

A \_\_\_\_\_

06.A BUILDING SECTION "ELEV. A"  
06.A1 BUILDING SECTION (OPT. EXTENDED LANAI) "ELEV. A"  
06.B BUILDING SECTION "ELEV. B"  
06.B1 BUILDING SECTION (OPT. EXTENDED LANAI) "ELEV. B"  
06.C BUILDING SECTION "ELEV. C"  
06.C1 BUILDING SECTION (OPT. EXTENDED LANAI) "ELEV. C"  
07.A ELECTRICAL PLAN "ELEV. A"  
07.A1 ELECTRICAL PLAN (OPT. MASTER SITTING) "ELEV. A"  
07.A2 ELECTRICAL PLAN (OPT. EXTENDED LANAI) "ELEV. A"  
07.B ELECTRICAL PLAN "ELEV. B"  
07.B1 ELECTRICAL PLAN (OPT. MASTER SITTING) "ELEV. B"  
07.B2 ELECTRICAL PLAN (OPT. EXTENDED LANAI) "ELEV. B"  
07.C ELECTRICAL PLAN "ELEV. C"  
07.C1 ELECTRICAL PLAN (OPT. MASTER SITTING) "ELEV. C"  
07.C2 ELECTRICAL PLAN (OPT. EXTENDED LANAI) "ELEV. C"  
08.A LINTEL PLAN "ELEV. A"  
08.A1 LINTEL PLAN (OPT. MASTER SITTING) "ELEV. A"  
08.A2 LINTEL PLAN (OPT. EXTENDED LANAI) "ELEV. A"  
08.B LINTEL PLAN "ELEV. B"  
08.B1 LINTEL PLAN (OPT. MASTER SITTING) "ELEV. B"  
08.B2 LINTEL PLAN (OPT. EXTENDED LANAI) "ELEV. B"  
08.C LINTEL PLAN "ELEV. C"  
08.C1 LINTEL PLAN (OPT. MASTER SITTING) "ELEV. C"  
08.C2 LINTEL PLAN (OPT. EXTENDED LANAI) "ELEV. C"  
09.A TRUSS PLAN "ELEV. A"  
09.A1 TRUSS PLAN (OPT. MASTER SITTING) "ELEV. A"  
09.A2 TRUSS PLAN (OPT. EXTENDED LANAI) "ELEV. A"  
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09.C TRUSS PLAN "ELEV. C"  
09.C1 TRUSS PLAN (OPT. MASTER SITTING) "ELEV. C"  
09.C2 TRUSS PLAN (OPT. EXTENDED LANAI) "ELEV. C"  
D1 TYPICAL DETAILS  
D2 TYPICAL DETAILS  
D3 TYPICAL DETAILS

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GENERAL NOTES KEY:

1. CONTRACTOR TO VERIFY ALL DIMENSIONS ON JOB SITE.

2. DO NOT SCALE PRINTS. CONSTRUCTION TO BE FROM CALCULATED DIMENSIONS ONLY. ANY DISCREPANCIES OR ERRORS TO BE REPORTED PROMPTLY TO SUPERVISOR FOR CLARIFICATION.

3. WATER HEATER T & P RELIEF VALVE SHALL BE FULL SIZE TO EXTERIOR WATER HEATED AT OR ABOVE FLOOR LEVEL SHALL BE IN A PAN WITH DRAIN TO EXTERIOR. WATER HEATER SHALL HAVE AN APPROVED THERMAL EXPANSION DEVICE.

4. FLOOR SLAB OF PLANT MIX CONCRETE 2500 P.S.I. 4" THICK WITH 6x6 10/10 GAUGE REINFORCING MAT. w/ MIN. 1" COVER. 6 MIL.
- POLYETHYLENE VAPOR BARRIER OVER COMPACTED CLEAN FILL. WWF SHALL BE PLACED IN MIDDLE TO UPPER THIRD OF SLAB AND SUPPORTED ON APPROVED SLAB BOLSTERS. FIBER MESH REINFORCEMENT MAY BE USED AS AN ALTERNATIVE TO WIRE MESH.

5. PAVERS MAY BE USED ILO CONCRETE SLAB AT PATIO, PORCH, DRIVE AND WALKWAY. DELETE SLAB IN AREAS PAVERS ARE TO BE USED.

6. MECHANICAL EQUIP. LOCATIONS WILL BE DETERMINED BY COMMUNITY AND COUNTY CODES.



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- TREATMENT CAN BE APPLIED TO ALL INTERIOR WOOD SURFACES PER FBC-R 2017 6TH EDITION.


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9. ALL STEEL TO BE USED IN FOOTERS & EXTERIOR WALLS TO BE MIN. GRADE 60.

10. IF TRUSS LAYOUT / ENGINEERING IS CHANGED OR ALTERED FROM ITS ORIGINAL MASTER FILE, THE E.O.R AND DESIGNER MUST BE NOTIFIED IMMEDIATELY AND WILL NOT BE HELD LIABLE.

DOOR NOTE KEY:


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- \* ALL INT. DOORS TO BE 6'-8" TALL U.N.O. OR PER BUILDER/CLIENT SPECS.
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-  INDICATES A CONCRETE FILLED CELL OF 8" CMU. WALL WITH (1) #5 REBAR VERT. CONT. FROM FOUNDATION TO BOND BEAM. PROVIDE A MIN. OF 25" LAP ON ALL STEEL REINFORCING BARS. MIN. REBAR GRADE 60.

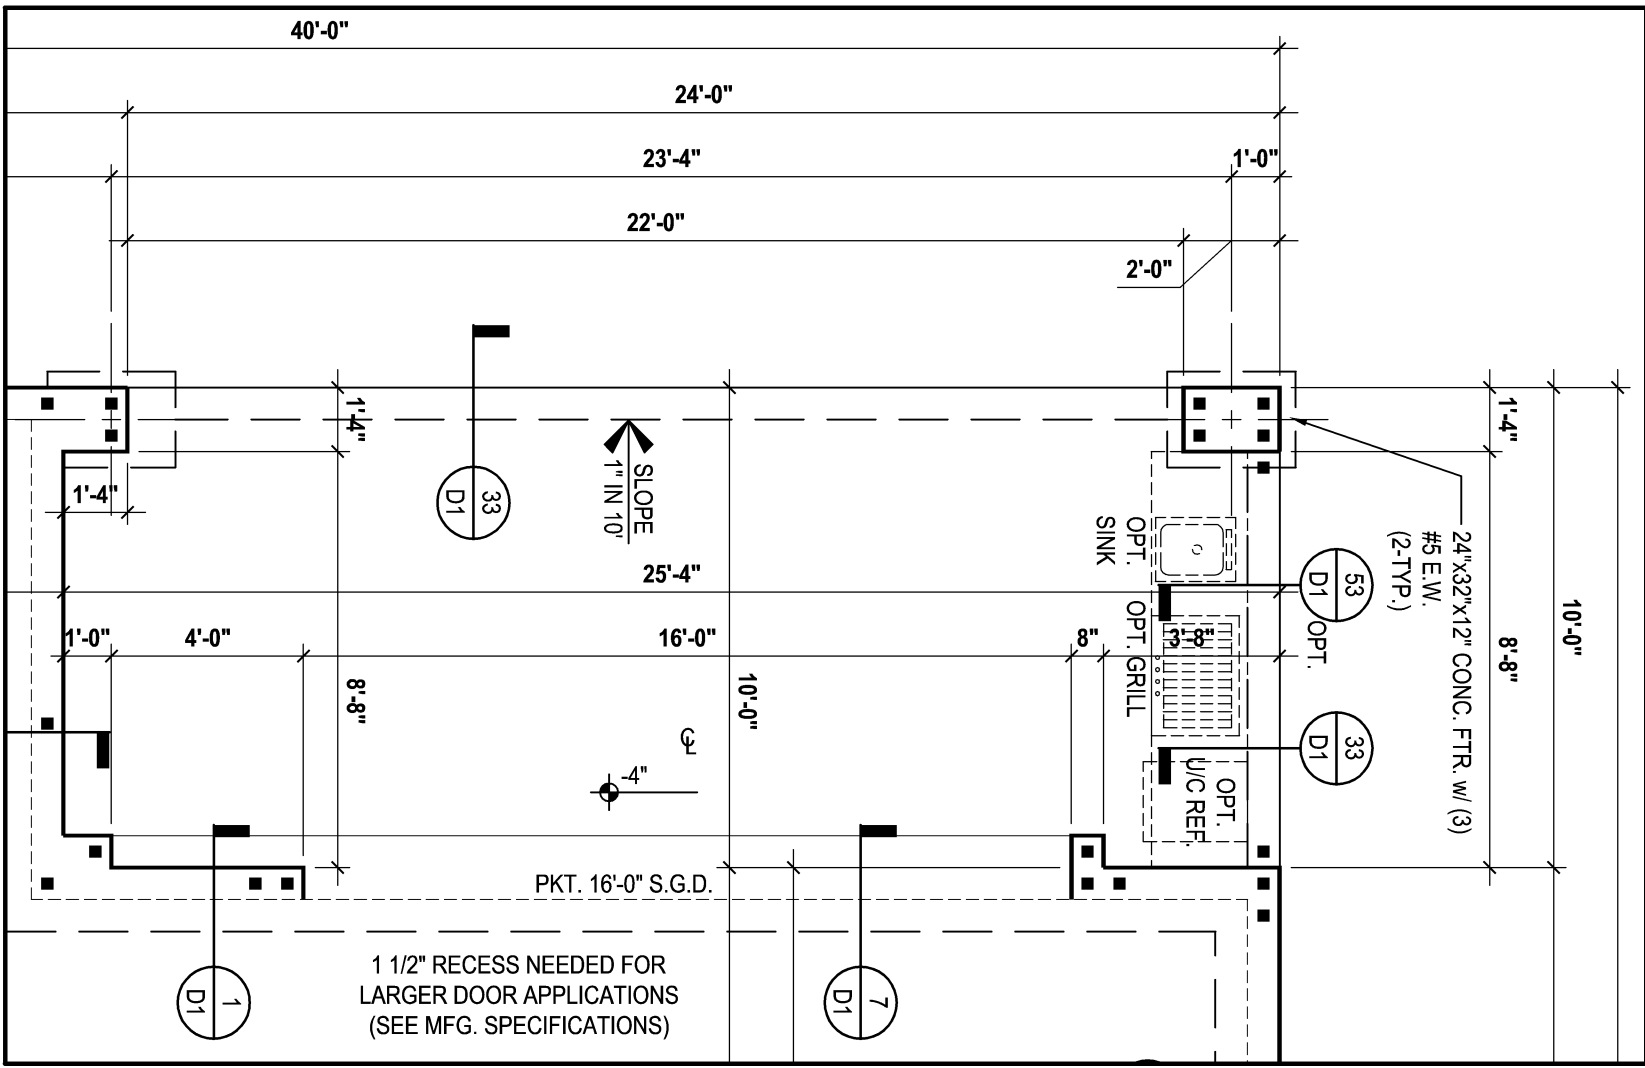

Foundation Plan

(Opt. Pocket SGD Dr.)


SCALE: 1/8" = 1'-0" (12x18) 1/4" = 1'-0" (24x36)

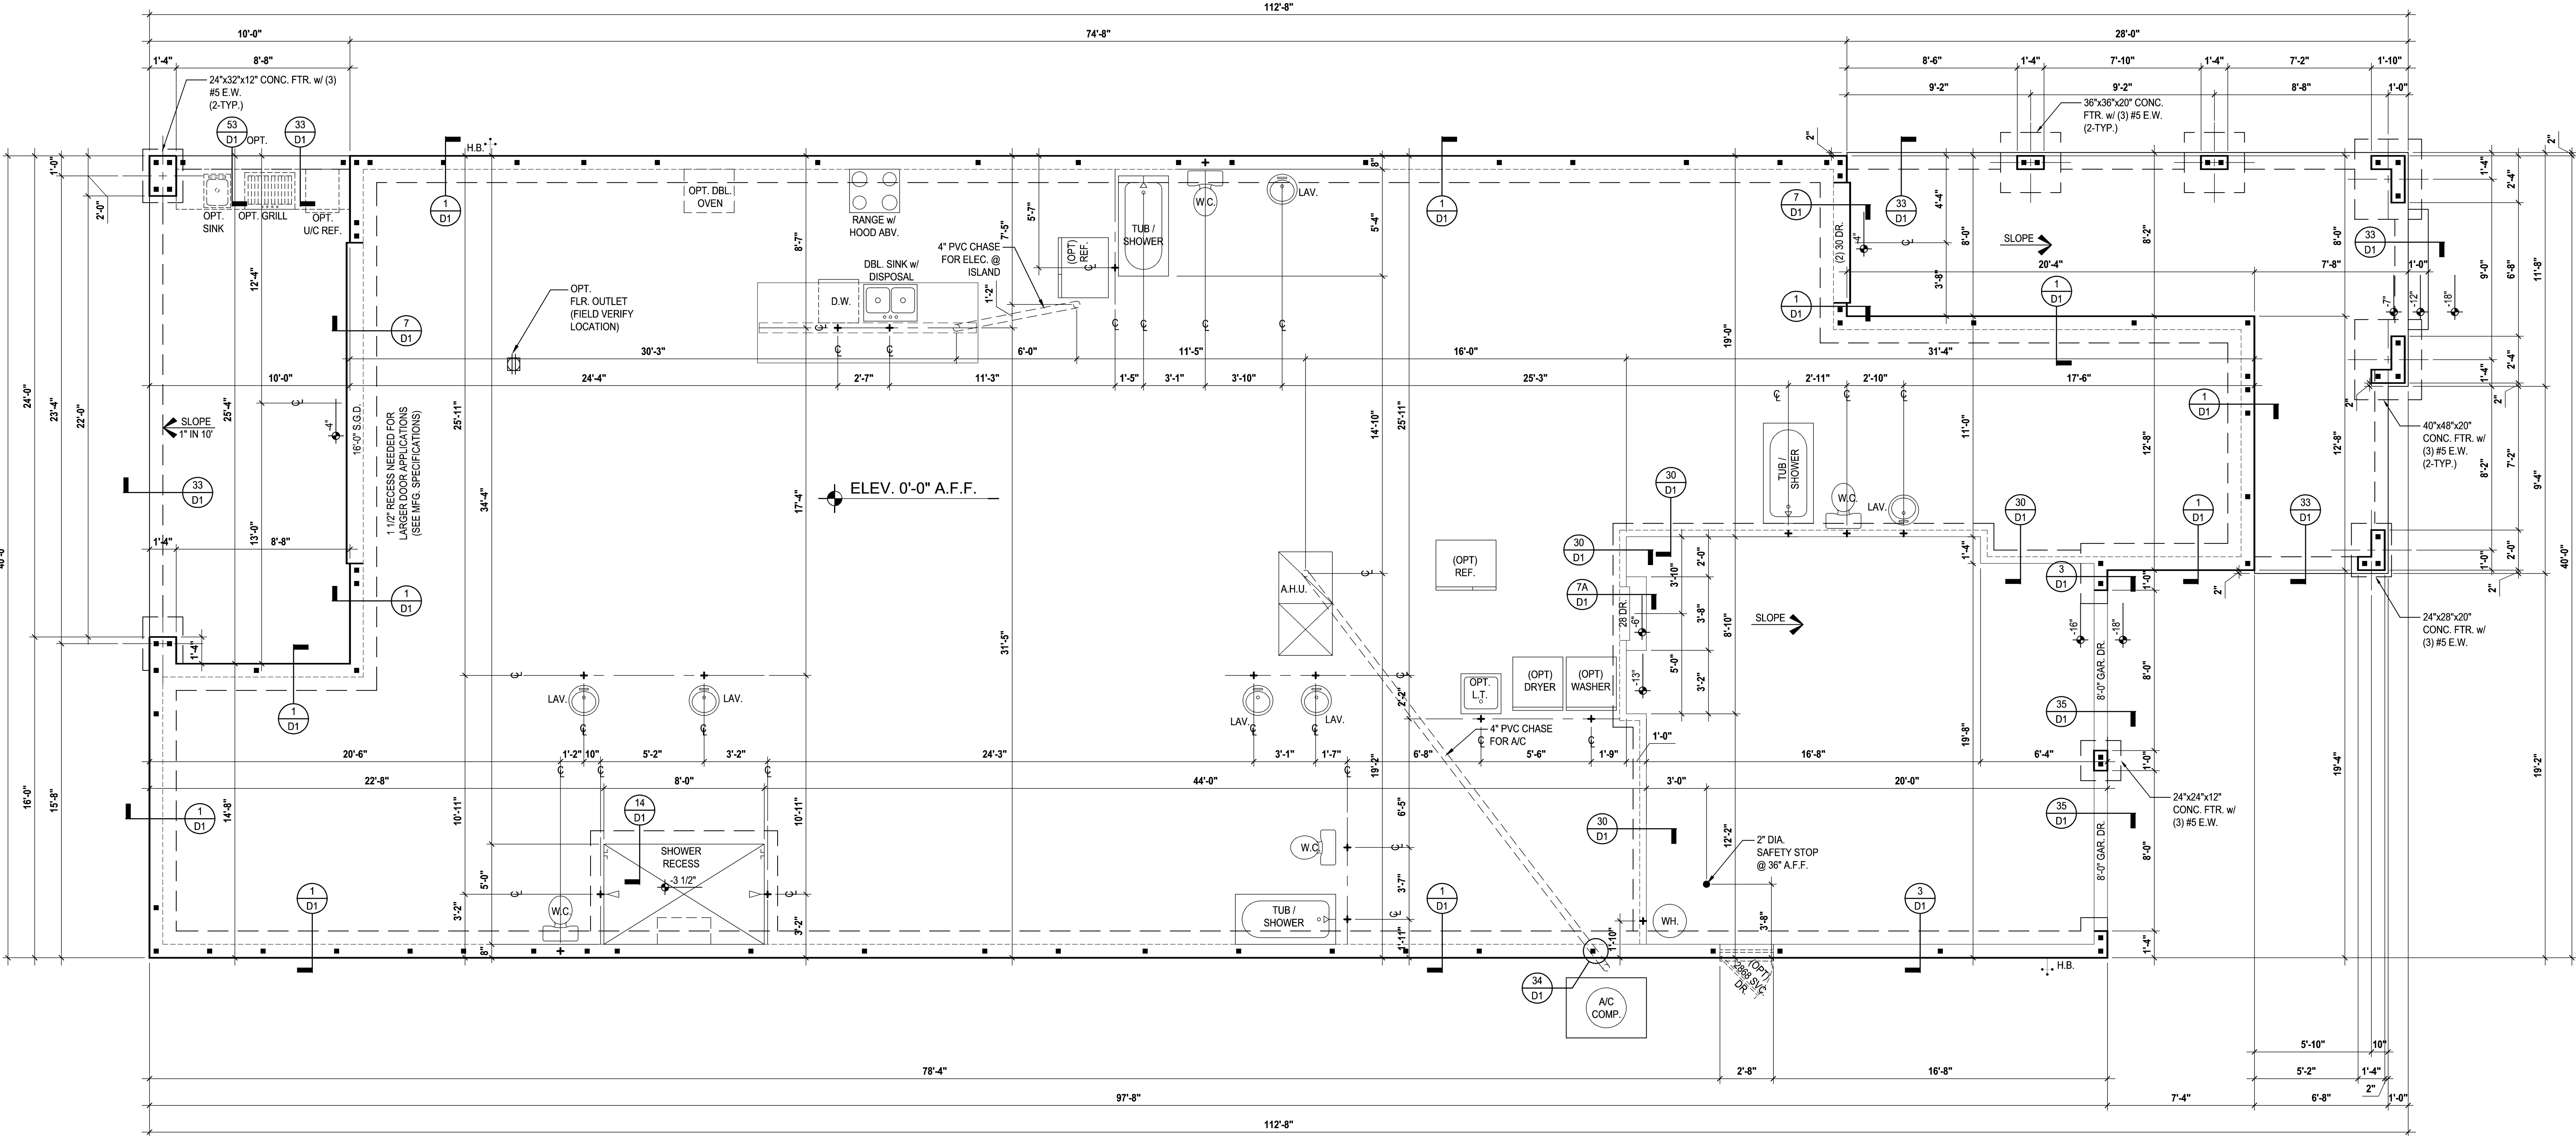

Foundation Plan "A"

(Standard)

SCALE: 1/8" = 1'-0" (12x18) 1/4" = 1'-0" (24x36)

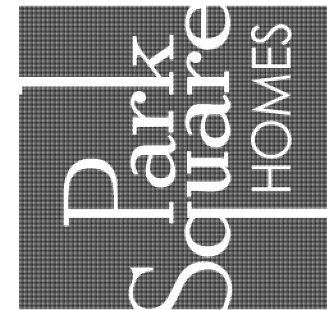

A Division of Park Square  
Enterprises Inc.  
5200 Vineland Rd. Suite #200  
Orlando, FL 32811  
Phone: (407) 525-3000

40-3164  
DORCHESTER  
Street Address  
Lot Info  
City, State, Zip

**MJS**  
815 Orienta Ave, Suite# 1040  
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235 Maitland Avenue S.  
Suite 108-A  
Maitland, FL 32751  
Ph: (407) 227-7416  
www.premier-structural.com  
FL CERT. AUTH.: 28113  
FL. PER#: 80239

GENERAL NOTES KEY:

- |    |  |  |  |
|----|--|--|--|
| 1. | CONTRACTOR TO VERIFY ALL DIMENSIONS ON JOB SITE.   | POLYETHYLENE VAPOR BARRIER OVER COMPACTED CLEAN FILL.  | TREATMENT CAN BE APPLIED TO ALL INTERIOR WOOD SURFACES PER FBC-9 2017 6TH EDITION.   |
| 2. | DO NOT SCALE PRINTS. CONSTRUCTION TO BE FROM CALCULATED DIMENSIONS ONLY. ANY DISCREPANCIES OR ERRORS TO BE REPORTED PROMPTLY TO SUPERVISOR FOR CLARIFICATION.  | WWF SHALL BE PLACED IN MIDDLE TO UPPER THIRD OF SLAB AND SUPPORTED ON APPROVED SLAB BOLSTERS. FIBER MESH REINFORCEMENT MAY BE USED AS AN ALTERNATIVE TO WIRE MESH. | 8. BORATE TREATMENT TO BE APPLIED ON ALL INTERIOR WOOD SURFACES IN ACCORDANCE WITH MANUFACTURERS INSTRUCTIONS AND SPECIFICATIONS. PURSUANT TO CH.482 OF THE FLORIDA BUILDING CODE. |
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| 4. | FLOOR SLAB GUARANTEE MIX CONCRETE 2500 P.S.I. 4" THICK WITH 6#6 10/10 GAUGE REINFORCING MAT. w/ MIN. 1" COVER. 6 MIL.  | 6. MECHANICAL EQUIP. LOCATIONS WILL BE DETERMINED BY COMMUNITY AND COUNTY CODES.   | 10. IF TRUSS LAYOUT / ENGINEERING IS CHANGED OR ALTERED FROM ITS ORIGINAL MASTER FILE, THE E.O.R AND DESIGNER MUST BE NOTIFIED IMMEDIATELY AND WILL NOT BE HELD LIABLE.            |
|    |  | 7. IN LIEU OF TREATING THE SOIL AN ALTERNATIVE TREATMENT   |  |

DOOR NOTE KEY:


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# Foundation Plan "A"

(Opt. Sitting Room)

SCALE: 1/8" = 1'-0" (12x18) 1/4" = 1'-0" (24x36)

235 Maitland Avenue S.


Suite 108-A

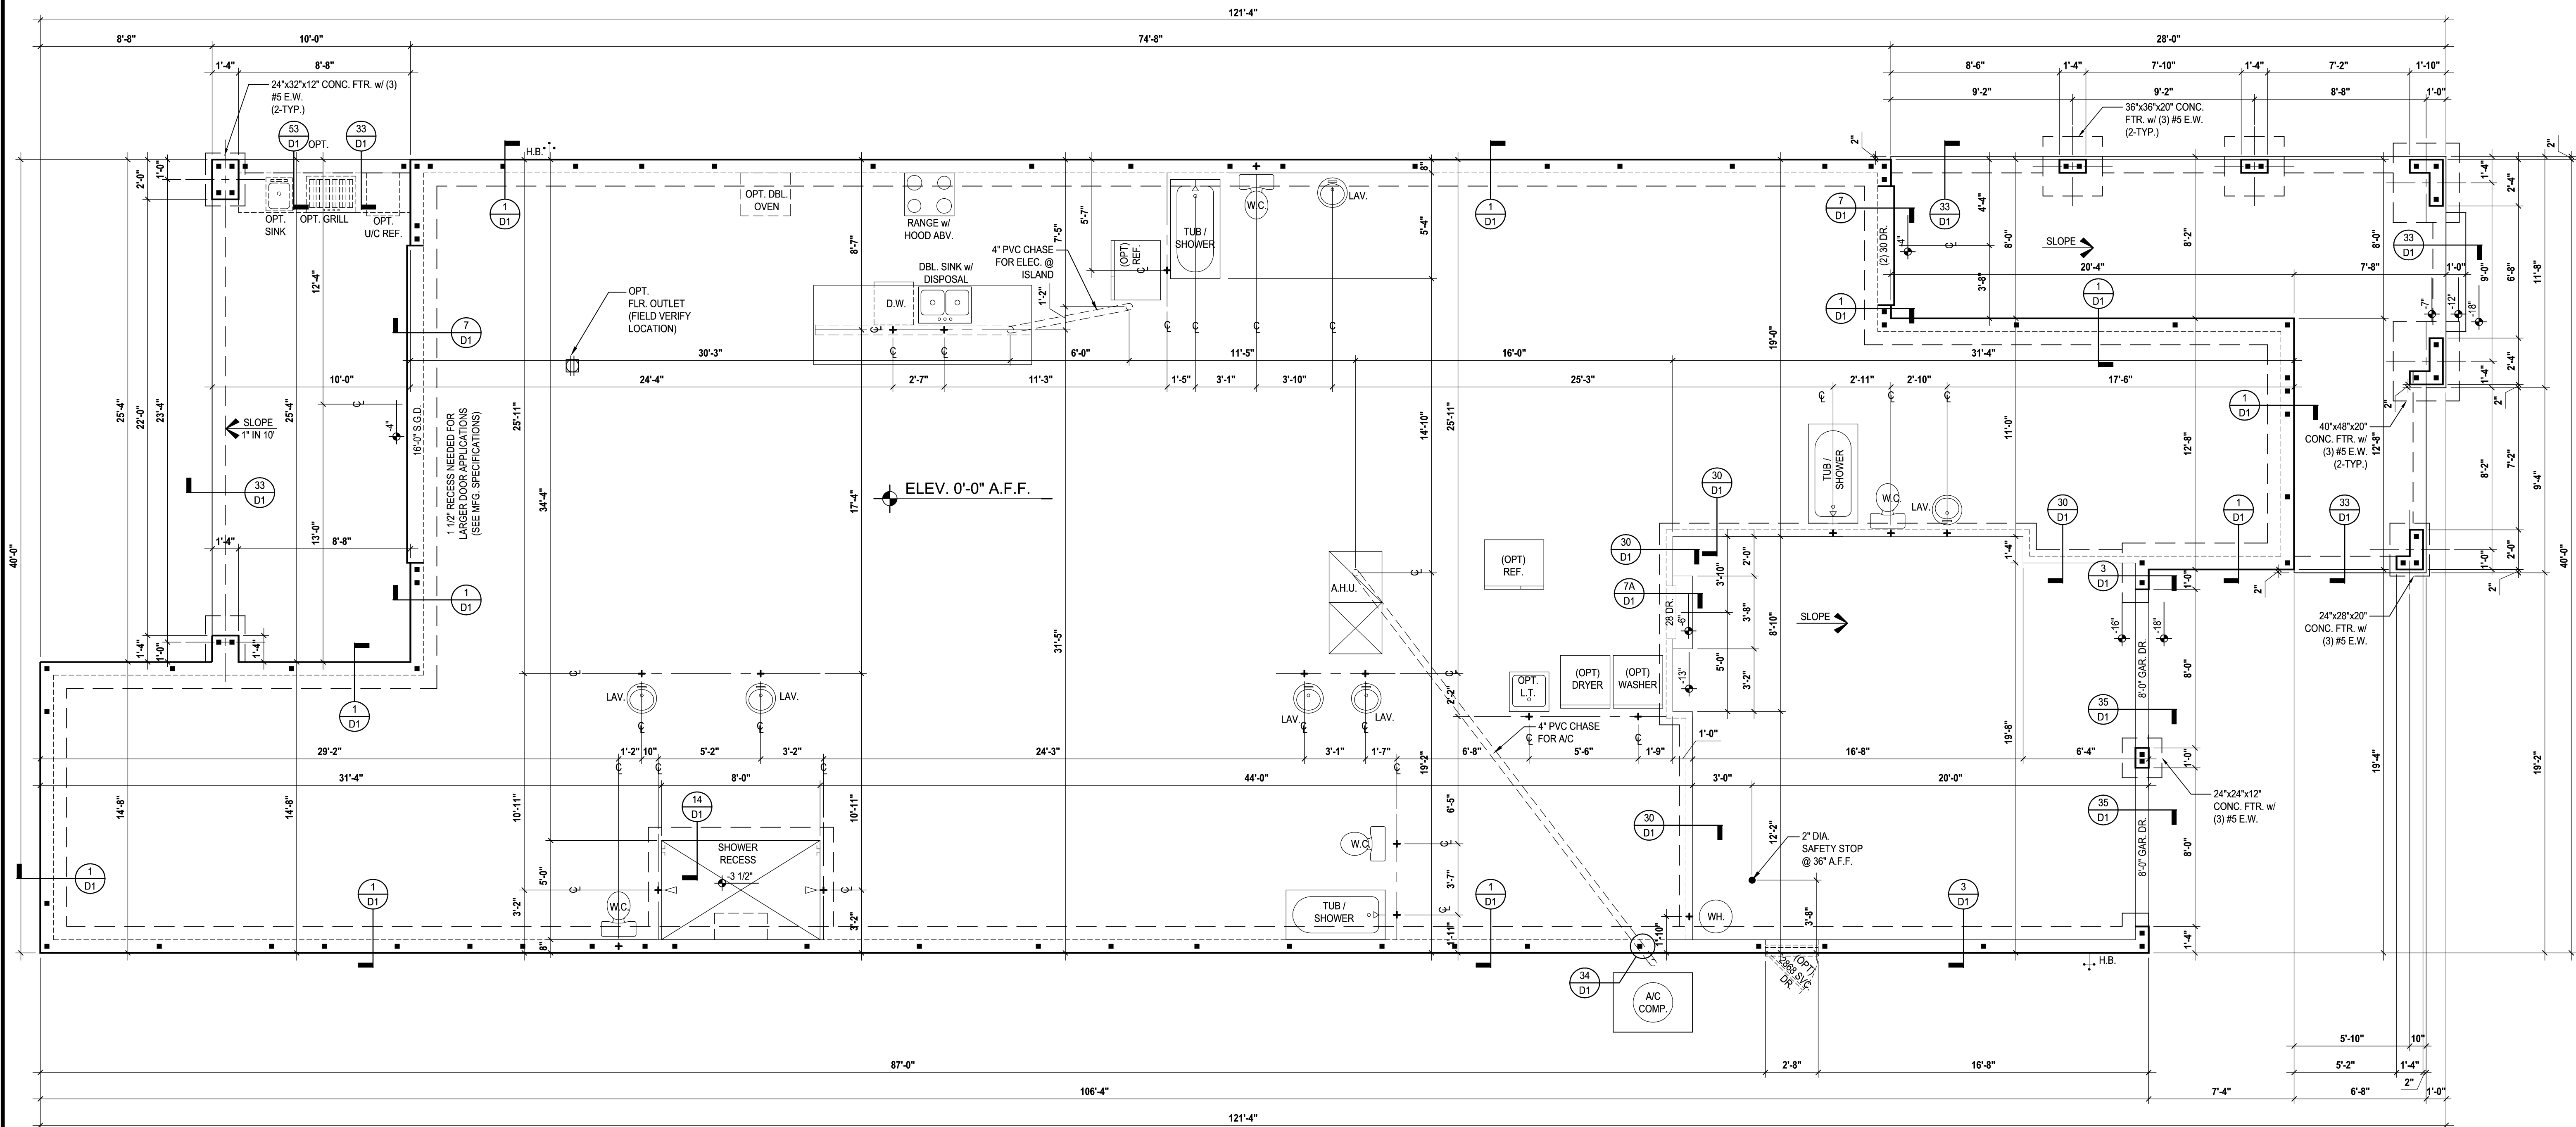Maitland, FL. 32751

Ph: (407) 227-7416  
www.premier-structural.com

FL. CERT. AUTH.: 29113

FL. PE#: 60239

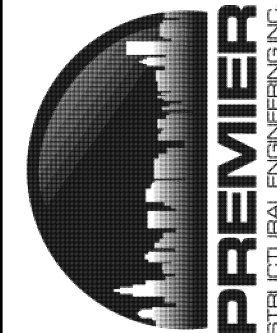

When plans have been electronically signed

**AMS**  
815 Orienta Ave. Suite# 1040  
Altamonte Springs, FL. 32701

Ph: (407) 629-6711

custom home design  
Fax: (407) 629-6776

DESIGNERS - PLANNERS [www.mjshomedesigns.com](http://www.mjshomedesigns.com)

WRITTEN DIMENSIONS SHALL HAVE PRECEDENCE OVER SCALE DIMENSIONS

THESE DIMENSIONS SHALL HAVE A TOLERANCE OVER OR UNDER ZERO.

40-3164

# DORCHESTER

Street Address

Lot Info

City: State: Zip:

A division of Park Square

**Enterprises Inc.**

5200 Vineland Rd. Suite #200

Orlando, Fl. 32811

Phone: (407) 529-3000

ISSUE DATE	00/00/0000
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## REVISION

PROJECT:	00-0000
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SCALE:	AS NOTED
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DRAWN BY: C.C.

DESIGNED BY: MJS

FOUNDATION PLAN

01.A1

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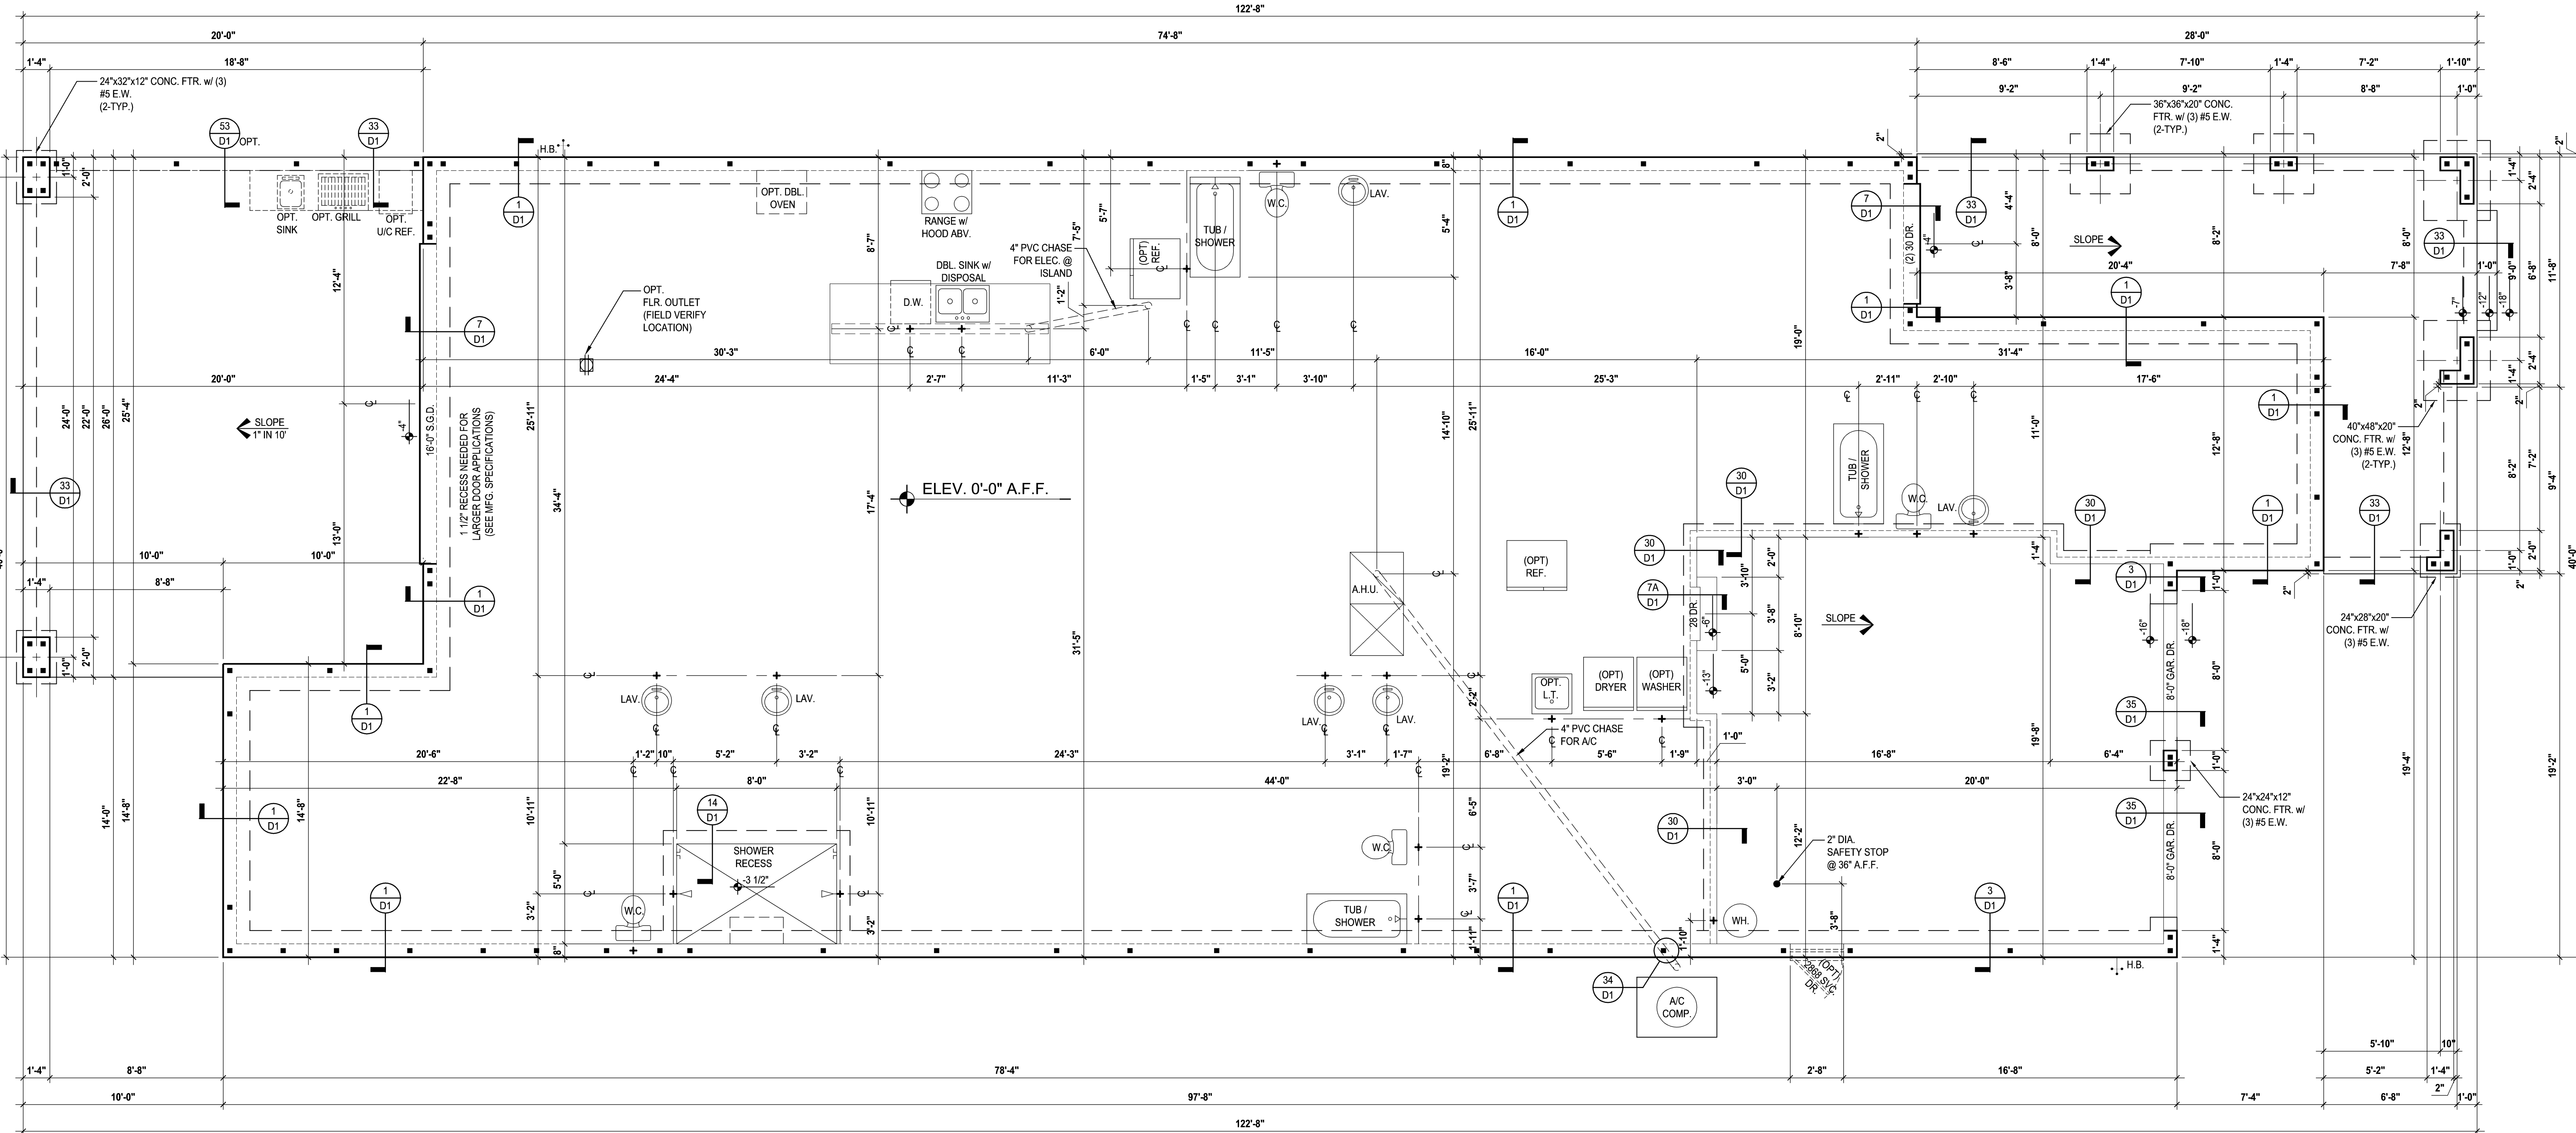
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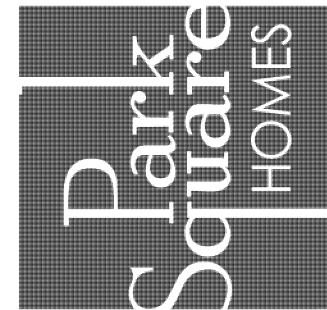


Foundation Plan "A"

(Opt. Extended Lanai)

SCALE: 1/8" = 1'-0" (12x18) 1/4" = 1'-0" (24x36)

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

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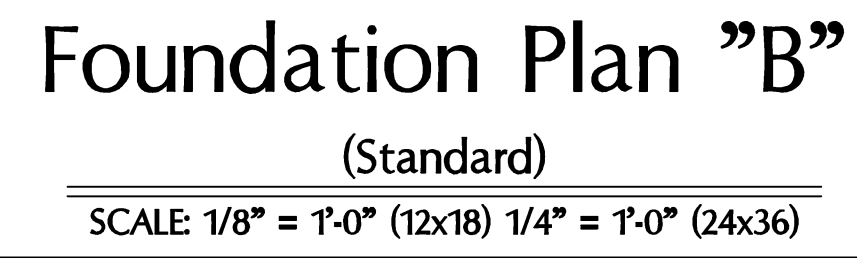


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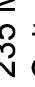
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

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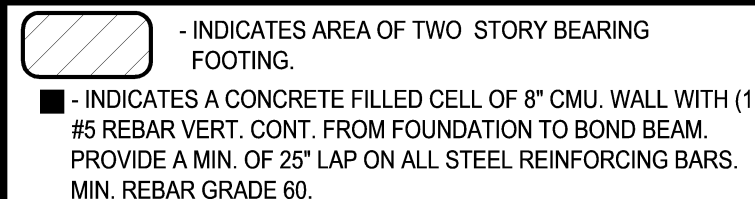
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

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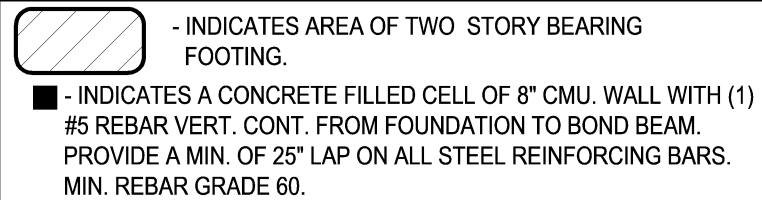
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FOUNDATION PLAN

01.B2

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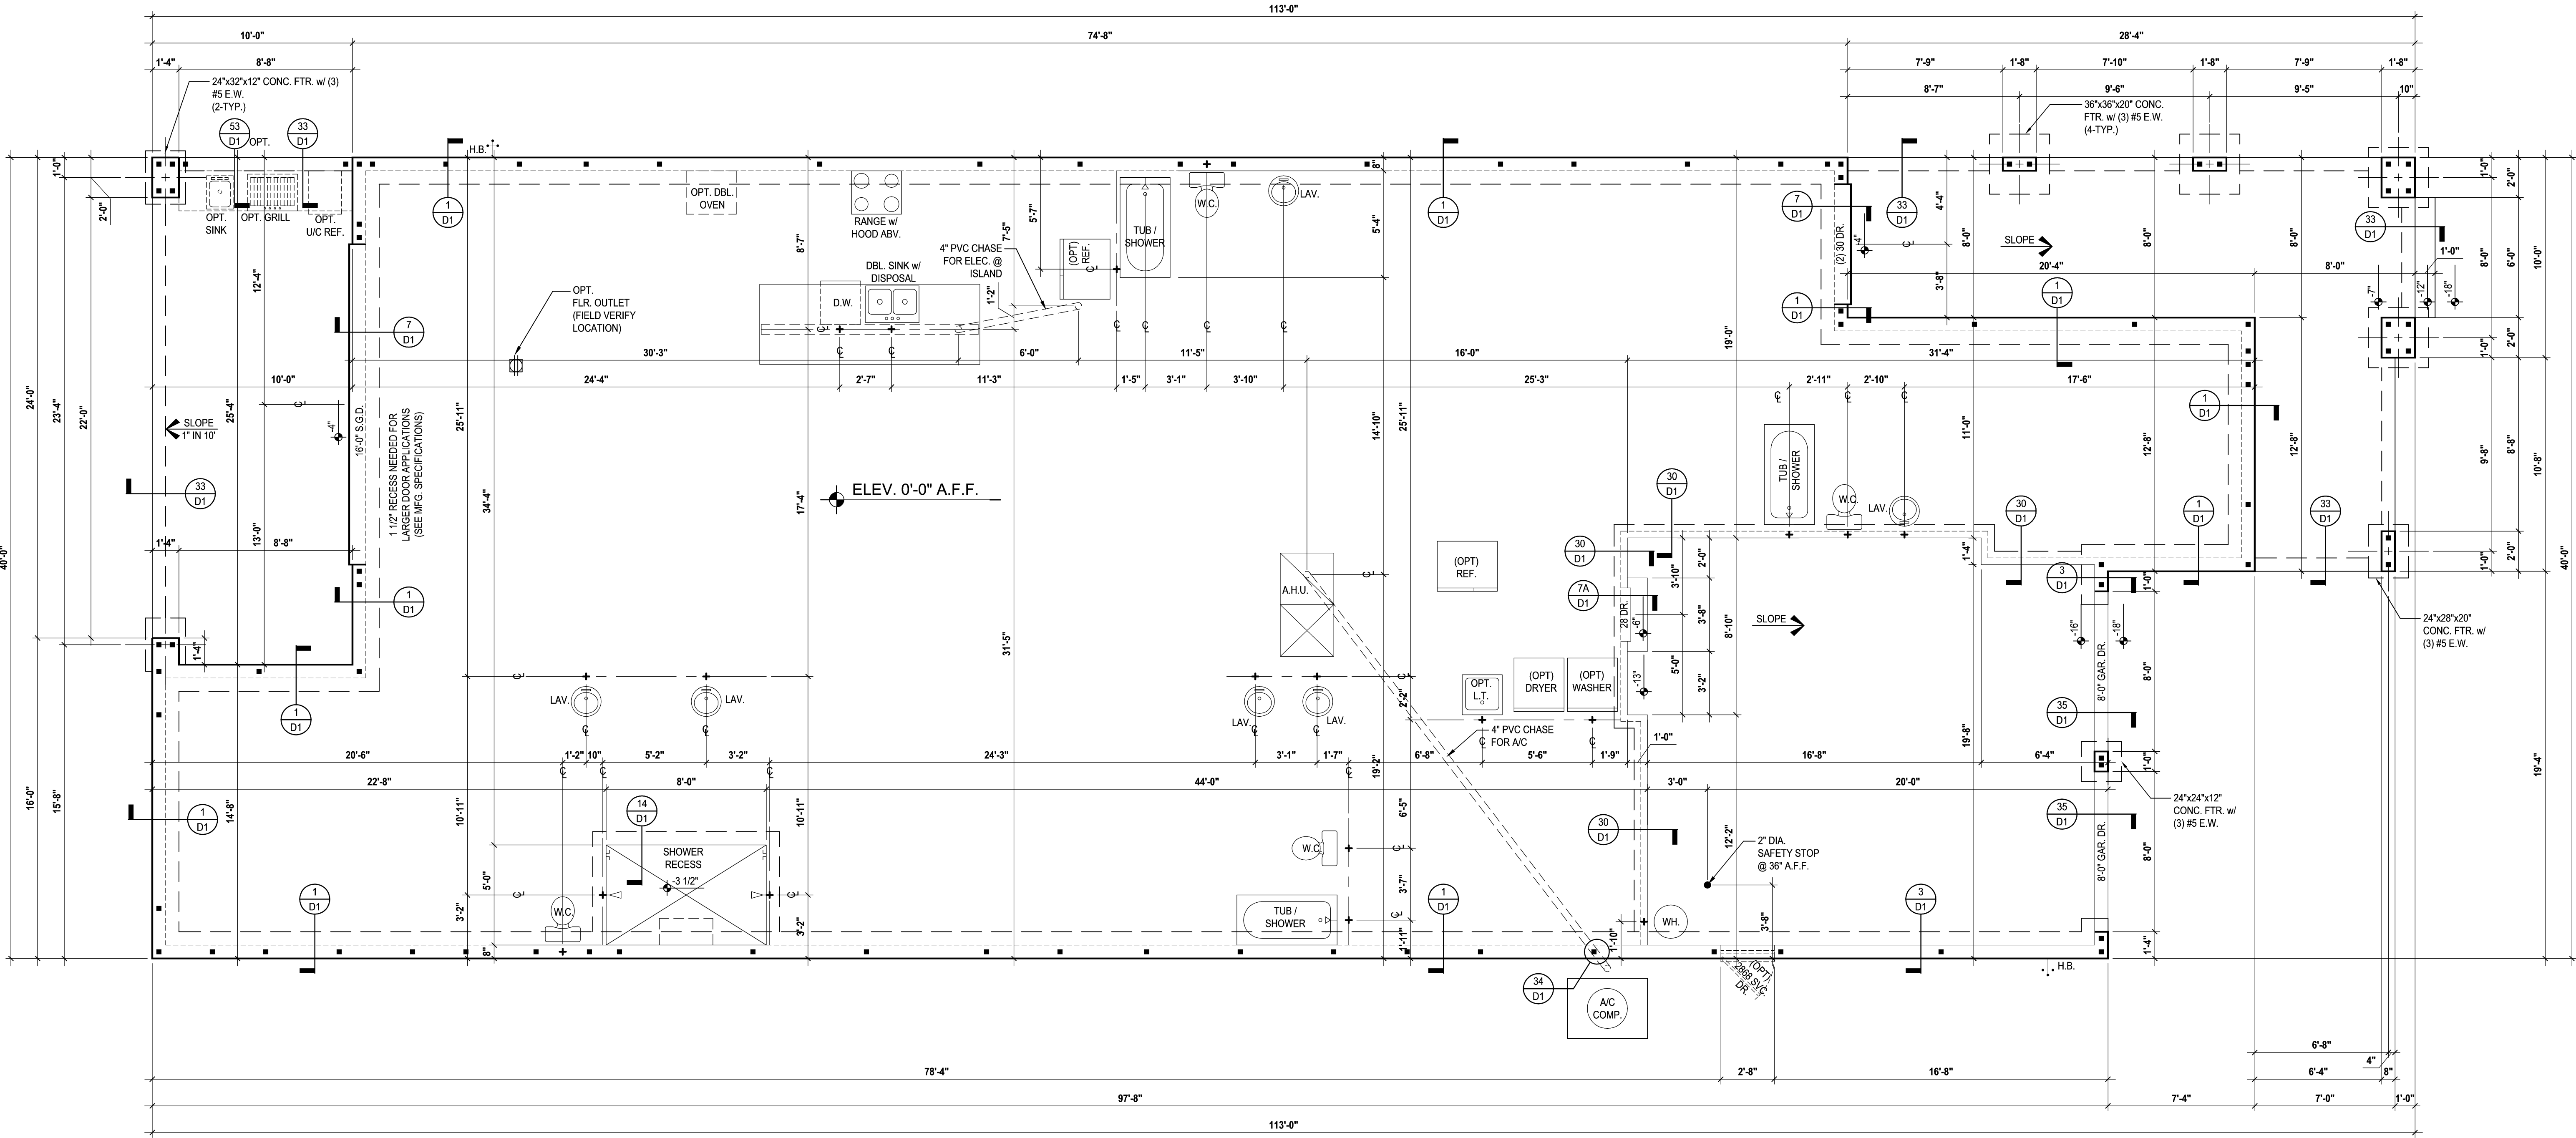
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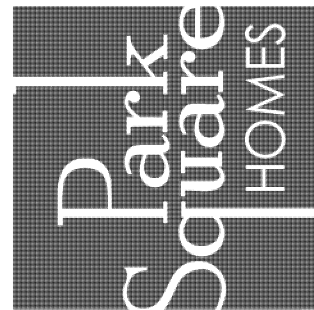
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- INDICATES A CONCRETE FILLED CELL OF 8" CMU. WALL WITH (1) #5 REBAR VERT. CONT. FROM FOUNDATION TO BOND BEAM. PROVIDE A MIN. OF 25" LAP ON ALL STEEL REINFORCING BARS. MIN. REBAR GRADE 60.



Foundation Plan "C"

(Standard)

SCALE: 1/8" = 1'-0" (12x18) 1/4" = 1'-0" (24x36)



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Enterprises Inc.  
5200 Vineland Rd. Suite #200  
Orlando, FL 32811  
Phone: (407) 525-3000



40-3164  
DORCHESTER  
Street Address  
Lot Info  
City, State, Zip



MJS  
815 Orienta Ave, Suite# 1040  
Altamonte Springs, FL 32701  
Ph: (407) 629-6711  
CUSTOM Home design  
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www.mjshomedesigns.com  
Fax: (407) 629-6776  
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Ph: (407) 227-7416  
www.premier-structural.com  
FL CERT. AUTH.: 28113  
FL. PE#: 60239

DOOR NOTE KEY:

- DOOR SIZE CALLOUT:**
- |            |                        |
|------------|------------------------|
| 20 = 2'-0" | 30 = 3'-0"             |
| 24 = 2'-4" | 40 B.F. = 4'-0" BIFOLD |
| 26 = 2'-6" | 50 B.F. = 5'-0" BIFOLD |
| 28 = 2'-8" | 60 B.F. = 6'-0" BIFOLD |
- \* ALL INT. DOORS TO BE 6'-8" TALL U.N.O. OR PER BUILDER/CLIENT SPECS.
-  - INDICATES AREA OF TWO STORY BEARING FOOTING.
-  - INDICATES A CONCRETE FILLED CELL OF 8" CMU. WALL WITH (1) 5# REBAR VERT. CONT. FROM FOUNDATION TO BOND BEAM. PROVIDE A MIN. OF 25' LAP ON ALL STEEL REINFORCING BARS. MIN. REBAR GRADE 60.



SCALE: 1/8" = 1'-0" (12x18) 1/4" = 1'-0" (24x36)

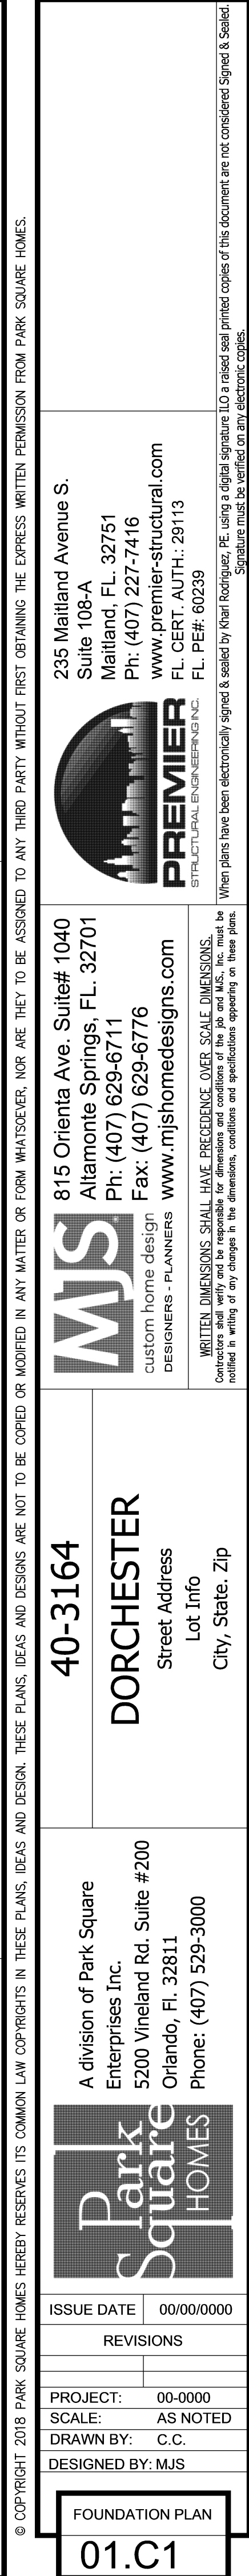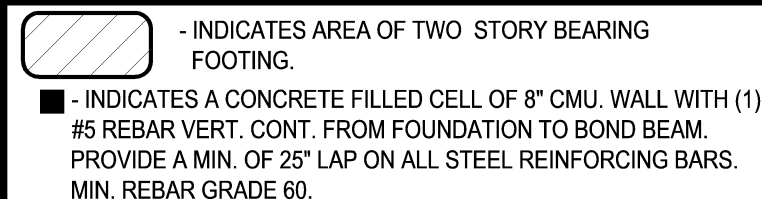GENERAL NOTES KEY:

1. CONTRACTOR TO VERIFY ALL DIMENSIONS ON JOB SITE.

2. DO NOT SCALE PRINTS. CONSTRUCTION TO BE FROM CALCULATED DIMENSIONS ONLY. ANY DISCREPANCIES OR ERRORS TO BE REPORTED PROMPTLY TO SUPERVISOR FOR CLARIFICATION.

3. WATER HEATER T & P RELIEF VALVE SHALL BE FULL SIZE TO EXTERIOR WATER HEATED AT OR ABOVE FLOOR LEVEL SHALL BE IN A PAN WITH DRAIN TO EXTERIOR. WATER HEATER SHALL HAVE AN APPROVED THERMAL EXPANSION DEVICE.

4. FLOOR SLAB OF PLANT MIX CONCRETE 2500 P.S.I. 4" THICK WITH 6x6 10/10 GAUGE REINFORCING MAT. w/ MIN. 1" COVER. 6 MIL.
- POLYETHYLENE VAPOR BARRIER OVER COMPACTED CLEAN FILL. WWF SHALL BE PLACED IN MIDDLE TO UPPER THIRD OF SLAB AND SUPPORTED ON APPROVED SLAB BOLSTERS. FIBER MESH REINFORCEMENT MAY BE USED AS AN ALTERNATIVE TO WIRE MESH.

5. PAVERS MAY BE USED I/O CONCRETE SLAB AT PATIO, PORCH, DRIVE AND WALKWAY. DELETE SLAB IN AREAS PAVERS ARE TO BE USED.

6. MECHANICAL EQUIP. LOCATIONS WILL BE DETERMINED BY COMMUNITY AND COUNTY CODES.

7. IN LEIU OF TREATING THE SOIL AN ALTERNATIVE TERMITE
- TREATMENT CAN BE APPLIED TO ALL INTERIOR WOOD SURFACES PER FBC-R 2017 6TH EDITION.


8. BORATE TERMITE TREATMENT TO BE APPLIED ON ALL INTERIOR WOOD SURFACES IAW MANUFACTURERS INSTRUCTIONS AND SPECIFICATIONS, PURSUANT TO CH.482 OF THE FLORIDA BUILDING CODE.

9. ALL STEEL TO BE USED IN FOOTERS & EXTERIOR WALLS TO BE MIN. GRADE 60.

10. IF TRUSS LAYOUT / ENGINEERING IS CHANGED OR ALTERED FROM ITS ORIGINAL MASTER FILE, THE E.O.R AND DESIGNER MUST BE NOTIFIED IMMEDIATELY AND WILL NOT BE HELD LIABLE.

DOOR NOTE KEY:


- DOOR SIZE CALLOUT:  
20 = 2'-0"    30 = 3'-0"  
24 = 2'-4"    40 B.F. = 4'-0" BIFOLD  
26 = 2'-6"    50 B.F. = 5'-0" BIFOLD  
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Foundation Plan "C"

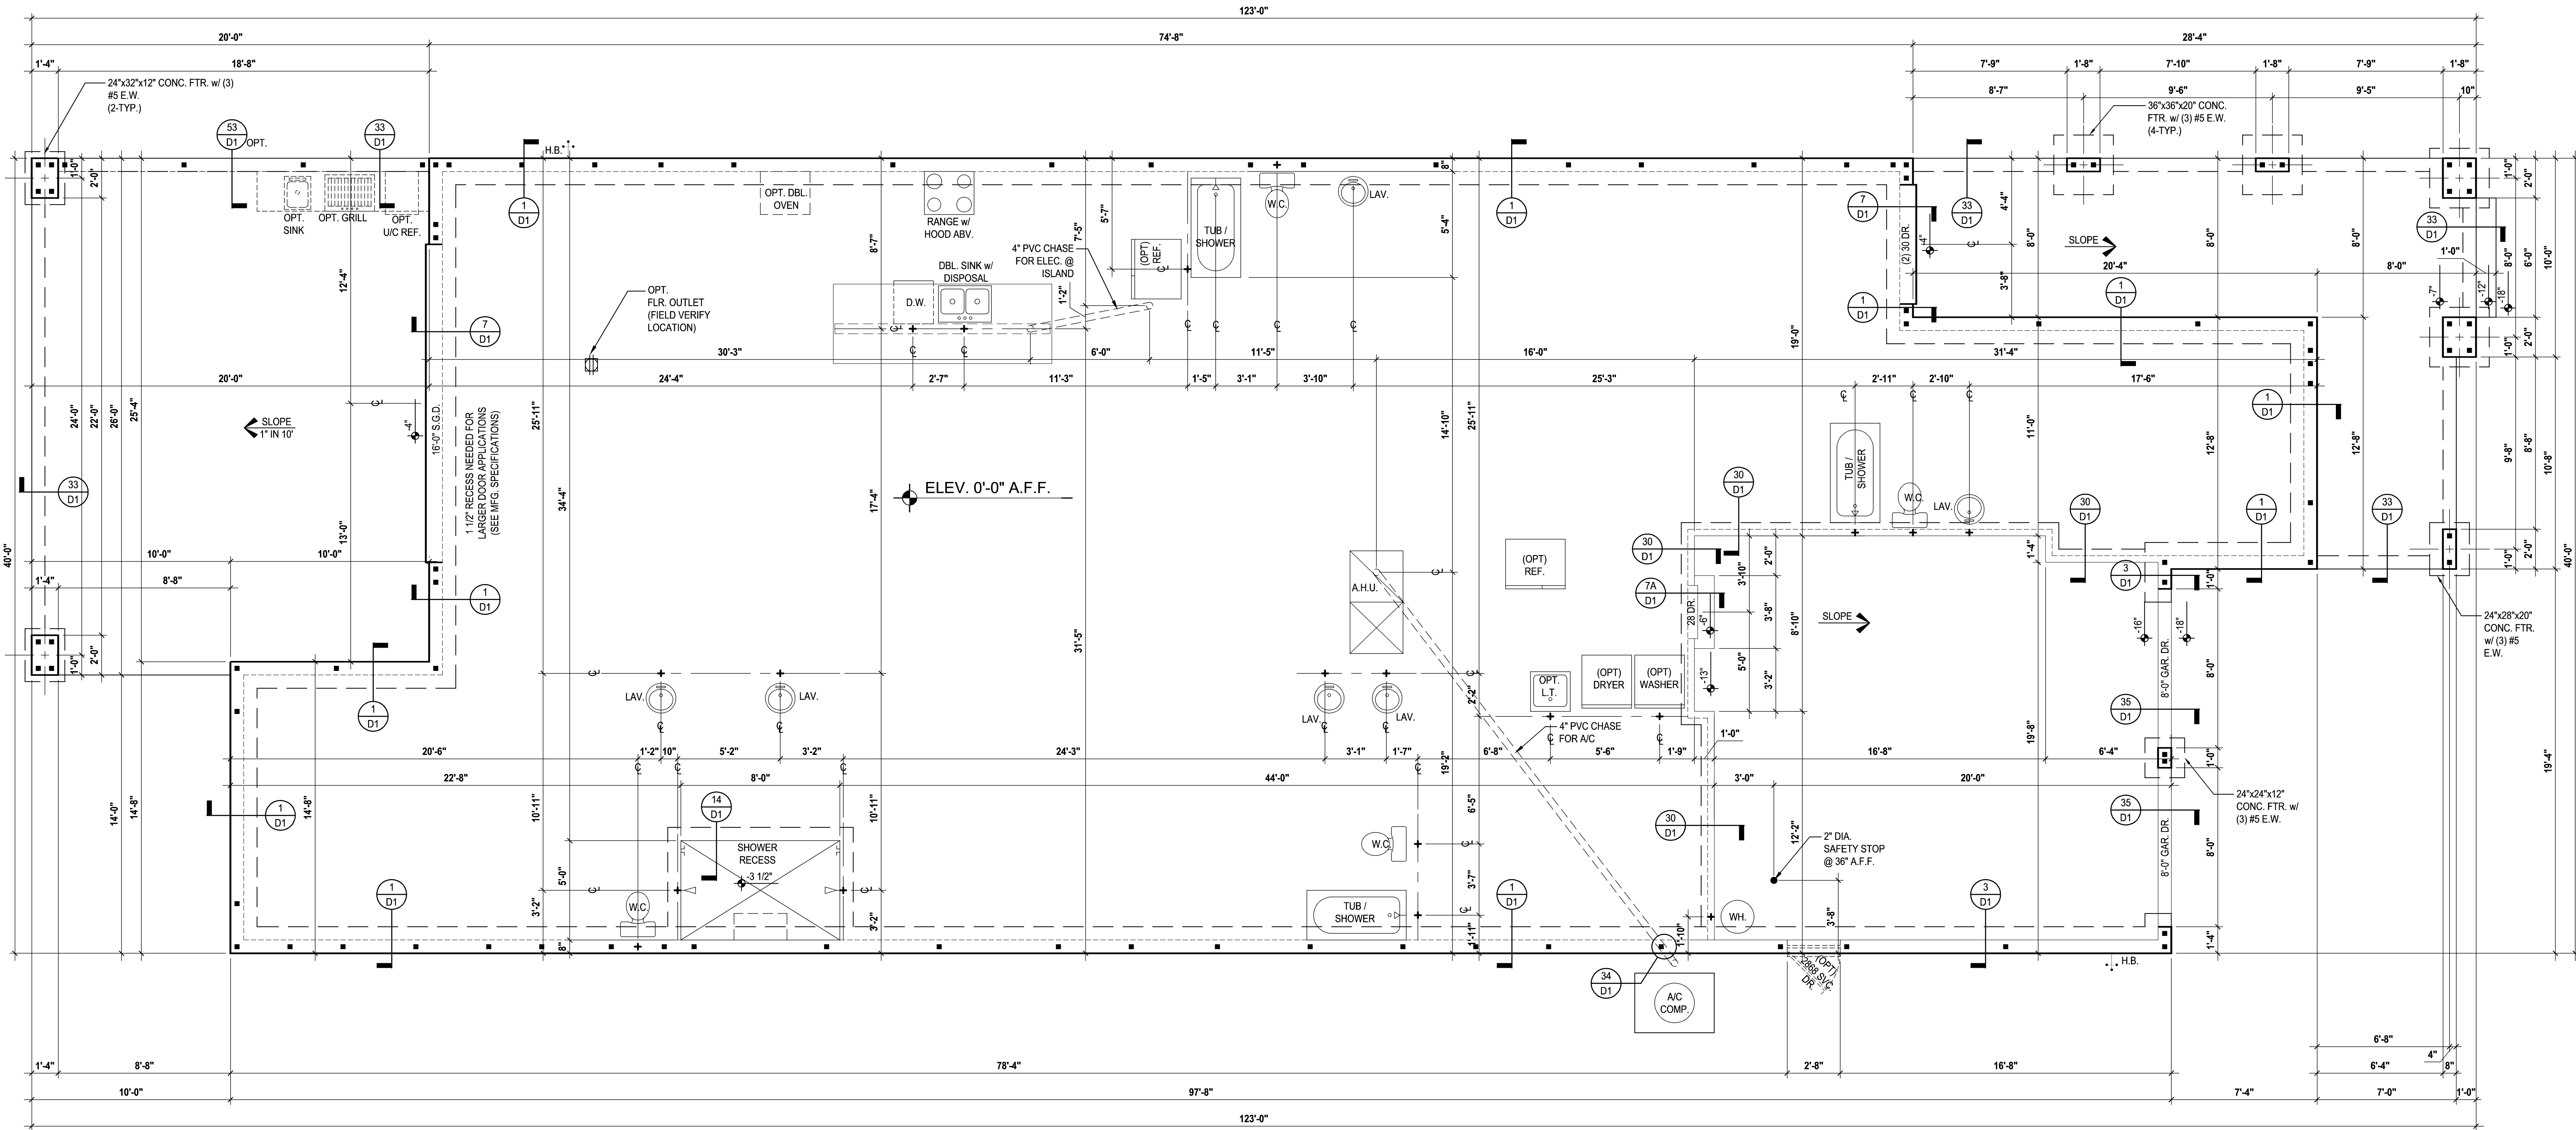(Opt. Extended Lanai)


SCALE: 1/8" = 1'-0" (12x18) 1/4" = 1'-0" (24x36)



A Division of Park Square  
Enterprises Inc.  
5200 Vineland Rd. Suite #200  
Orlando, FL 32811  
Phone: (407) 525-3000

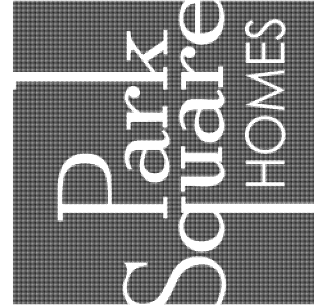40-3164  
DORCHESTER

Street Address  
Lot Info  
City, State, Zip

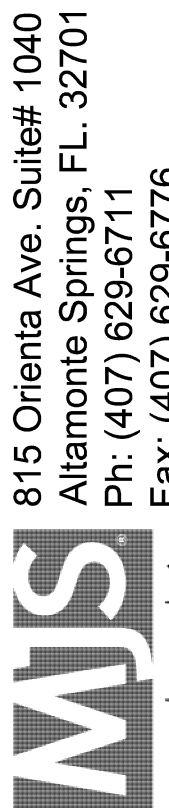

815 Orienta Ave. Suite# 1040  
Altamonte Springs, FL 32701  
Ph: (407) 629-6711  
CUSTOM Home design  
DESIGNERS - PLANNERS


www.mjshomedesigns.com



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Suite 108-A  
Maitland, FL 32751  
Ph: (407) 227-7416  
www.premier-structural.com  
FL CERT. AUTH.: 28113  
FL. PER#: 60239

FOUNDATION PLAN

01.C2

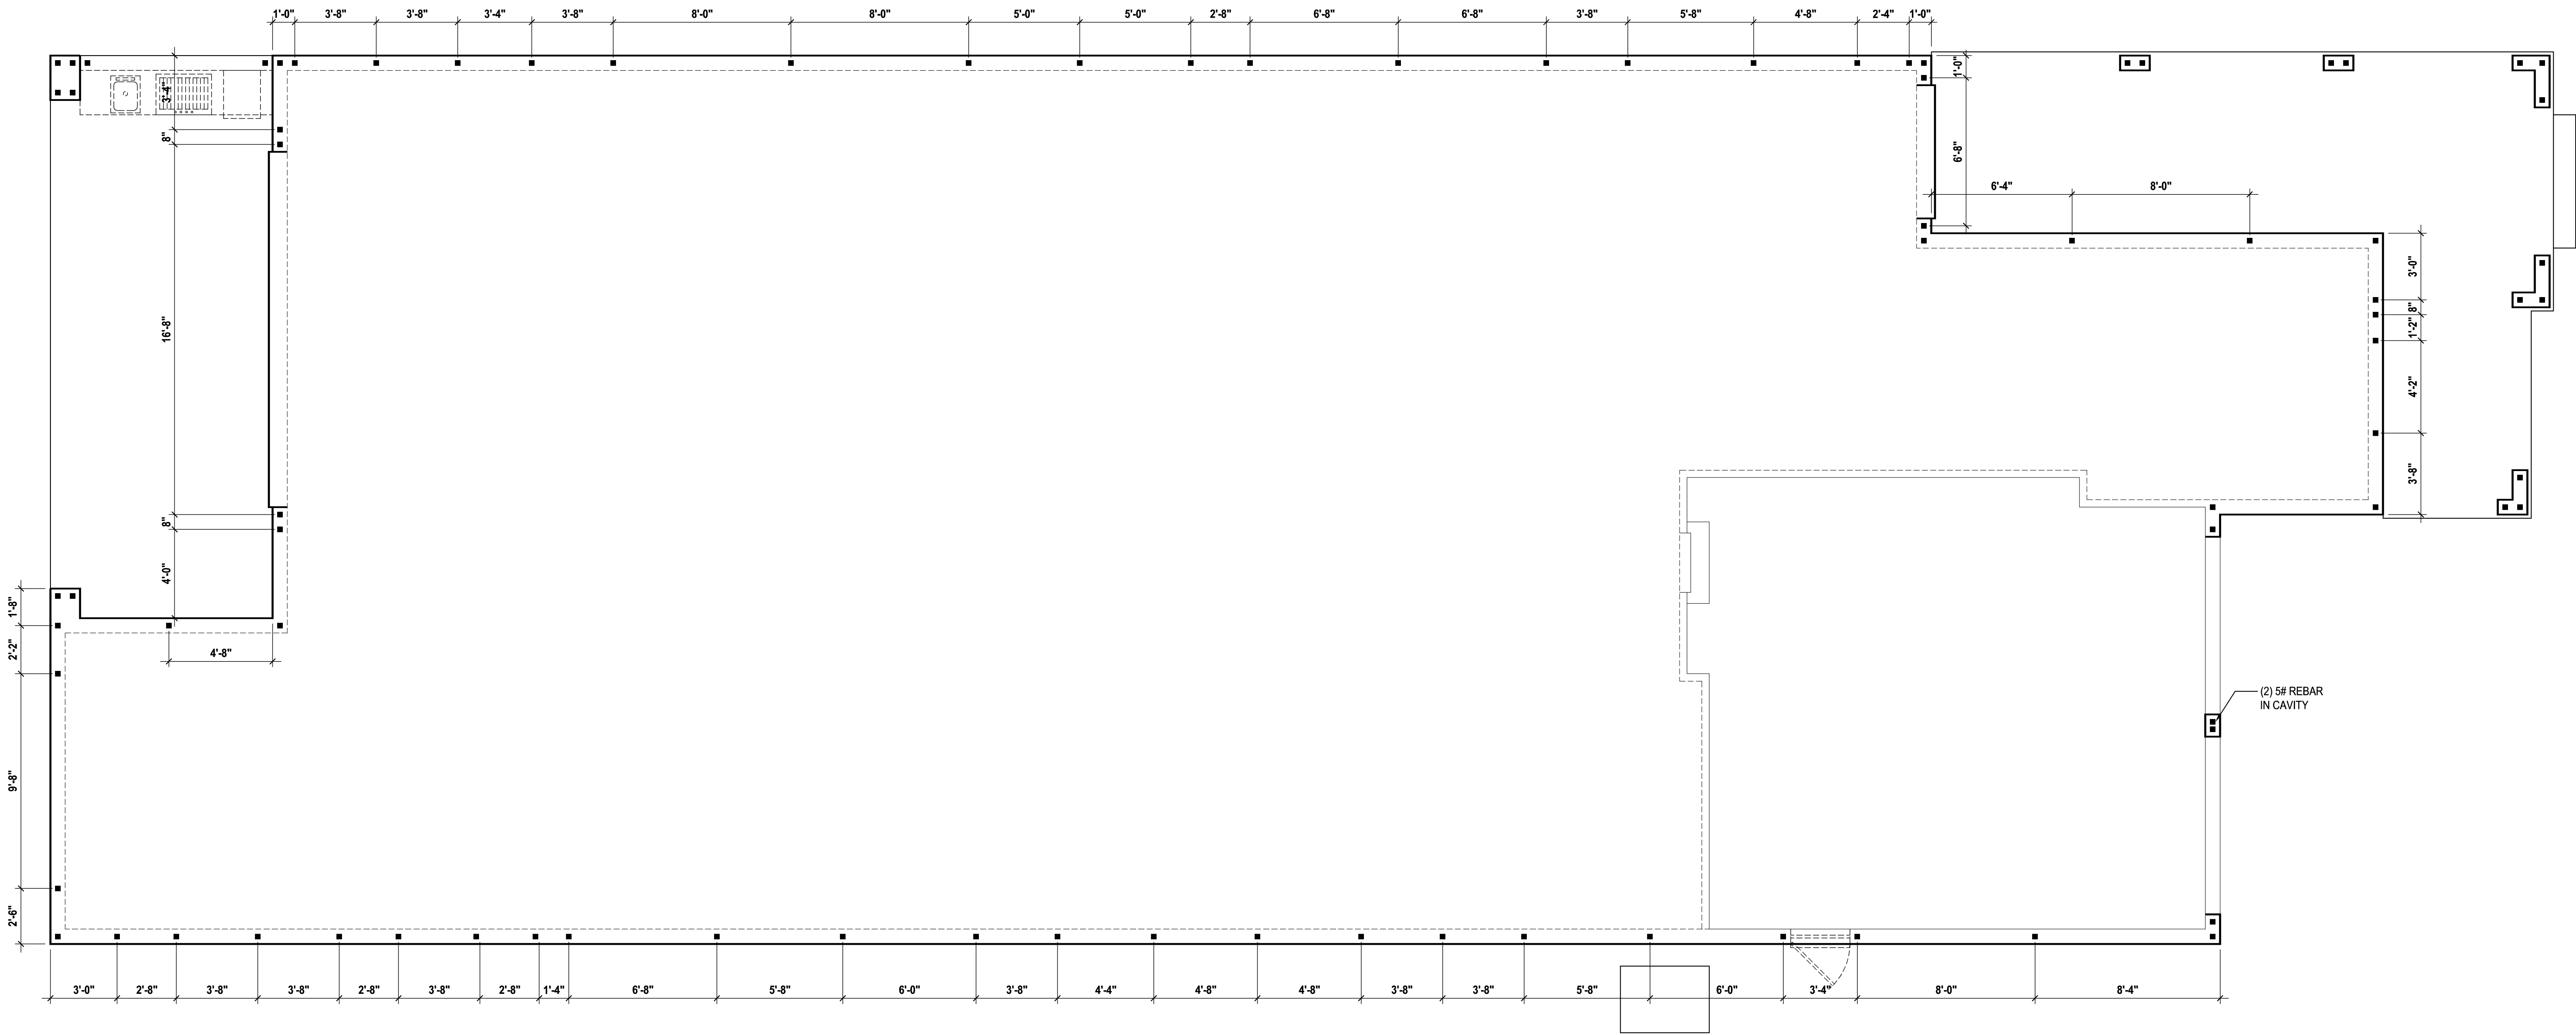

SCALE: 1/8" = 1'-0" (12x18) 1/4" = 1'-0" (24x36)


— (2) 5# REBAR  
IN CAVITY

SCALE:  $1/8" = 1'-0"$  (12x18)  $1/4" = 1'-0"$  (24x36)

DOWEL PLAN

40-3164  
DORCHESTER  
Street Address  
Lot Info  
City, State, Zip

815 Orienta Ave. Suite# 1040  
Altamonte Springs, FL. 32701  
Ph: (407) 629-6711  
Fax: (407) 629-6776  
[www.mishomedesigns.com](http://www.mishomedesigns.com)



**PREMIER**  
STRUCTURAL ENGINEERING, INC.

235 Maitland Avenue S.  
Suite 108-A  
Maitland, FL 32751  
Ph: (407) 227-7416  
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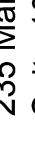


40-3164	DORCHESTER
	Street Address
	Lot Info
	City, State, Zip

**MJS**  
custom home design  
DESIGNERS • PLANNERS


815 Orienta Ave. Suite# 1040  
Altamonte Springs, FL. 32701  
Ph: (407) 629-6711  
Fax: (407) 629-6776  
[www.rjshomedesigns.com](http://www.rjshomedesigns.com)

WRITTEN DIMENSIONS SHALL HAVE PRECEDENCE OVER SCALE DIMENSIONS.  
Contractor shall verify and be responsible for dimensions and conditions of the job and MJS, Inc. must be  
consulted for any changes to the design.

 **PREMIER**  
STRUCTURAL ENGINEERING, INC.

235 Maitland Avenue S.  
Suite 108-A  
Maitland, FL 32751  
Ph: (407) 227-7416  
[www.premier-structural.com](http://www.premier-structural.com)  
FL CERT. AUTH.: 29113  
FL P#E: 60239

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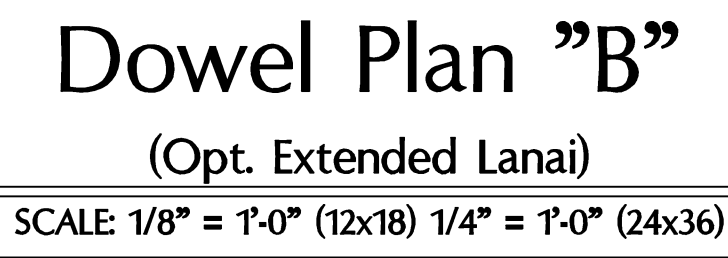
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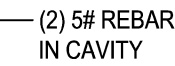

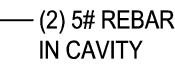
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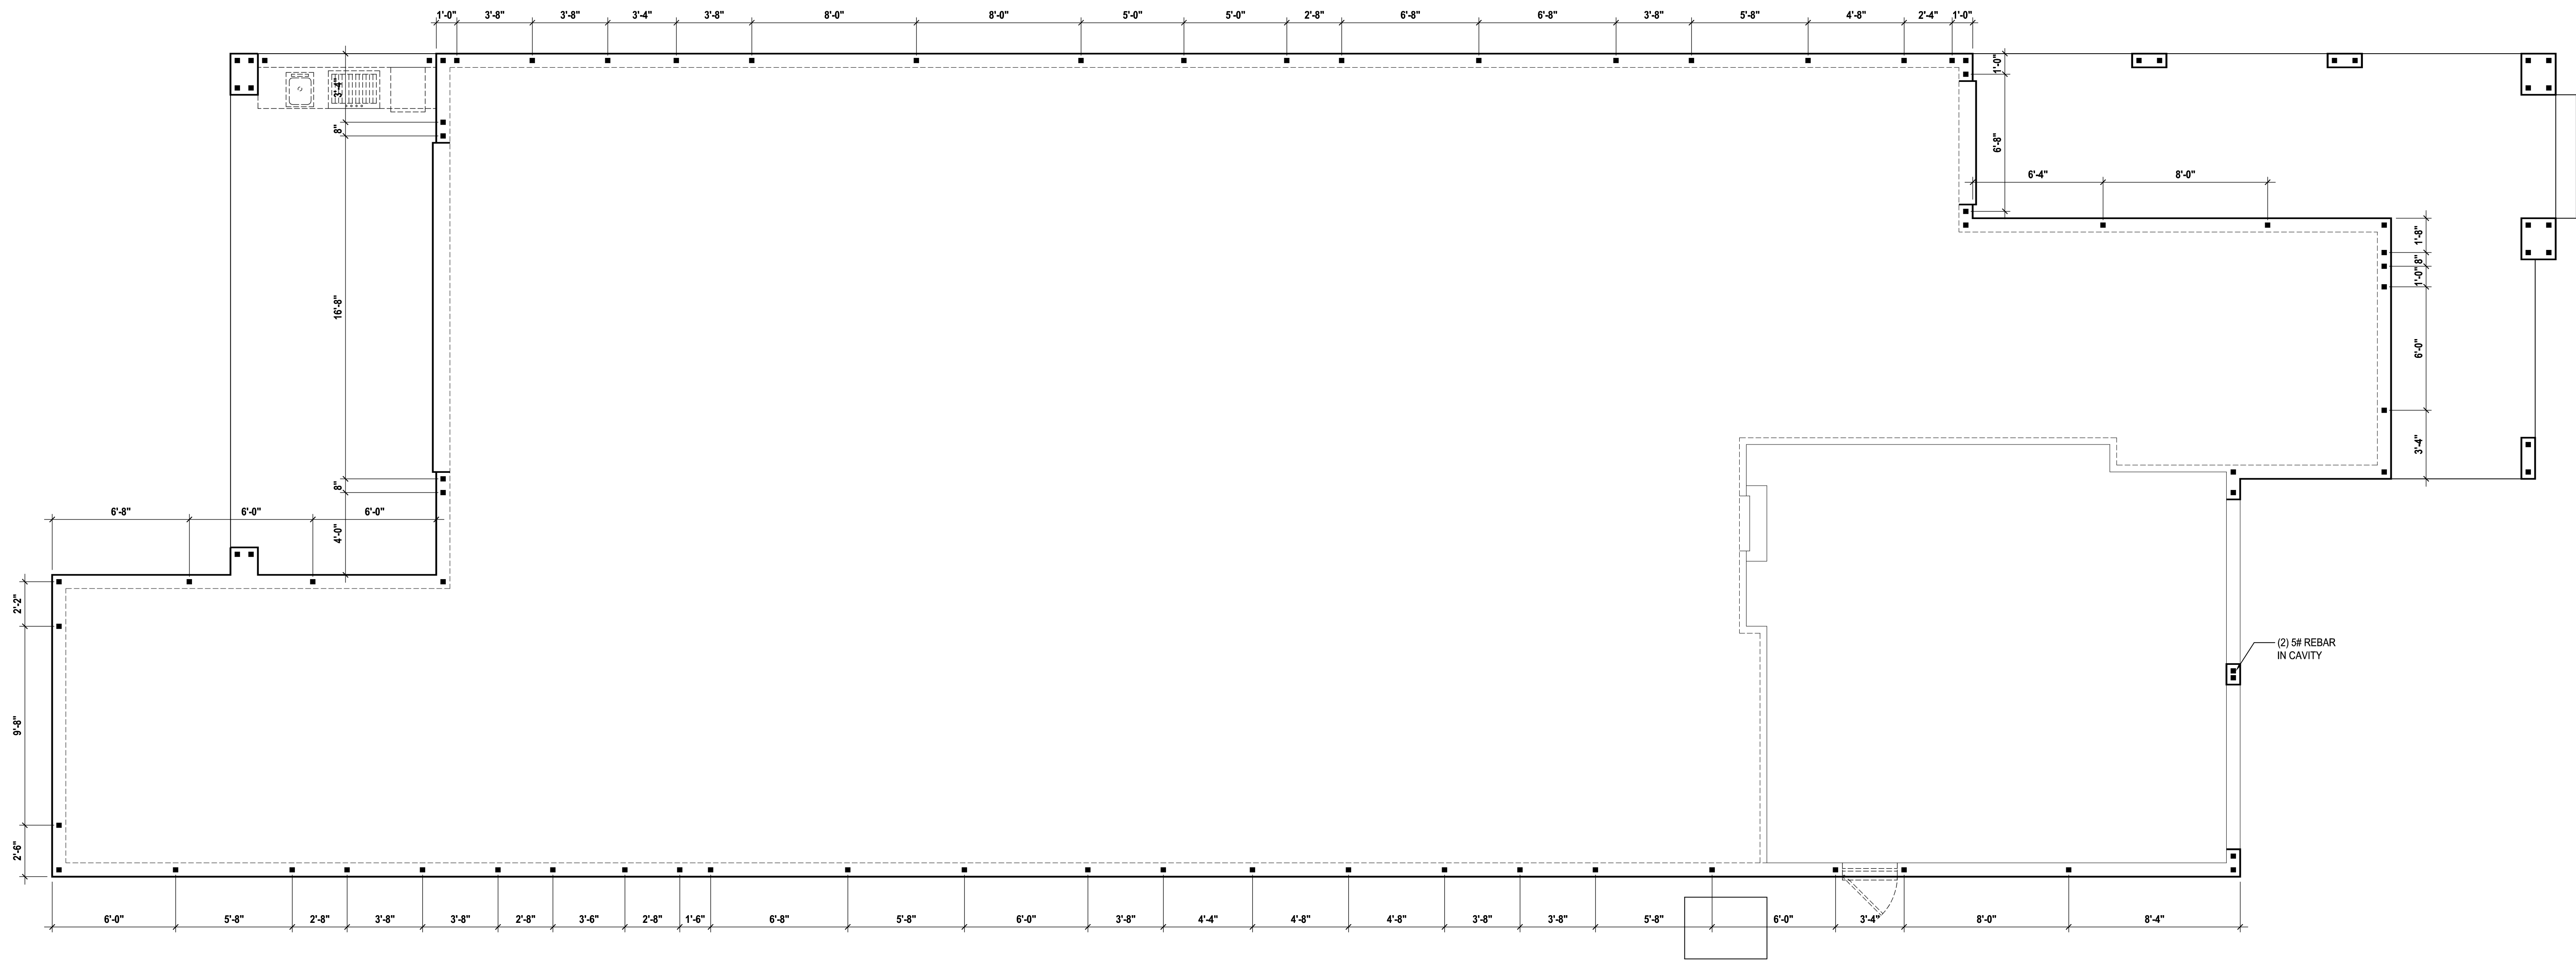
DOWEL PLAN

02.B1






SCALE: 1/8" = 1'-0" (12x18) 1/4" = 1'-0" (24x36)



## Dowel Plan "C"

(Opt. Sitting Room)

SCALE: 1/8" = 1'-0" (12x18) 1/4" = 1'-0" (24x36)

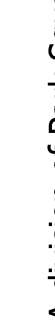

**Clark Square**  
HOMES

A Division of Park Square  
Enterprises Inc.  
5200 Vineland Rd. Suite #200  
Orlando, FL 32811  
Phone: (407) 529-3000

ISSUE DATE	00/00/0000
REVISIONS	
PROJECT:	00-0000
SCALE:	AS NOTED
DRAWN BY:	C.C.
DESIGNED BY:	MJS

DOWEL PLAN

02.C1

40-3164	DORCHESTER
	Street Address
	Lot Info
	City, State, Zip

**MJS**  
CUSTOM HOME DESIGN  
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Ph: (407) 629-6711  
Fax: (407) 629-6776  
DESIGNERS - PLANNERS [www.mjshomedesigns.com](http://www.mjshomedesigns.com)

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Maitland, FL 32751  
Ph: (407) 227-7416  
[www.premier-structural.com](http://www.premier-structural.com)  
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REVISIONS	
PROJECT:	00-0000
SCALE:	AS NOTED
DRAWN BY:	C.C.
DESIGNED BY:	MJS

**Park  
Square  
HOMES**

40-3164  
DORCHESTER  
Street Address  
Lot Info  
City, State, Zip


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Suite 108-A  
Maitland, FL 32751  
Ph: (407) 227-7416  
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FL. PE#: 60239

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FLOOR PLAN NOTES:

1. CONTRACTOR TO VERIFY ALL DIMENSIONS ON JOB SITE.
2. DO NOT SCALE PRINTS! CONSTRUCTION TO BE FROM CALCULATED DIMENSIONS ONLY. ANY DISCREPANCIES OR ERRORS TO BE REPORTED PROMPTLY TO SUPERVISOR FOR CLARIFICATION.
3. MECHANICAL EQUIP. LOCATIONS WILL BE DETERMINED BY COMMUNITY AND COUNTY CODES.
4. A/C CONDENSER UNIT TO BE ANCHORED TO SLAB PER CODE M307.2 & M1309.3.
5. PROVIDE RECESS H&C WATER w/ DRAIN @ WASHER SPACE.
6. VENT DRYER THRU EXTERIOR WALL, U.N.O.
7. PROVIDE COLD WATER LINE FOR ICE MAKER LINE @ REF. SPACE.
8. SAG RESISTANT DRYWALL ON ALL CEILINGS.
9. PULL ALL DIMENSIONS FROM THE REAR OF PLAN.
10. REFER TO EXTERIOR ELEVATIONS & TYP. DETAIL SHEETS FOR EXTERIOR WALL FINISH SPECS.
11. REFER TO DETAIL SHEETS FOR FLASHING REQUIREMENTS AT ALL WOOD TO MASONRY INTERFACES.
12. ALL INTERIOR FRAME WALL DIMENSIONS TO BE 3 1/2" U.N.O.
13. ALL EXTERIOR BLOCK WALL DIMENSIONS TO BE 7 1/2" U.N.O.
14. ALL INT. FIRST FLOOR CEILINGS AT 9'-4" U.N.O.  
•• ALL INT. SECOND FLOOR CEILINGS AT 9'-0" U.N.O.
15. C.M.U. & FRAME WALL SYSTEM SEGMENTS WHICH HAVE AN UNINTERRUPTED LENGTH OF 12'-0" OR MORE SHALL BE CONSIDERED SHEAR WALL SWS = SHEAR WALL SEGMENTS.
16. OPENING BETWEEN GARAGE AND RESIDENCE SHALL BE EQUIPPED w/ A 20 MIN. FIRE RATED SOLID WOOD OR HONEYCOMB CORE STEEL DOOR NOT LESS THAN 1 3/8" THICKNESS AS PER FBC-R302.5.1.
17. INSTALL 5/8" TYPE X DRYWALL ON GARAGE CEILING BENEATH HABITABLE ROOMS (TYP.)
18. GARAGE DOOR TO BE CERTIFIED BY MFR. FOR 140 M.P.H.
19. ALL TUB & SHOWER UNITS WILL HAVE ANTI-SCALDING DEVICES INSTALLED.
20. ALL OPERABLE WINDOWS LOCATED MORE THAN 72" ABV. SURFACE BELOW SHALL HAVE THE LOWEST PORTION OF WINDOW CLEAR OPENING A MIN. OF 24" ABOVE FINISHED FLOOR BEING SERVER PER (FBC-R312.2).
21. ALL INT. DOORS TO BE 6'-8" TALL U.N.O. OR PER BUILDER / CLIENT
22. 1/2" GYPSUM BOARD APPLIED TO THE GARAGE SIDE OF WALL TO UNDERSIDE OF DECKING
23. ALL WINDOW AND DOOR ROUGH OPENINGS VARY PER MANUFACTURER'S SPECIFICATIONS, AND ARE NOT REFLECTED ON THE PLANS. DIMENSIONS PROVIDED ON PLANS ARE USED FOR AN APPROXIMATE LOCATION OF WINDOWS & DOORS, AND DO NOT REFLECT THE ROUGH OPENINGS REQUIRED FOR PROPER INSTALLATION. BUILDER WILL BE REQUIRED TO CROSS-REFERENCE ROUGH OPENINGS AND PLAN DIMENSIONS.

BRG. HT. LEGEND

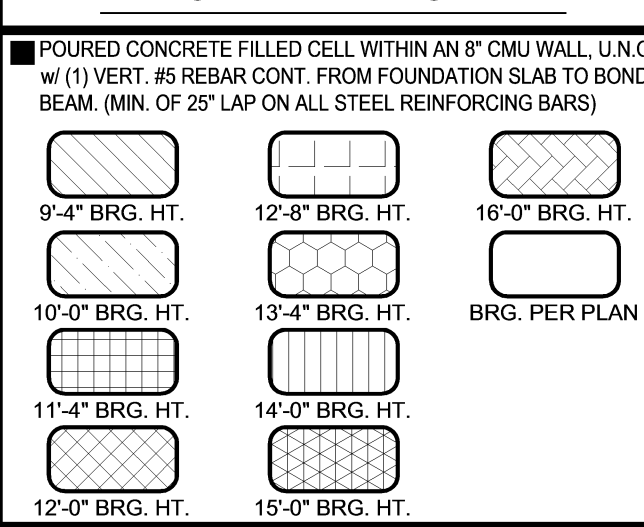

Area Tabulations

Living:	
1st floor:	3,164 sf
Total Living:	3,164 sf
entry:	318 sf
covered lanai:	253 sf
garage:	478 sf
Total Area:	4,213 sf

Floor Plan


(Opt. Pocket SGD Dr.)

SCALE: 1/8" = 1'-0" (12x18) 1/4" = 1'-0" (24x36)

Floor Plan

(Opt. Wine Room)

SCALE: 1/8" = 1'-0" (12x18) 1/4" = 1'-0" (24x36)

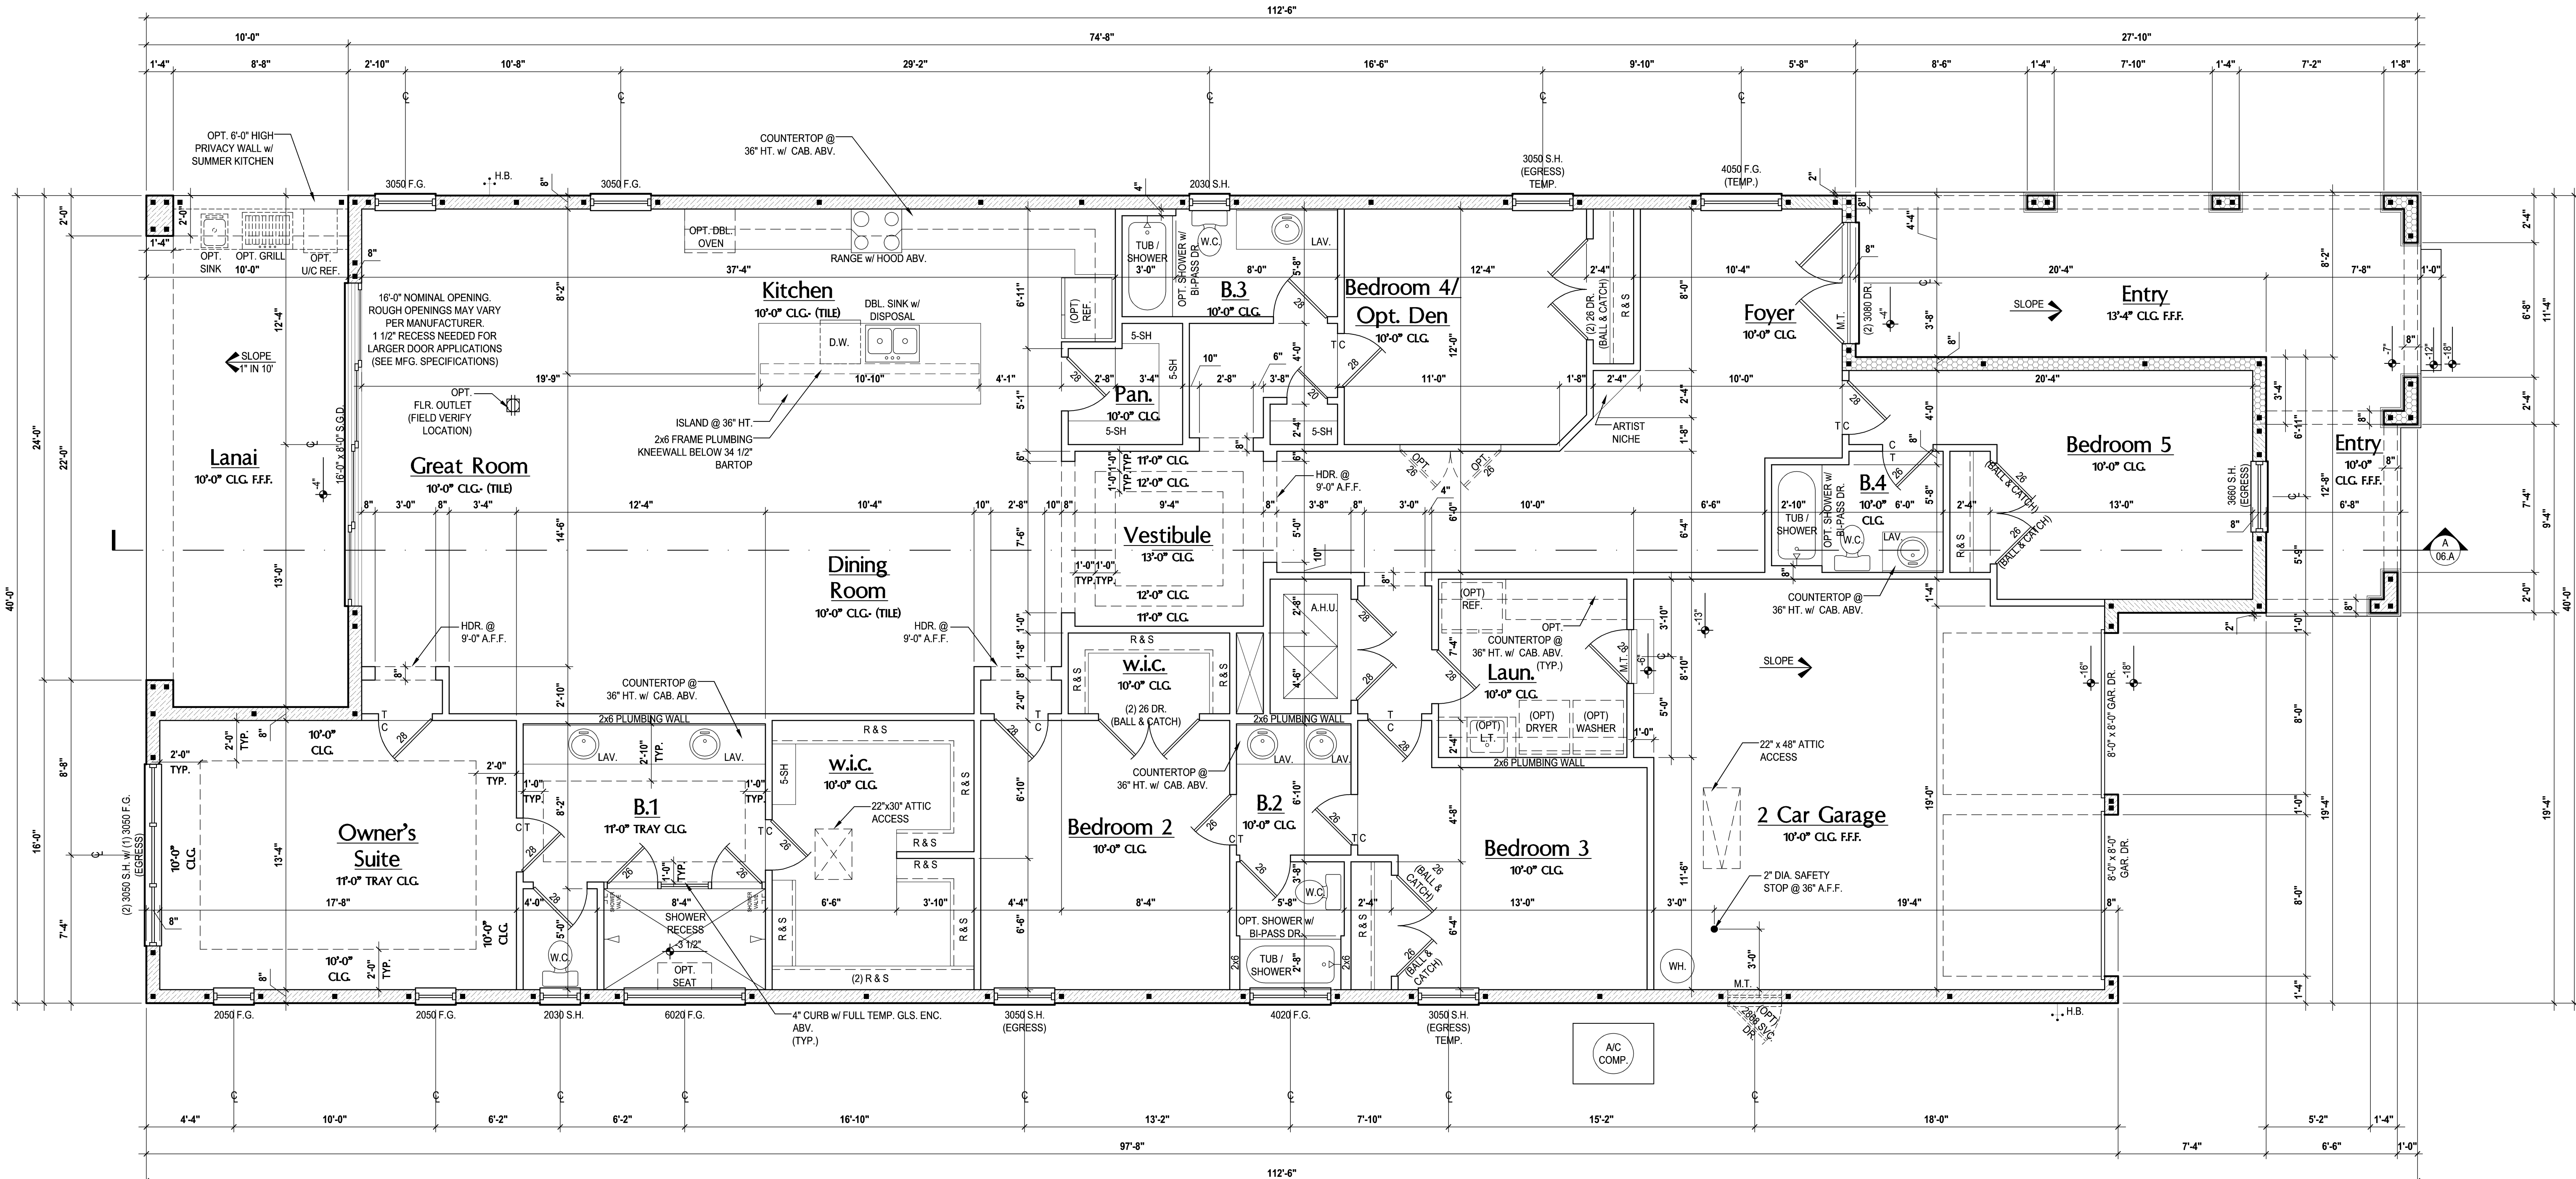

Floor Plan "A"

(Standard)

SCALE: 1/8" = 1'-0" (12x18) 1/4" = 1'-0" (24x36)

235 Maitland Avenue S.  
Suite 108-A  
Maitland, FL 32751  
Ph: (407) 227-7416  
www.premier-structural.com  
FL CERT. AUTH.: 28113  
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Fax: (407) 629-6776  
CUSTOM HOME DESIGN  
DESIGNERS - PLANNERS  
www.mjshomedesigns.com

WRITTEN DIMENSIONS SHALL HAVE PRECEDENCE OVER SCALE DIMENSIONS.  
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40-3164  
DORCHESTER  
Street Address  
Lot Info  
City, State, Zip

A Division of Park Square  
Enterprises Inc.  
5200 Vineland Rd. Suite #200  
Orlando, FL 32811  
Phone: (407) 525-3000

Park Square  
HOMES

ISSUE DATE	00/00/0000
REVISIONS	
PROJECT:	00-0000
SCALE:	AS NOTED
DRAWN BY:	C.C.
DESIGNED BY:	MJS

FLOOR PLAN  
03.A


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- CONTRACTOR TO VERIFY ALL DIMENSIONS ON JOB SITE.
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  - PULL ALL DIMENSIONS FROM THE REAR OF PLAN.
  - REFER TO EXTERIOR ELEVATIONS & TYP. DETAIL SHEETS FOR EXTERIOR WALL FINISH SPECS.
  - REFER TO DETAIL SHEETS FOR FLASHING REQUIREMENTS AT ALL WOOD TO MASONRY INTERFACES.
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• ALL INT. SECOND FLOOR CEILINGS AT 9'-0" U.N.O.
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**BRG. HT. LEGEND**

POURED CONCRETE FILLED CELL WITHIN AN 8" CMU WALL, U.N.O. w/ (1) VERT. #5 REBAR CONT. FROM FOUNDATION SLAB TO BOND BEAM. (MIN. OF 25" LAP ON ALL STEEL REINFORCING BARS)		
9'-4" BRG. HT.	12'-8" BRG. HT.	16'-0" BRG. HT.
10'-0" BRG. HT.	13'-4" BRG. HT.	BRG. PER PLAN
11'-4" BRG. HT.	14'-0" BRG. HT.	
12'-0" BRG. HT.	15'-0" BRG. HT.	

**Area Tabulations**

Living:	
1st floor:	3,291 sf
Total Living:	3,291 sf
entry:	318 sf
covered lanai:	253 sf
garage:	478 sf
Total Area:	4,340 sf

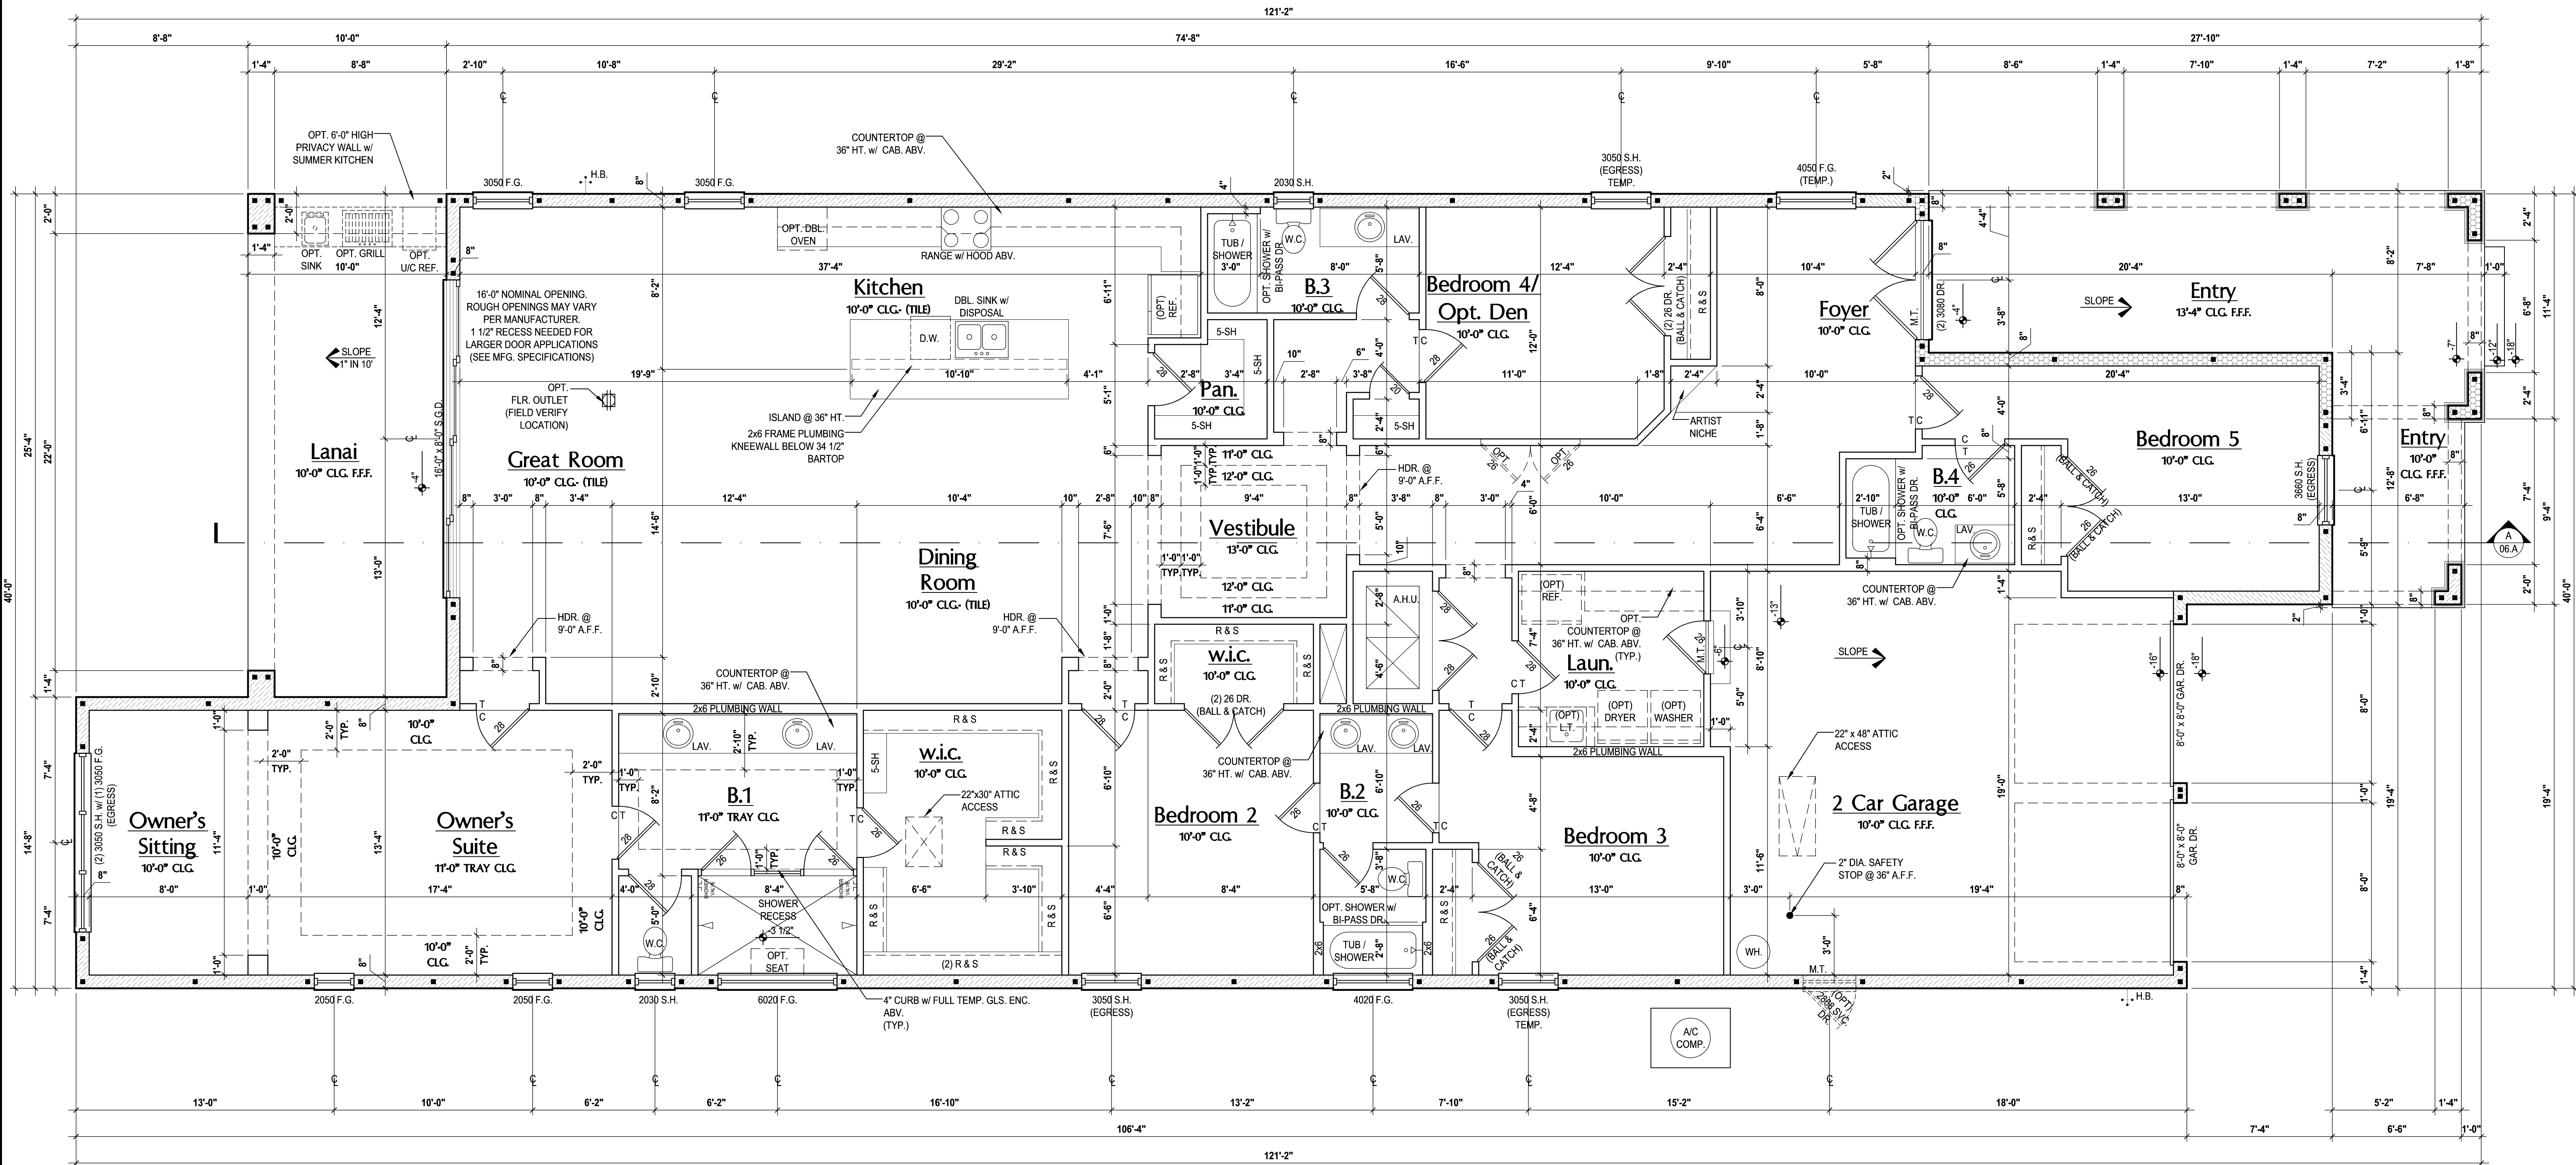

**Floor Plan "A"**  
(Opt. Sitting Rm.)

SCALE: 1/8" = 1'-0" (12x18) 1/4" = 1'-0" (24x36)

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Suite 108-A  
Maitland, FL 32751  
Ph: (407) 227-7416  
www.premier-structural.com  
FL. CERT. AUTH.: 28113  
FL. PER#: 80239

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STRUCTURAL ENGINEERS, P.A.C.

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**MJS**

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Corrections and work not be responsible for dimensions and conditions of the job and M.J.S. Inc. shall be held harmless for any errors, omissions, and/or misinterpretations, whether in drawing or plan.

40-3164  
**DORCHESTER**  
Street Address  
Lot Info  
City, State, Zip

A Division of Park Square  
Enterprises Inc.  
5200 Vineland Rd., Suite #200  
Orlando, FL 32811  
Phone: (407) 525-3000

**Park Square HOMES**

ISSUE DATE: 00/00/0000

REVISIONS


PROJECT: 00-0000  
SCALE: AS NOTED  
DRAWN BY: C.C.  
DESIGNED BY: MJS

FLOOR PLAN  
**03.A1**

FLOOR PLAN NOTES:


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7. PROVIDE COLD WATER LINE FOR ICE MAKER LINE @ REF. SPACE.
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BRG. HT. LEGEND

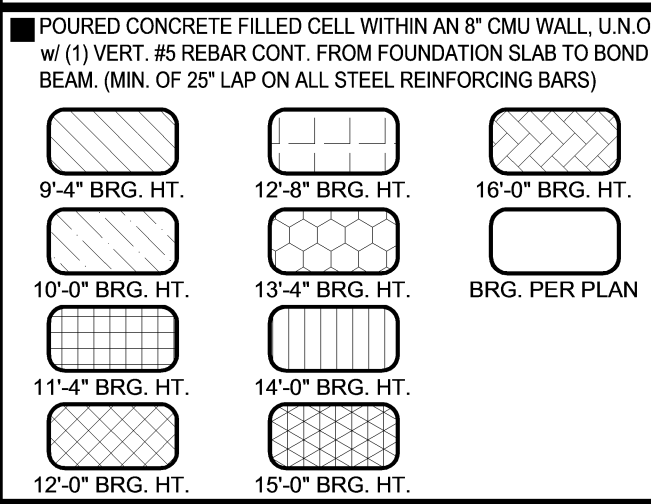

Area Tabulations

Living:	
1st floor:	3,164 sf
Total Living:	3,164 sf
entry:	318 sf
covered lanai:	513 sf
garage:	478 sf
Total Area:	4,473 sf

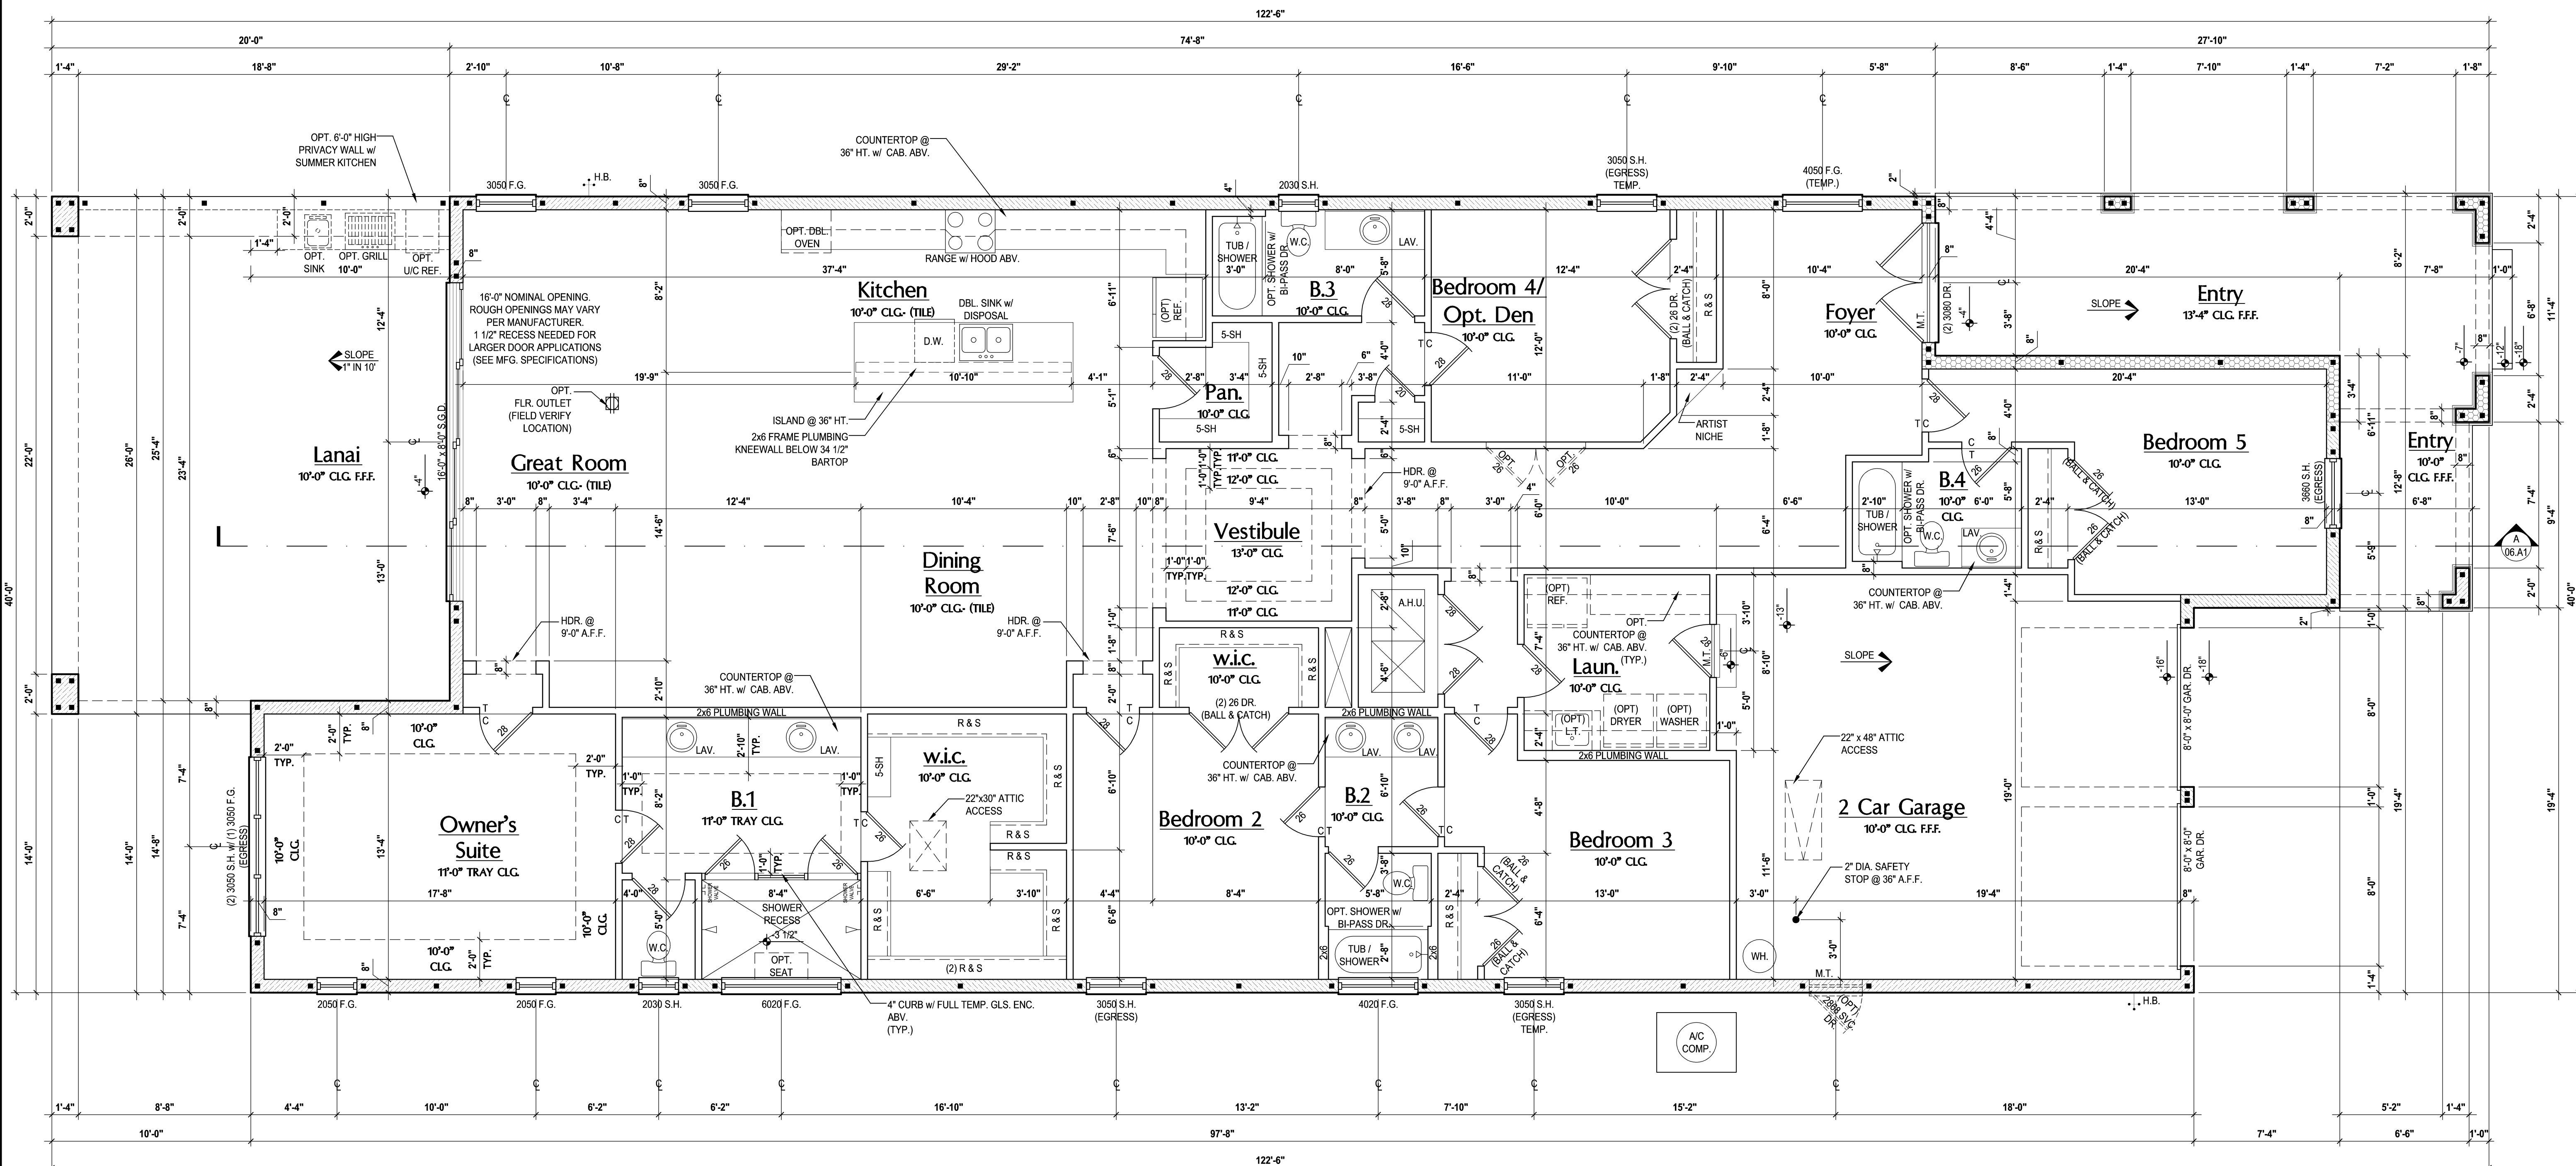

Floor Plan "A"  
(Opt. Extended Lanai)

SCALE: 1/8" = 1'-0" (12x18) 1/4" = 1'-0" (24x36)

235 Maitland Avenue S.  
Suite 108-A  
Maitland, FL 32751  
Ph: (407) 227-7416  
www.premier-structural.com  
FL CERT. AUTH.: 28113  
FL. PE#: 60239

**PREMIER**  
STRUCTURAL ENGINEERS, P.A.C.

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Altamonte Springs, FL 32701  
Ph: (407) 629-6711  
CUSTOM HOME DESIGN  
DESIGNERS - PLANNERS  
www.mjshomedesigns.com

**MJS**

WRITTEN DIMENSIONS SHALL HAVE PRECEDENCE OVER SCALE DIMENSIONS.  
Contractor shall verify and be responsible for dimensions and locations of the job and MJS shall not be responsible for any errors or omissions in the plans. MJS shall not be responsible for any errors or omissions in the plans.

40-3164  
**DORCHESTER**  
Street Address  
Lot Info  
City, State, Zip

A Division of Park Square  
Enterprises Inc.  
5200 Vineland Rd., Suite #200  
Orlando, FL 32811  
Phone: (407) 525-3000

**Park Square HOMES**

ISSUE DATE: 00/00/0000

REVISIONS


PROJECT: 00-0000  
SCALE: AS NOTED  
DRAWN BY: C.C.  
DESIGNED BY: MJJS

FLOOR PLAN  
**03.A2**

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BRG. HT. LEGEND





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Total Living:	3,164 sf
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covered lanai:	253 sf
garage:	478 sf
Total Area:	4,213 sf

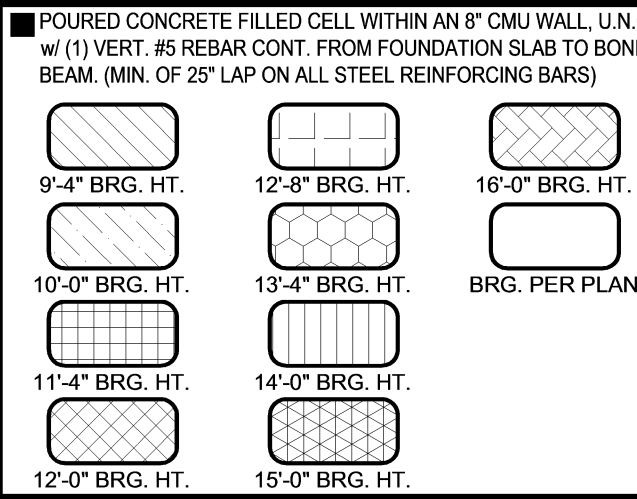Floor Plan

(Opt. Pocket SGD Dr.)


SCALE: 1/8" = 1'-0" (12x18) 1/4" = 1'-0" (24x36)

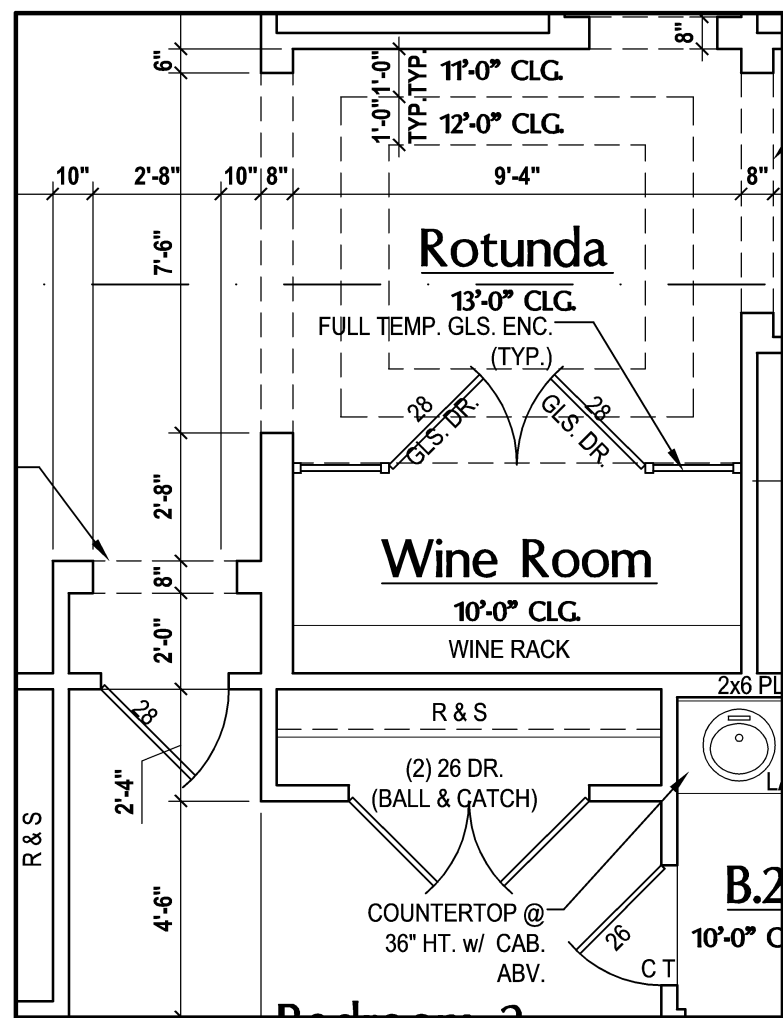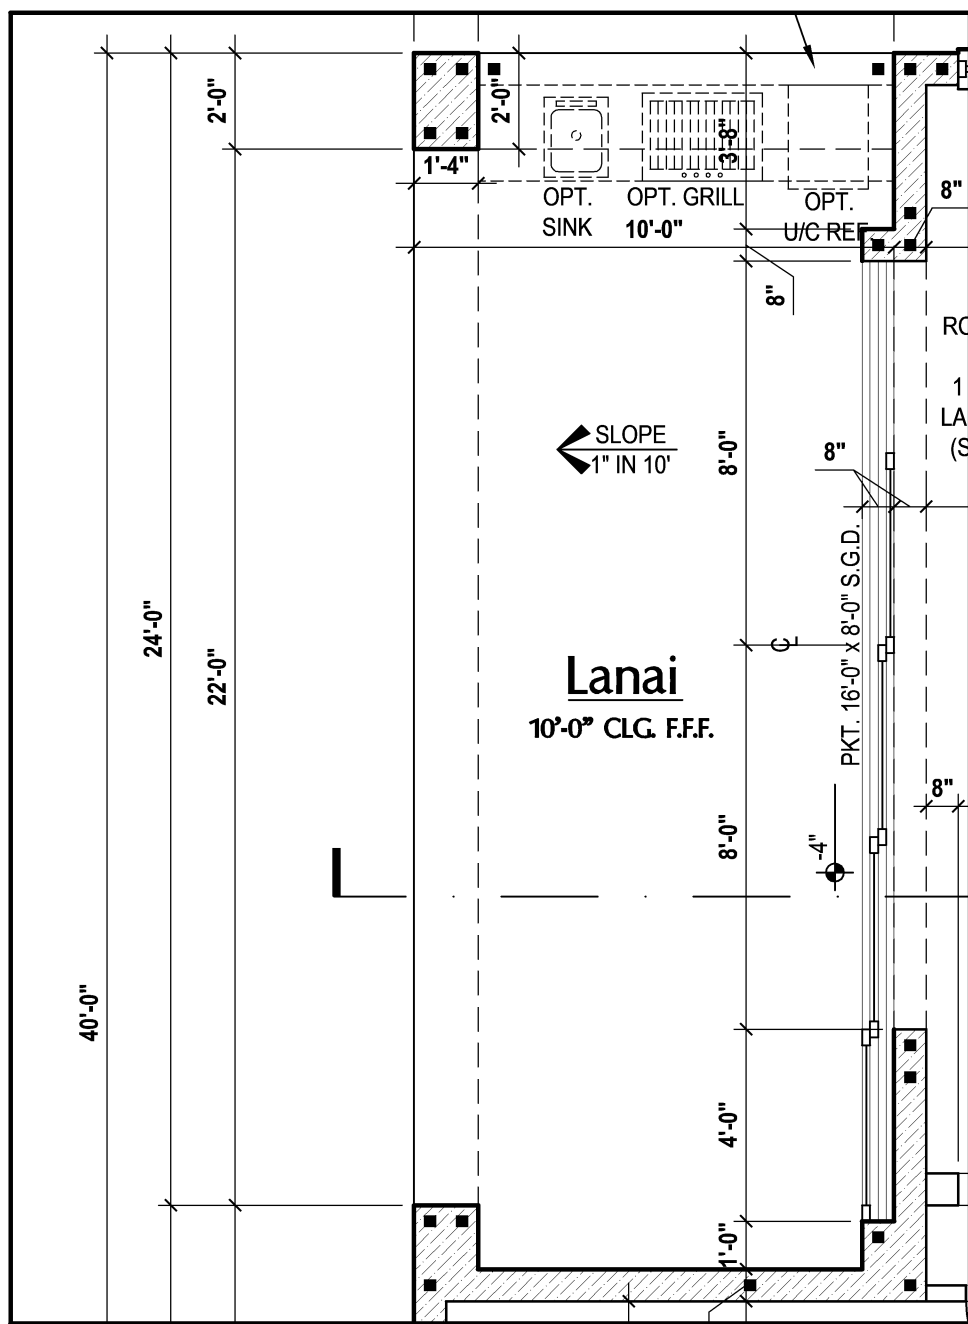

Floor Plan

(Opt. Wine Room)

SCALE: 1/8" = 1'-0" (12x18) 1/4" = 1'-0" (24x36)

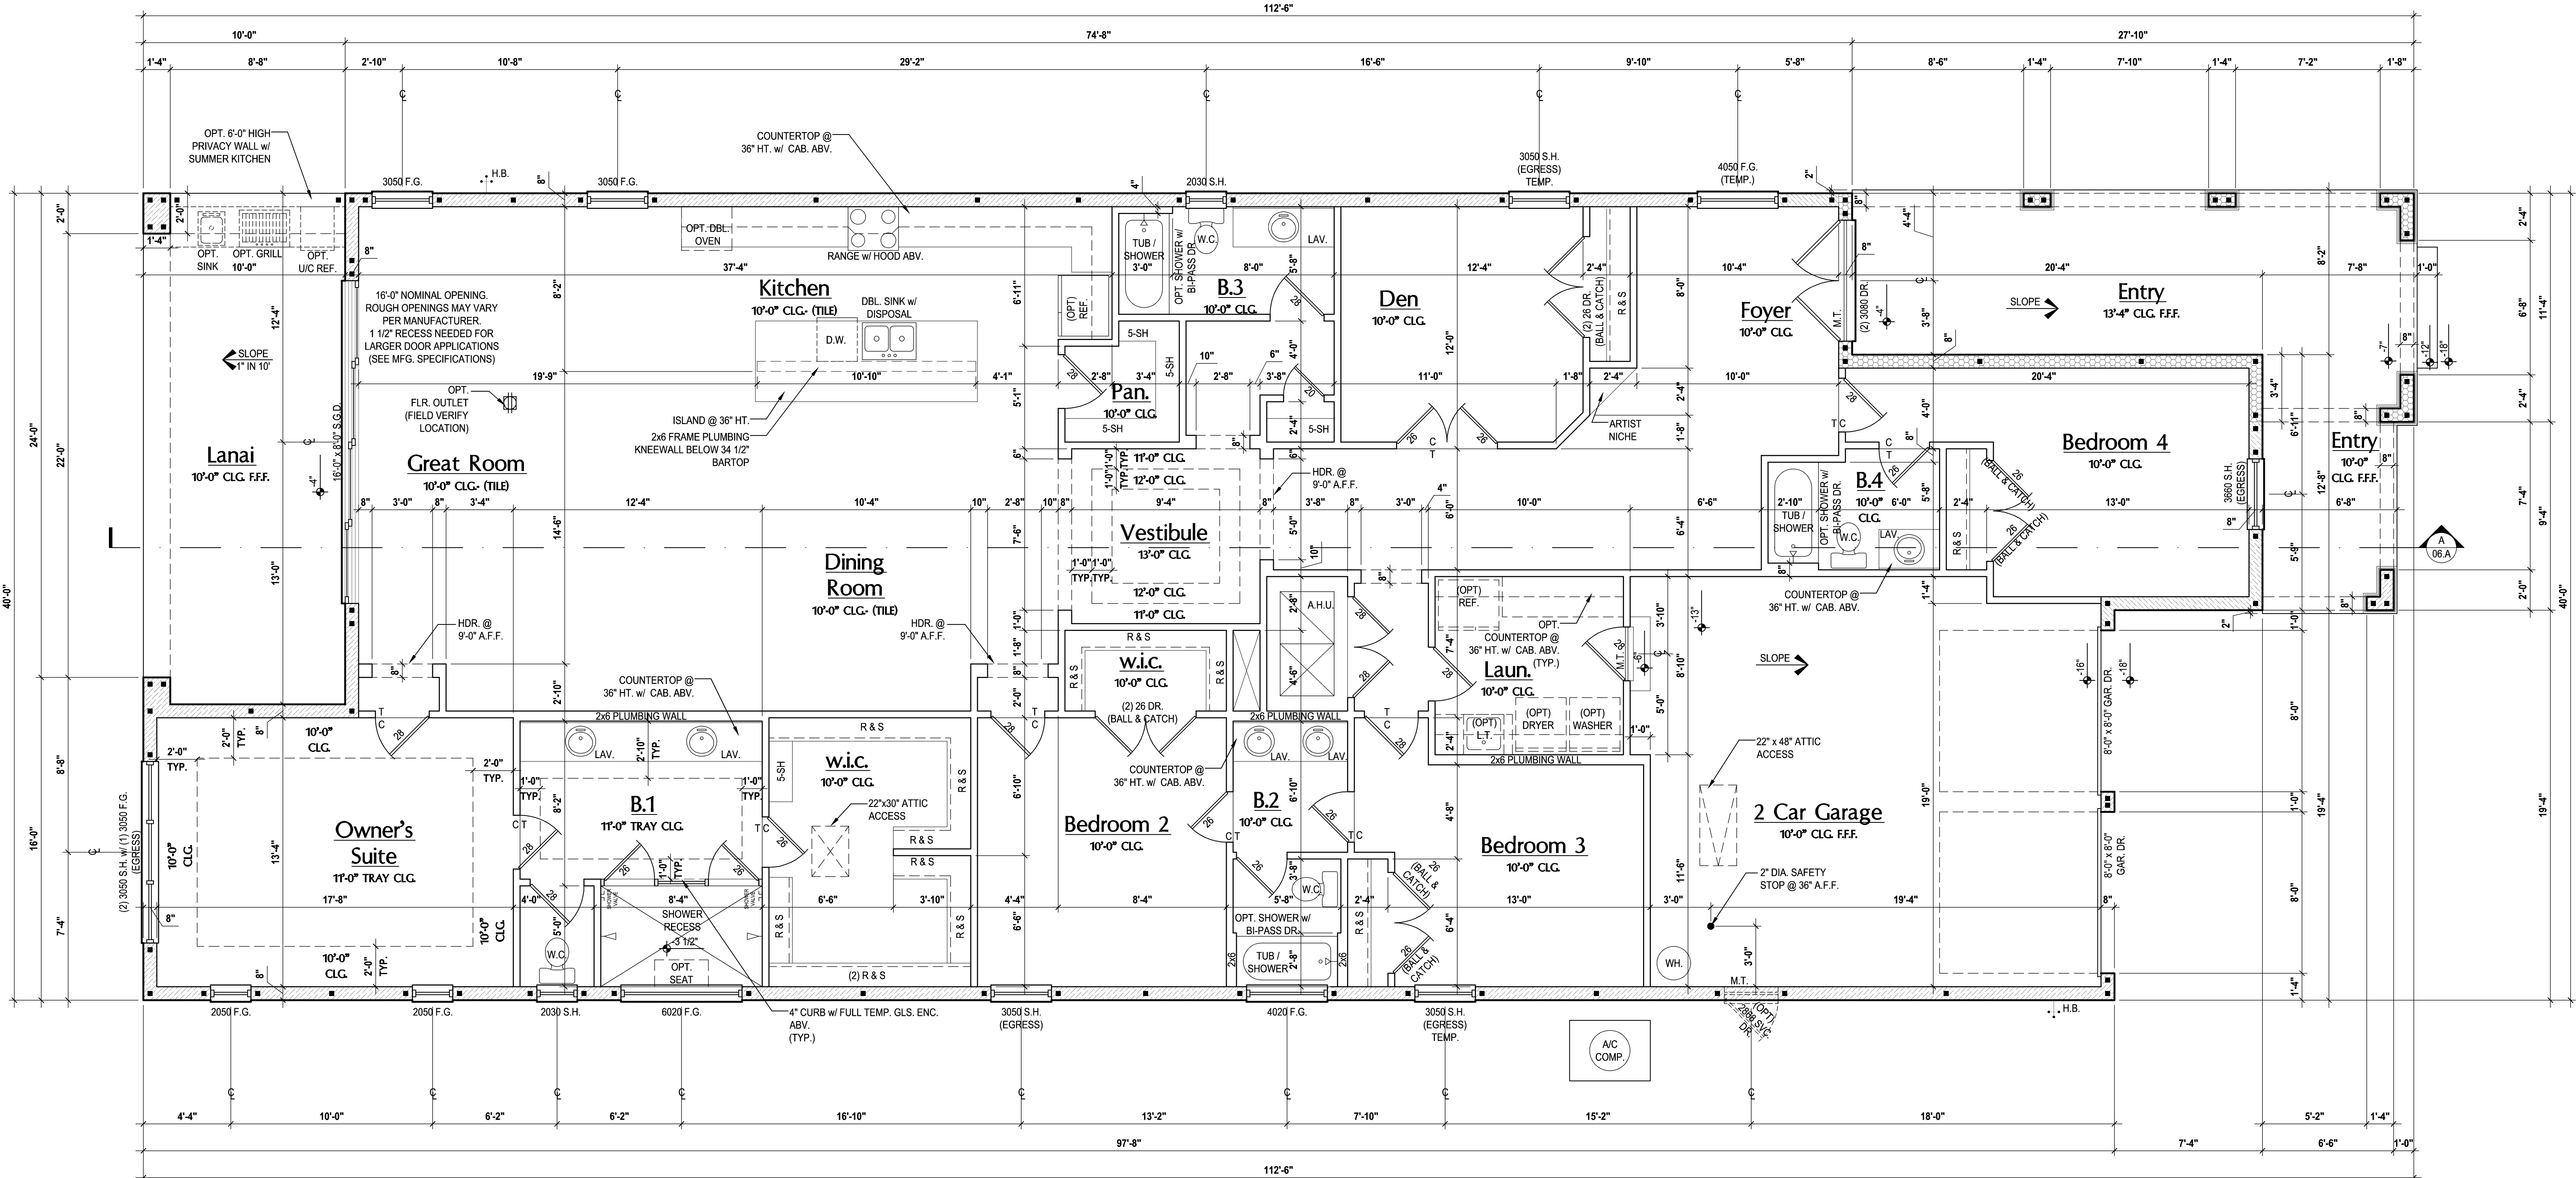

Floor Plan "A"

(Opt. Study)

SCALE: 1/8" = 1'-0" (12x18) 1/4" = 1'-0" (24x36)

40-3164

DORCHESTER

Street Address

Lot Info

City, State, Zip


A Division of Park Square

Enterprises Inc.

5200 Vineland Rd., Suite #200

Orlando, FL 32811

Phone: (407) 525-3000

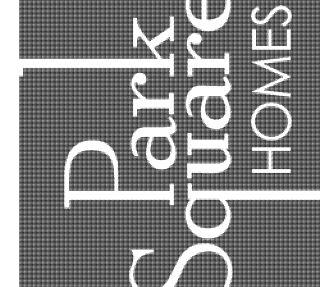

ISSUE DATE	00/00/0000
REVISIONS	
PROJECT:	00-0000
SCALE:	AS NOTED
DRAWN BY:	C.C.
DESIGNED BY:	MJS

FLOOR PLAN

03.A3

815 Orienta Ave. Suite# 1040

Altamonte Springs, FL 32701

Ph: (407) 629-6711

Fax: (407) 629-6776

CUSTOM HOME DESIGN



DESIGNERS - PLANNERS

www.mjshomedesigns.com

www.premier-structural.com

FL. CERT. AUTH.: 28113

FL. PER#: 60239



235 Maitland Avenue S.

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Maitland, FL 32751

Ph: (407) 227-7416

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BRG. HT. LEGEND

POURED CONCRETE FILLED CELL WITHIN AN 8" CMU WALL, U.N.O. w/ (1) VERT. #5 REBAR CONT. FROM FOUNDATION SLAB TO BOND BEAM. (MIN. OF 25" LAP ON ALL STEEL REINFORCING BARS)

9'-4" BRG. HT.

10'-0" BRG. HT.

11'-4" BRG. HT.

12'-0" BRG. HT.

12'-8" BRG. HT.

13'-4" BRG. HT.

14'-0" BRG. HT.

15'-0" BRG. HT.

16'-0" BRG. HT.

BRG. PER PLAN

Area Tabulations

Living:

1st floor: 3,164 sf

Total Living: 3,164 sf

entry: 323 sf

covered lanai: 253 sf

garage: 478 sf

Total Area: 4,218 sf

Floor Plan "B"

(Standard)

SCALE: 1/8" = 1'-0" (12x18) 1/4" = 1'-0" (24x36)

Aug 26, 2019 8:32am

Carlos Z:\Park Square Homes\MODELS\ORLANDO MODEL\140 Models (Horizon West)\MODEL\SThe Dorchester (40-3164)\03 B Floor Plan.dwg

235 Maitland Avenue S.  
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Maitland, FL 32751  
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www.premier-structural.com  
FL CERT. AUTH.: 29113  
FL. PER#: 60239

PREMIER

STRUCTURAL ENGINEERS, P.A.C.

815 Orienta Ave. Suite# 1040  
Altamonte Springs, FL 32701  
Ph: (407) 629-6711  
Fax: (407) 629-6717  
www.mjshomedesigns.com

MJS

DESIGNERS - PLANNERS

40-3164

DORCHESTER

Street Address  
Lot Info  
City, State, Zip

A Division of Park Square  
Enterprises Inc.  
5200 Vineland Rd. Suite #200  
Orlando, FL 32811  
Phone: (407) 525-3000

Park Square

HOMES

ISSUE DATE: 00/00/0000

REVISIONS

PROJECT: 00-0000

SCALE: AS NOTED

DRAWN BY: C.C.

DESIGNED BY: MJJS

FLOOR PLAN

03.B


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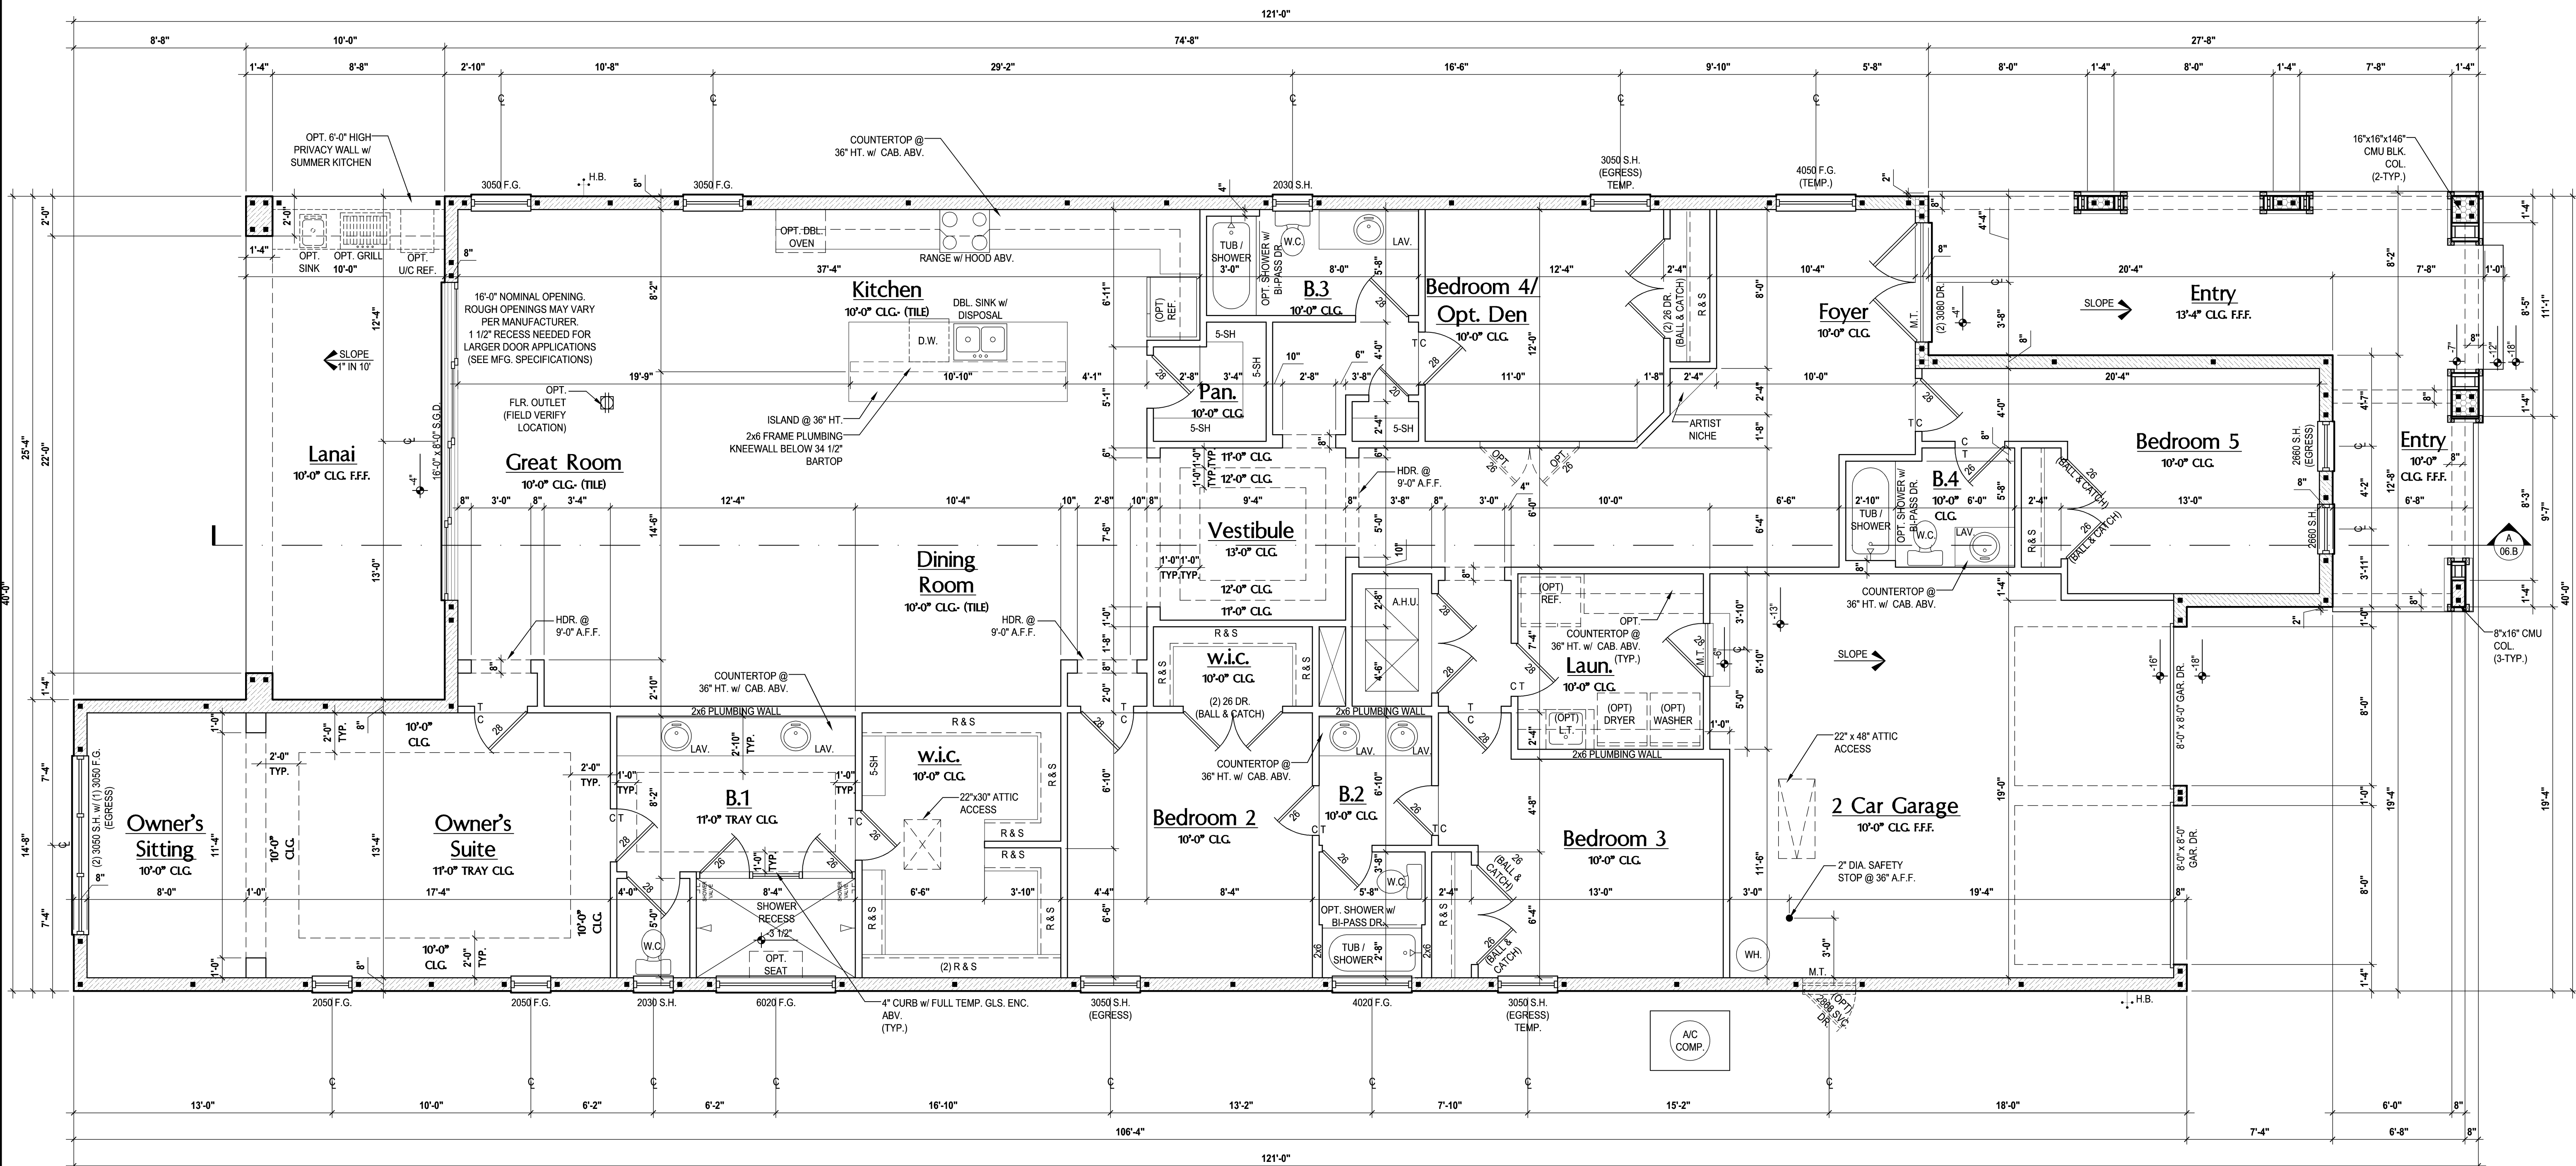
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BRG. HT. LEGEND



Area Tabulations

Living:	
1st floor:	3,291 sf
Total Living:	3,291 sf
entry:	318 sf
covered lanai:	253 sf
garage:	478 sf
Total Area:	4,340 sf

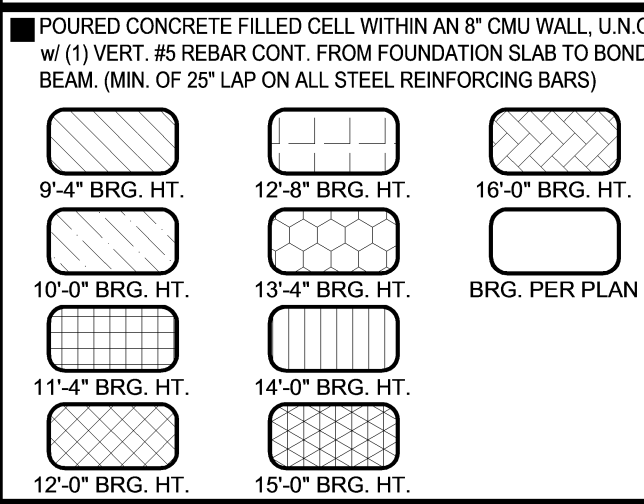

Floor Plan "B"

(Opt. Sitting Rm.)

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ISSUE DATE: 00/00/0000  
REVISIONS:  
PROJECT: 00-0000  
SCALE: AS NOTED  
DRAWN BY: C.C.  
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FLOOR PLAN  
03.B1


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Carlos Z:\Park Square Homes\MODELS\ORLANDO MODEL\340 Models (Horizon West)\MODEL\SThe Dorchester (40-3164)\03.B2 Floor Plan (Opt. Extended Lanai).dwg  
Aug 26, 2019 8:32am

FLOOR PLAN NOTES:


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BRG. HT. LEGEND



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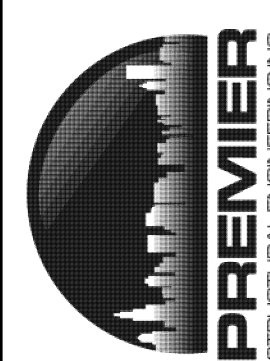


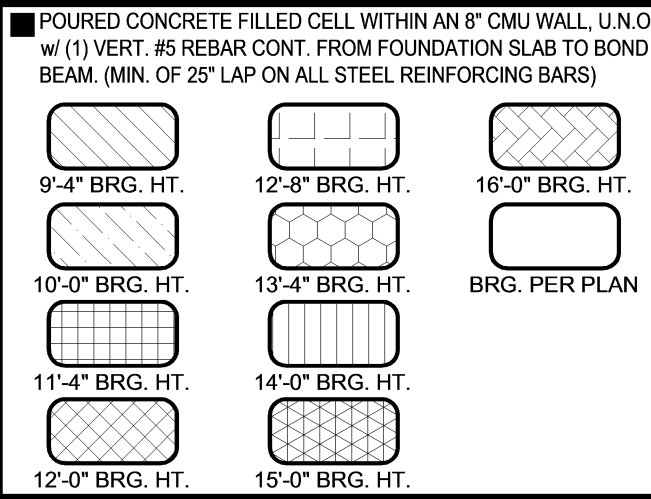Floor Plan "B"

(Opt. Extended Lanai)
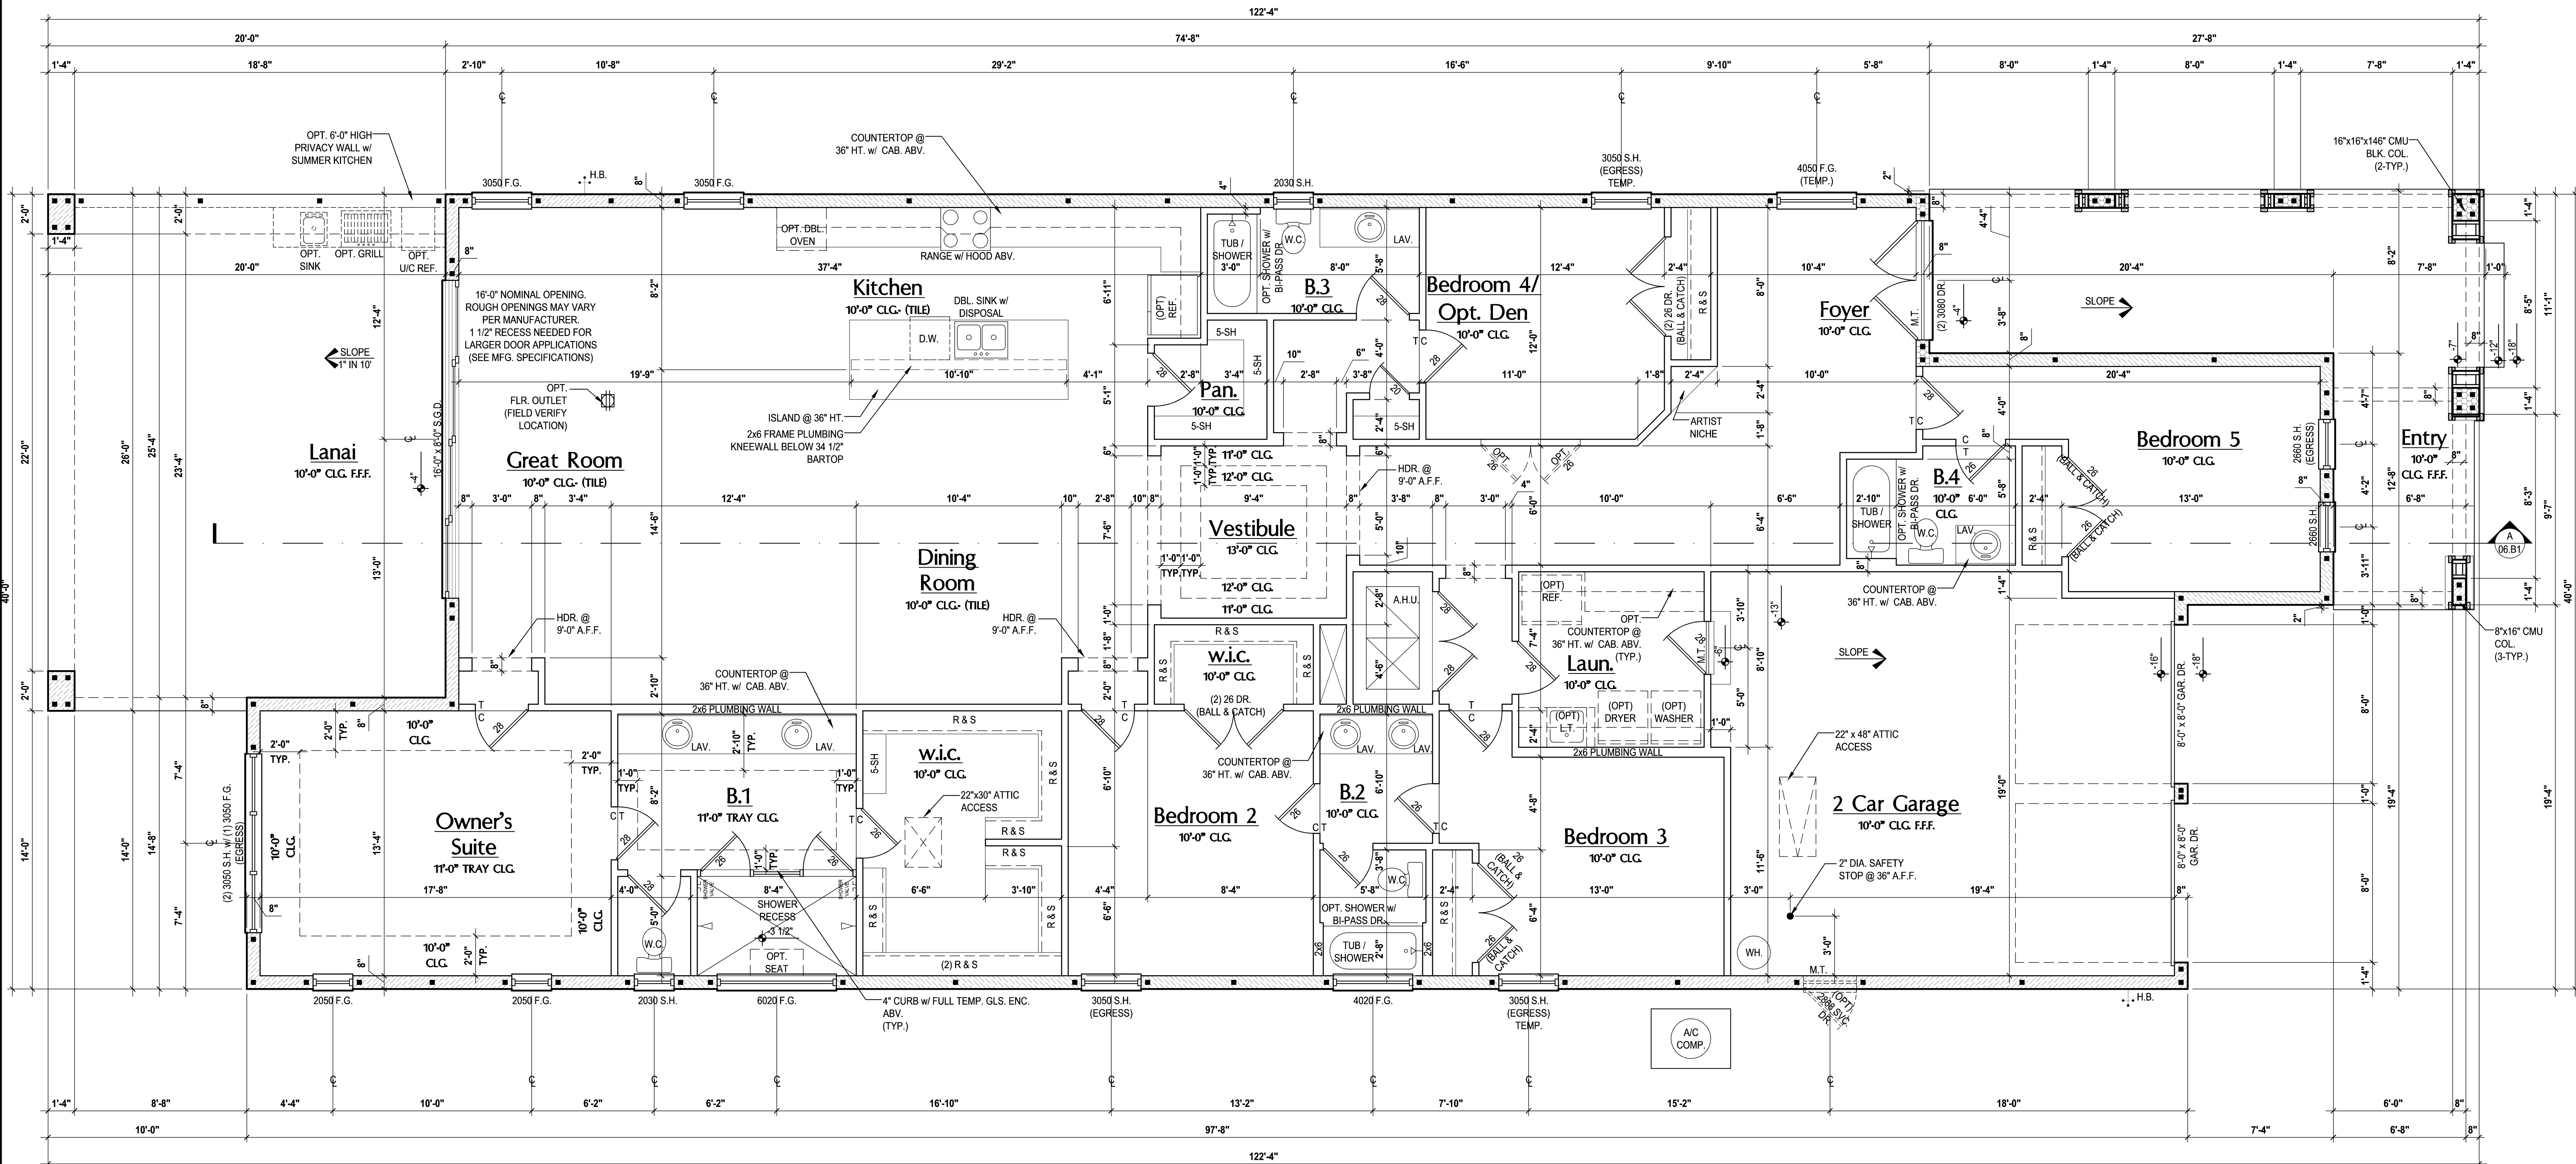
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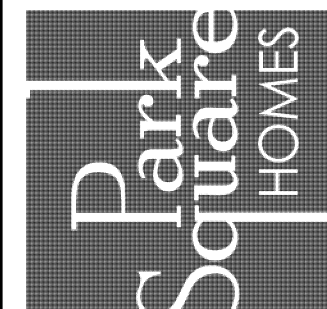
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CUSTOM HOME DESIGN  
DESIGNERS - PLANNERS  
www.mjshomedesigns.com

40-3164  
DORCHESTER  
Street Address  
Lot Info  
City, State, Zip

A Division of Park Square  
Enterprises Inc.  
5200 Vineland Rd. Suite #200  
Orlando, FL 32811  
Phone: (407) 525-3000



ISSUE DATE	00/00/0000
REVISIONS	
PROJECT:	00-0000
SCALE:	AS NOTED
DRAWN BY:	C.C.
DESIGNED BY:	MJS

FLOOR PLAN

03.B2

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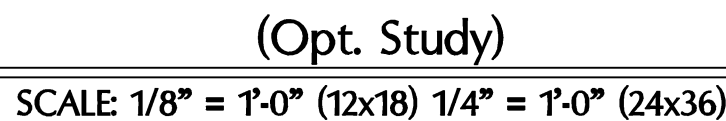
\_\_\_\_\_

20. ALL OPERABLE WINDOWS LOCATED MORE THAN 72" ABV. SURFACE BELOW SHALL HAVE THE LOWEST PORTION OF WINDOW CLEAR OPENING A MIN. OF 24" ABOVE FINISHED FLOOR BEING SERVER PER (IBC-KN131.2).
21. ALL INT. DOORS TO BE 6" TALL U.N.O. OR PER BUILDER / CLIENT
22. 1/2" GYPSUM BOARD APPLIED TO THE GARAGE SIDE OF WALL TO UNDERSIDE OF DECKING
23. ALL WINDOW AND DOOR ROUGH OPENINGS VARY PER MANUFACTURERS SPECIFICATIONS, AND ARE NOT REFLECTED ON THE PLANS. DIMENSIONS PROVIDED ON PLANS ARE USED FOR AN APPROXIMATE LOCATION OF WINDOWS & DOORS, AND DO NOT REFLECT THE ROUGH OPENINGS REQUIRED FOR PROPER INSTALLATION. BUILDER WILL BE REQUIRED TO CROSS-REFERENCE ROUGH OPENINGS AND PLAN DIMENSIONS.

POURED CONCRETE FILLED CELL WITHIN AN 8" CMU WALL, U.N.O.  
w/ (1) VERT. U.S. REBAR CONT. FROM FOUNDATION SLAB TO BOND  
BEAM. (MIN. OF 25" LAP ON ALL STEEL REINFORCING BARS)

9'-4" BRG. HT. 	12'-8" BRG. HT. 	16'-0" BRG. HT. 
10'-0" BRG. HT. 	13'-4" BRG. HT. 	BRG. PER PLAN 
11'-4" BRG. HT. 	14'-0" BRG. HT. 	
12'-0" BRG. HT. 	15'-0" BRG. HT. 	

---



- FLOOR PLAN NOTES:
1. CONTRACTOR TO VERIFY ALL DIMENSIONS ON JOB SITE.

2. DO NOT SCALE PRINTS! CONSTRUCTION TO BE FROM CALCULATED DIMENSIONS ONLY. ANY DISCREPANCIES OR ERRORS TO BE REPORTED PROMPTLY TO SUPERVISOR FOR CLARIFICATION.

3. MECHANICAL EQUIP. LOCATIONS WILL BE DETERMINED BY COMMUNITY AND COUNTY CODES.

4. A/C CONDENSER UNIT TO BE ANCHORED TO SLAB PER CODE M307.2 & M1309.3.

5. PROVIDE RECESS H&C WATER w/ DRAIN @ WASHER SPACE.

6. VENT DRYER THRU EXTERIOR WALL, U.N.O.

7. PROVIDE COLD WATER LINE FOR ICE MAKER LINE @ REF. SPACE.

8. SAG RESISTANT DRYWALL ON ALL CEILINGS.

9. PULL ALL DIMENSIONS FROM THE REAR OF PLAN.

10. REFER TO EXTERIOR ELEVATIONS & TYP. DETAIL SHEETS FOR EXTERIOR WALL FINISH SPECS.

11. REFER TO DETAIL SHEETS FOR FLASHING REQUIREMENTS AT ALL WOOD TO MASONRY INTERFACES.

12. ALL INTERIOR FRAME WALL DIMENSIONS TO BE 3 1/2" U.N.O.

13. ALL EXTERIOR BLOCK WALL DIMENSIONS TO BE 7 1/2" U.N.O.

14. ALL INT. FIRST FLOOR CEILINGS AT 9'-4" U.N.O.  
• ALL INT. SECOND FLOOR CEILINGS AT 9'-0" U.N.O.

15. C.M.U. & FRAME WALL SYSTEM SEGMENTS WHICH HAVE AN UNINTERRUPTED LENGTH OF 12'-0" OR MORE SHALL BE CONSIDERED SHEAR WALL SWS = SHEAR WALL SEGMENTS.

16. OPENING BETWEEN GARAGE AND RESIDENCE SHALL BE EQUIPPED w/ A 20 MIN. FIRE RATED SOLID WOOD OR HONEYCOMB CORE STEEL DOOR NOT LESS THAN 1 3/8" THICKNESS AS PER FBC-R302.5.1.

17. INSTALL 5/8" TYPE X DRYWALL ON GARAGE CEILING BENEATH HABITABLE ROOMS (TYP.)

18. GARAGE DOOR TO BE CERTIFIED BY MFR. FOR 140 M.P.H.

19. ALL TUB & SHOWER UNITS WILL HAVE ANTI-SCALDING DEVICES INSTALLED.

20. ALL OPERABLE WINDOWS LOCATED MORE THAN 72" ABV. SURFACE BELOW SHALL HAVE THE LOWEST PORTION OF WINDOW CLEAR OPENING A MIN. OF 24" ABOVE FINISHED FLOOR BEING SERVER PER (FBC-R312.2).

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BRG. HT. LEGEND

■ POURED CONCRETE FILLED CELL WITHIN AN 8" CMU WALL, U.N.O. w/ (1) VERT. #5 REBAR CONT. FROM FOUNDATION SLAB TO BOND BEAM. (MIN. OF 25" LAP ON ALL STEEL REINFORCING BARS)

9'-4" BRG. HT.

10'-0" BRG. HT.

11'-4" BRG. HT.

12'-0" BRG. HT.

12'-8" BRG. HT.

13'-4" BRG. HT.

14'-0" BRG. HT.

15'-0" BRG. HT.

16'-0" BRG. HT.

BRG. PER PLAN

Area Tabulations

Living:

1st floor: 3,164 sf


Total Living: 3,164 sf

entry: 317 sf

covered lanai: 253 sf

garage: 478 sf

Total Area: 4,212 sf

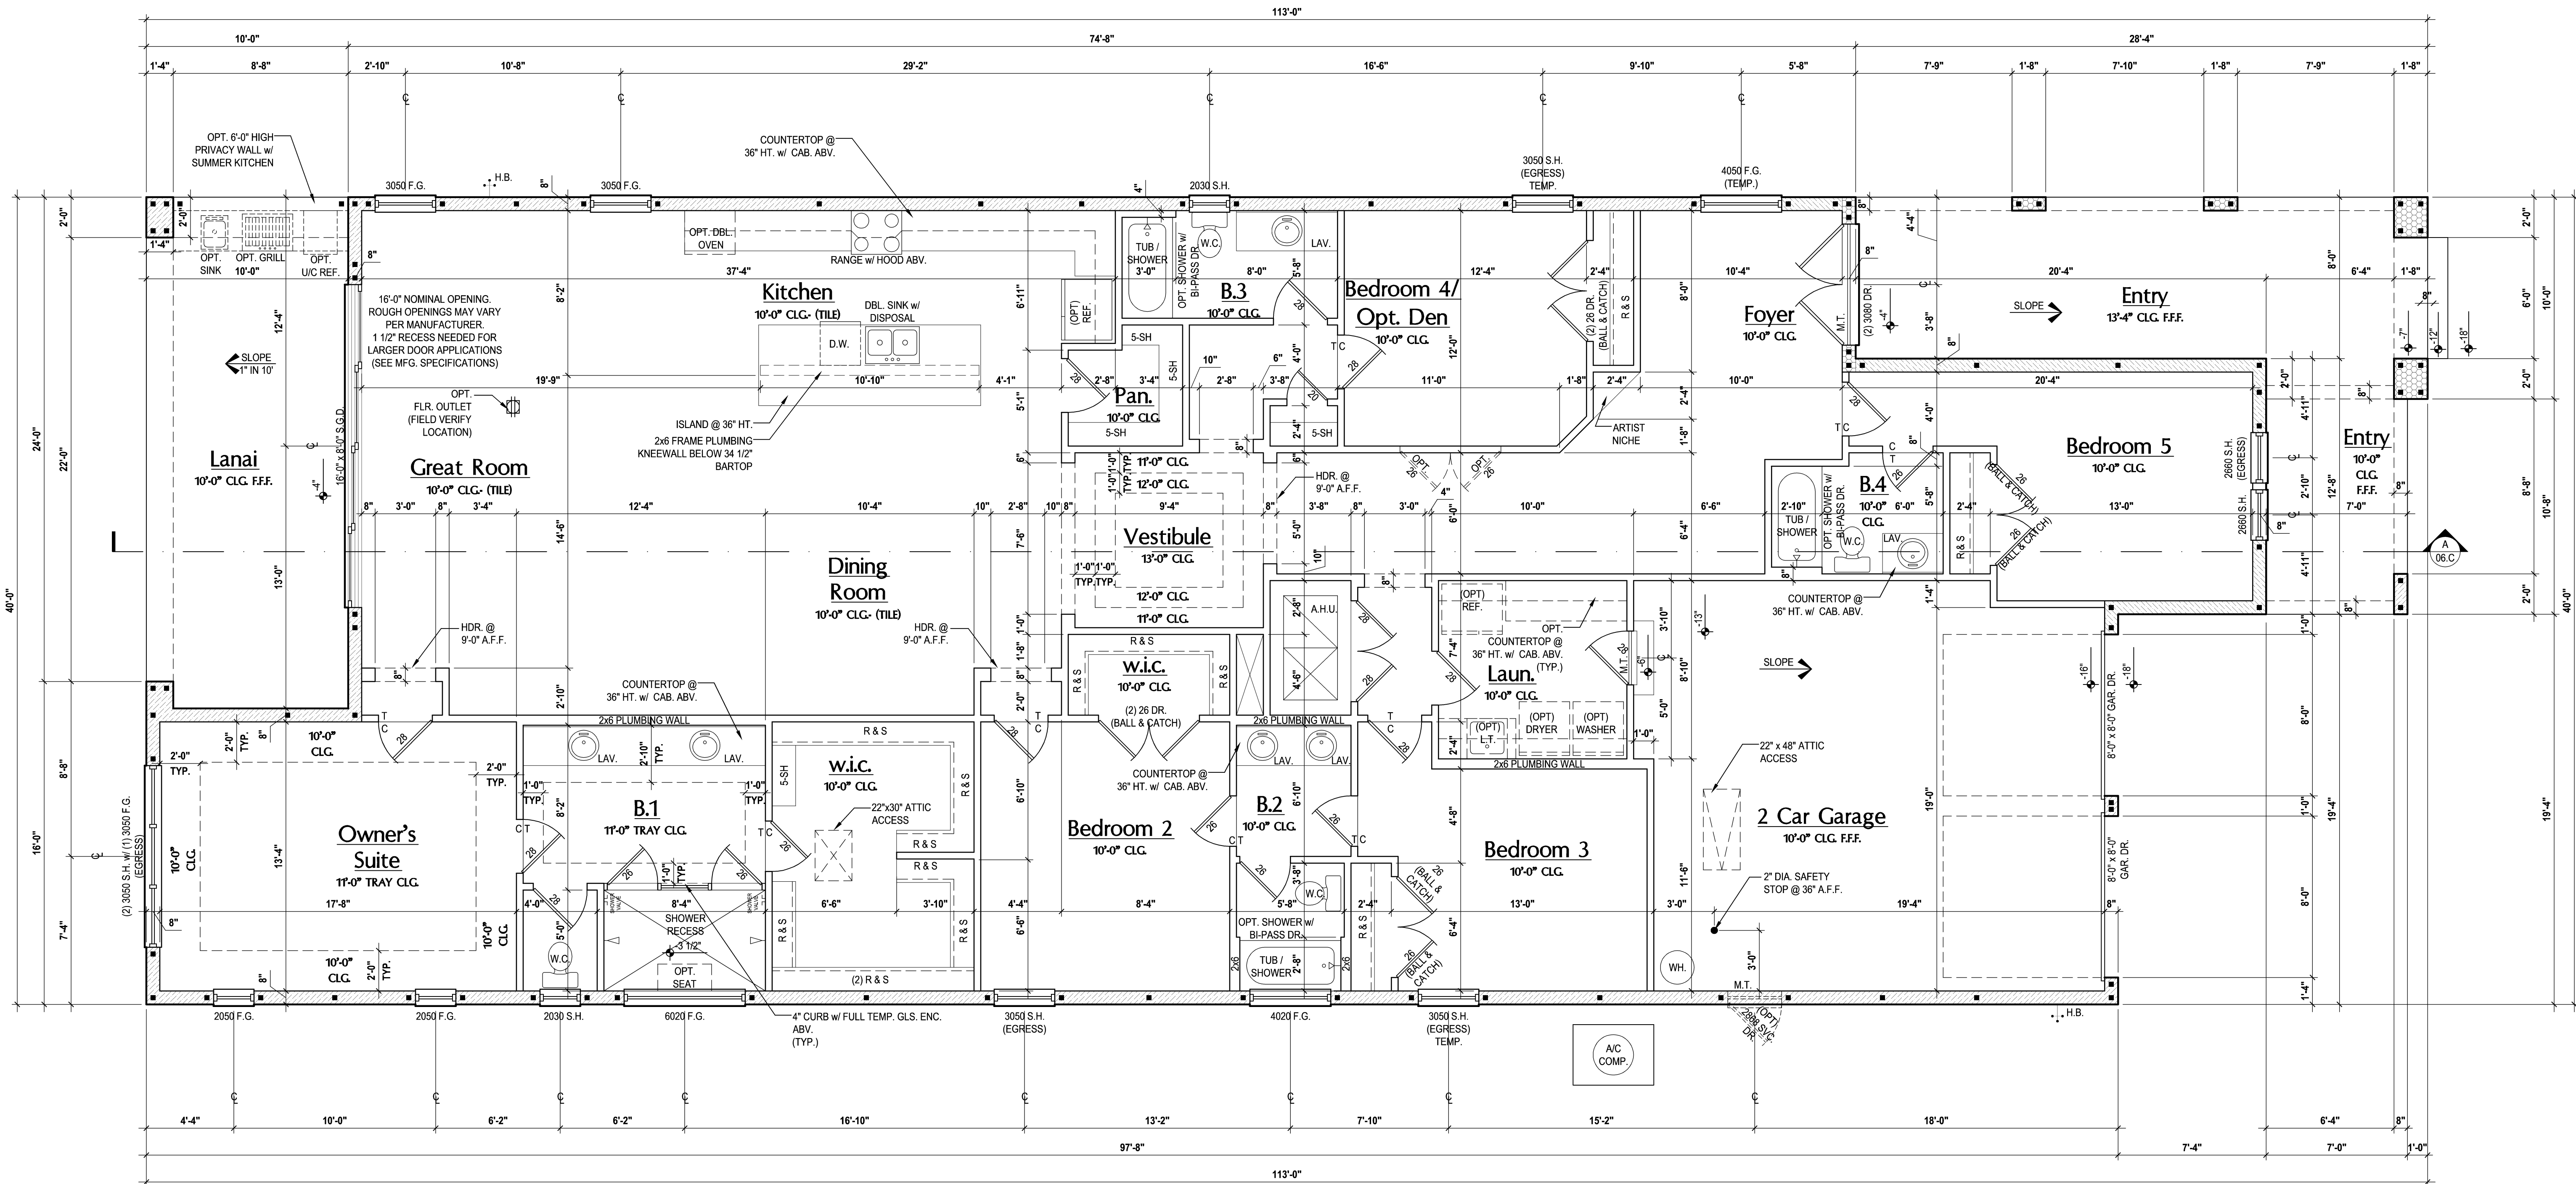

Floor Plan "C"  
(Standard)

SCALE: 1/8" = 1'-0" (12x18) 1/4" = 1'-0" (24x36)

235 Maitland Avenue S.  
Suite 108-A  
Maitland, FL 32751  
Ph: (407) 227-7416  
www.premier-structural.com  
FL CERT. AUTH.: 28113  
FL. PER#: 60269

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STRUCTURAL ENGINEERING, P.A.C.

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Altamonte Springs, FL 32701  
Ph: (407) 629-6711  
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MJS

DESIGNERS - PLANNERS

WRITTEN DIMENSIONS SHALL HAVE PRECEDENCE OVER SCALE DIMENSIONS.  
Contractor shall verify and be responsible for dimensions and locations of the job and MJS shall not be held responsible for any errors or omissions on the drawings, regardless of the type of electronic signature used.

40-3164

DORCHESTER

Street Address  
Lot Info  
City, State, Zip

Park Square HOMES

A Division of Park Square Enterprises Inc.  
5200 Vineland Rd. Suite #200  
Orlando, FL 32811  
Phone: (407) 525-3000

ISSUE DATE

00/00/0000

REVISIONS

PROJECT:

00-0000

SCALE:

AS NOTED

DRAWN BY:

C.C.

DESIGNED BY:

MJS

FLOOR PLAN

03.C

Aug 26, 2019 8:31am Carlos Z:\Park Square Homes\MODELS\ORLANDO MODEL\340 Models (Horizon West)\MODEL\SThe Dorchester (40-3164)\03.C1 Floor Plan (Opt. Sitting Rm.)\dwg\DESIGNS\PLANS IN THIS PUBLICATION ARE PROTECTED UNDER THE COPYRIGHT LAW. REPRODUCTION OF THE ILLUSTRATIONS OR WORKING DRAWINGS BY ANY MEANS IS STRICTLY PROHIBITED UNLESS LICENSED BY MJS, INC.

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12'-0" BRG. HT.

12'-8" BRG. HT.

13'-4" BRG. HT.

14'-0" BRG. HT.

15'-0" BRG. HT.

16'-0" BRG. HT.

BRG. PER PLAN

Area Tabulations

Living:

1st floor: 3,291 sf


Total Living: 3,291 sf

entry: 318 sf

covered lanai: 253 sf

garage: 478 sf

Total Area: 4,340 sf

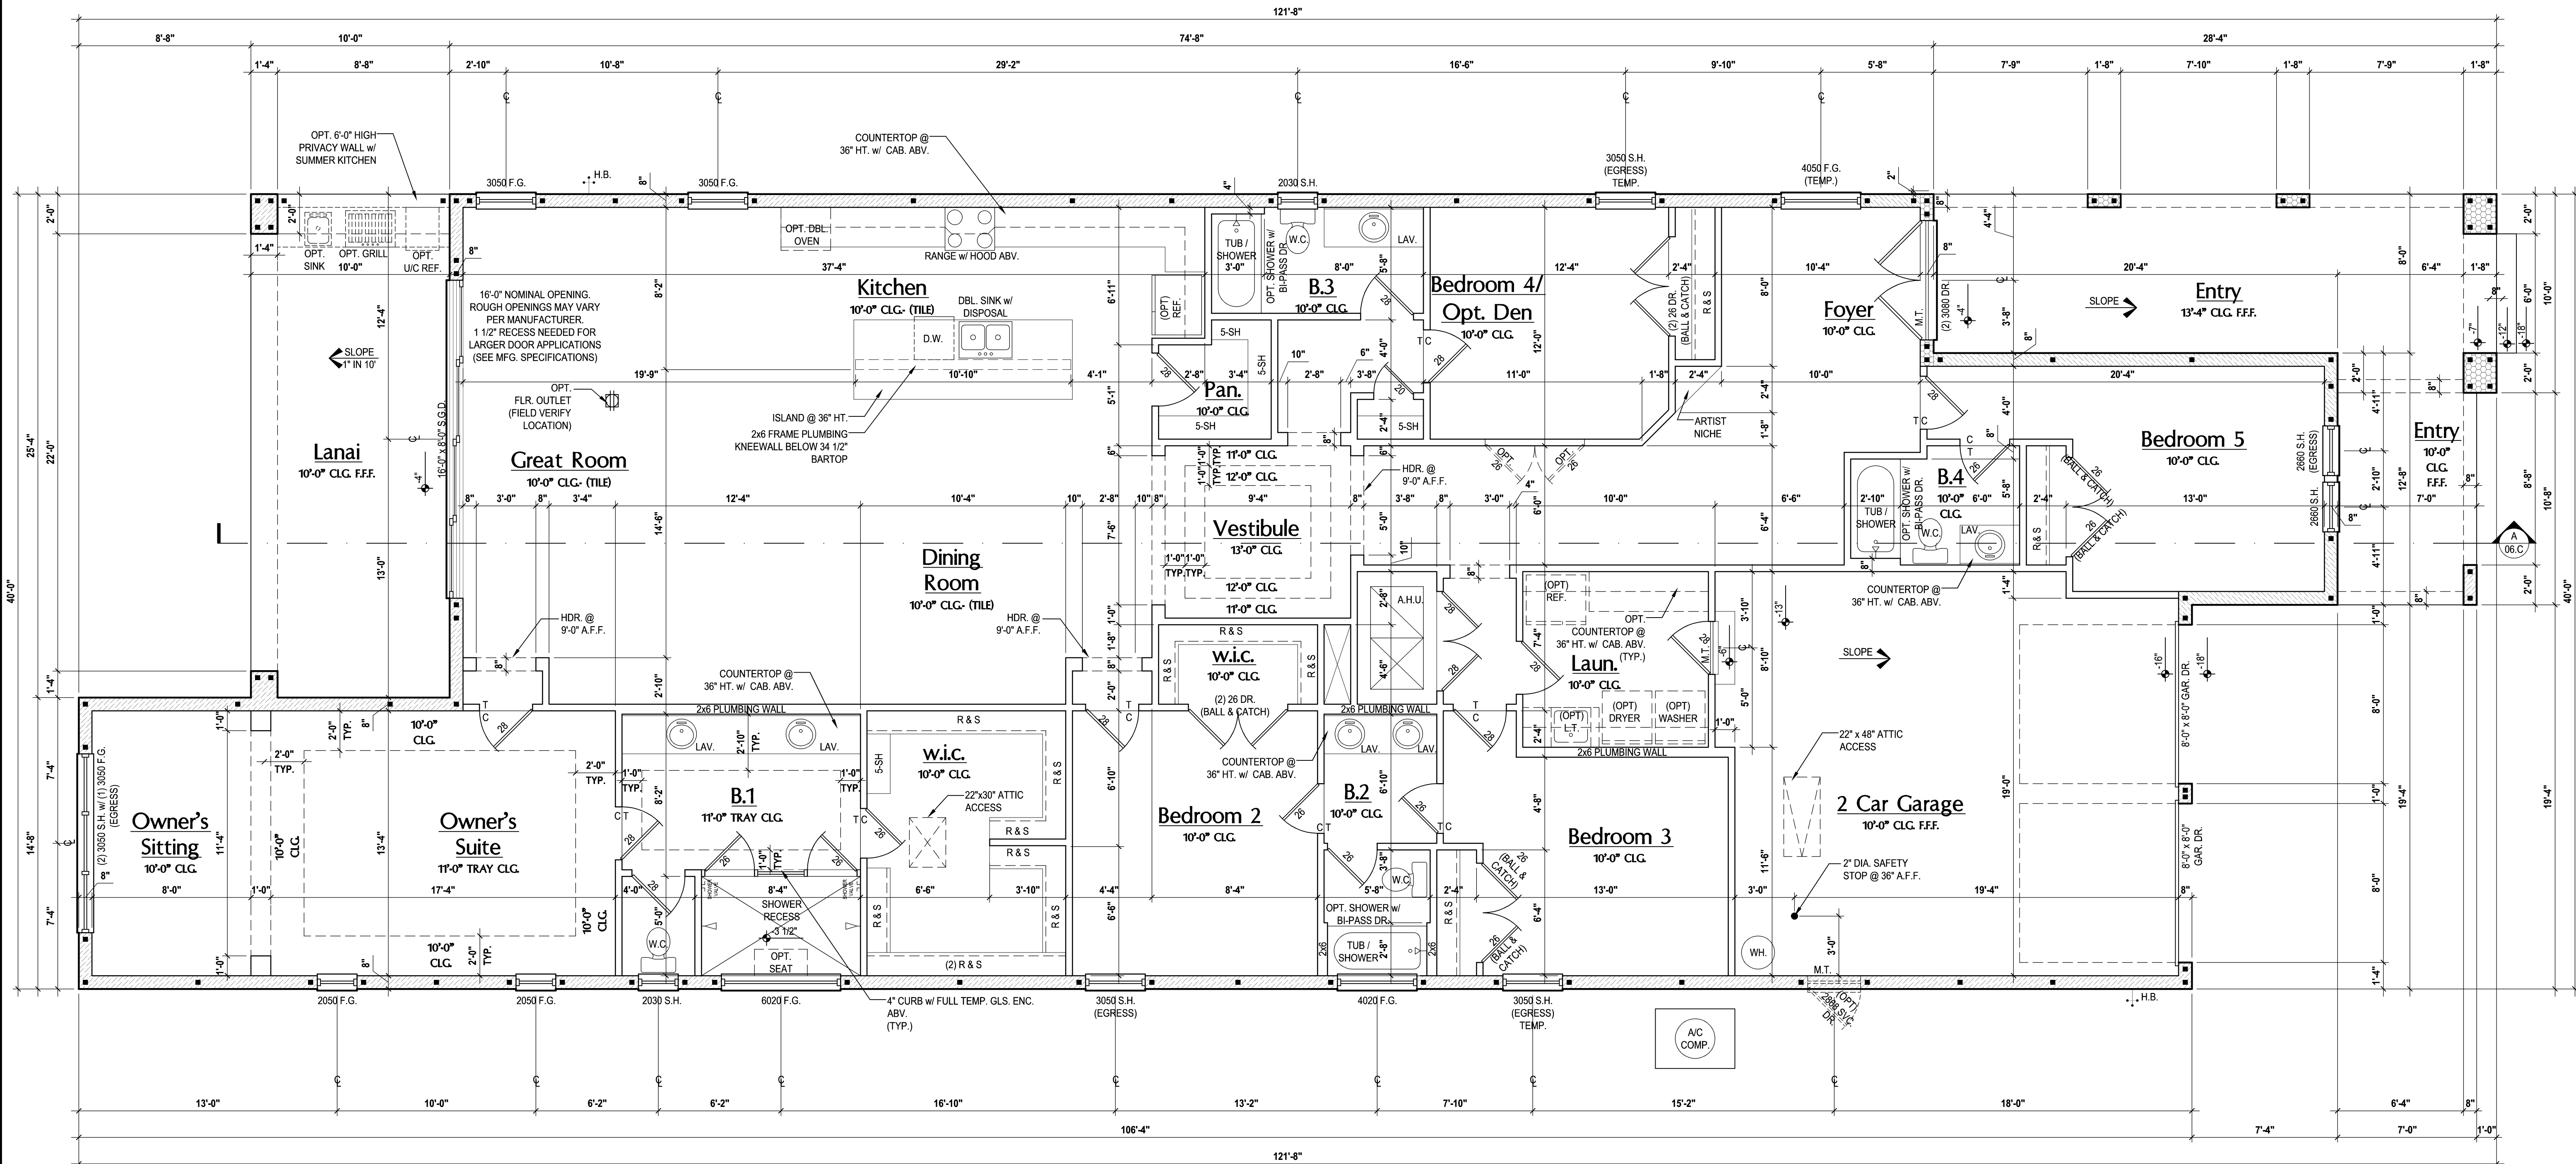

Floor Plan "C"

(Opt. Sitting Rm.)

SCALE: 1/8" = 1'-0" (12x18) 1/4" = 1'-0" (24x36)

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ISSUE DATE

00/00/0000

REVISIONS

PROJECT:

00-0000

SCALE:

AS NOTED

DRAWN BY:

C.C.

DESIGNED BY:

MJS

FLOOR PLAN

03.C1

40-3164

DORCHESTER

Street Address

Lot Info

City, State, Zip

815 Orienta Ave. Suite# 1040

Altamonte Springs, FL 32701

Ph: (407) 629-6711

Custom Home design

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STRUCTURAL ENGINEERING, INC.

235 Maitland Avenue S.

Suite 108-A

Maitland, FL 32751

Ph: (407) 227-7416

www.premier-structural.com

FL CERT. AUTH.: 29113

FL. P.E.#: 60239

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BRG. HT. LEGEND

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14'-0" BRG. HT.

15'-0" BRG. HT.

16'-0" BRG. HT.

BRG. PER PLAN

Area Tabulations

Living:

1st floor:

Total Living:

entry:

covered lanai:

garage:

Total Area:

3,164 sf


3,164 sf

317 sf

513 sf

478 sf

4,472 sf

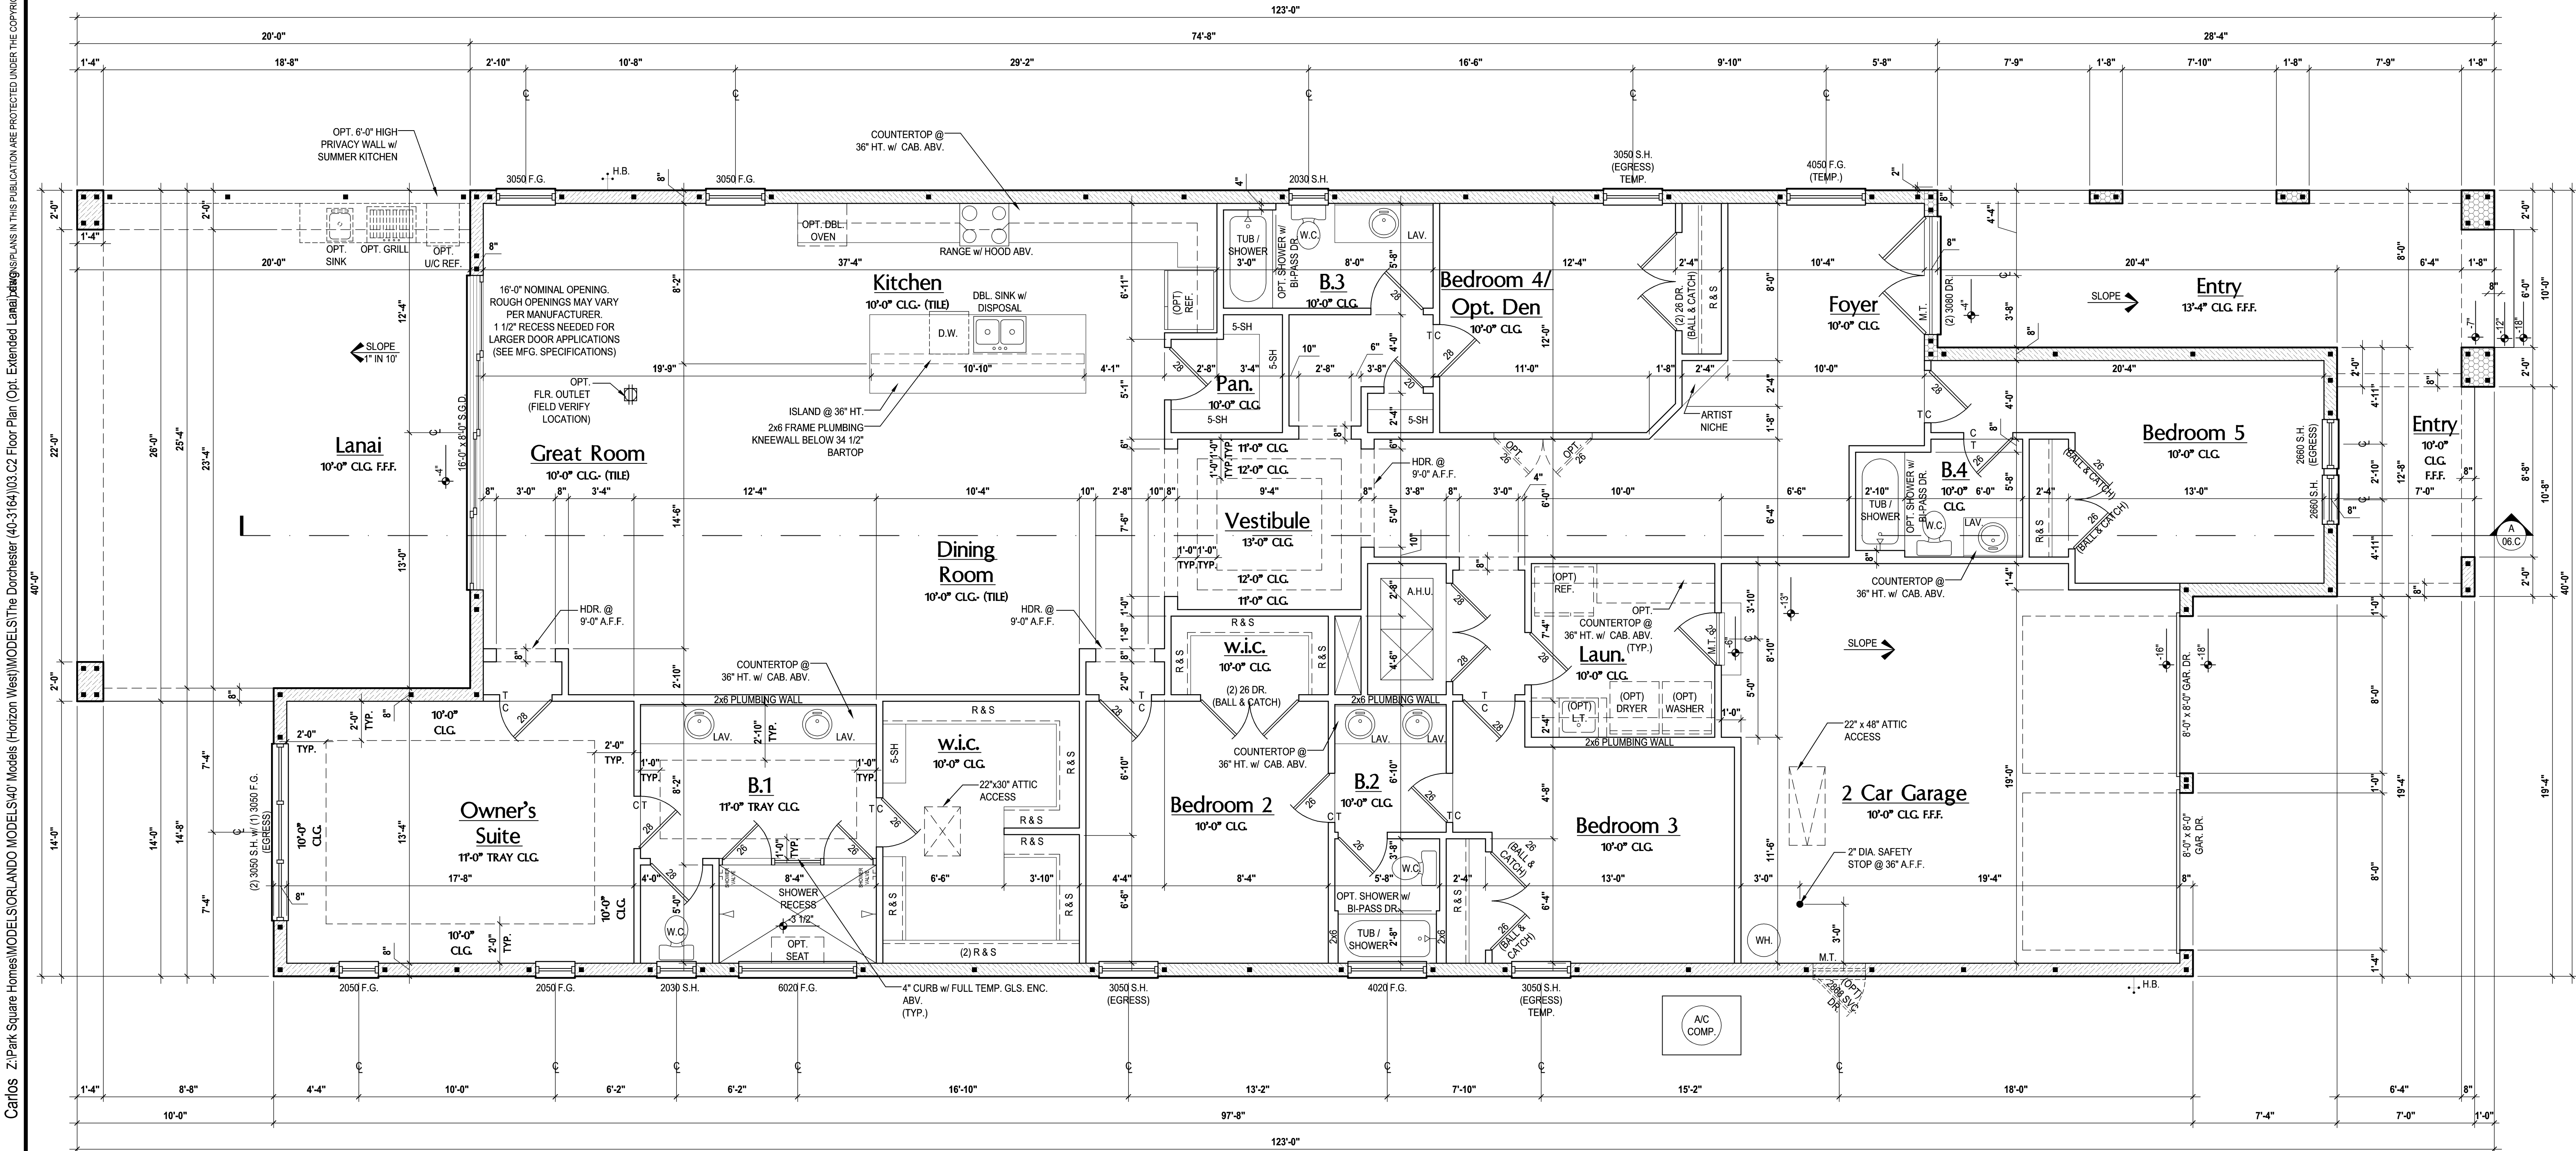

Floor Plan "C"  
(Opt. Extended Lanai)

SCALE: 1/8" = 1'-0" (12x18) 1/4" = 1'-0" (24x36)

ISSUE DATE

00/00/0000

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00-0000

SCALE:

AS NOTED

DRAWN BY:

C.C.

DESIGNED BY:

MJS

40-3164

DORCHESTER

Street Address

Lot Info

City, State, Zip

815 Orienta Ave. Suite# 1040

Altamonte Springs, FL 32701

Ph: (407) 629-6711

Fax: (407) 629-6776

CUSTOM HOME DESIGN

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WJS

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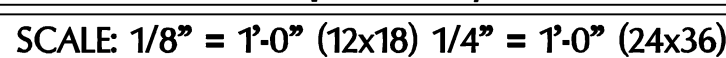
Phone: (407) 525-3000


Spark Square

HOMES

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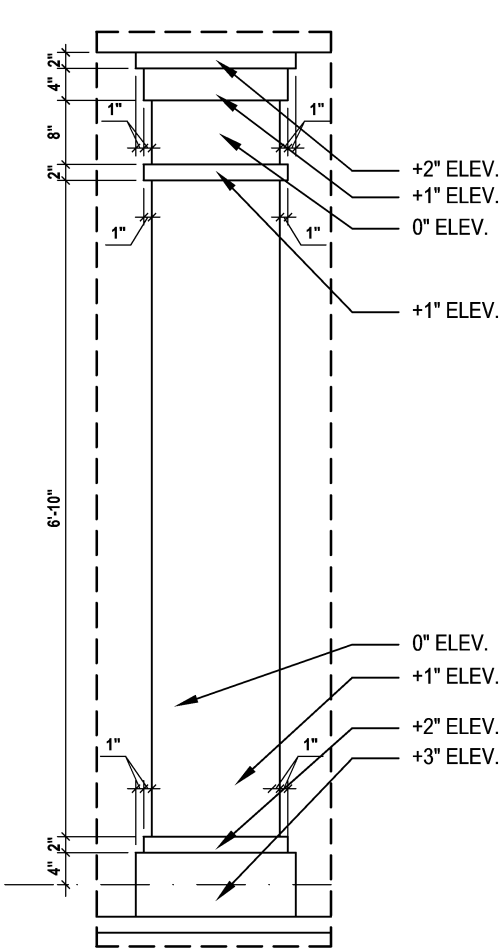
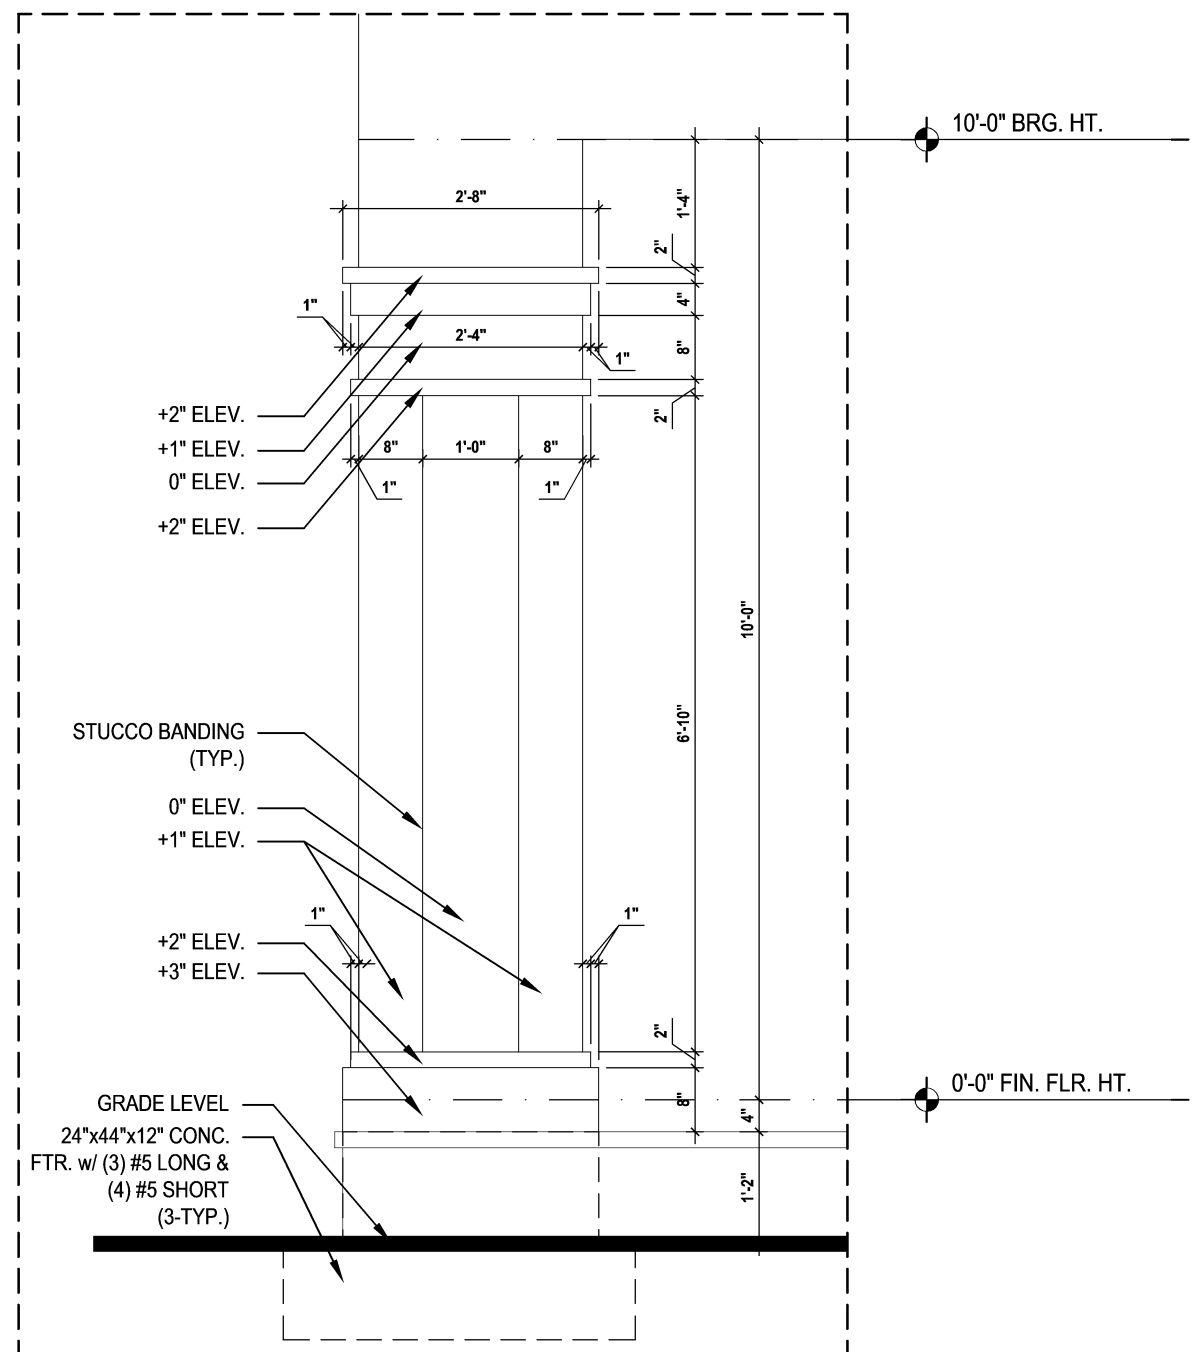
garage:	470	sq
Total Area:	4 313	sq




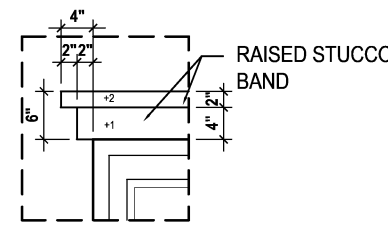

## Detail #2

SCALE: 1/2" = 1'-0" (12x18) 1" = 1'-0" (24x36)

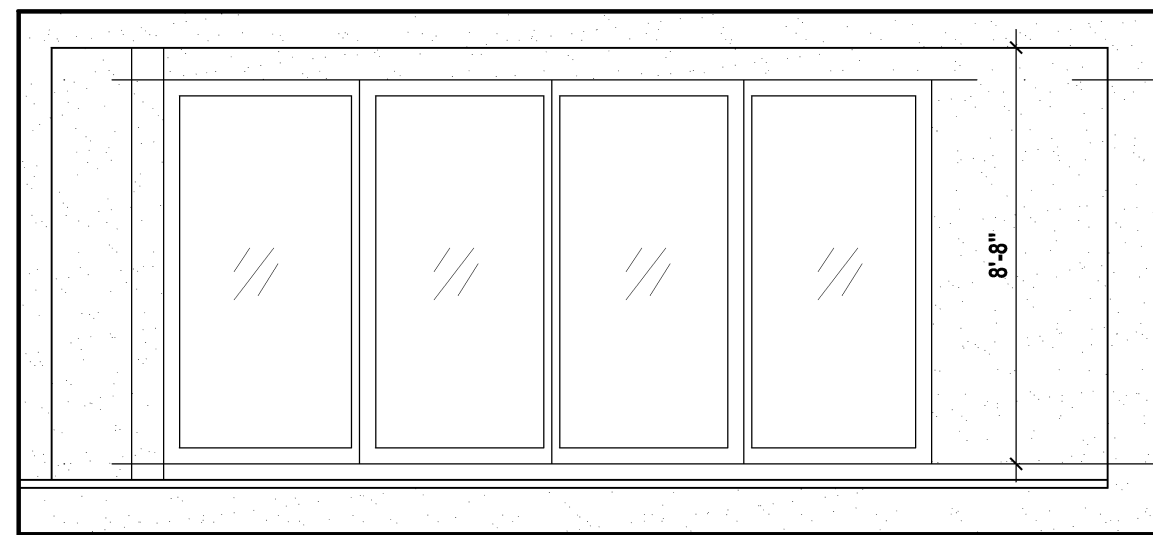


## Rear Elevation


SCALE: 1/8" = 1'-0" (12x18) 1/4" = 1'-0" (24x36)

TABLE 10.  $\chi^2$  (2 d.f.) (2010), 11.4;  $p$  = 0.003

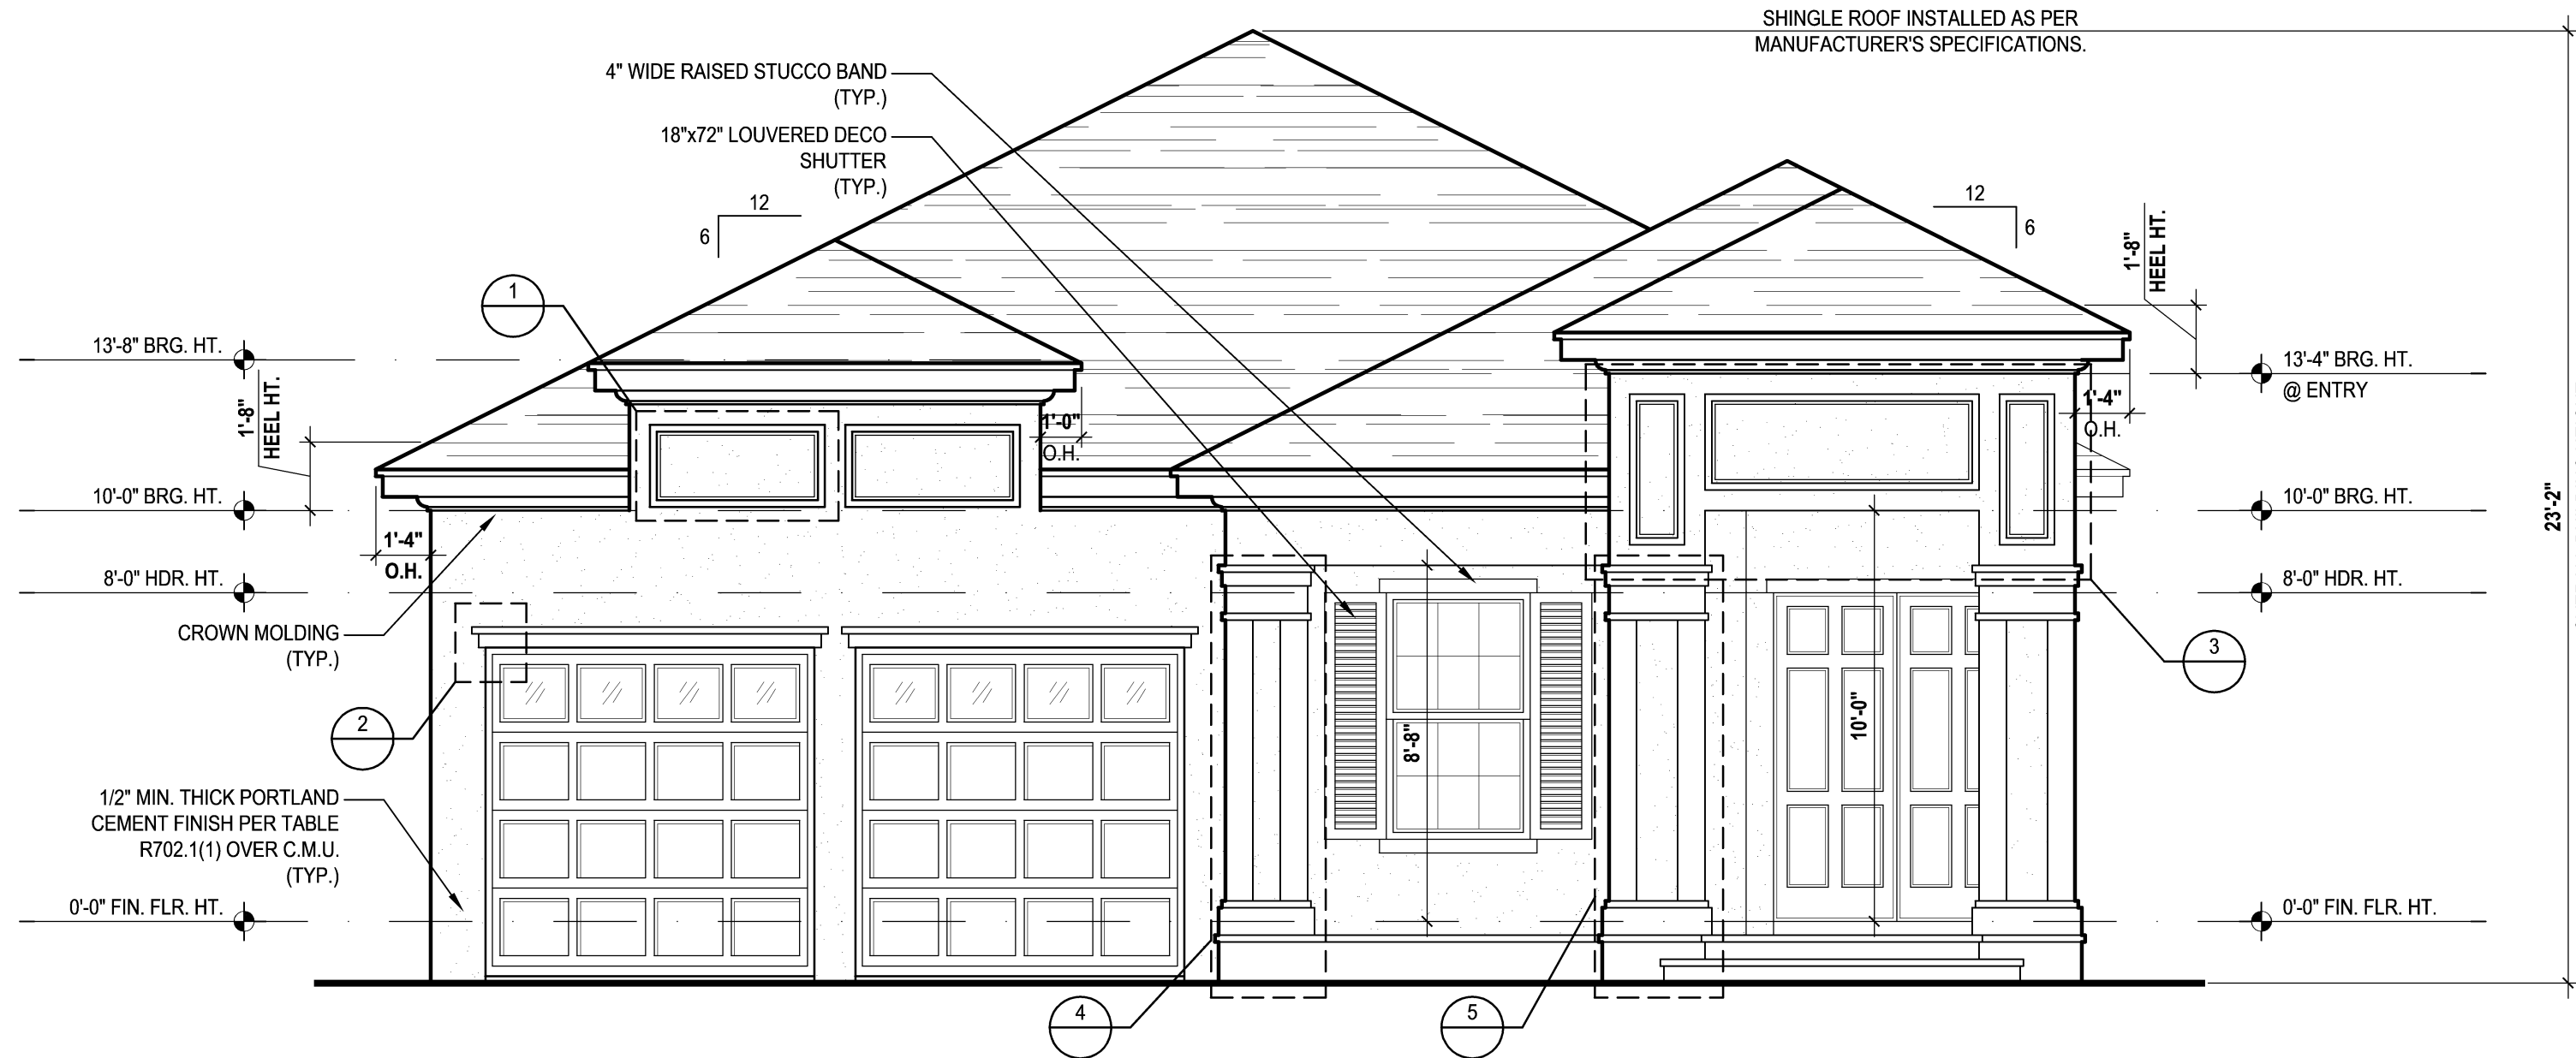


(Standard)

SCALE: 1/8" = 1'-0" (12x18) 1/4" = 1'-0" (24x36)

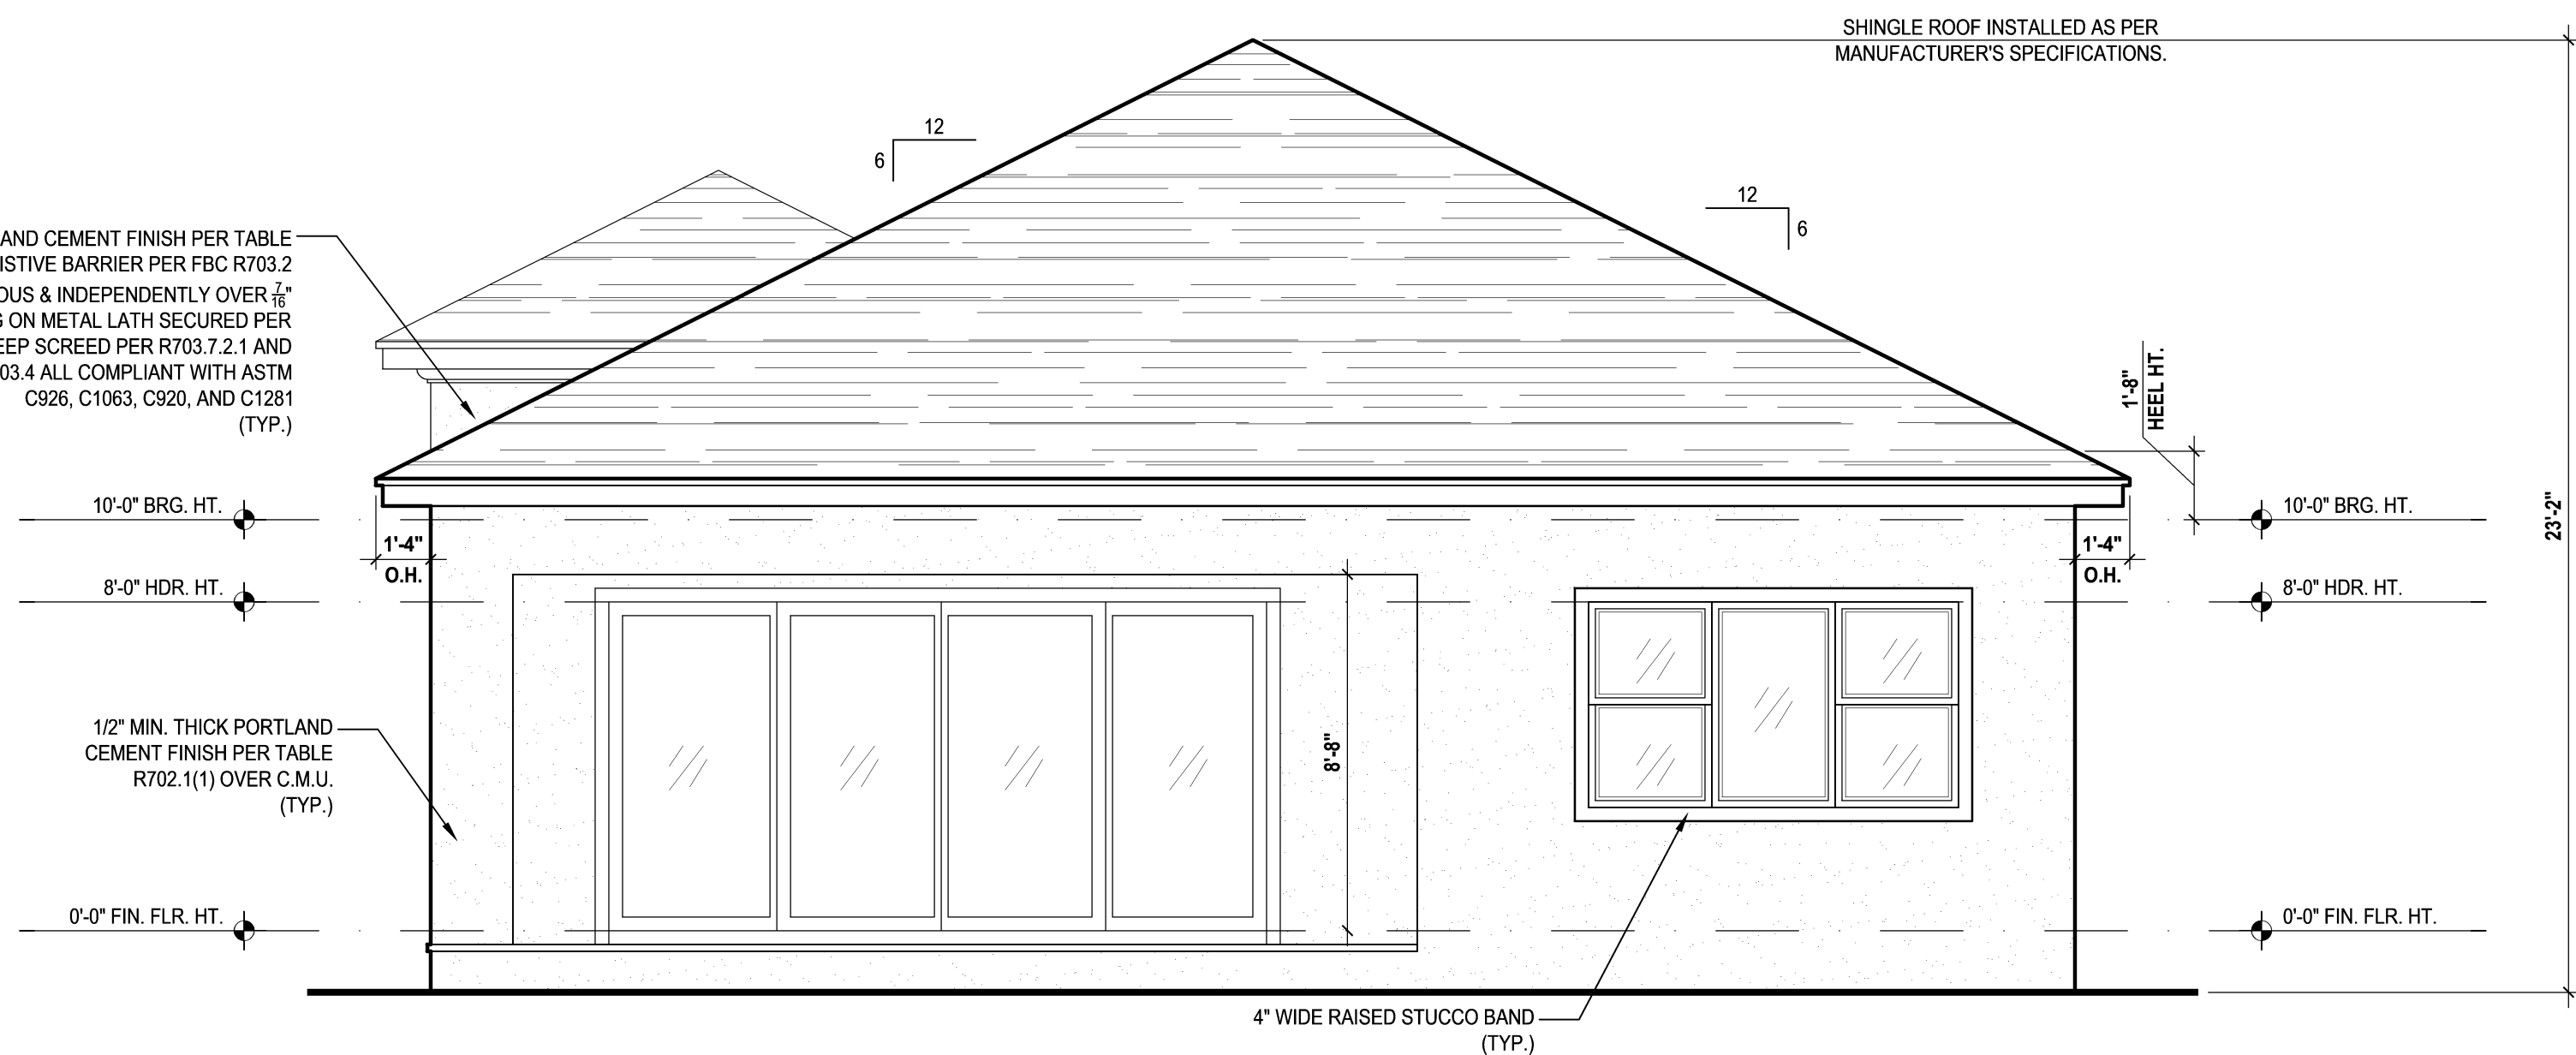

(Standard)

SCALE: 1/8" = 1'-0" (12x18) 1/4" = 1'-0" (24x36)

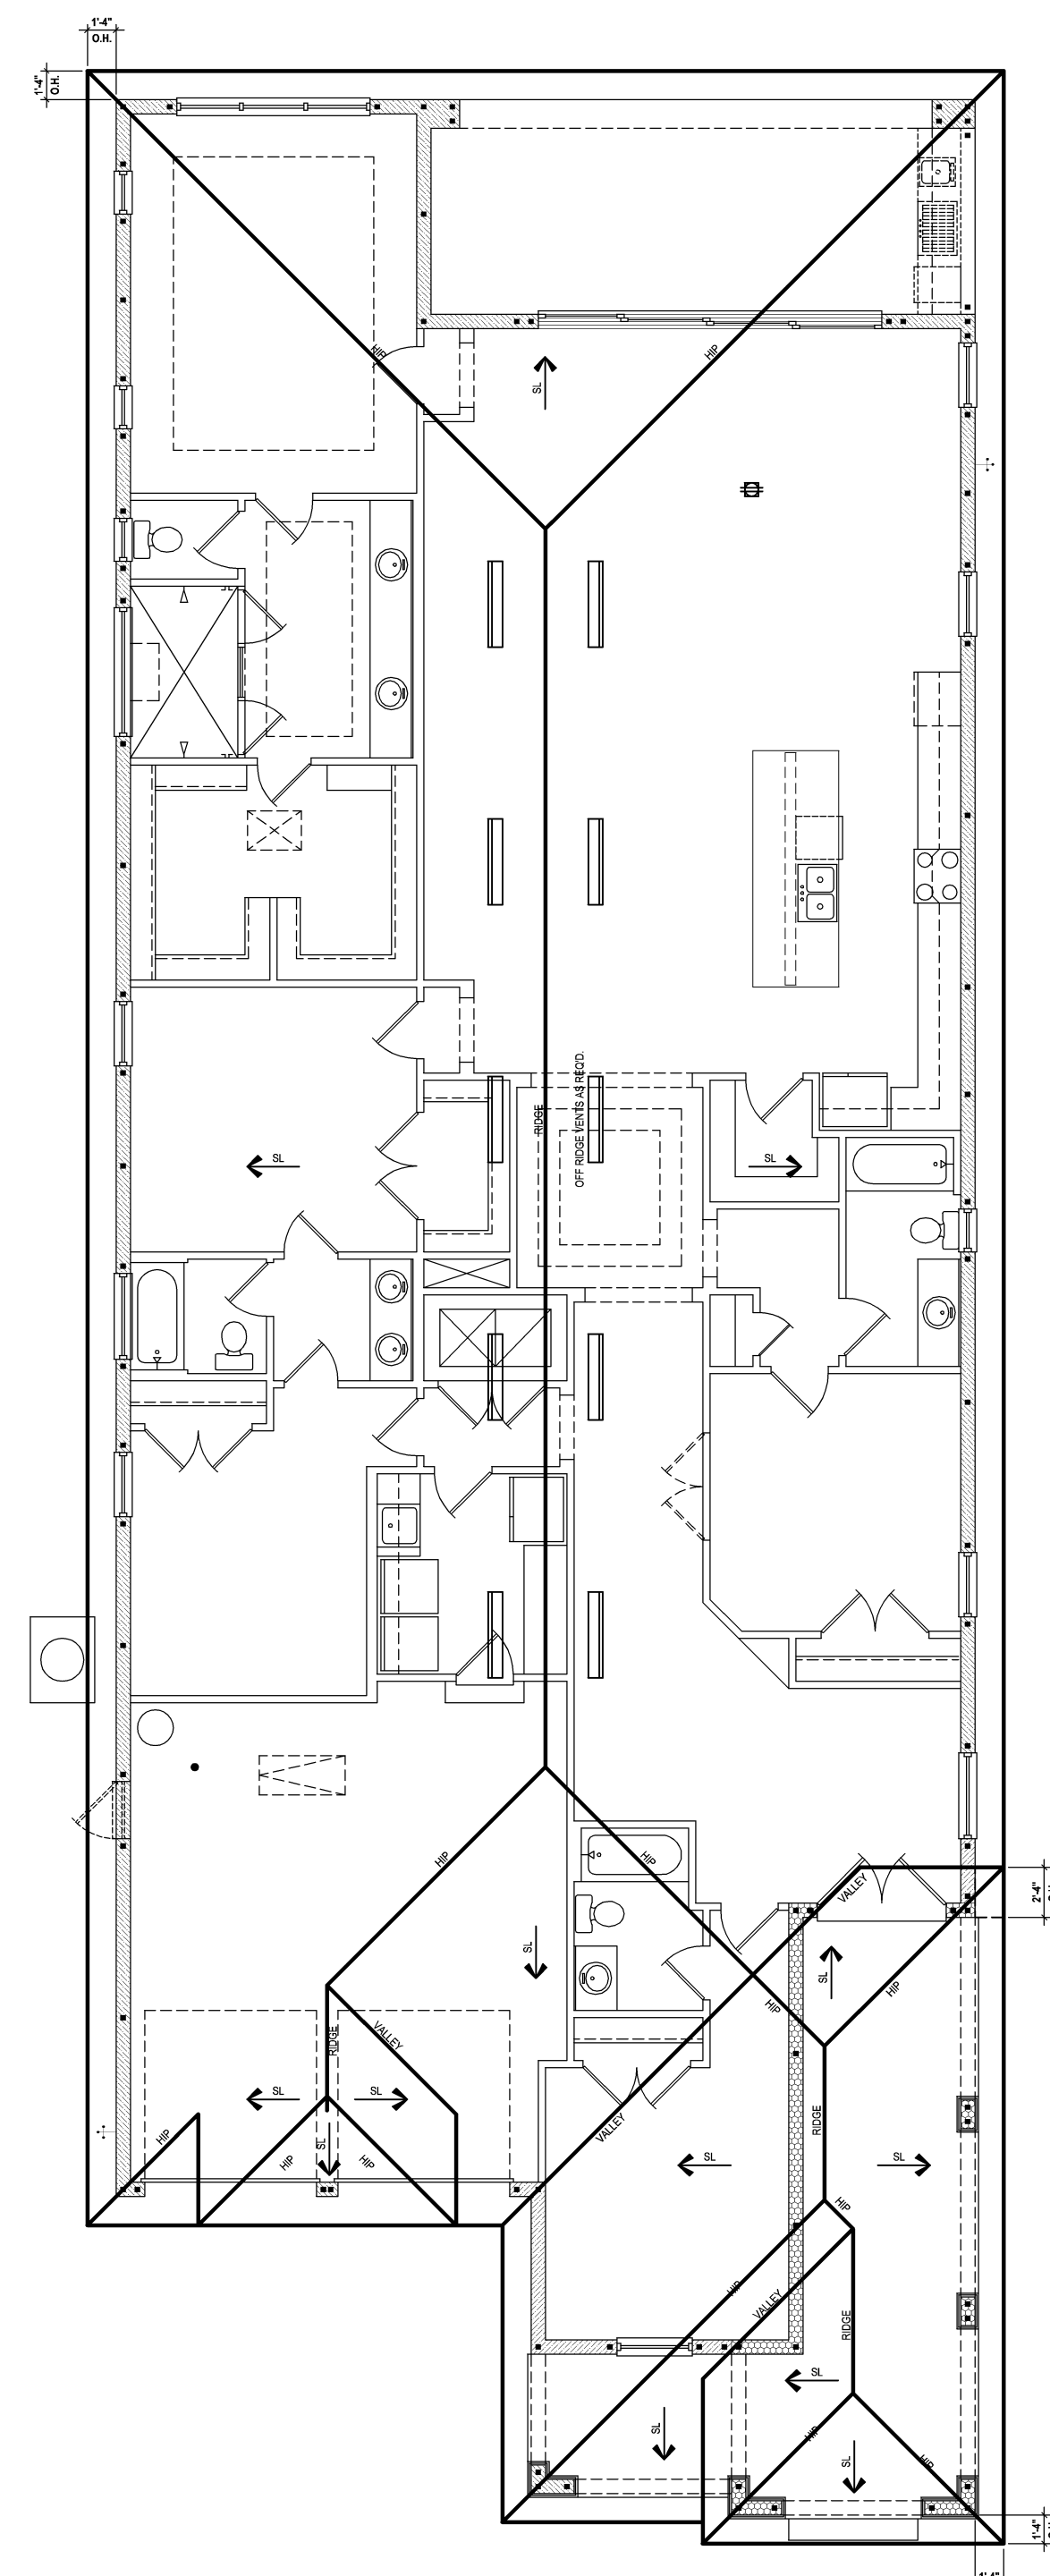

(Standard)

SCALE: 1/16" = 1'-0" (11x17) 1/8" = 1'-0" (22x34)

100%

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DORCHESTER

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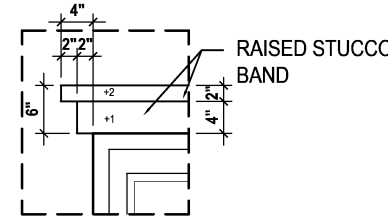
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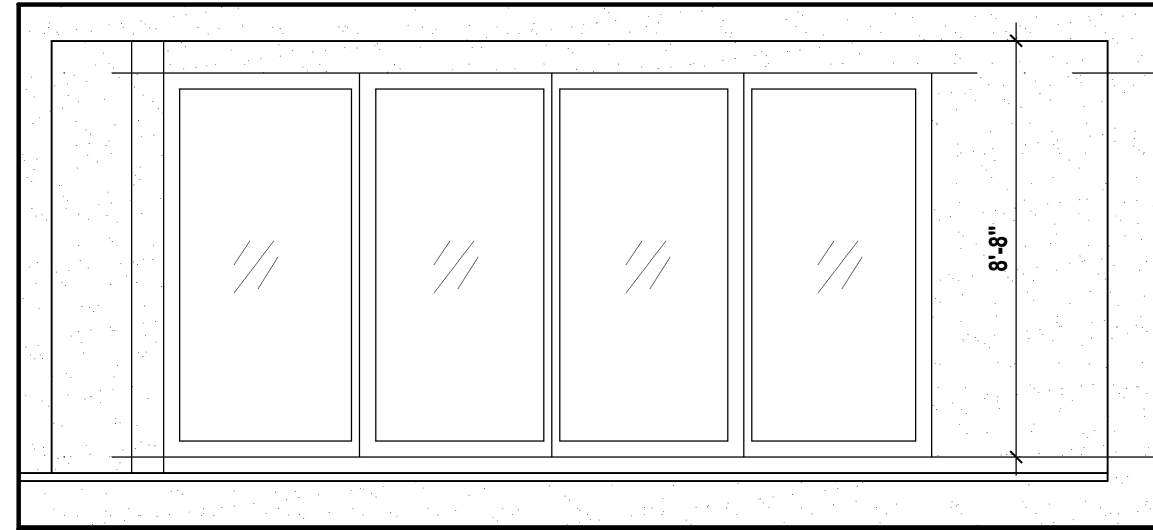
DESIGNED BY: MJS

04.A




## Detail #2

SCALE: 1/2" = 1'-0" (12x18) 1" = 1'-0" (24x36)




## Rear Elevation

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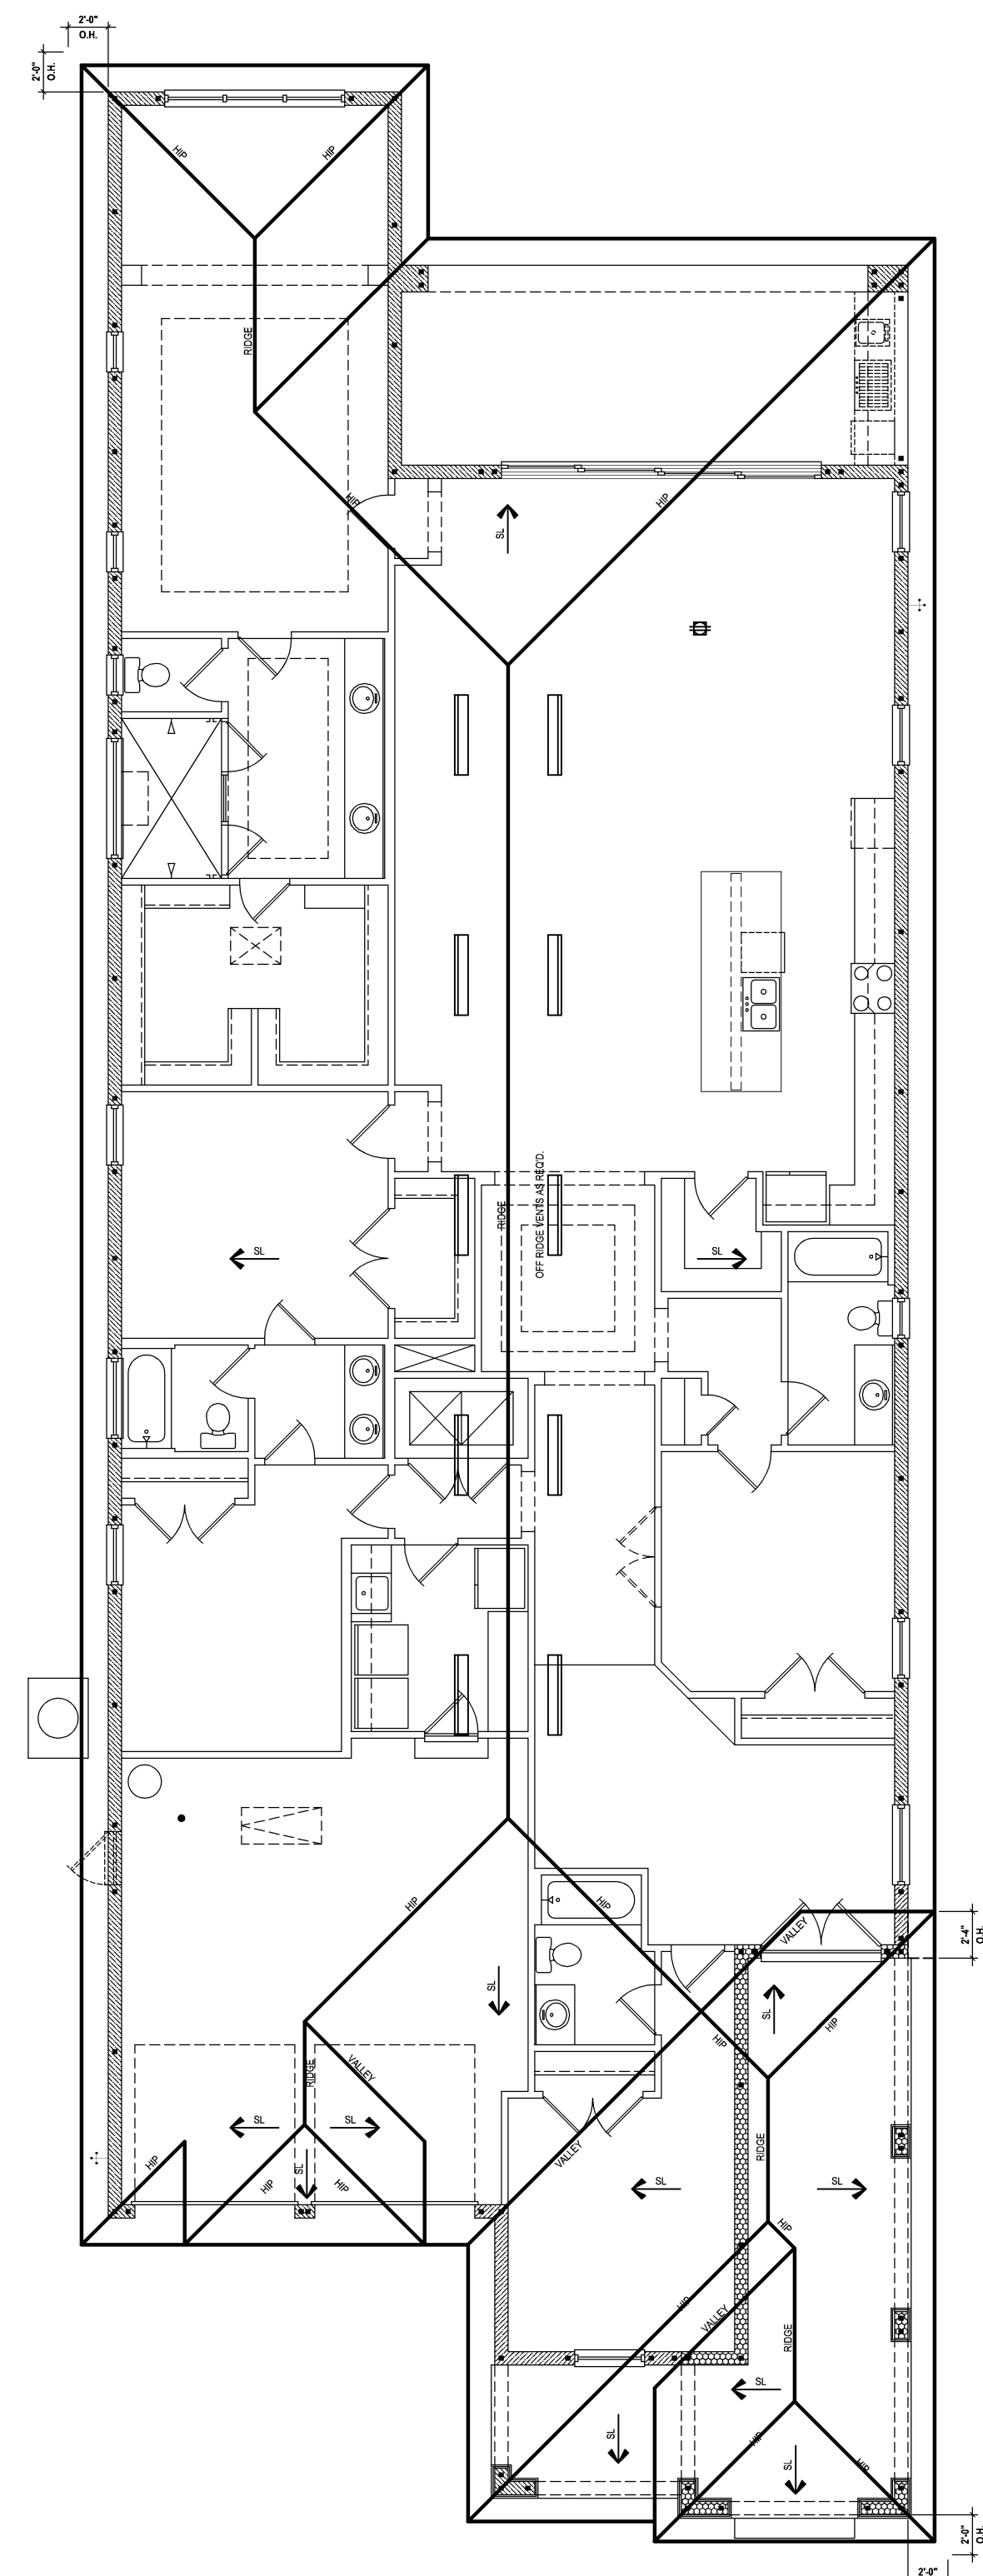
(Opt. Sitting Rm.)

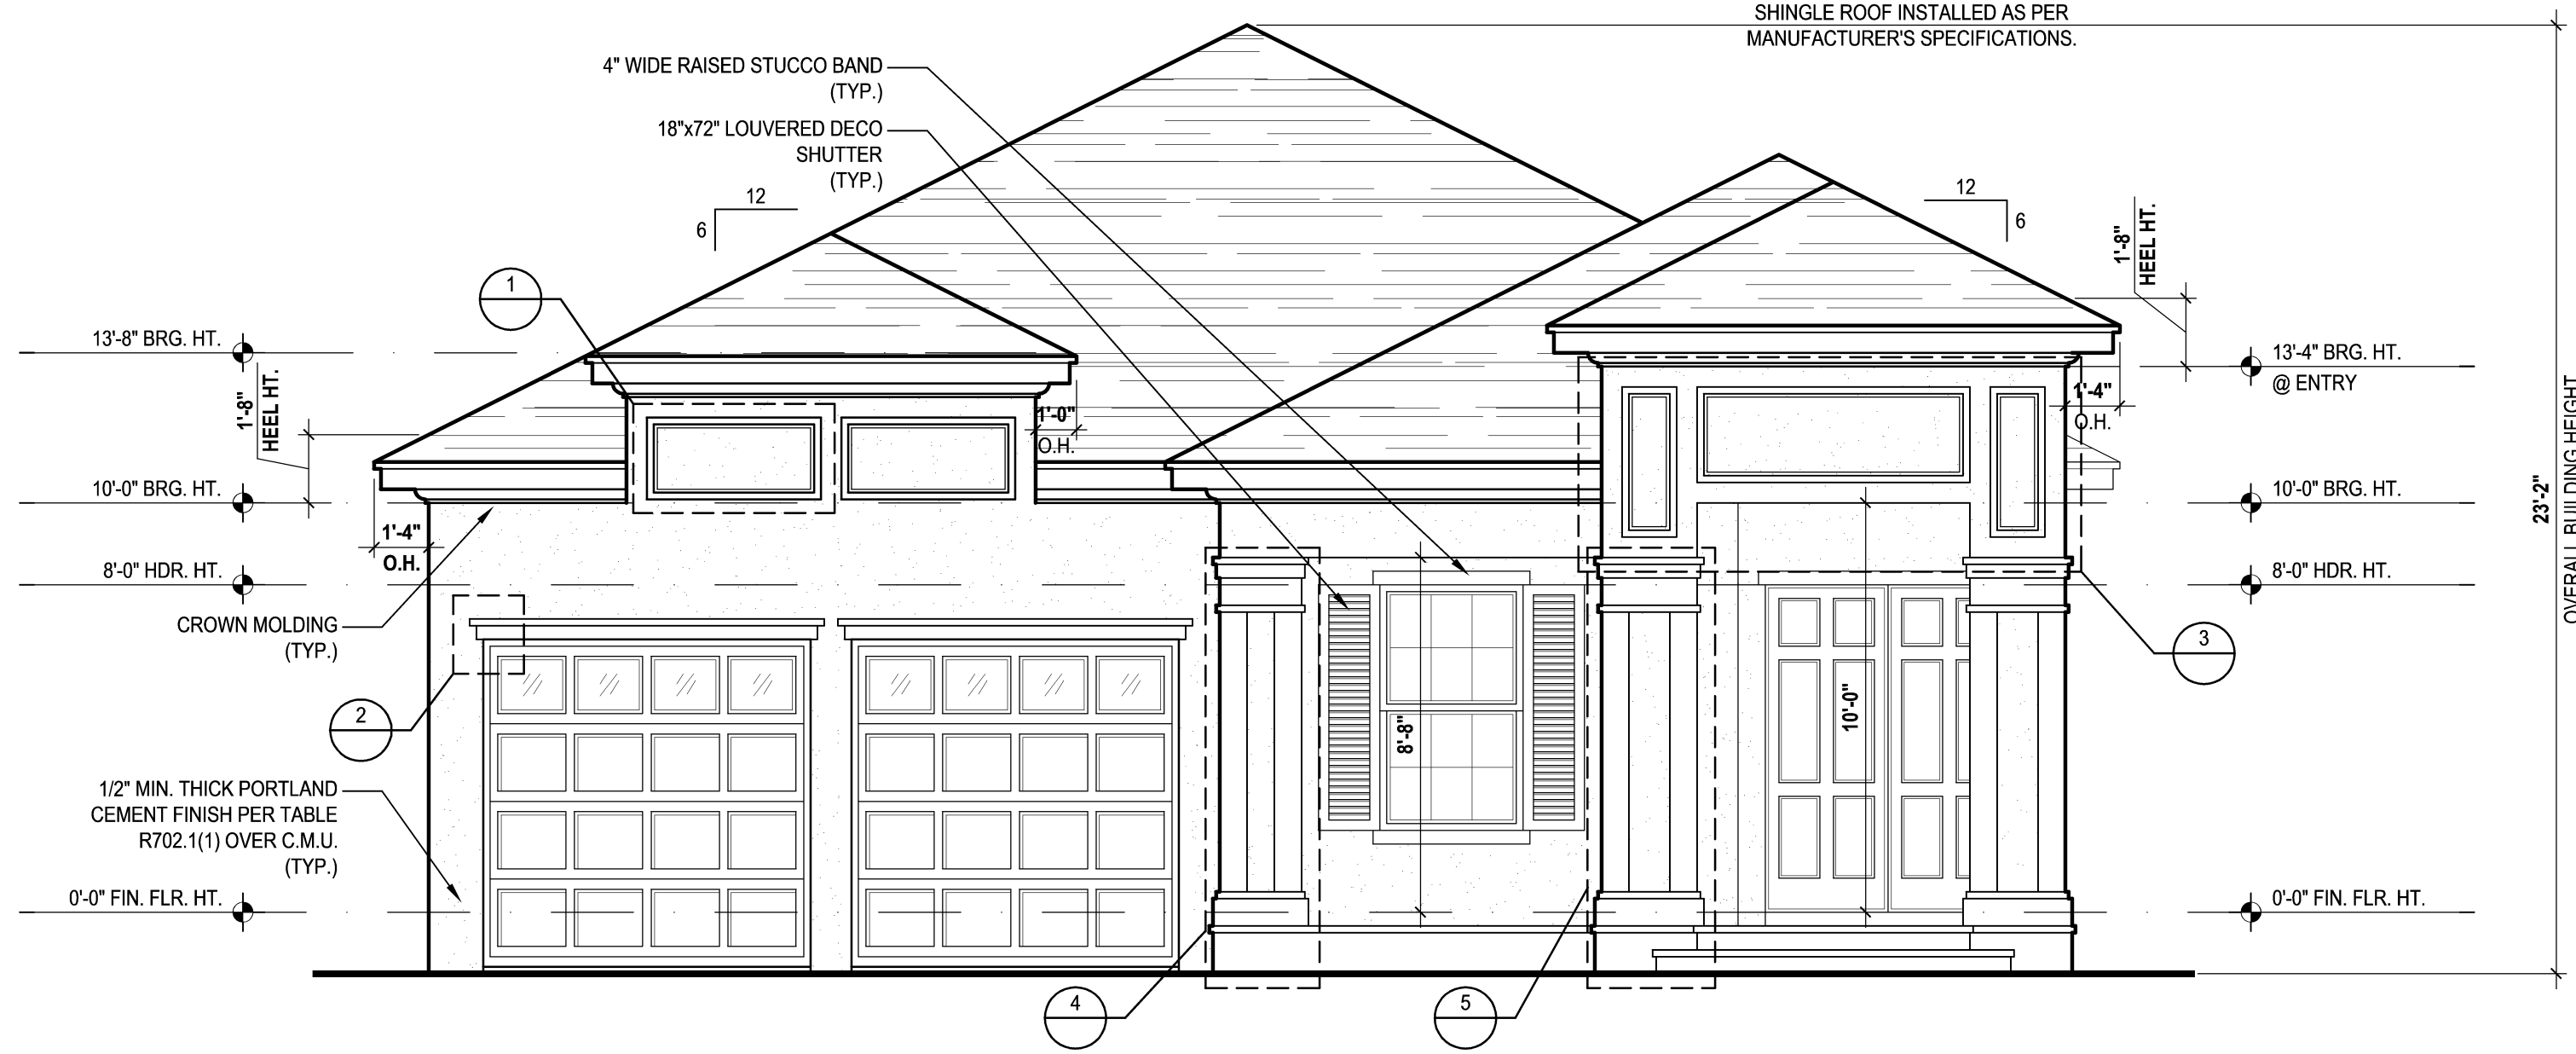SCALE: 1/8" = 1'-0" (12x18) 1/4" = 1'-0" (24x36)



(Opt. Sitting Rm.)
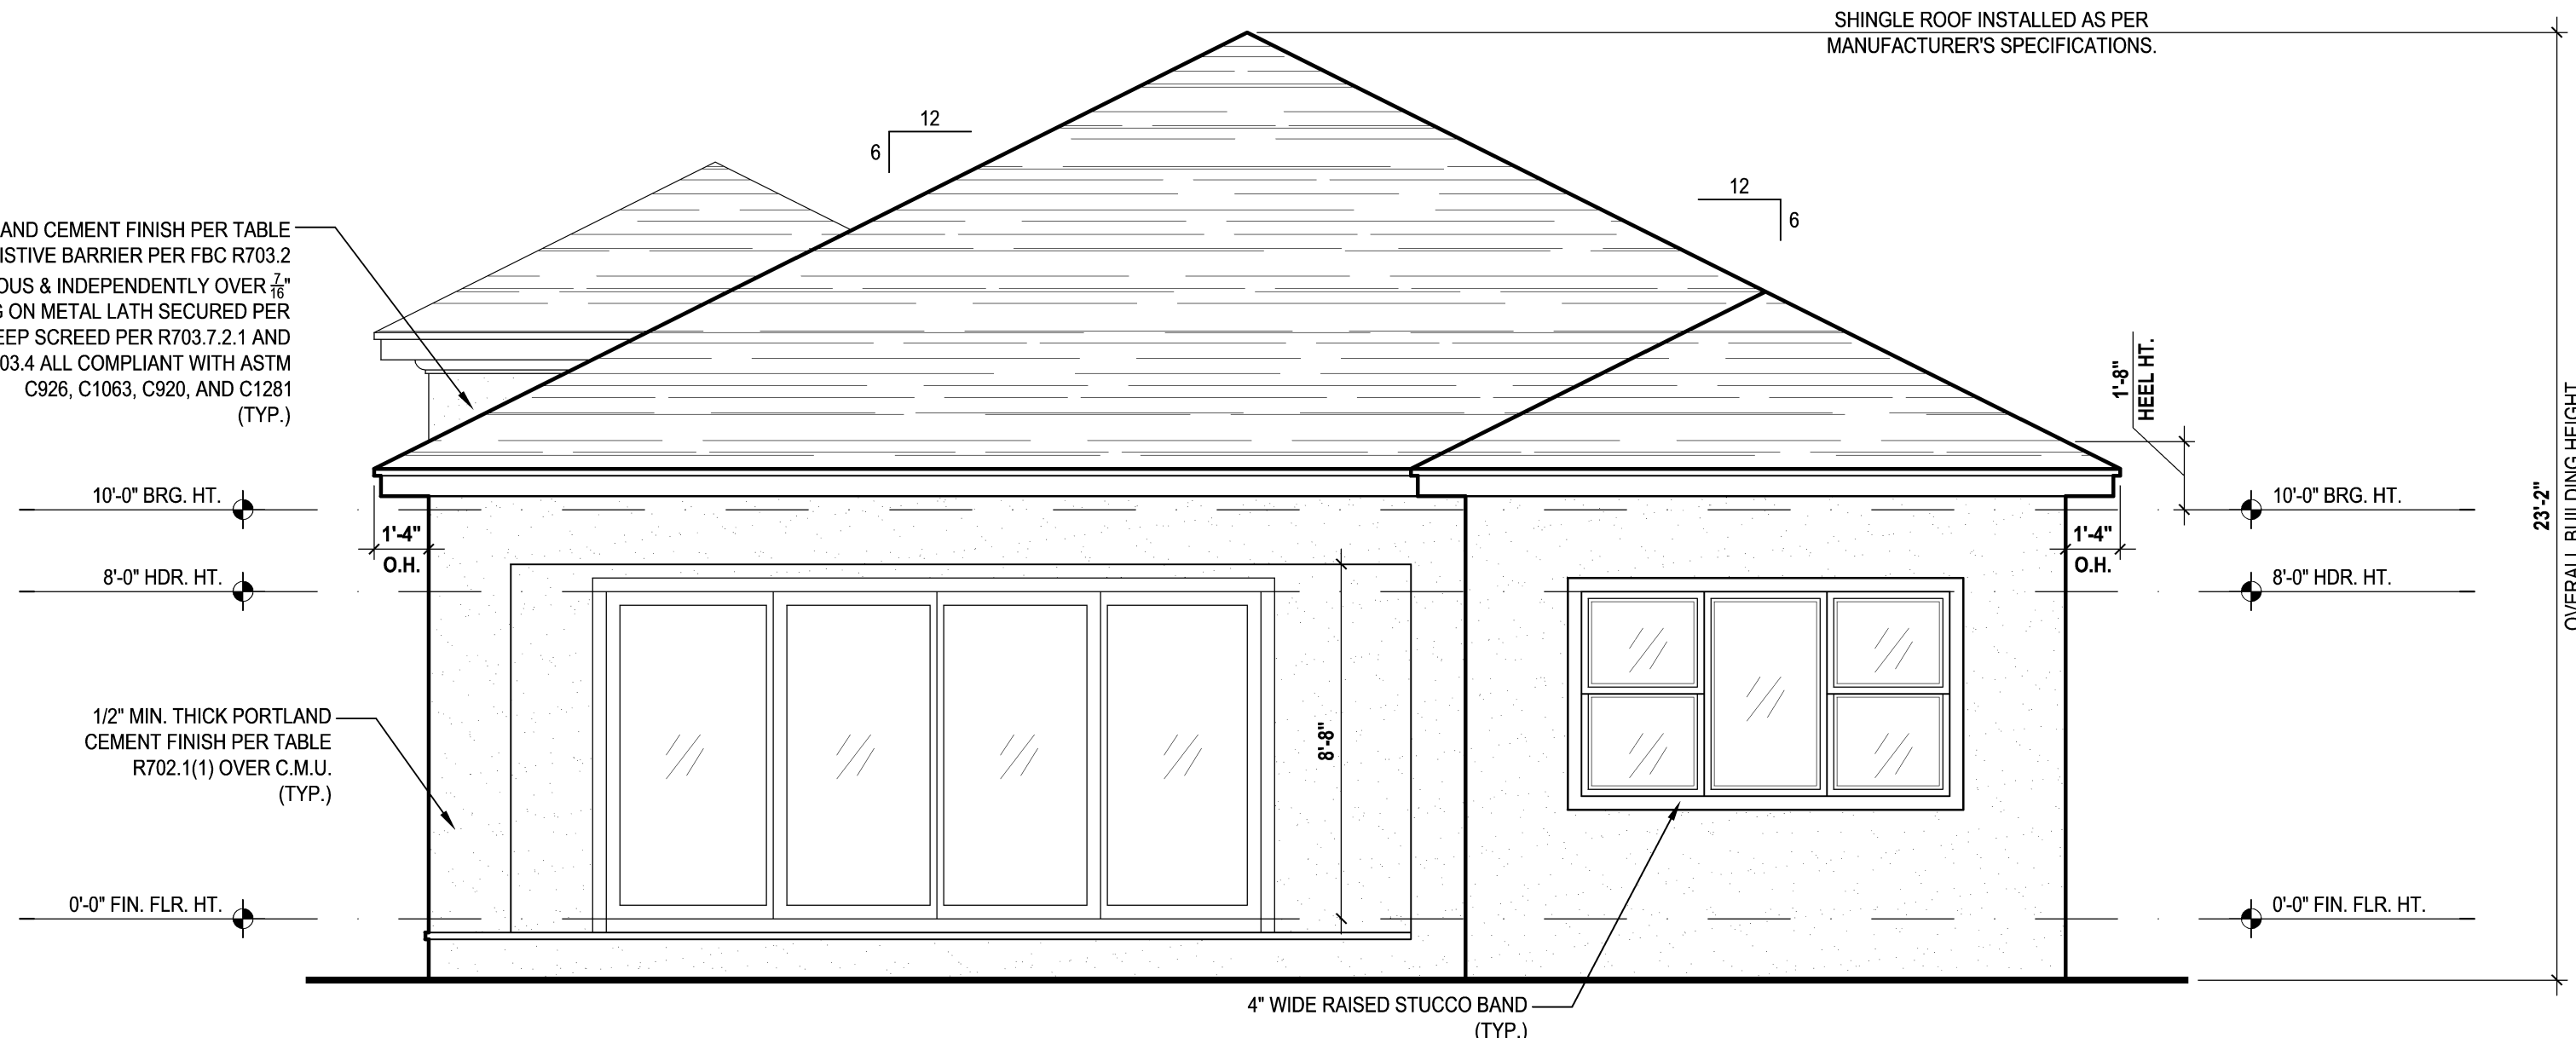
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(Opt. Sitting Rm.)


SCALE: 1/16" = 1'-0" (11x17) 1/8" = 1'-0" (22x34)

UPPER ROOF PERCENTAGE: 40%  
LOWER ROOF PERCENTAGE: 60%

[illegible]


ELEVATIONS "A"

04.A1

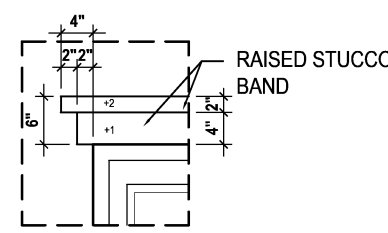


## Detail #2

SCALE: 1/2" = 1'-0" (12x18) 1" = 1'-0" (24x36)

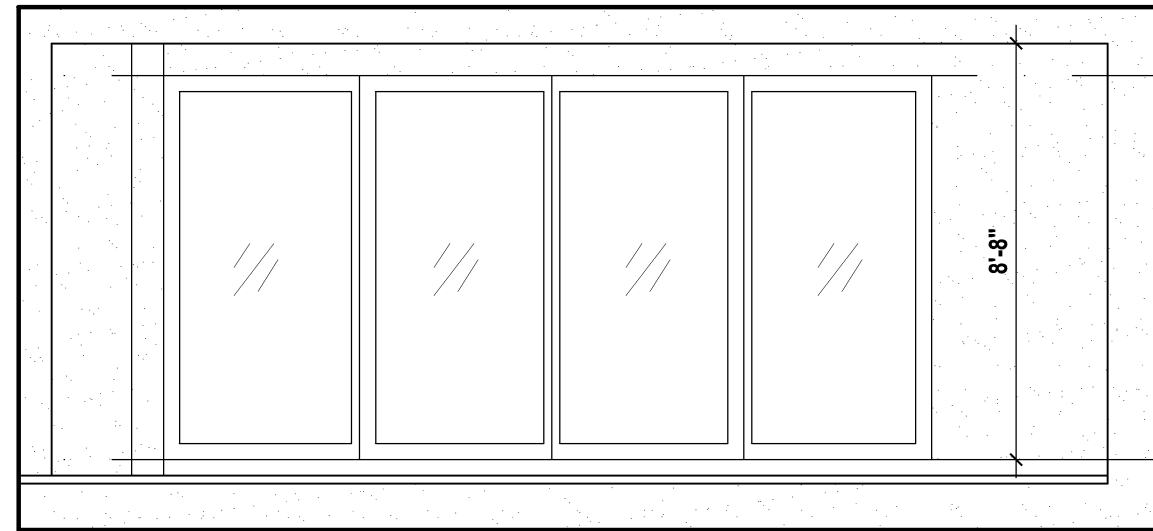


(Opt. Pocket SGD Dr.)

SCALE: 1/8" = 1'-0" (12x18) 1/4" = 1'-0" (24x36)

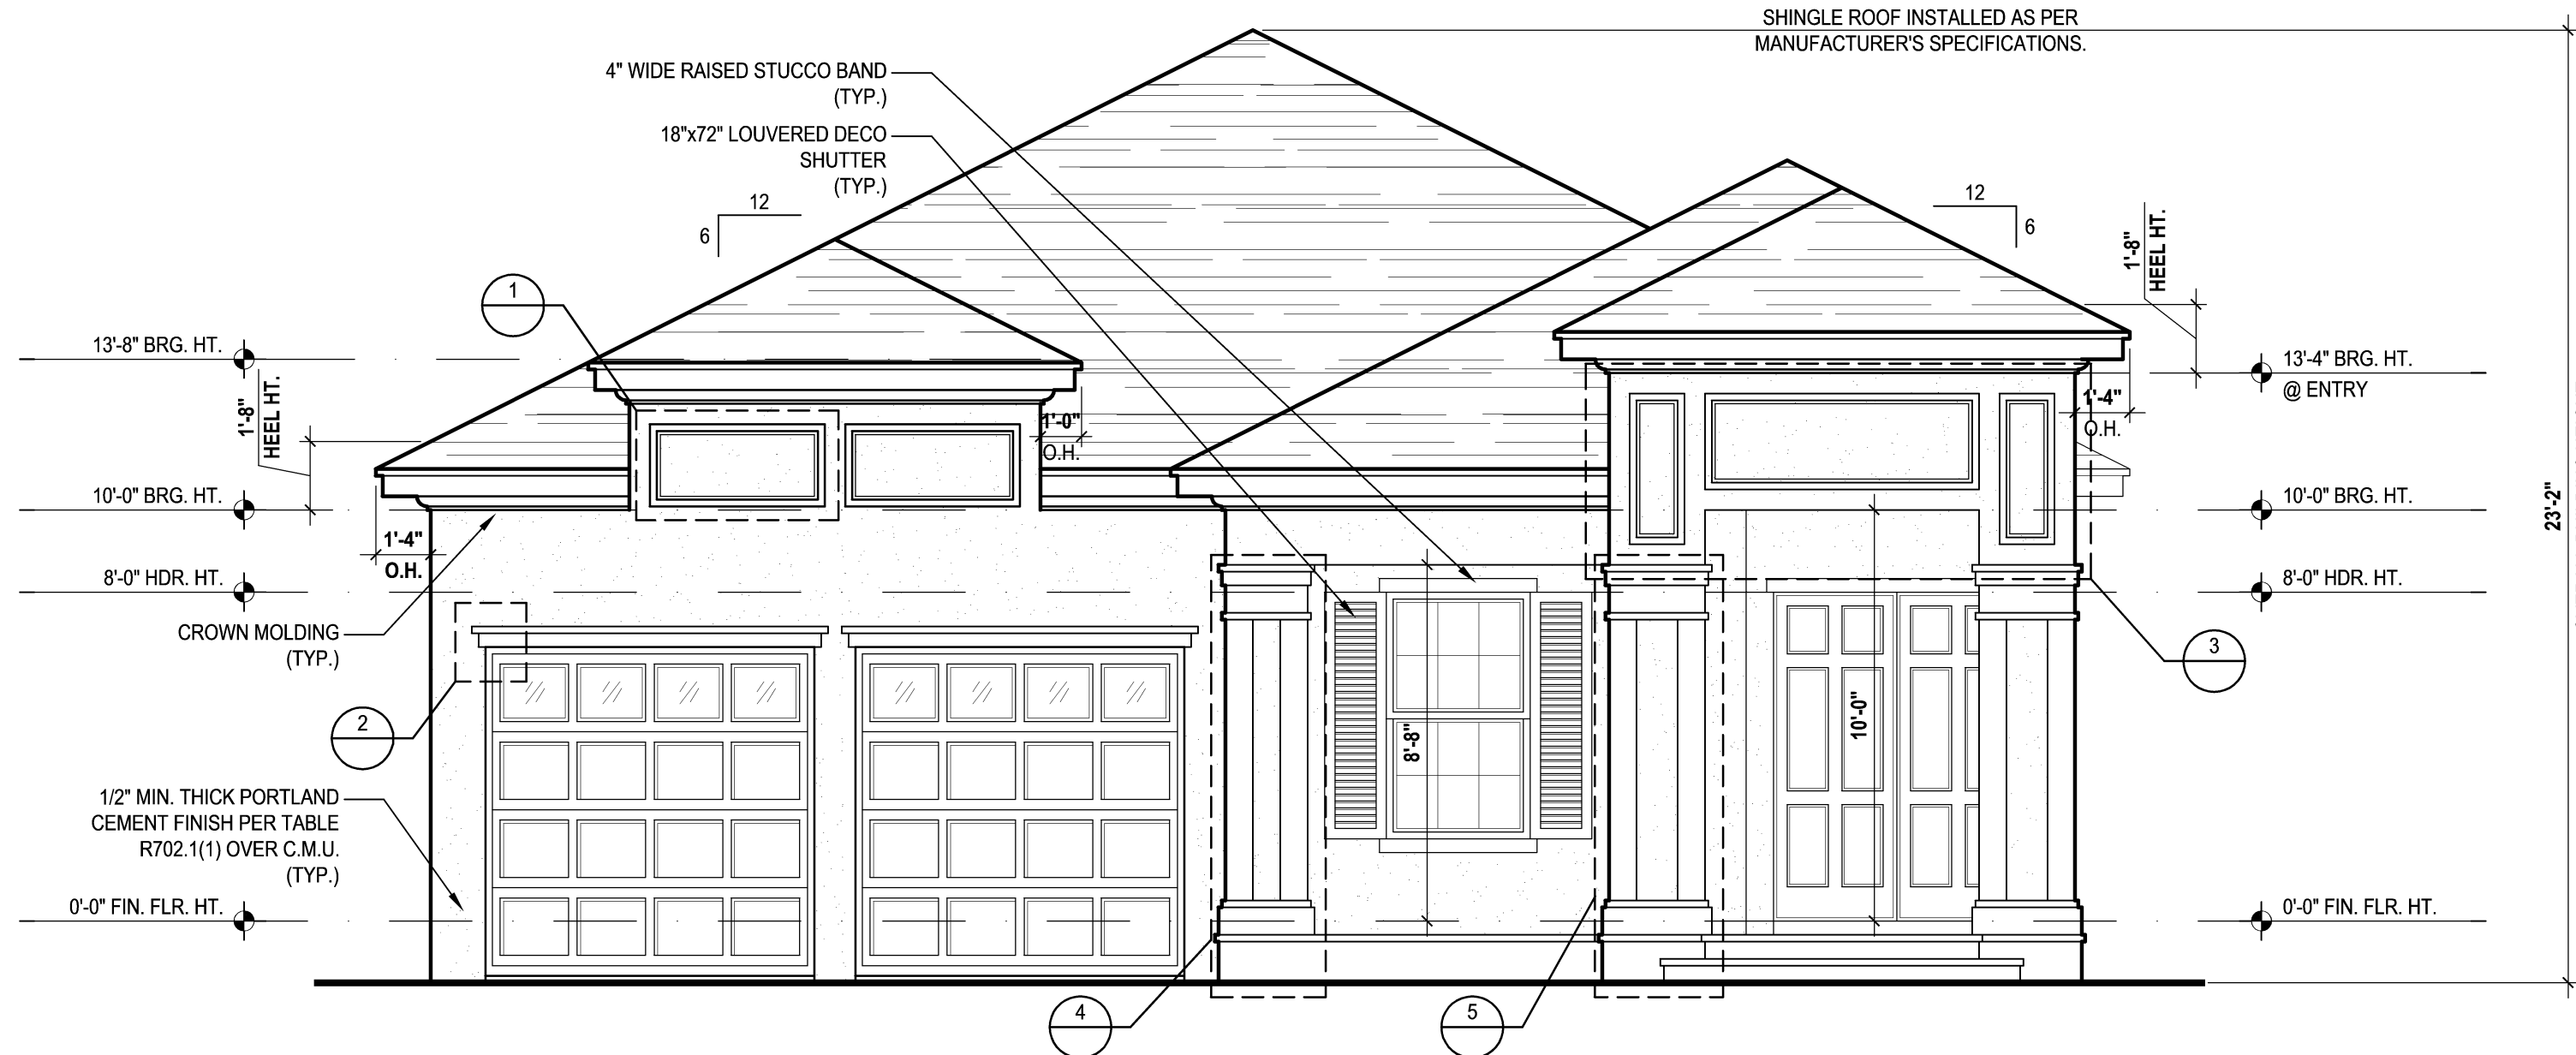

SCALE: 1/2" = 1'-0" (12x18) 1" = 1'-0" (24x36)


SCALE: 1/2" = 1'-0" (12x18) 1" = 1'-0" (24x36)

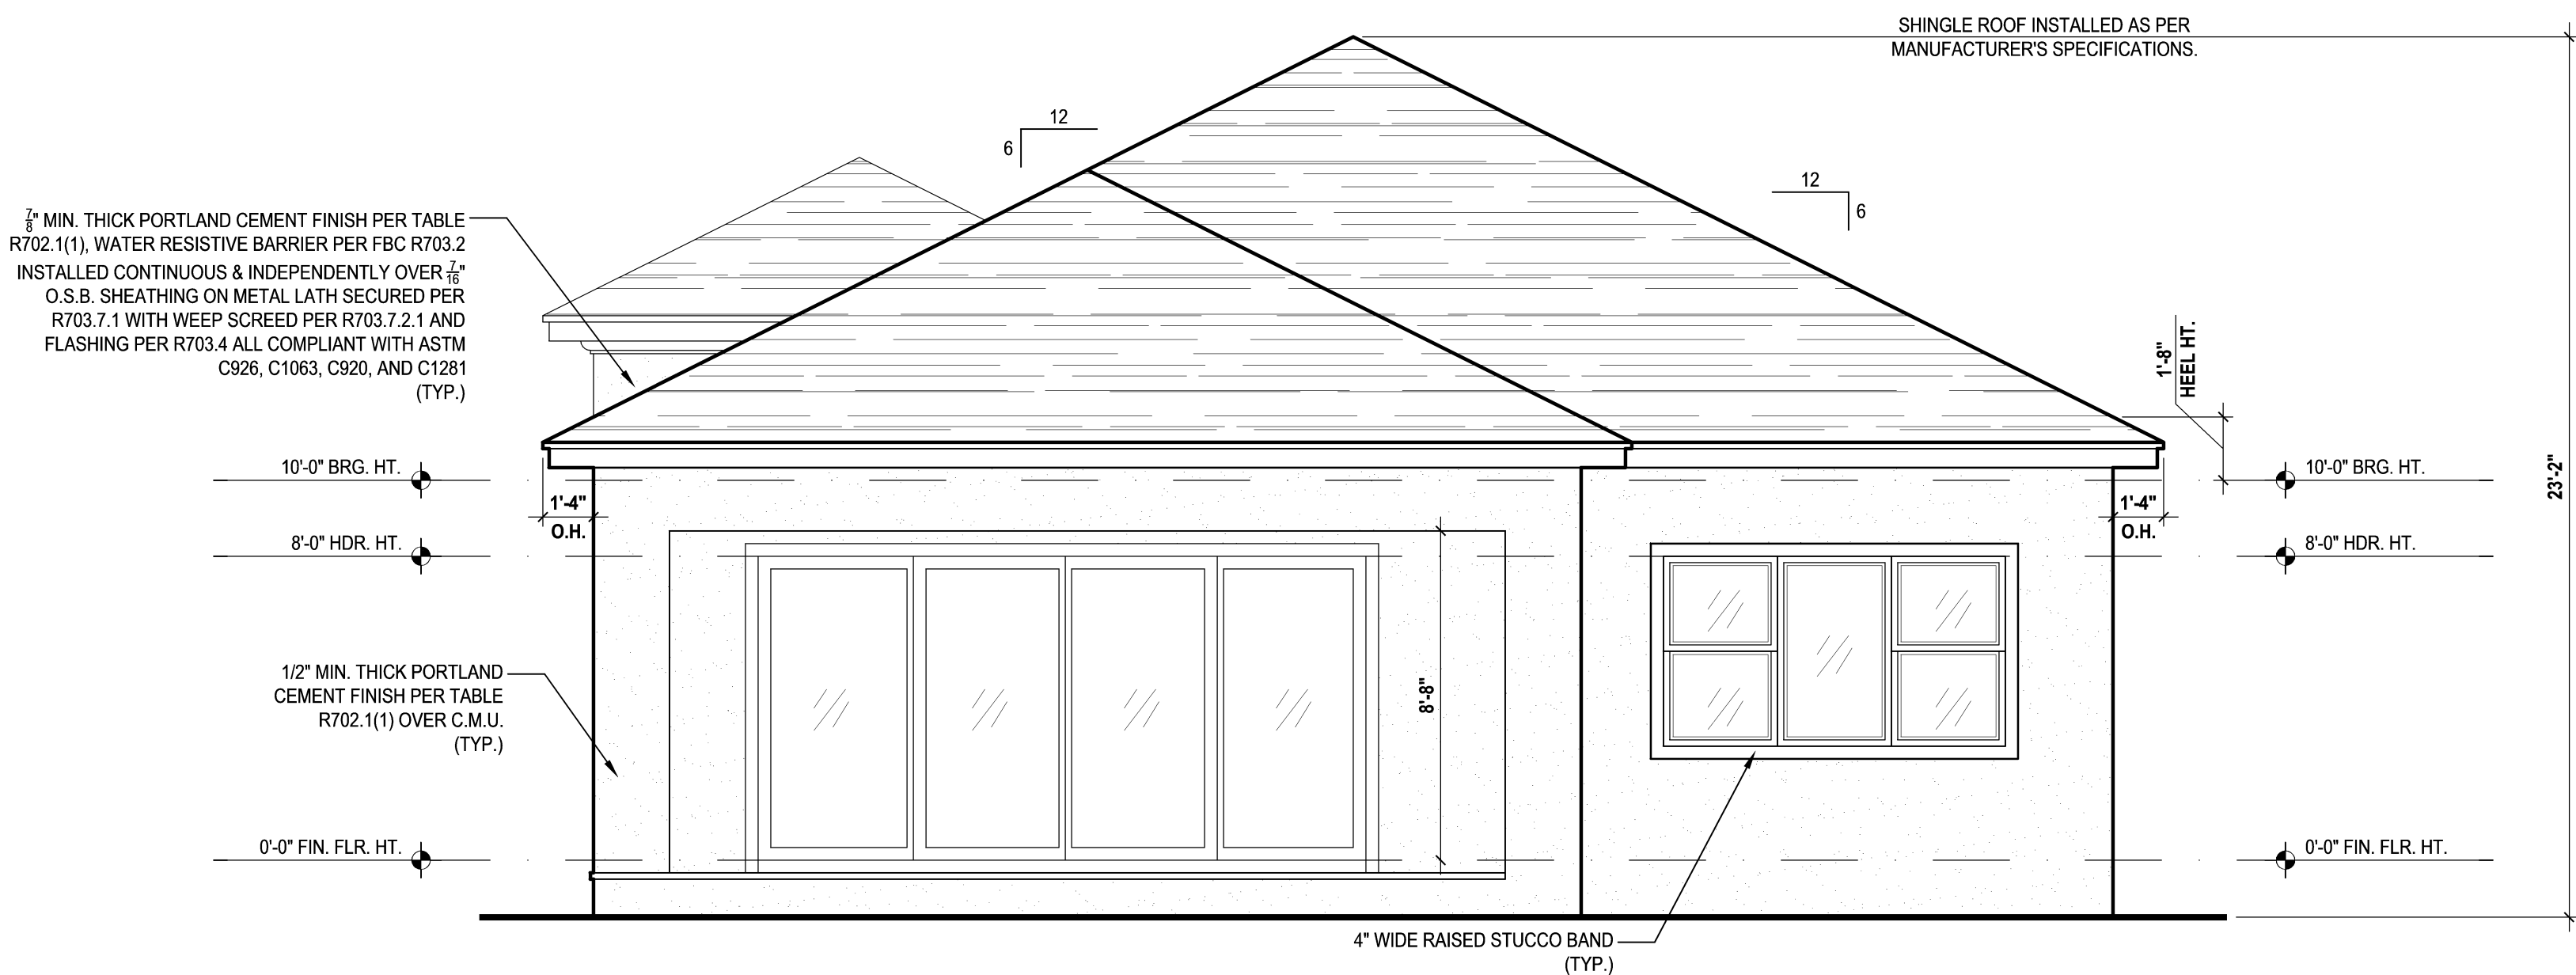

(Opt. Extended Lanai)

SCALE: 1/8" = 1'-0" (12x18) 1/4" = 1'-0" (24x36)

SCALE: 1/2" = 1'-0" (12x18) 1" = 1'-0" (24x36)

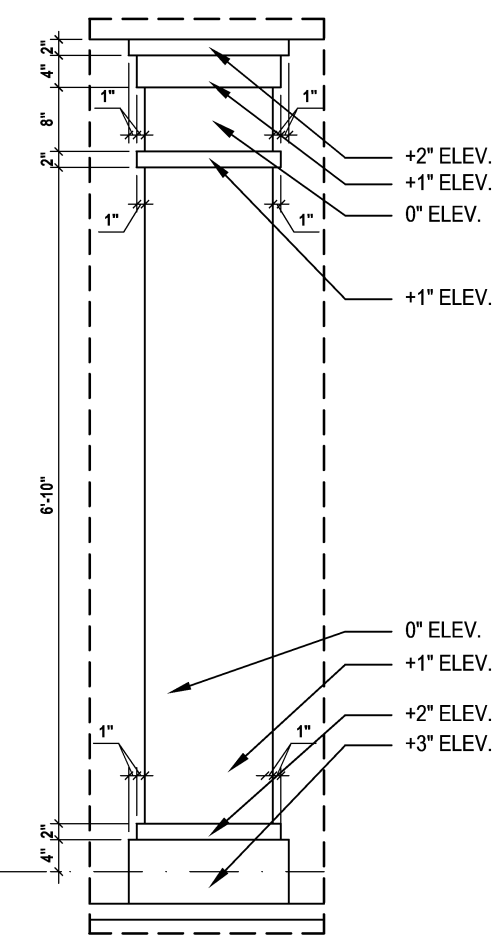

SCALE: 1/2" = 1'-0" (12x18) 1" = 1'-0" (24x36)

(Opt. Extended Lanai)

SCALE: 1/8" = 1'-0" (12x18) 1/4" = 1'-0" (24x36)

# ATTIC VENT CALC'S:

217 FLORIDA BUILDING CODE (16TH EDITION) SECTION R905  
MIN. 40% - MAX 50% OF REQUIRED VENTILATION TO BE  
IN UPPER PORTION OF ATTIC SPACE AND THE BALANCE TO BE  
IN LOWER PORTION (EAVES).  
(OFF-RIDGE VENT MAXIMUM OPENING SIZES)

MINIMUM NET VENTILATION AREA SHALL BE  $\frac{1}{15}$  OF VENTED SPACE.


TOTAL VENTED SPACE:  $4.842 = \frac{16.14 \text{ SF.}}{300}$  NET FREE  
REQUIRED

UPPER PORTION VENTILATION TOTAL: 6.456 SF.  
TO BE PROVIDED w/ OFF RIDGE VENTS:  
10 VENTS @ .683 /PER VENT

TITLE: O'HAGIN MODEL "S", SHINGLE: LOMAXCO 770-D).


LOWER PORTION VENTILATION TOTAL: 9.684 SF.  
TO BE PROVIDED w/ SOFFITS @ EAVE:  
80.01 LF. @ 0.121 SF. VENTING/LF.

UPPER ROOF PERCENTAGE: 40%  
LOWER ROOF PERCENTAGE: 60%

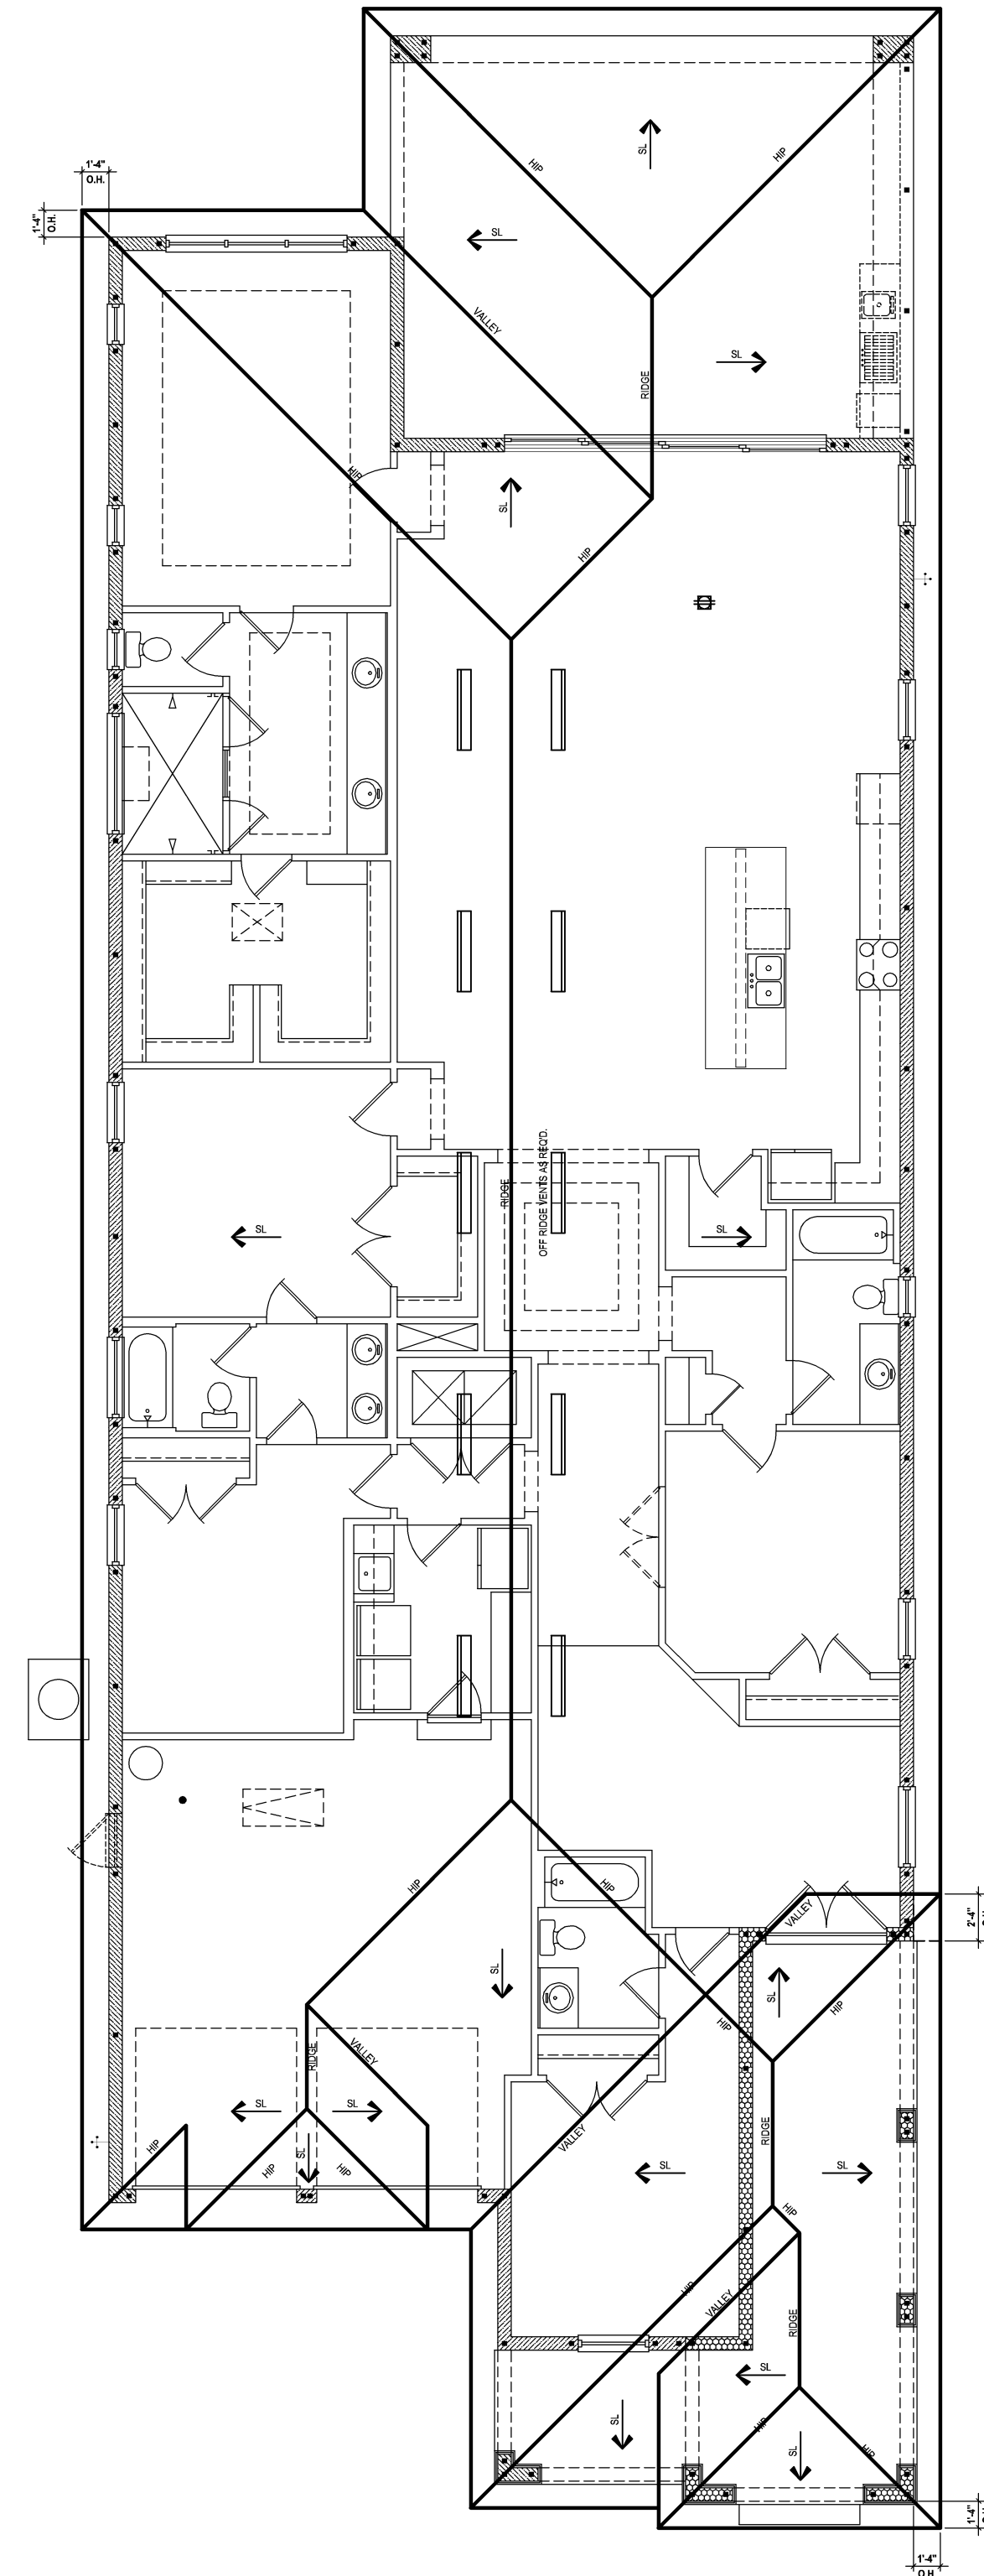


(Standard)

SCALE: 1/16" = 1'-0" (11x17) 1/8" = 1'-0" (22x34)

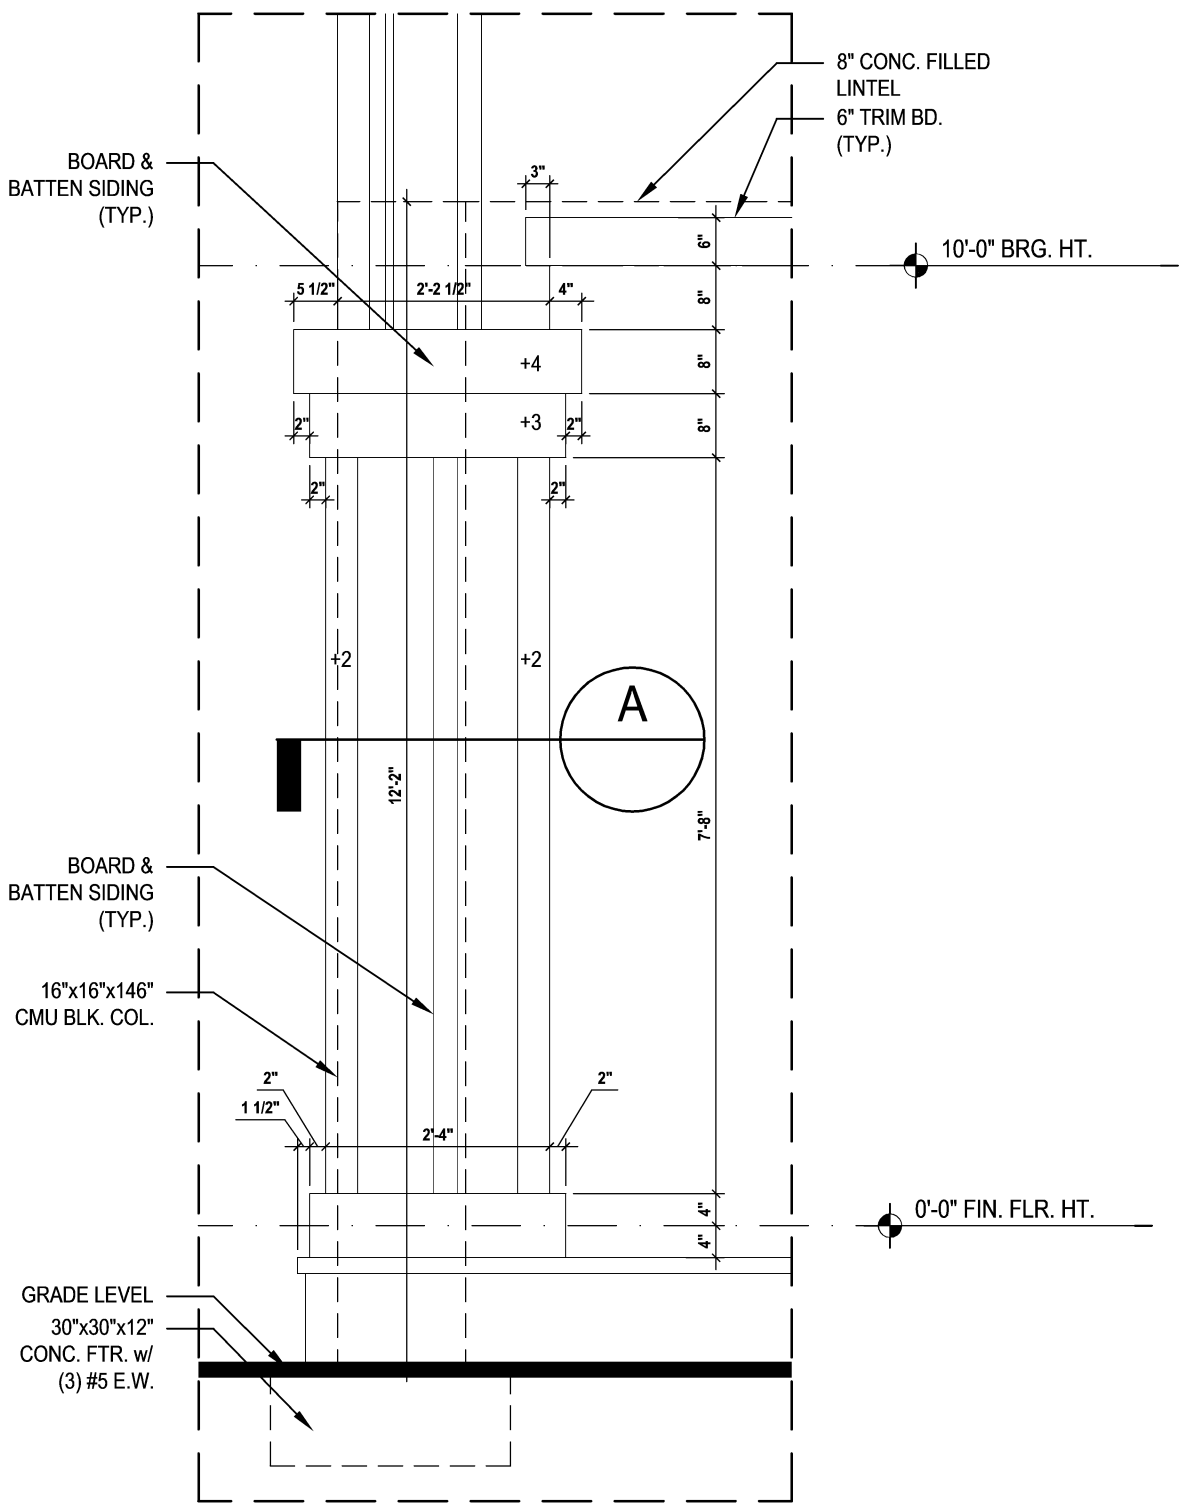


Detail #1

SCALE: 1/2" = 1'-0" (12x18) 1" = 1'-0" (24x36)

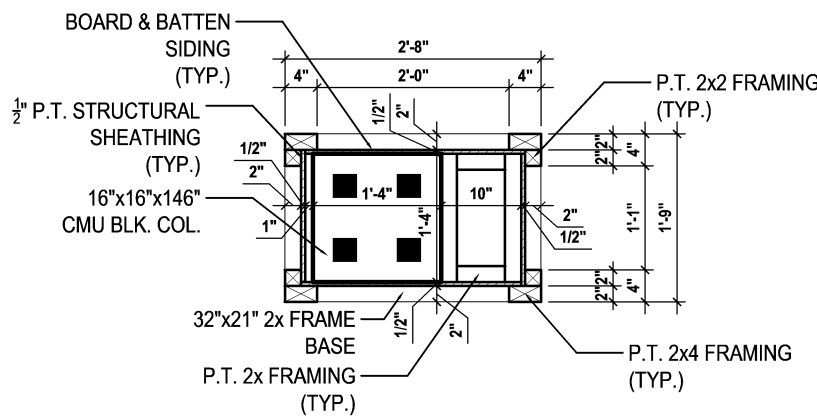

Detail #A


SCALE: 1/2" = 1'-0" (12x18) 1" = 1'-0" (24x36)

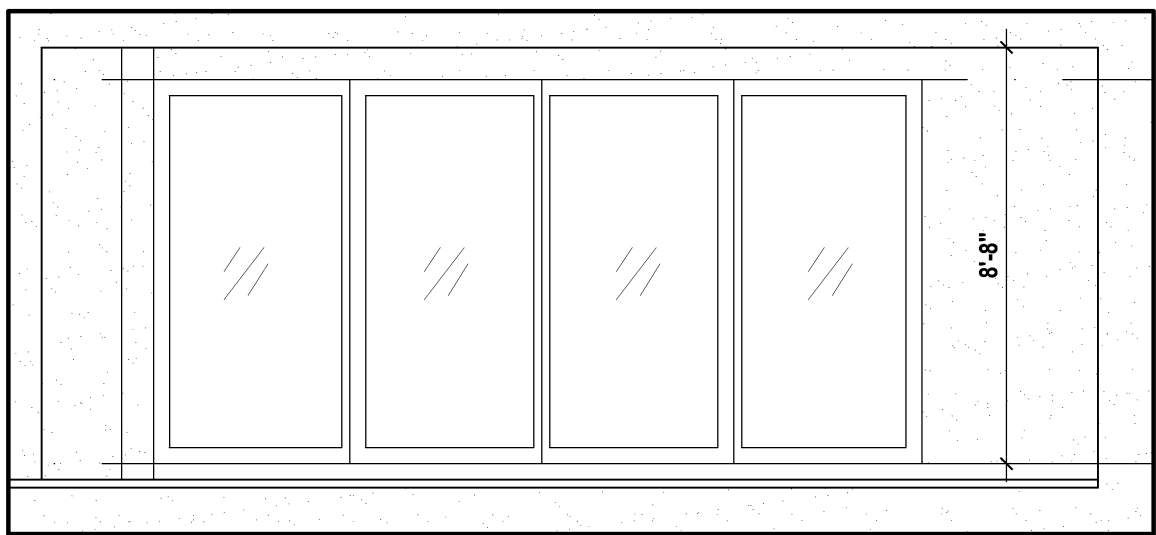

Rear Elevation

(Opt. Pocket SGD Dr.)


SCALE: 1/8" = 1'-0" (12x18) 1/4" = 1'-0" (24x36)

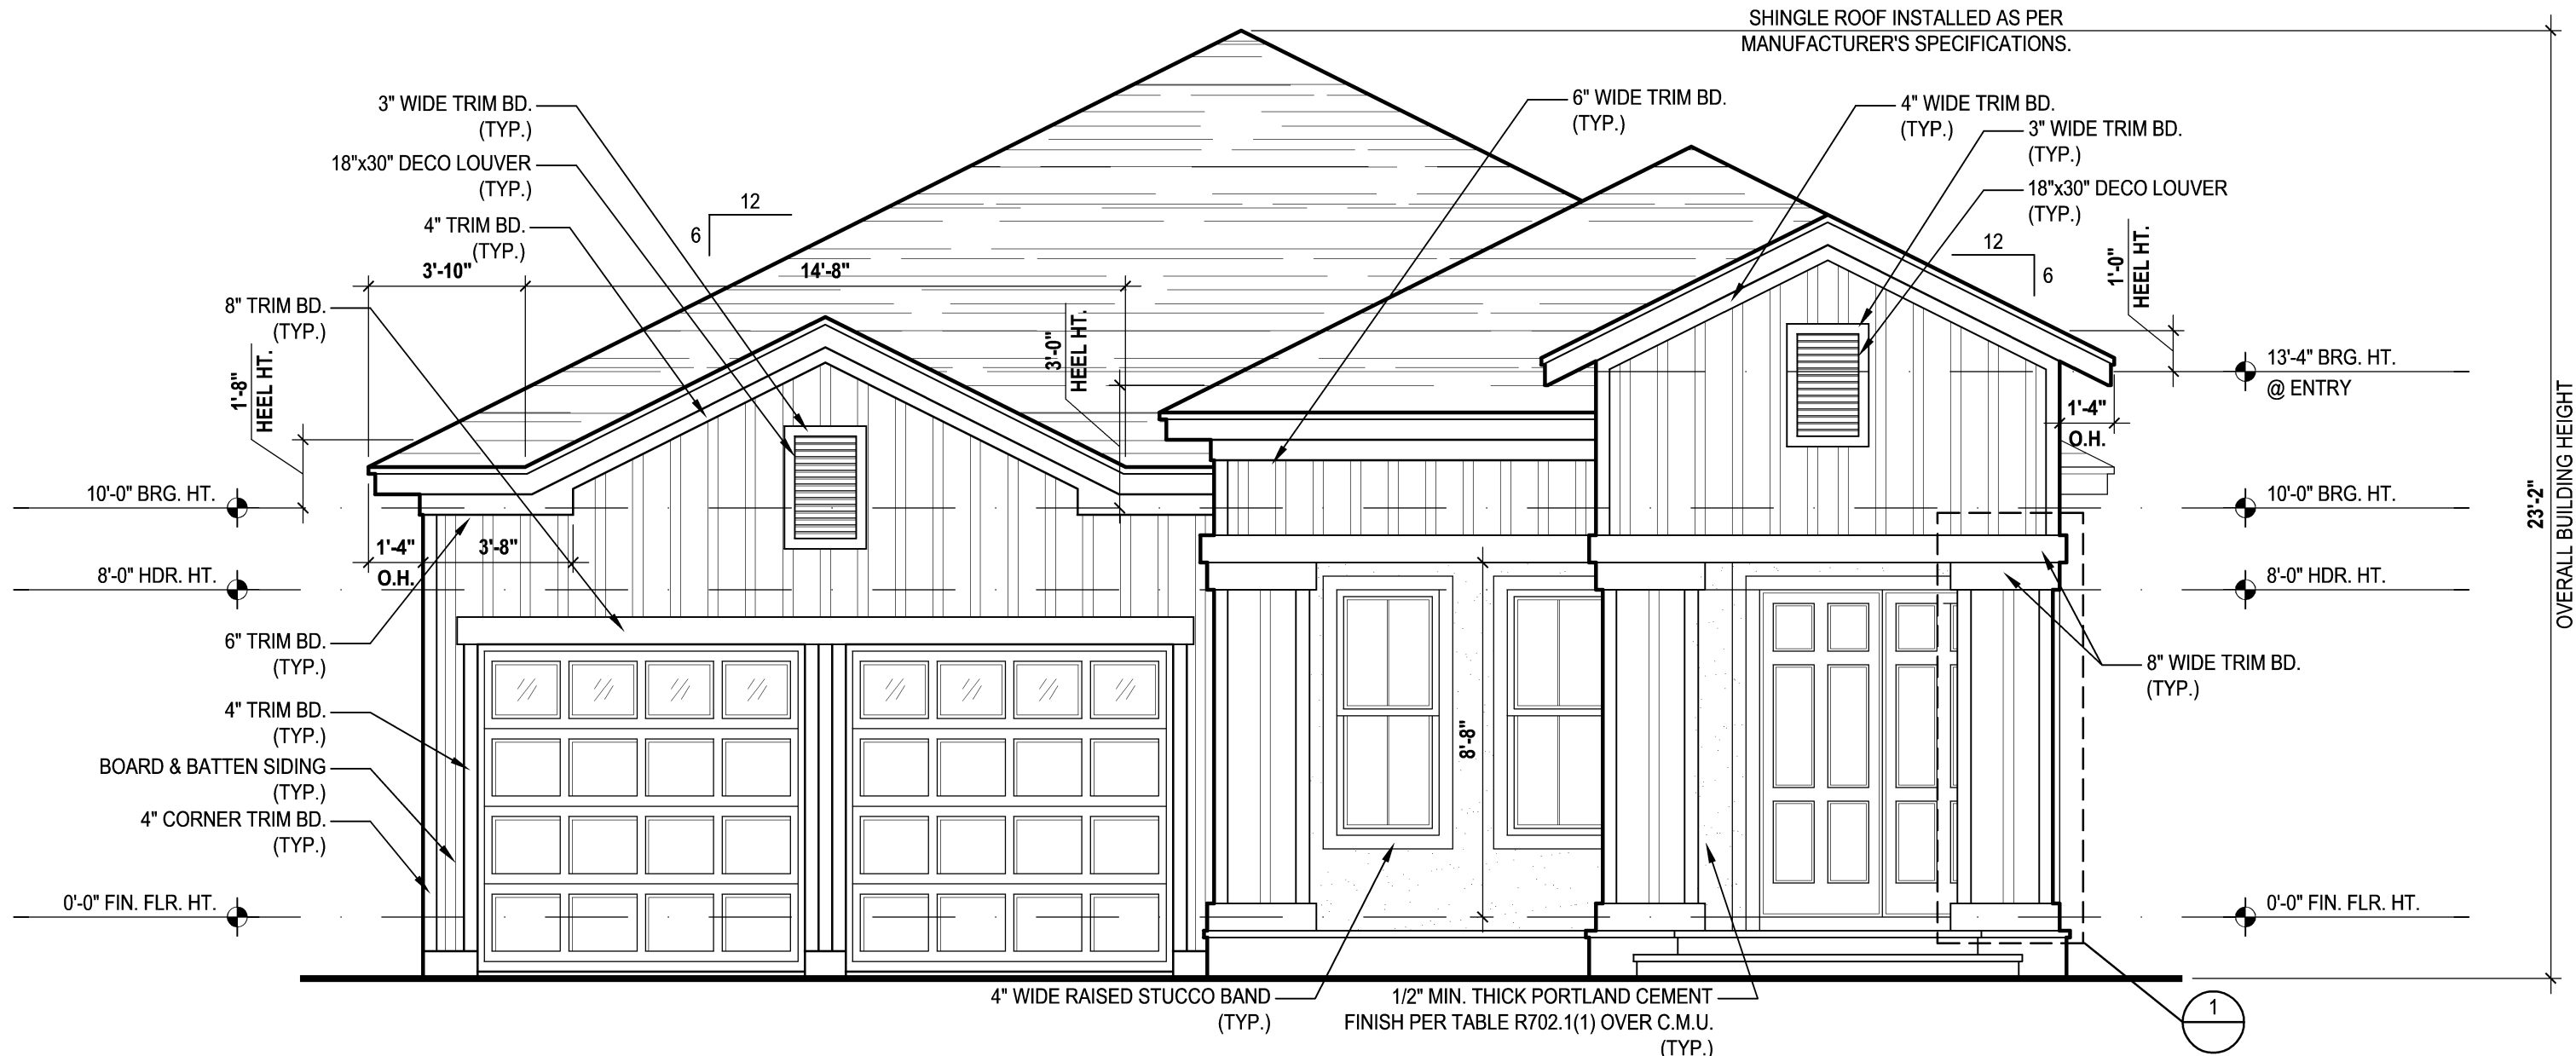

Front Elevation "B"

(Standard)


SCALE: 1/8" = 1'-0" (12x18) 1/4" = 1'-0" (24x36)

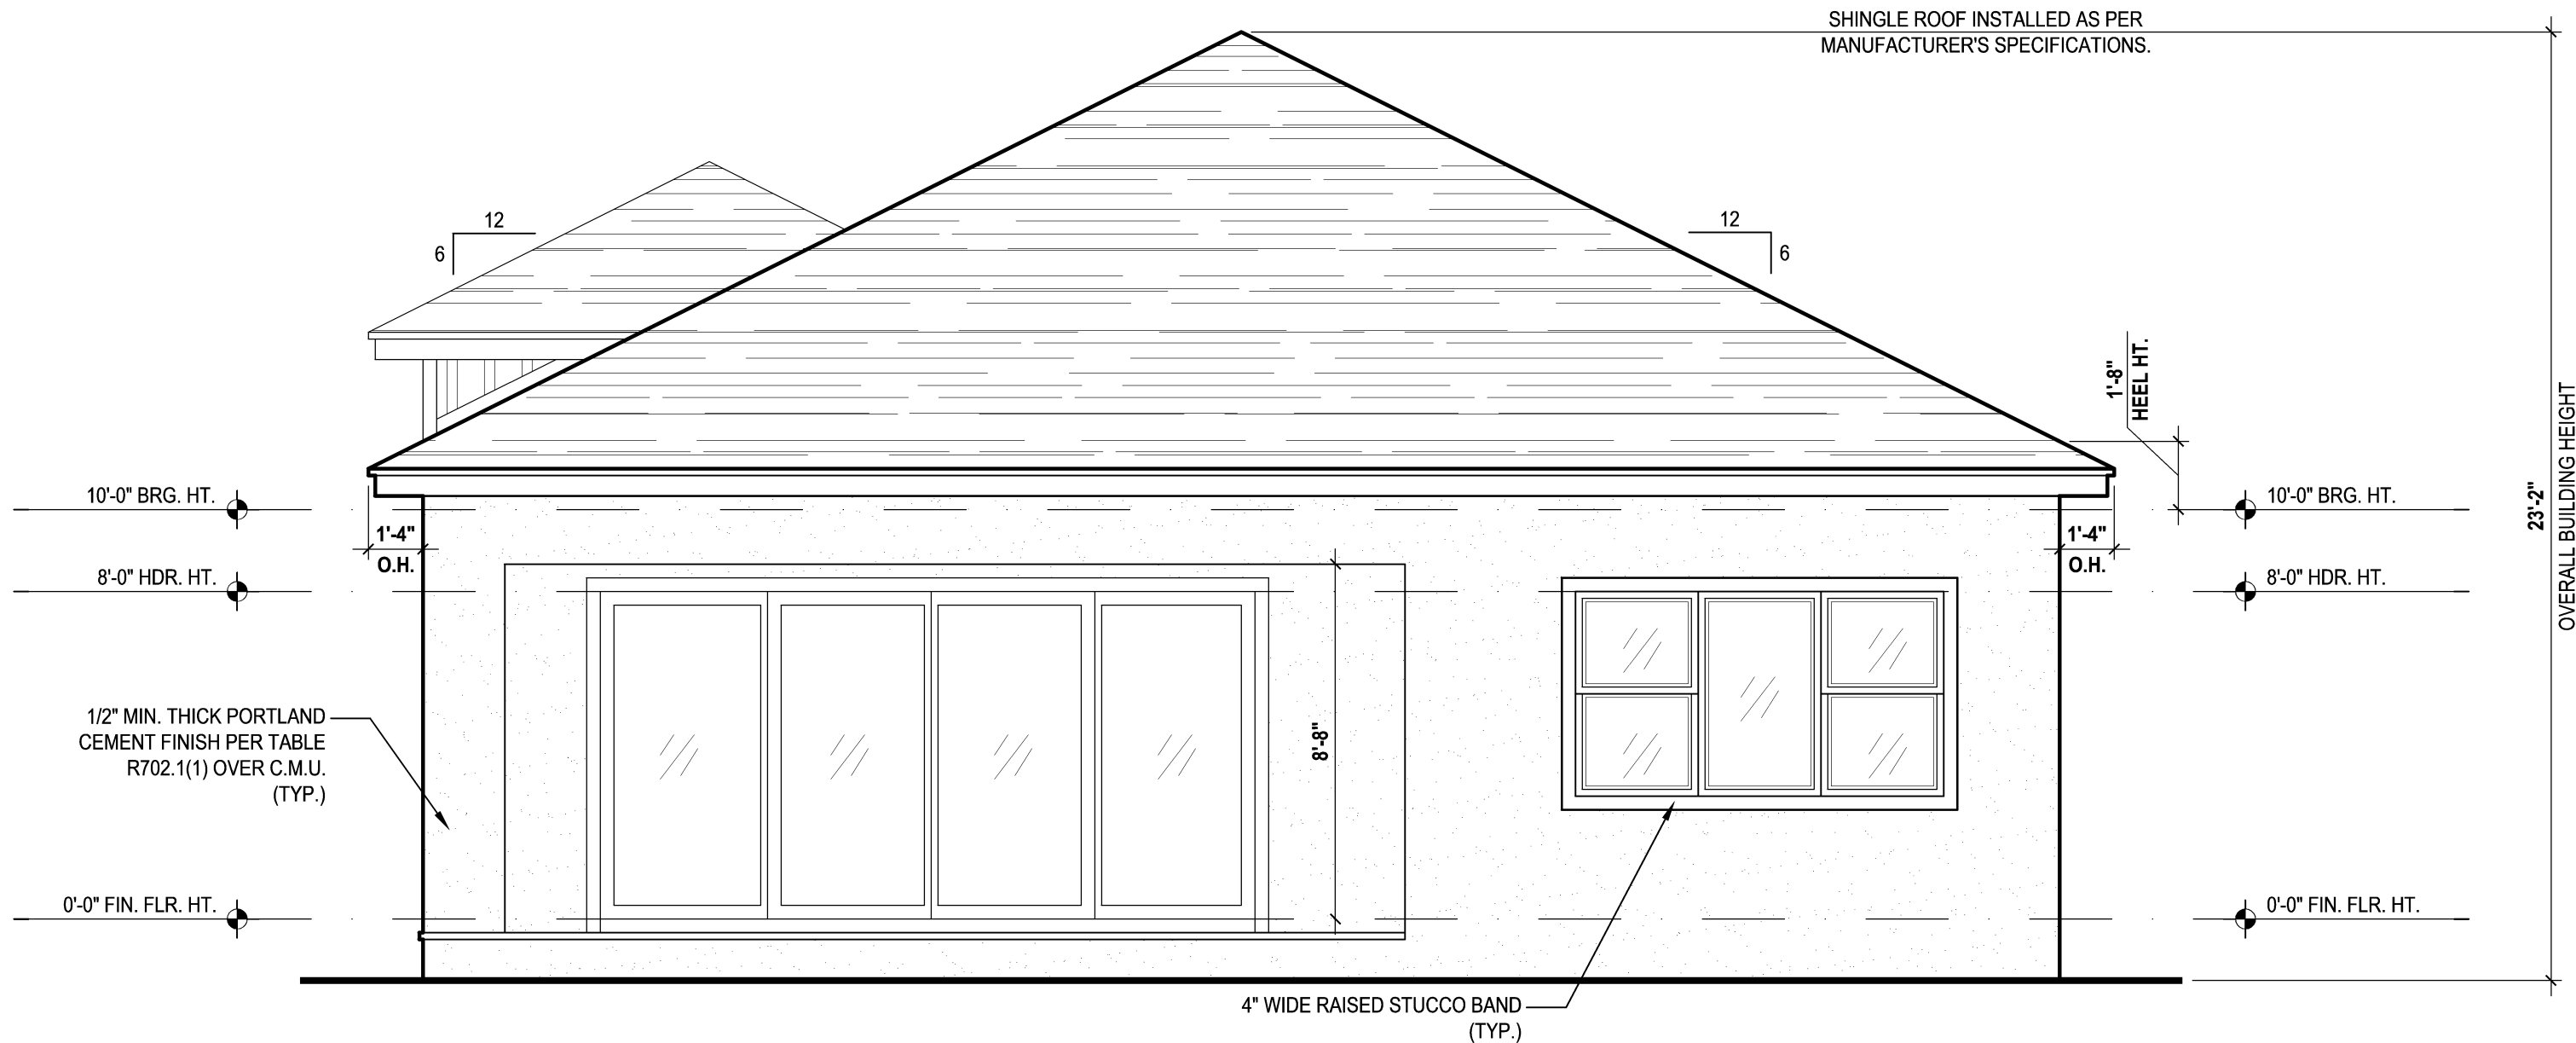

Rear Elevation "B"

(Standard)

SCALE: 1/8" = 1'-0" (12x18) 1/4" = 1'-0" (24x36)

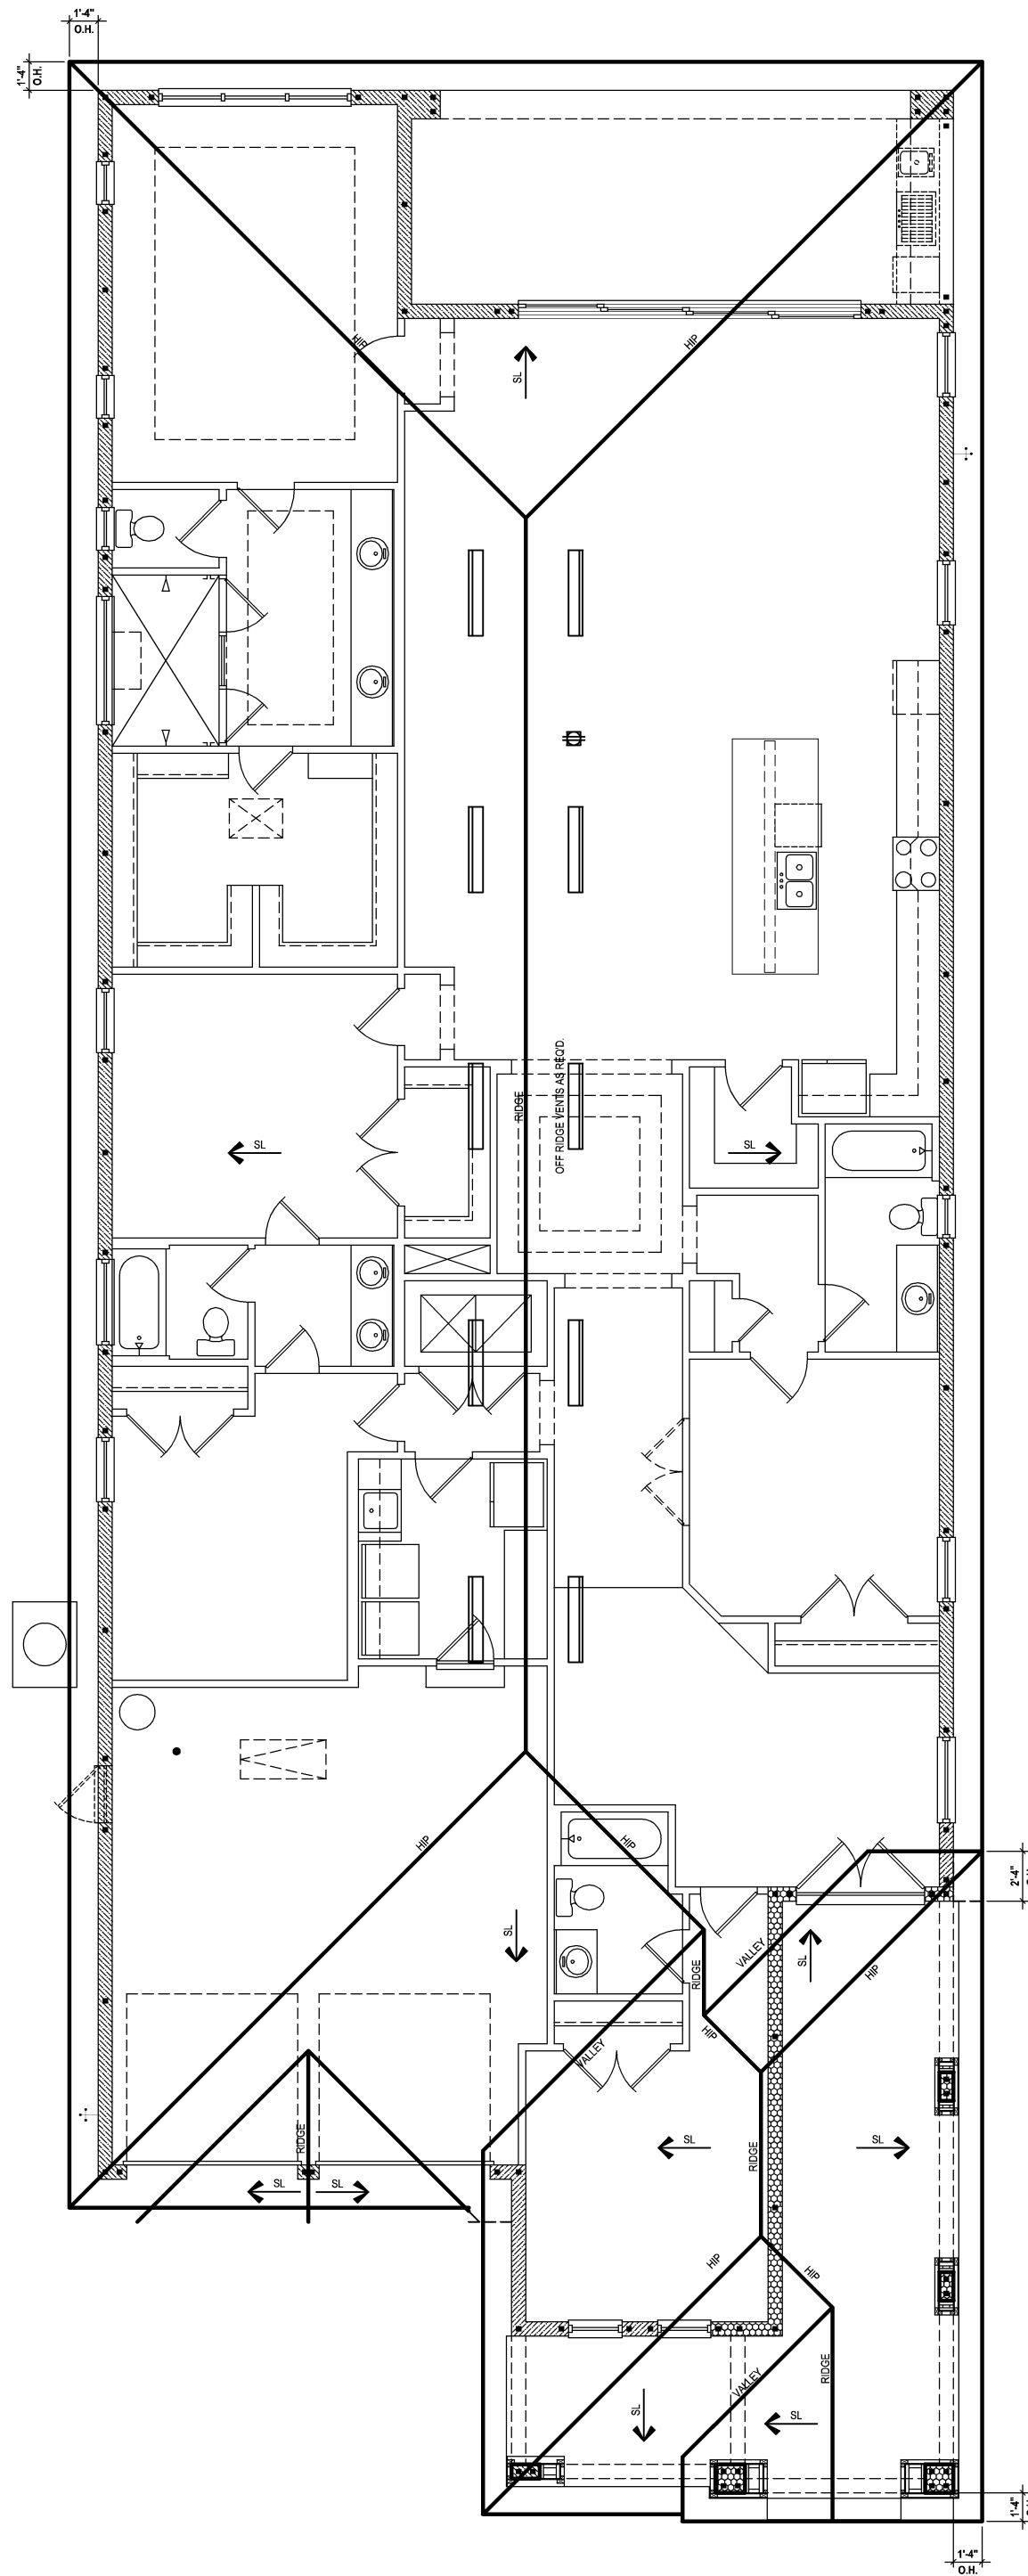

Roof Layout

(Standard)

SCALE: 1/16" = 1'-0" (11x17) 1/8" = 1'-0" (22x34)

ATTIC VENT CALC'S:

2017 FLORIDA BUILDING CODE (6TH EDITION) SECTION R806  
MIN. 40% - MAX 50% OF REQUIRED VENTILATION TO BE IN  
UPPER PORTION OF ATTIC SPACE AND THE BALANCE TO BE  
IN LOWER PORTION (EAVES).  
(OFF-RIDGE VENT MAXIMUM OPENING SIZES)

MINIMUM NET VENTILATION AREA SHALL BE 1/30 OF VENTED  
SPACE.

TOTAL VENTED SPACE: 4,842 = 16.14 SF. NET FREE  
300 REQUIRED


UPPER PORTION VENTILATION TOTAL: 6,456 SF.  
TO BE PROVIDED w/ OFF RIDGE VENTS:  
10 VENTS @ .683 /PER VENT

TILE: OHAGIN MODEL "S", SHINGLE: LOMANCO 770-D).

LOWER PORTION VENTILATION TOTAL: 9,684 SF.  
TO BE PROVIDED w/ SOFFITS @ EAVE:  
90.00 LF. @ 0.121 SF. VENTING/LF.


UPPER ROOF PERCENTAGE: 40%  
LOWER ROOF PERCENTAGE: 60%



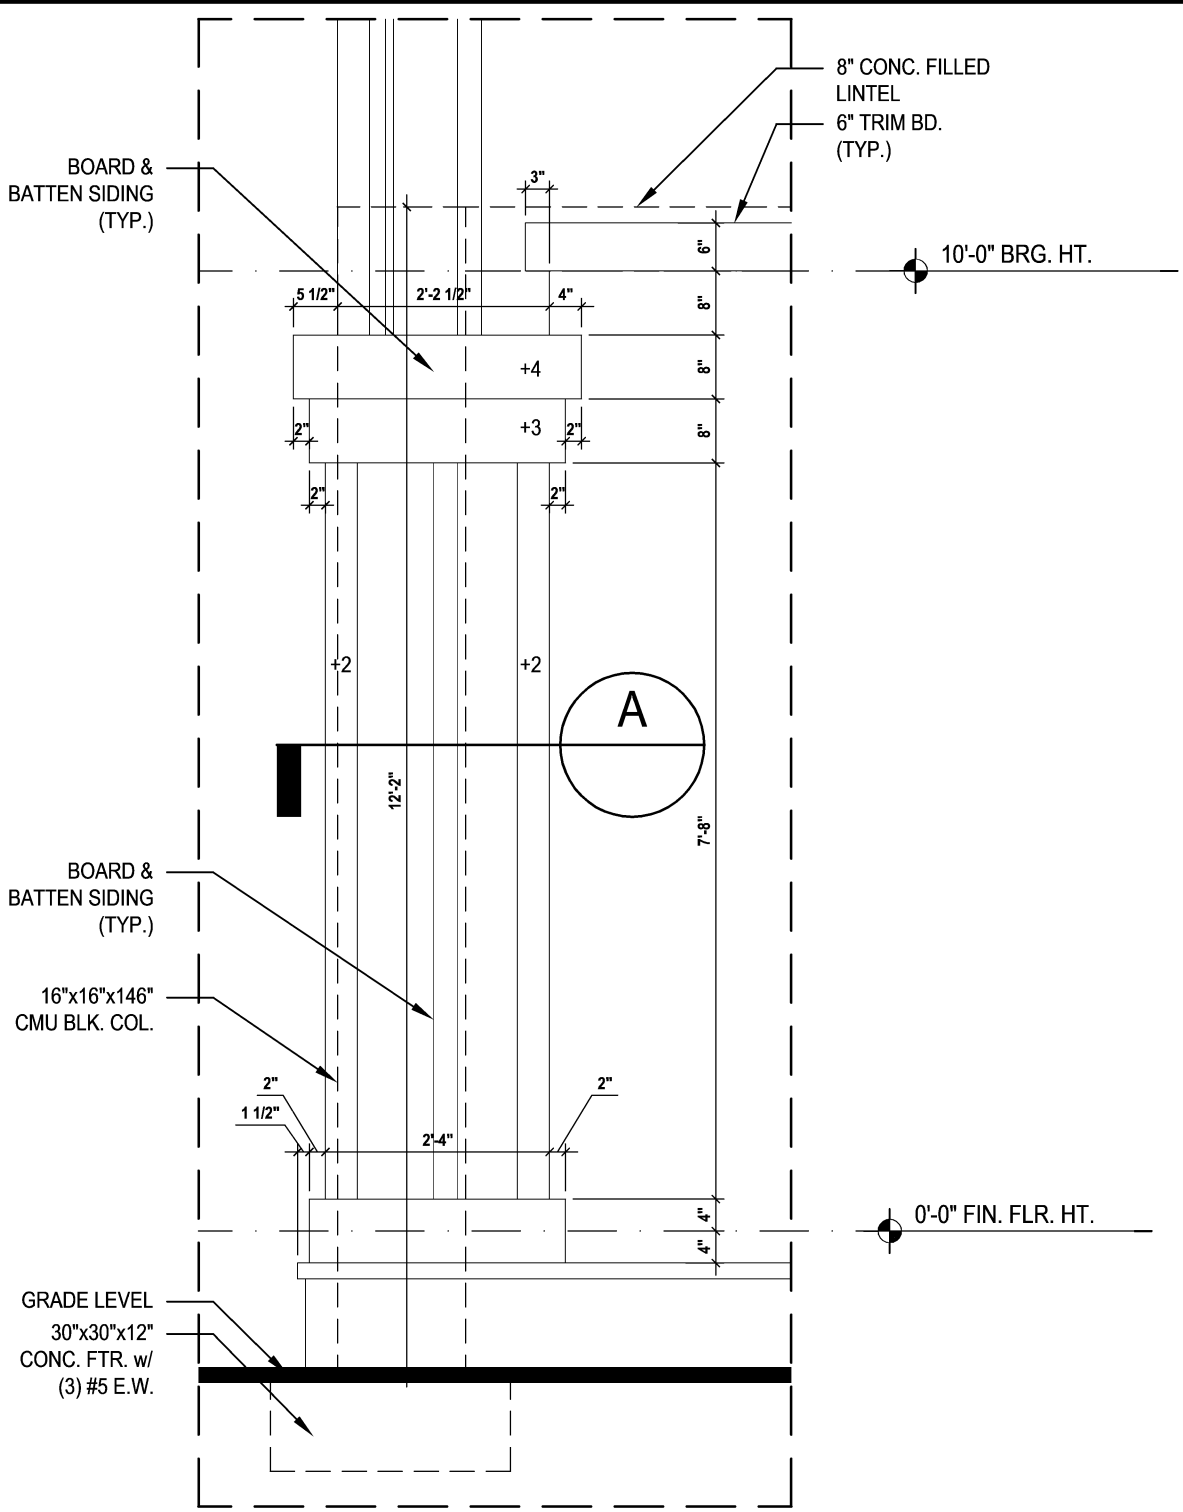


Detail #1

SCALE: 1/2" = 1'-0" (12x18) 1" = 1'-0" (24x36)

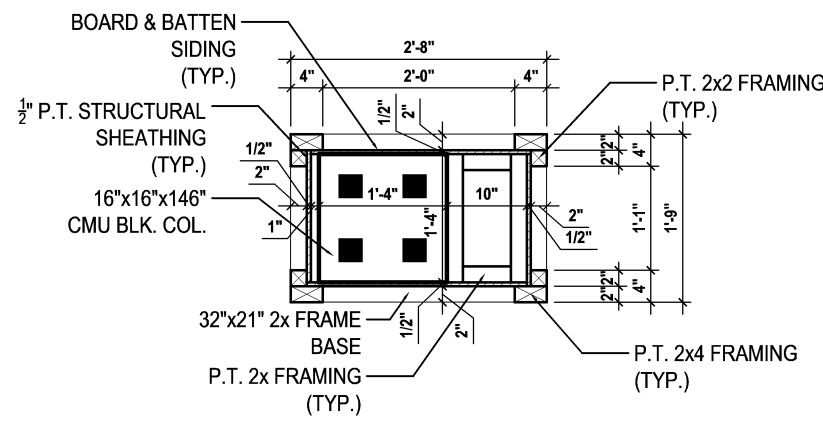

Detail #A


SCALE: 1/2" = 1'-0" (12x18) 1" = 1'-0" (24x36)

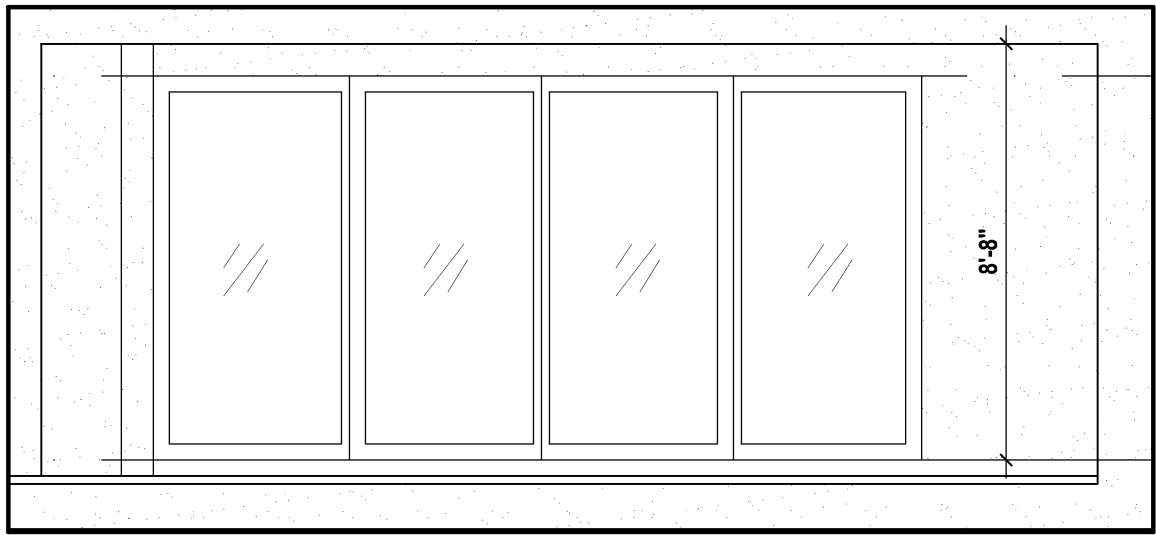

Rear Elevation

(Opt. Pocket SGD Dr.)


SCALE: 1/8" = 1'-0" (12x18) 1/4" = 1'-0" (24x36)

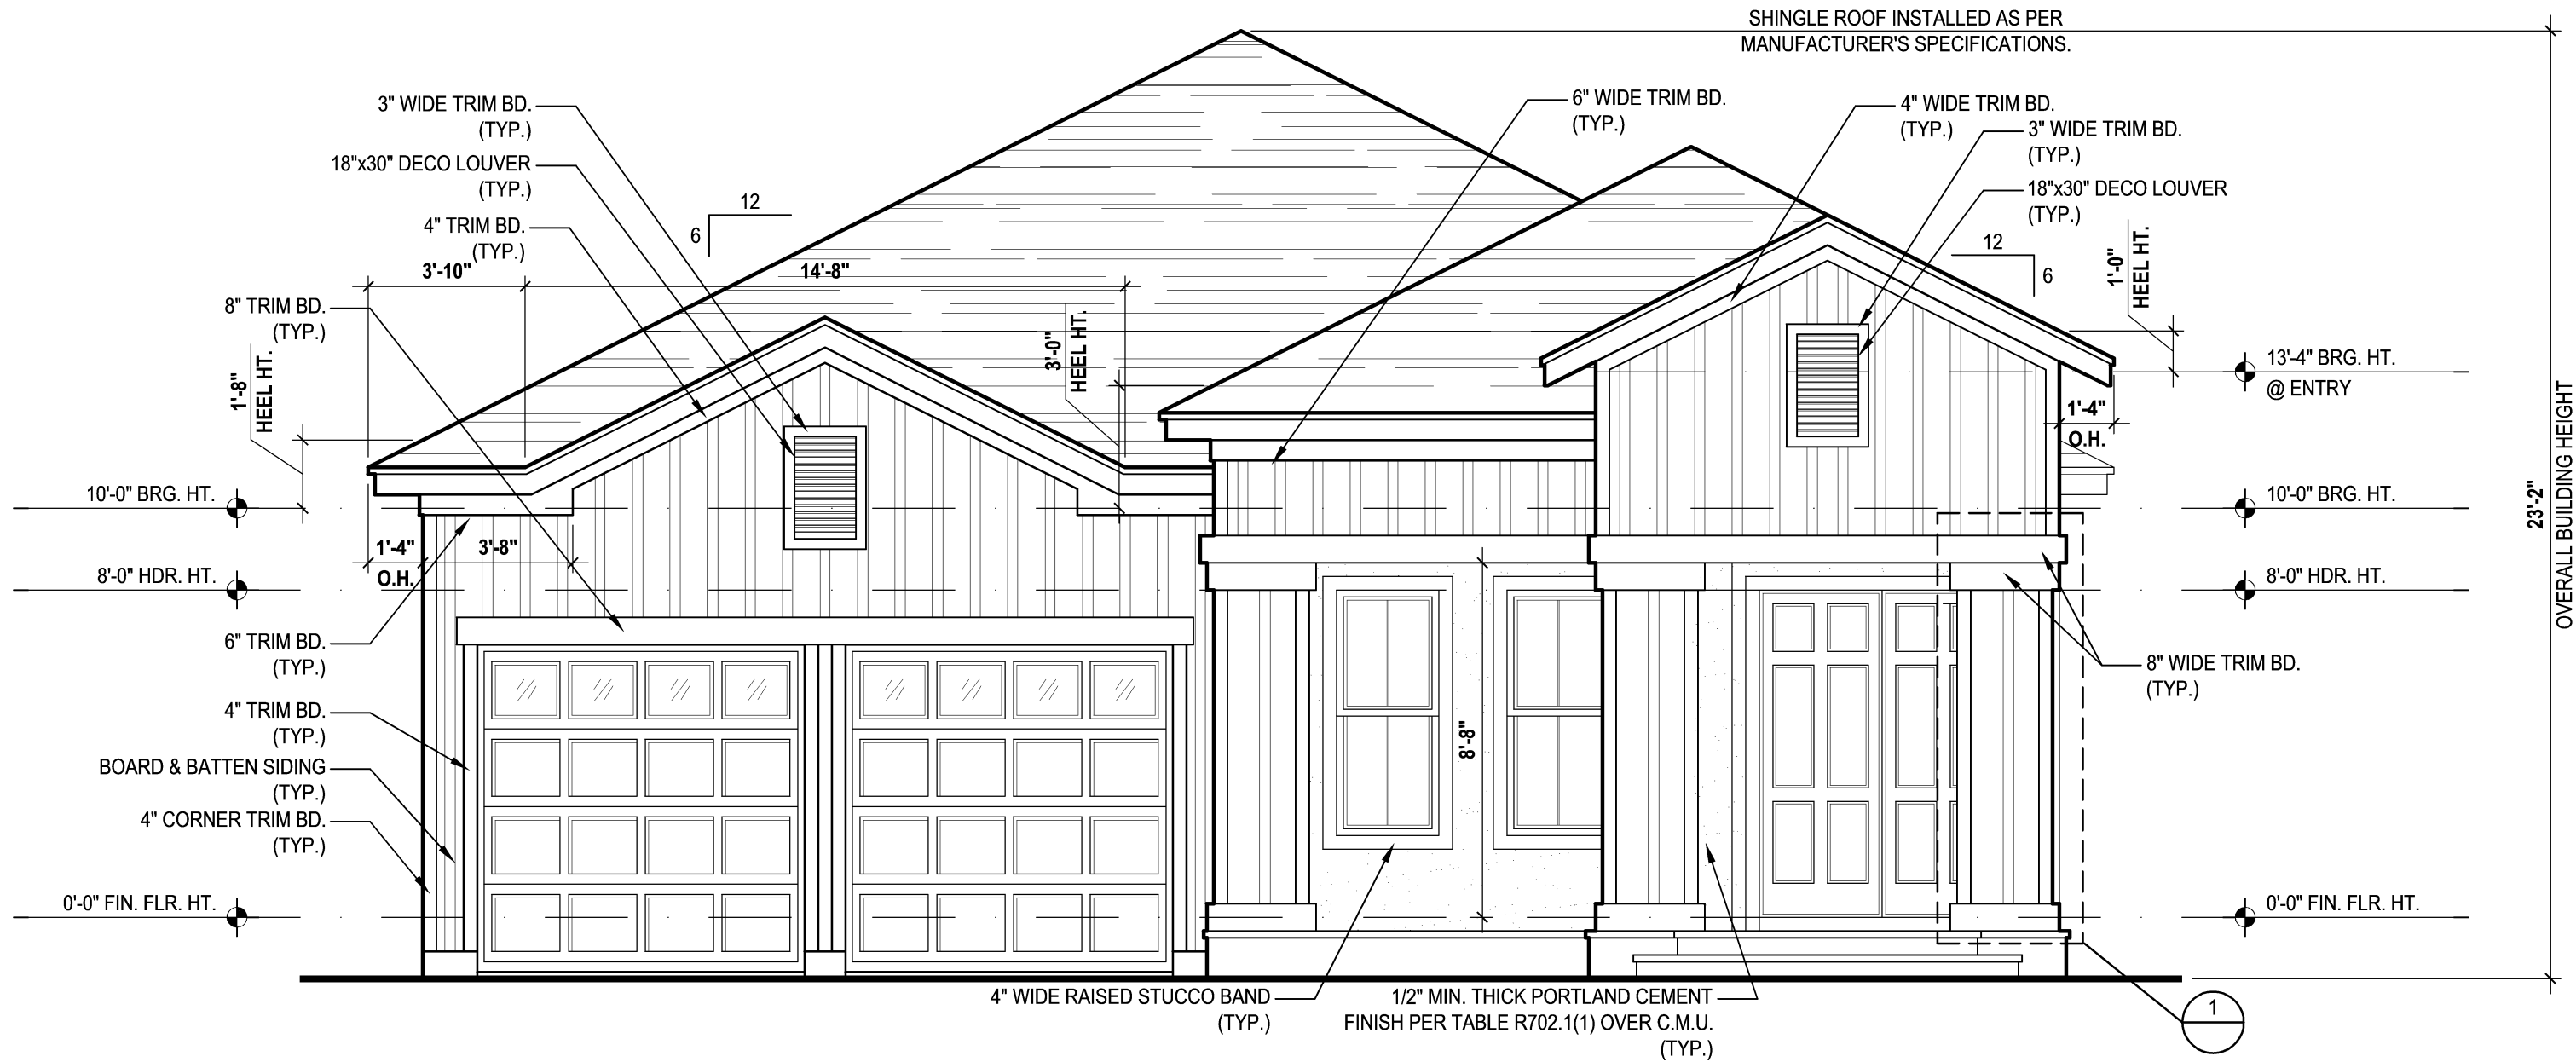

Front Elevation "B"

(Opt. Extended Lanai)


SCALE: 1/8" = 1'-0" (12x18) 1/4" = 1'-0" (24x36)

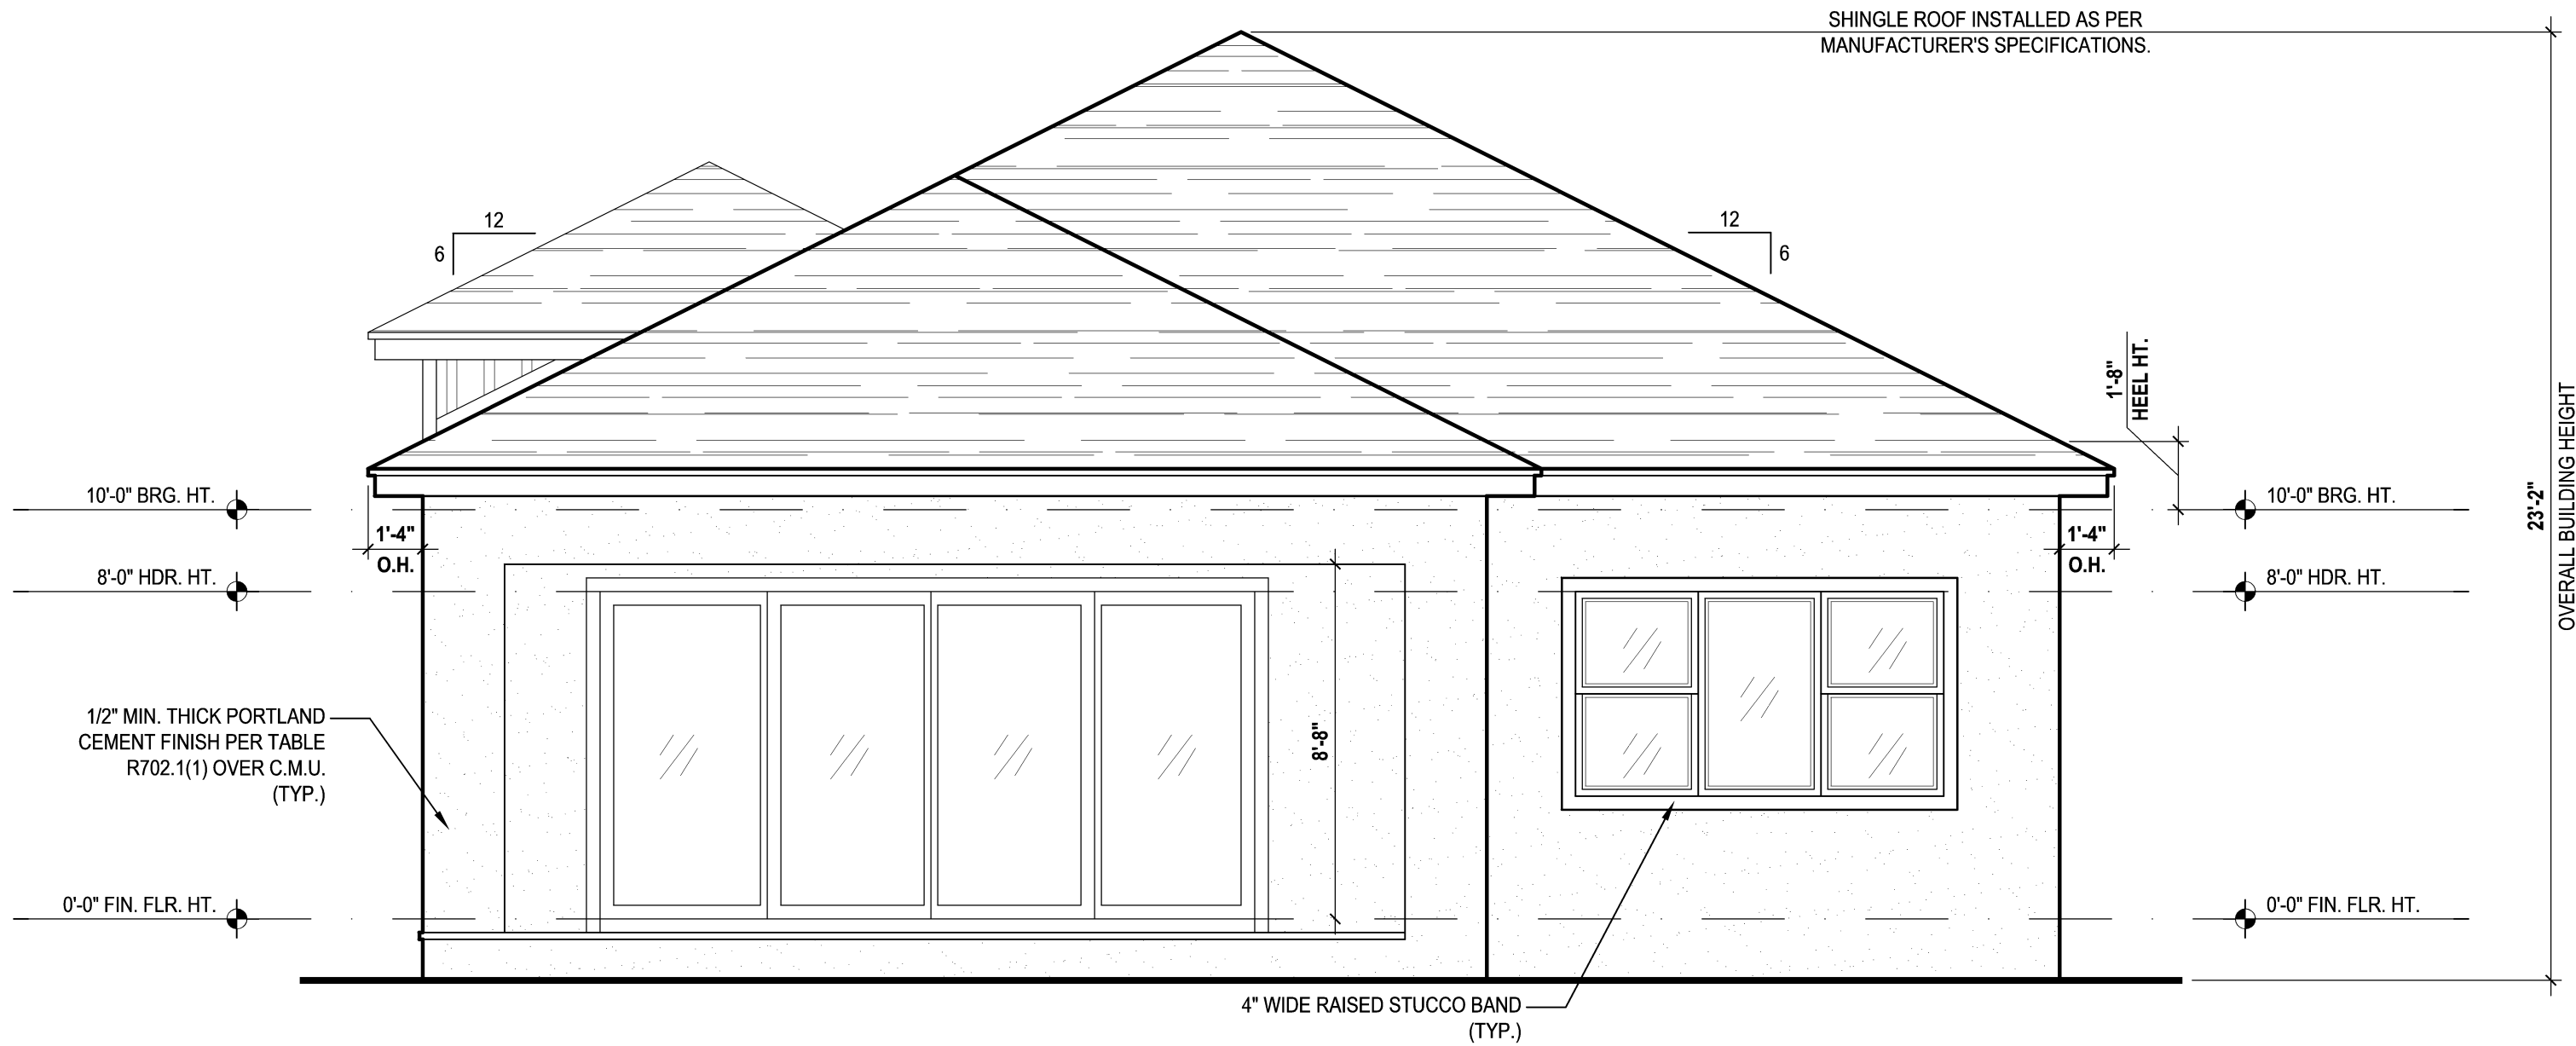

Rear Elevation "B"

(Opt. Extended Lanai)

SCALE: 1/8" = 1'-0" (12x18) 1/4" = 1'-0" (24x36)

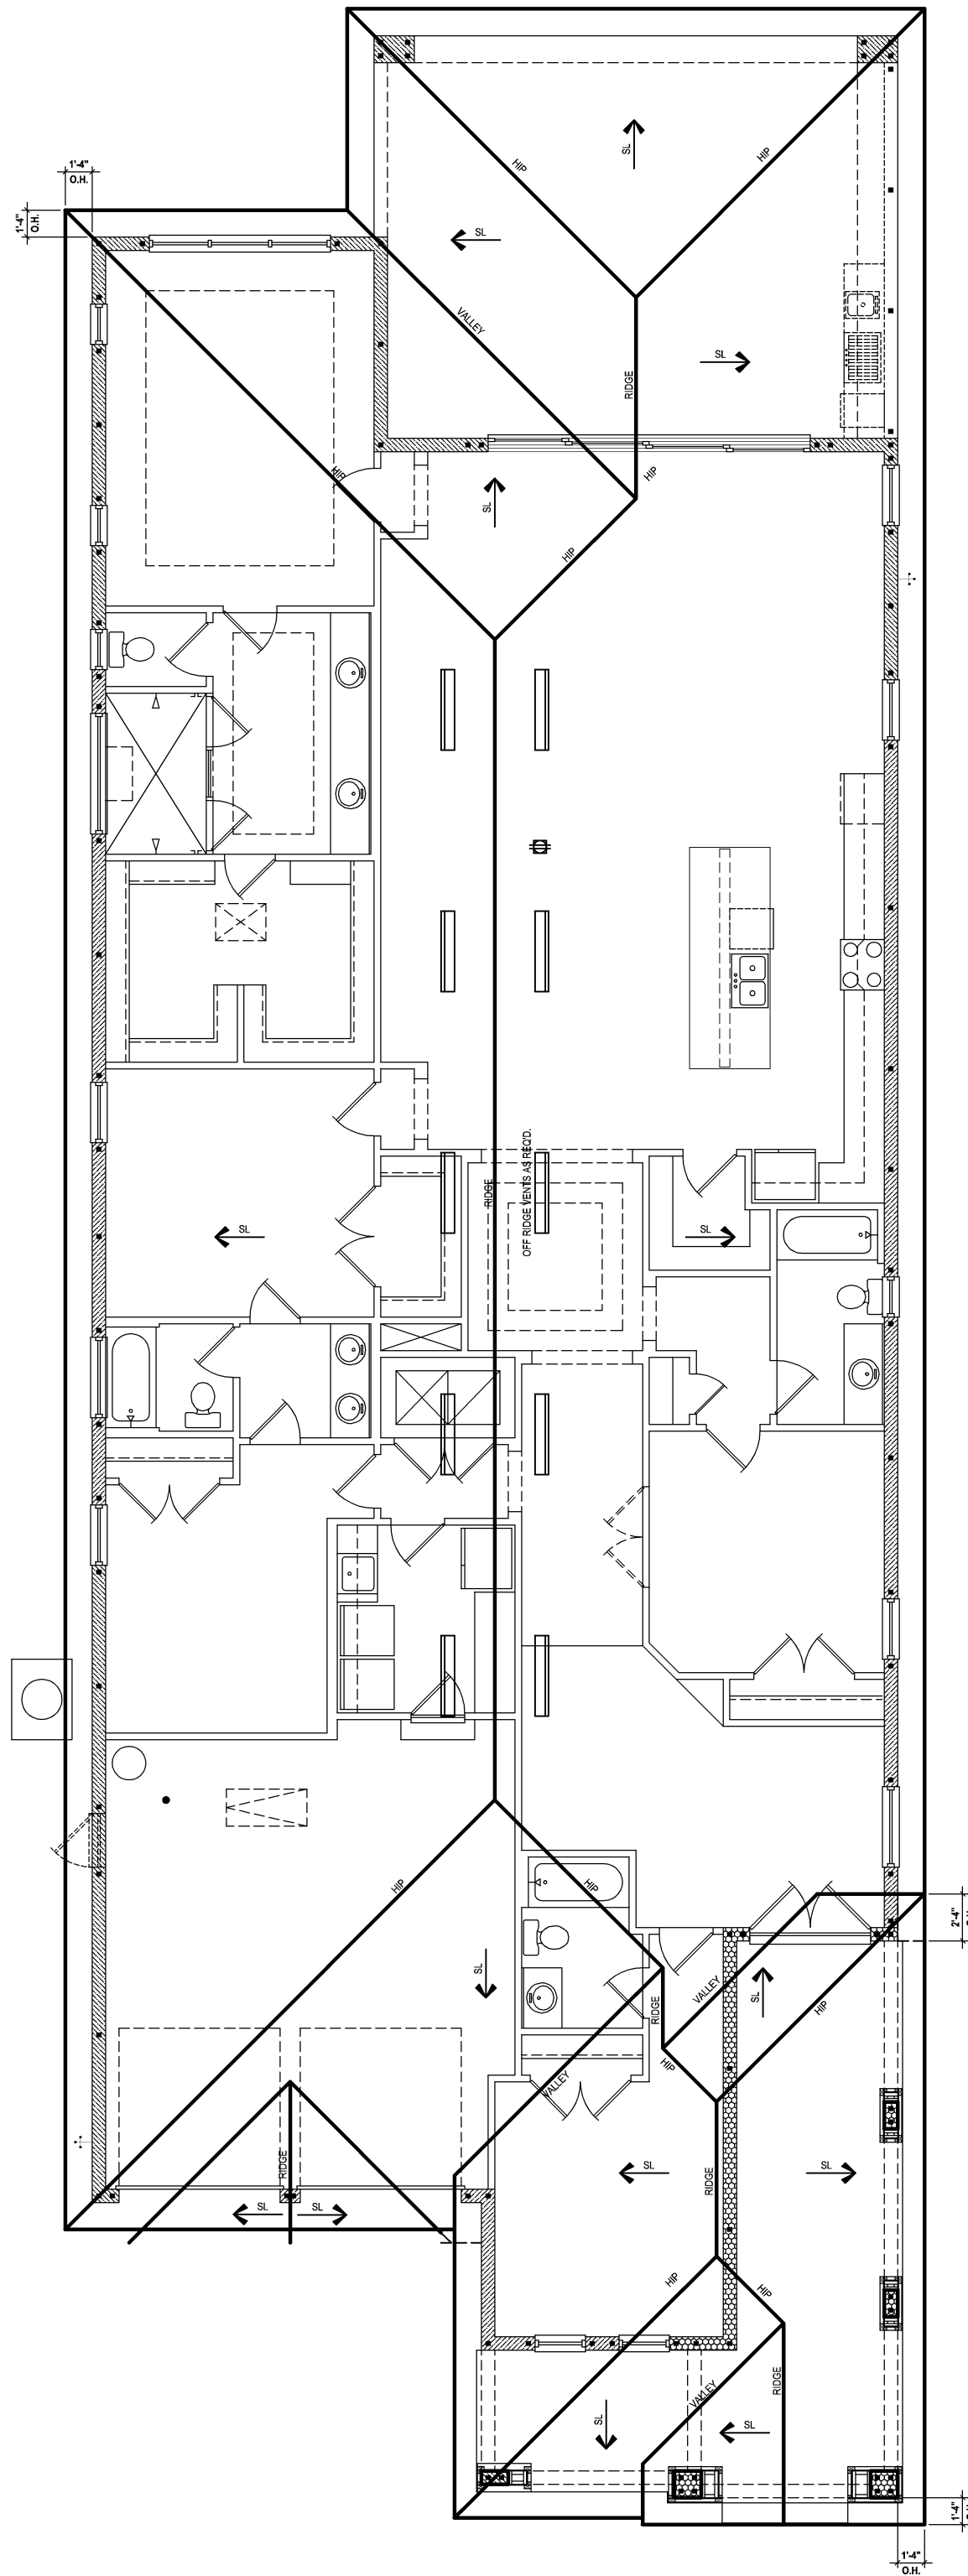

Roof Layout

(Standard)

SCALE: 1/16" = 1'-0" (11x17) 1/8" = 1'-0" (22x34)

ATTIC VENT CALC'S:

2017 FLORIDA BUILDING CODE (6TH EDITION) SECTION R806  
MIN. 40% - MAX 50% OF REQUIRED VENTILATION TO BE IN  
UPPER PORTION OF ATTIC SPACE AND THE BALANCE TO BE  
IN LOWER PORTION (EAVES).  
(OFF-RIDGE VENT MAXIMUM OPENING SIZES)

MINIMUM NET VENTILATION AREA SHALL BE 1/150 OF VENTED  
SPACE.


TOTAL VENTED SPACE: 4,842 = 16.14 SF. NET FREE  
300 REQUIRED

UPPER PORTION VENTILATION TOTAL: 6,456 SF.  
TO BE PROVIDED W/ OFF RIDGE VENTS:  
10 VENTS @ .683 /PER VENT

TILE: O'HAGIN MODEL "S", SHINGLE: LOMANCO 770-D).


LOWER PORTION VENTILATION TOTAL: 9,684 SF.  
TO BE PROVIDED W/ SOFFITS @ EAVE:  
90.00 LF. @ 0.121 SF. VENTING/LF.

UPPER ROOF PERCENTAGE: 40%  
LOWER ROOF PERCENTAGE: 60%

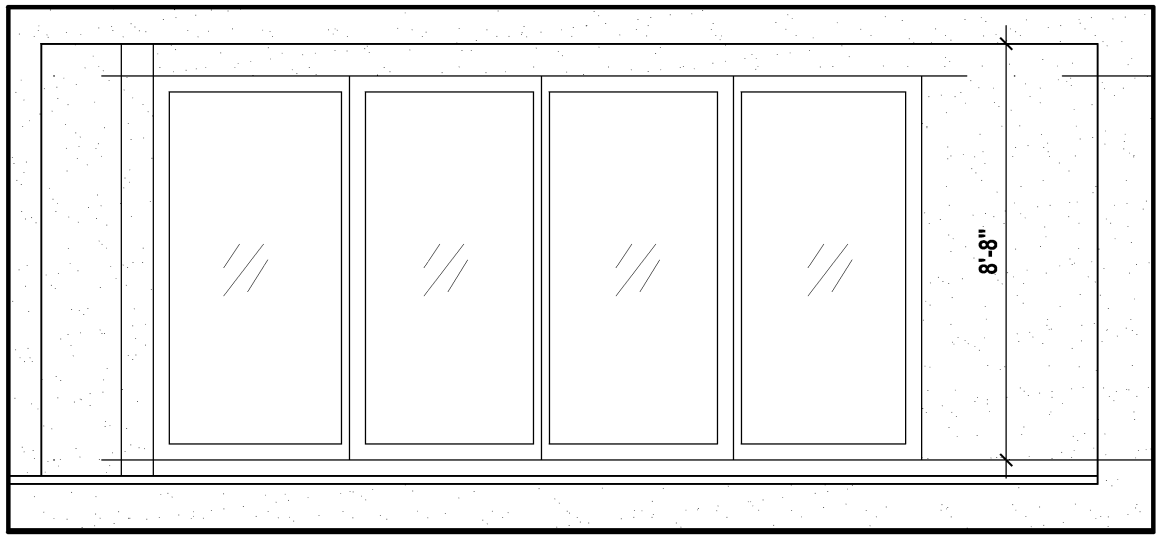


Rear Elevation  
(Opt. Pocket SGD Dr.)

SCALE: 1/8" = 1'-0" (12x18) 1/4" = 1'-0" (24x36)

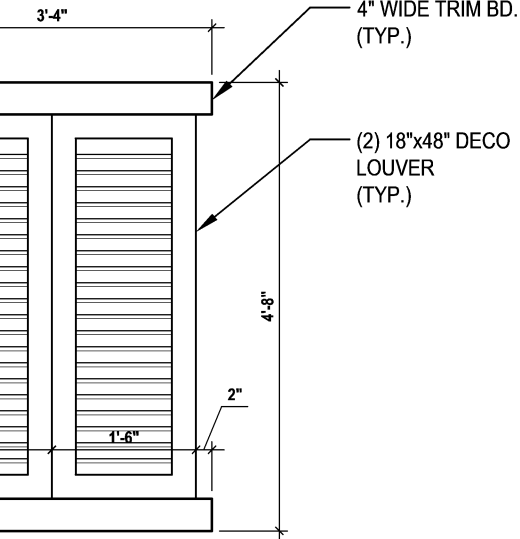


Detail #2

SCALE: 1/2" = 1'-0" (12x18) 1" = 1'-0" (24x36)

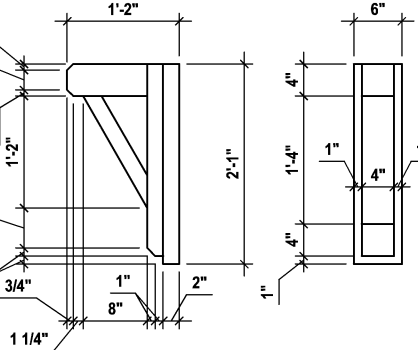


Detail #1

SCALE: 1/2" = 1'-0" (12x18) 1" = 1'-0" (24x36)

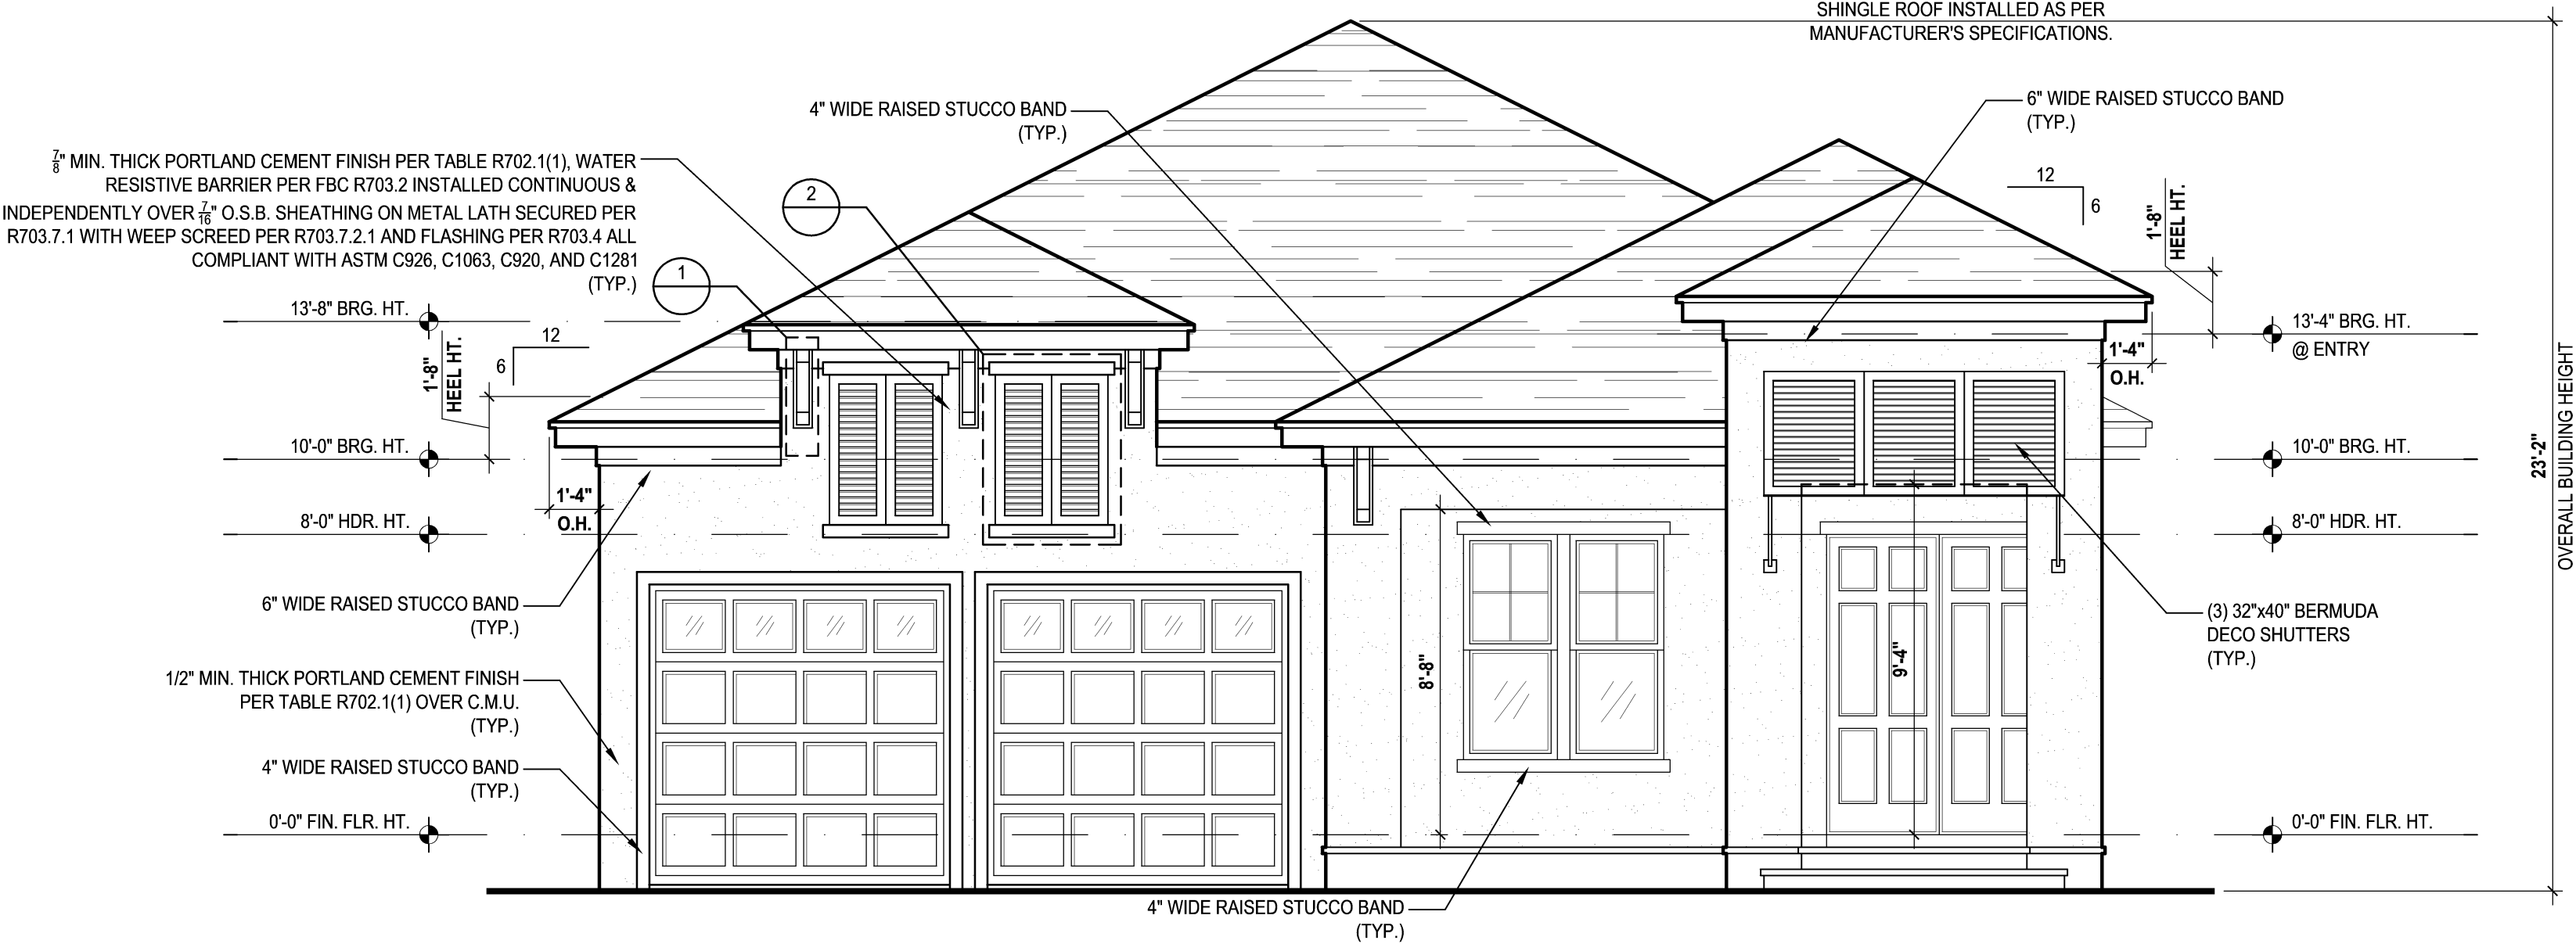


Front Elevation "C"  
(Standard)

SCALE: 1/8" = 1'-0" (12x18) 1/4" = 1'-0" (24x36)

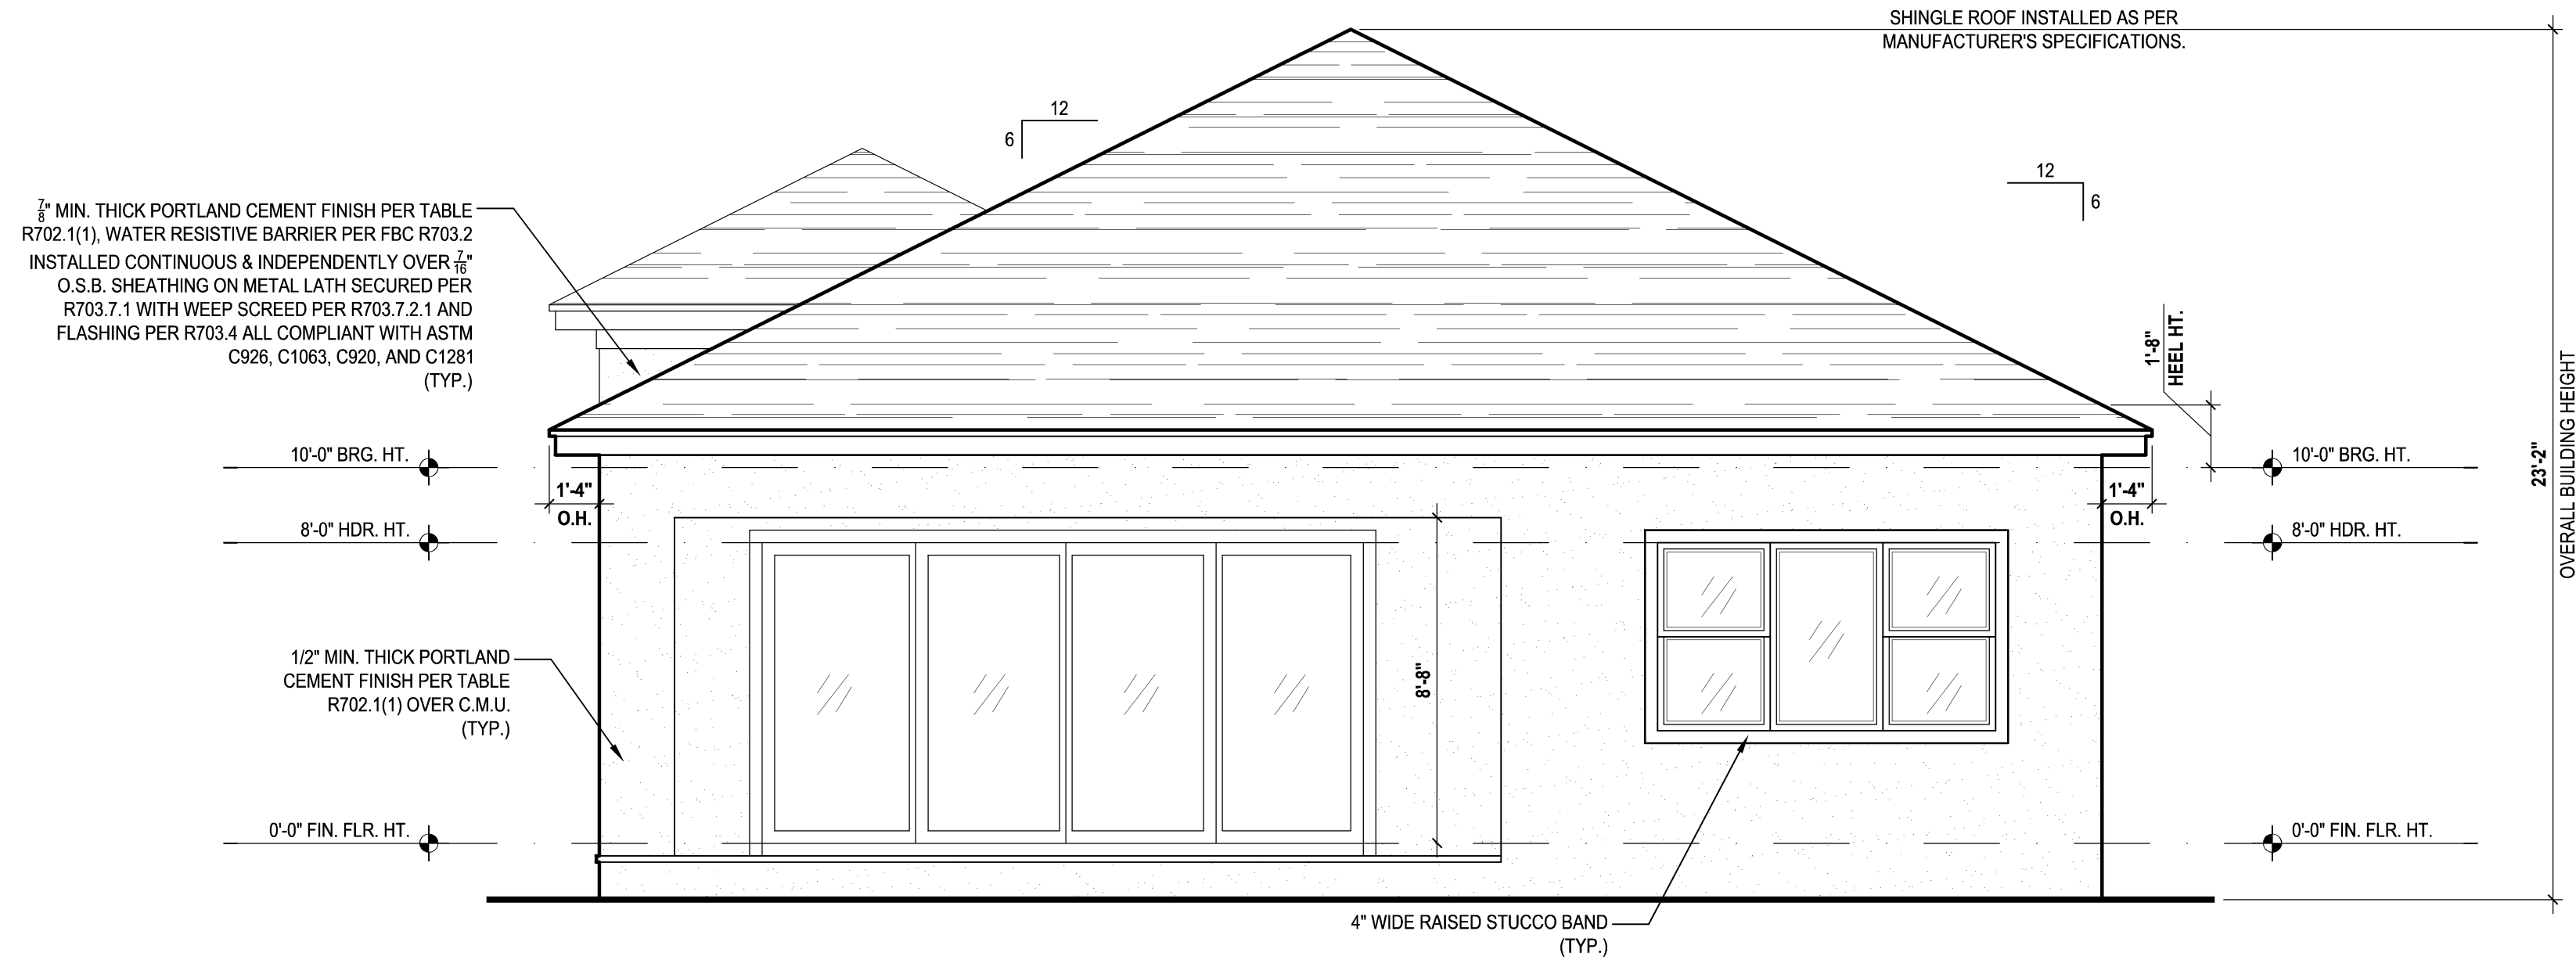

Rear Elevation "C"  
(Standard)

SCALE: 1/8" = 1'-0" (12x18) 1/4" = 1'-0" (24x36)

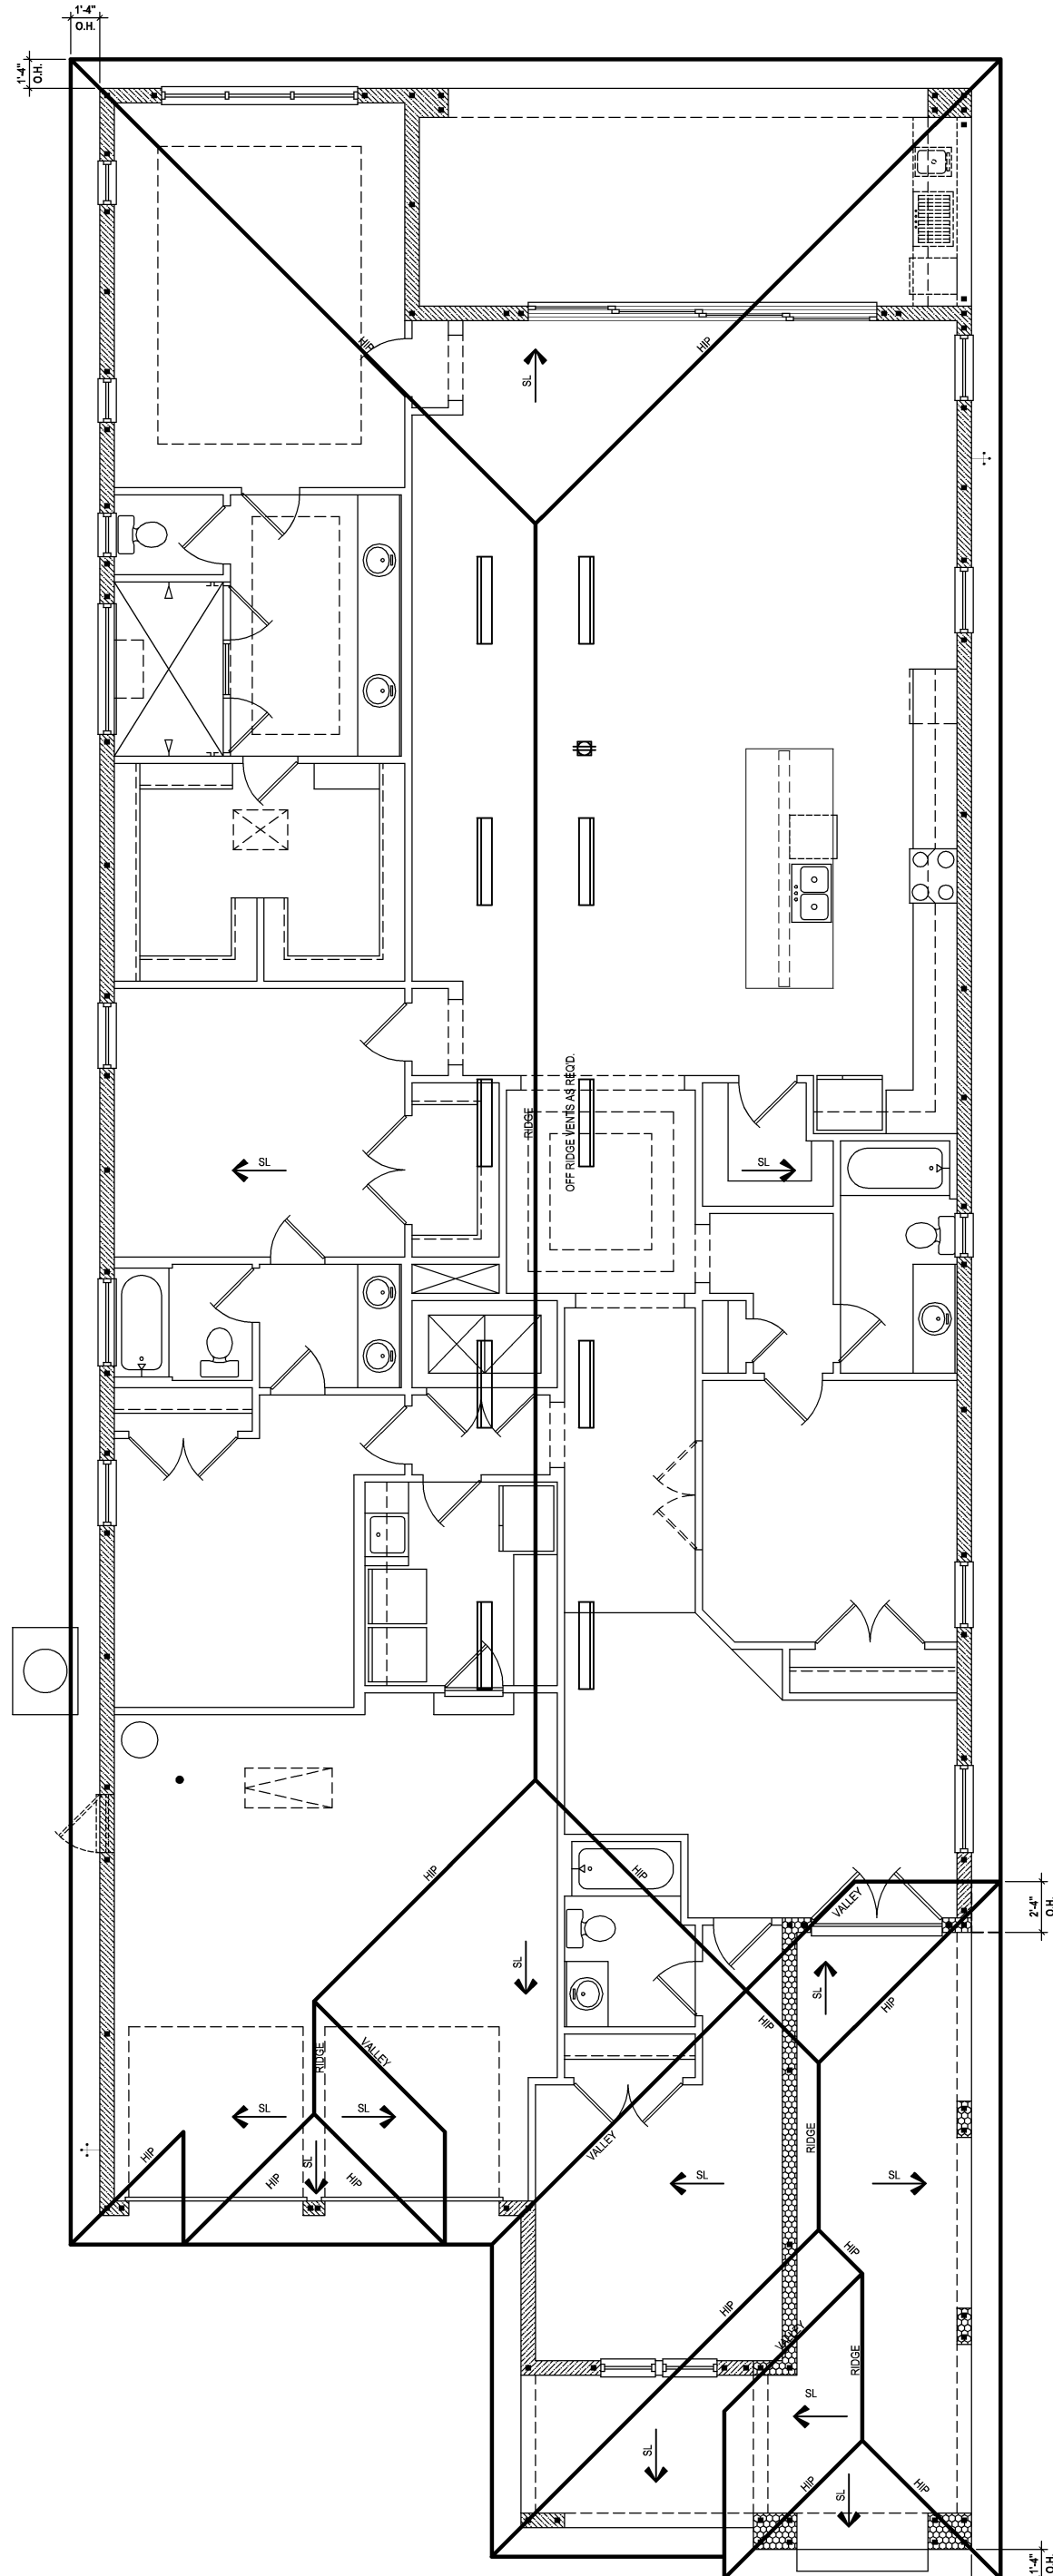


Roof Layout  
(Standard)

SCALE: 1/16" = 1'-0" (11x17) 1/8" = 1'-0" (22x34)

ATTIC VENT CALC'S:


2017 FLORIDA BUILDING CODE (6TH EDITION) SECTION R806  
MIN. 40% - MAX 50% OF REQUIRED VENTILATION TO BE IN UPPER PORTION OF ATTIC SPACE AND THE BALANCE TO BE IN LOWER PORTION (EAVES).  
(OFF-RIDGE VENT MAXIMUM OPENING SIZES)  
MINIMUM NET VENTILATION AREA SHALL BE 1/160 OF VENTED SPACE.  
TOTAL VENTED SPACE: 4,842 = 16.14 SF. NET FREE REQUIRED 300  
UPPER PORTION VENTILATION TOTAL: 6,456 SF.  
TO BE PROVIDED w/ OFF RIDGE VENTS: 10 VENTS @ .683 /PER VENT  
TILE: O'HAGIN MODEL "S", SHINGLE: LOMANCO 770-D).  
LOWER PORTION VENTILATION TOTAL: 9,684 SF.  
TO BE PROVIDED w/ SOFFITS @ EAVE: 90.00 LF. @ 0.121 SF. VENTING/LF.  
UPPER ROOF PERCENTAGE: 40%  
LOWER ROOF PERCENTAGE: 60%

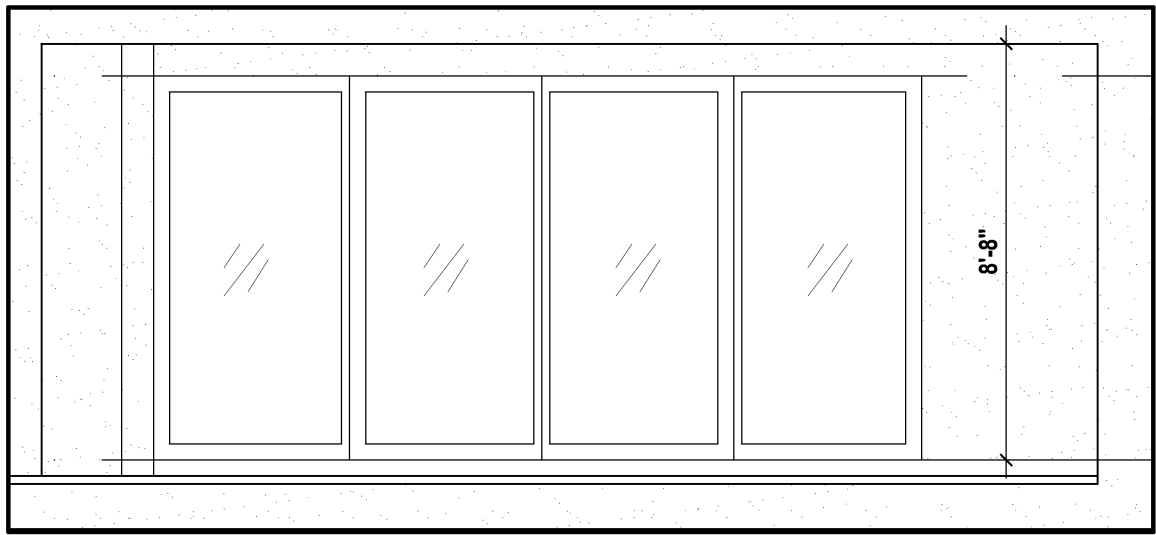

Rear Elevation


(Opt. Pocket SGD Dr.)

SCALE: 1/8" = 1'-0" (12x18) 1/4" = 1'-0" (24x36)

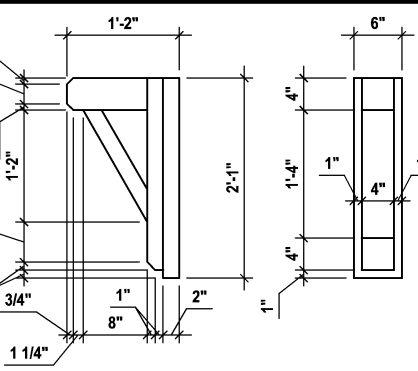

Detail #1

SCALE: 1/2" = 1'-0" (12x18) 1" = 1'-0" (24x36)

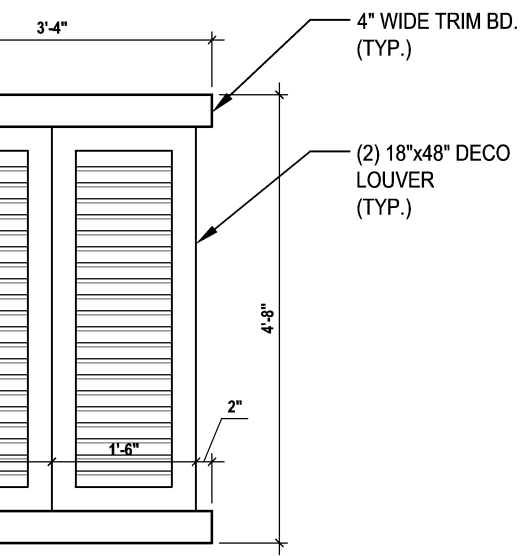

Detail #2


SCALE: 1/2" = 1'-0" (12x18) 1" = 1'-0" (24x36)



Front Elevation "C"

(Opt. Sitting Rm.)


SCALE: 1/8" = 1'-0" (12x18) 1/4" = 1'-0" (24x36)

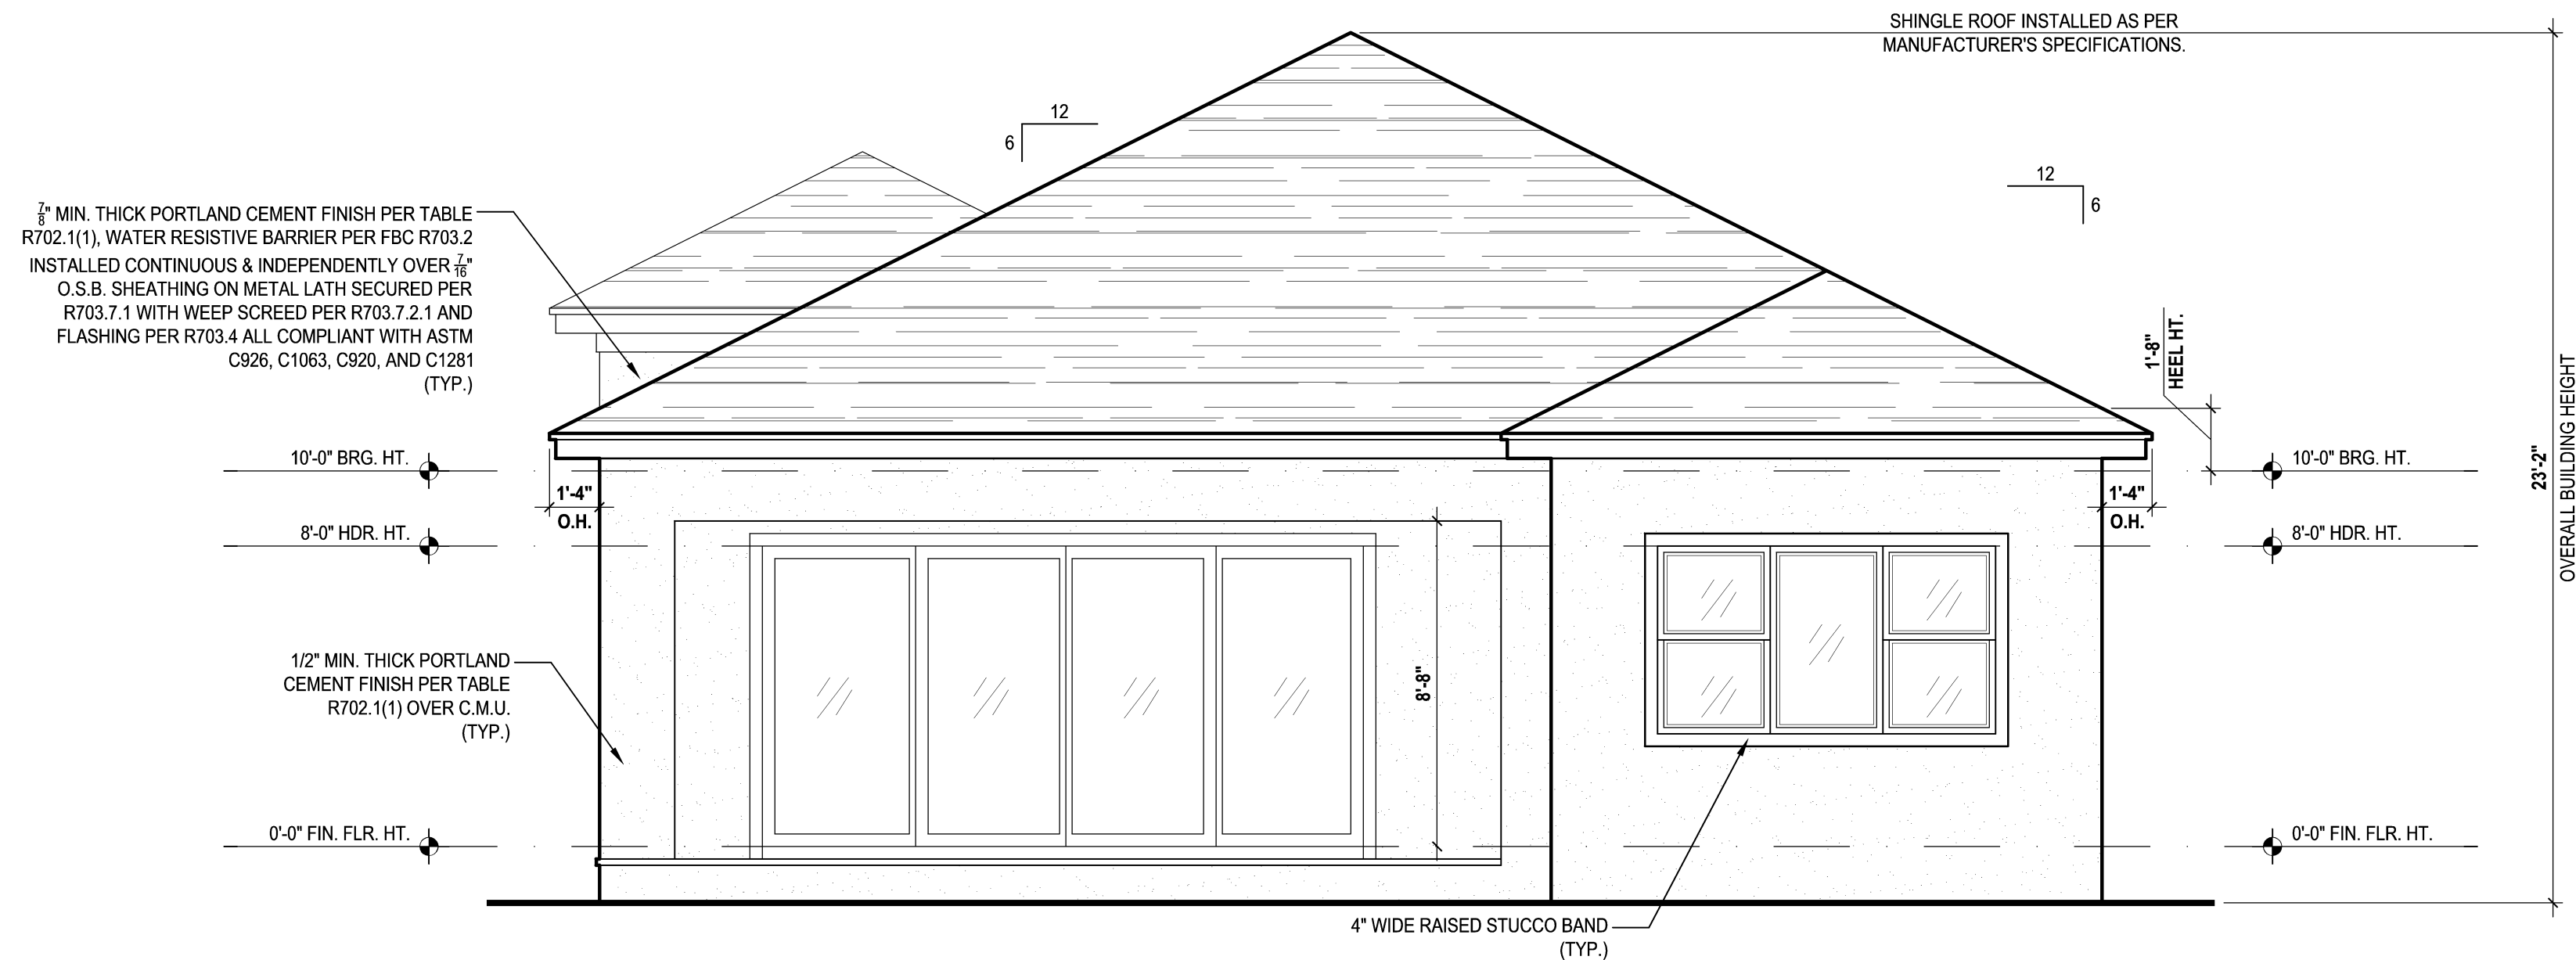

Rear Elevation "C"

(Opt. Sitting Rm.)

SCALE: 1/8" = 1'-0" (12x18) 1/4" = 1'-0" (24x36)

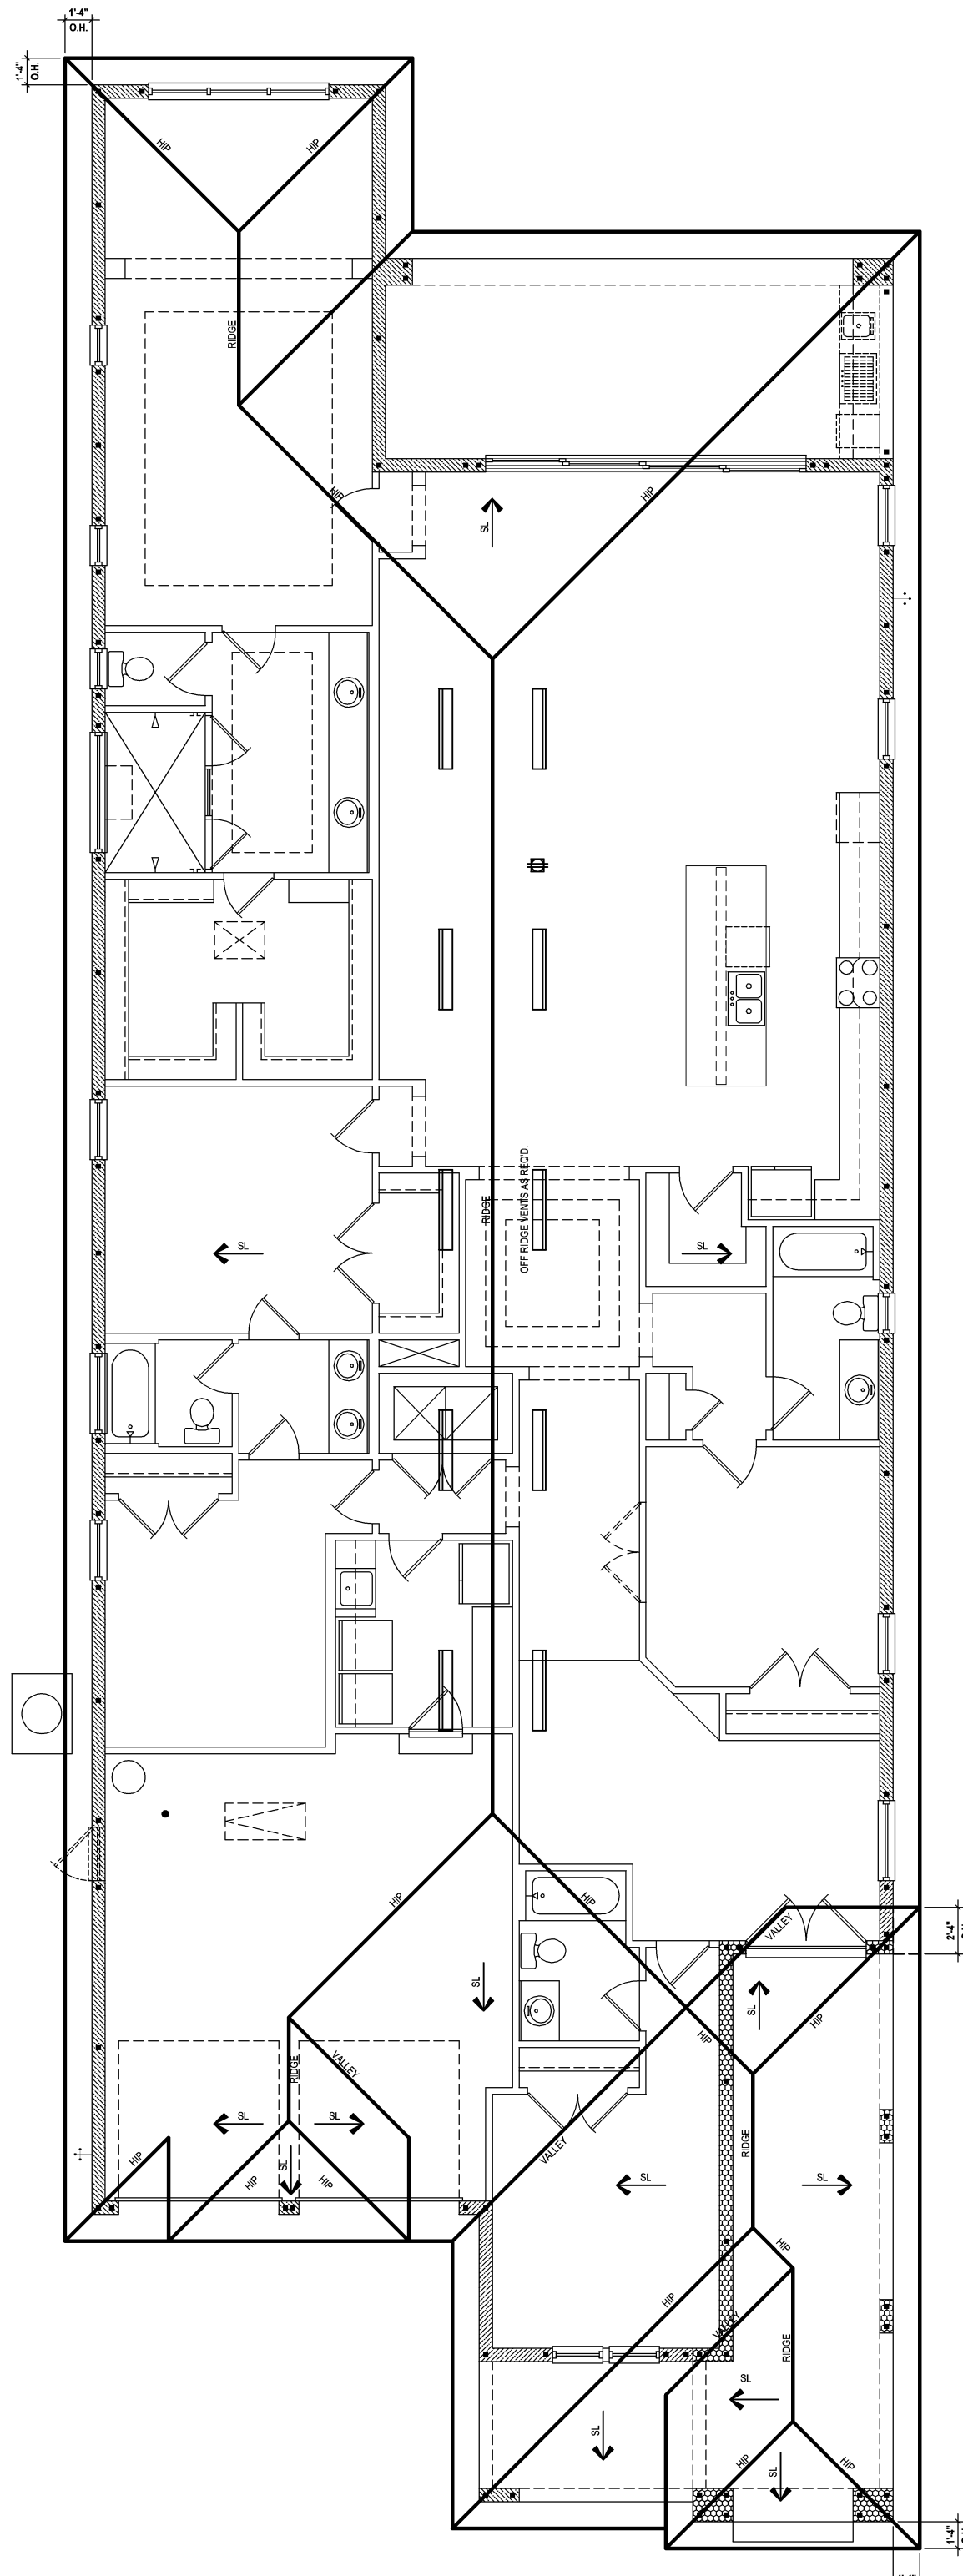

Roof Layout

(Opt. Sitting Rm.)

SCALE: 1/16" = 1'-0" (11x17) 1/8" = 1'-0" (22x34)

ATTIC VENT CALC'S:

2017 FLORIDA BUILDING CODE (6TH EDITION) SECTION R806  
MIN. 40% - MAX 50% OF REQUIRED VENTILATION TO BE IN  
UPPER PORTION OF ATTIC SPACE AND THE BALANCE TO BE  
IN LOWER PORTION (EAVES).  
(OFF-RIDGE VENT MAXIMUM OPENING SIZES)

MINIMUM NET VENTILATION AREA SHALL BE 1/150 OF VENTED  
SPACE.


TOTAL VENTED SPACE: 4,842 = 16.14 SF. NET FREE  
300 REQUIRED

UPPER PORTION VENTILATION TOTAL: 6,456 SF.  
TO BE PROVIDED w/ OFF RIDGE VENTS:  
10 VENTS @ .683 /PER VENT

TILE: O'HAGIN MODEL "S", SHINGLE: LOMANCO 770-D).


LOWER PORTION VENTILATION TOTAL: 9,684 SF.  
TO BE PROVIDED w/ SOFFITS @ EAVE:  
90.00 LF. @ 0.121 SF. VENTING/LF.

UPPER ROOF PERCENTAGE: 40%  
LOWER ROOF PERCENTAGE: 60%

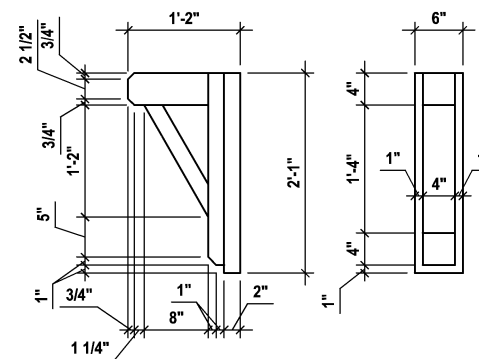


## Detail #1

SCALE: 1/2" = 1'-0" (12x18) 1" = 1'-0" (24x36)

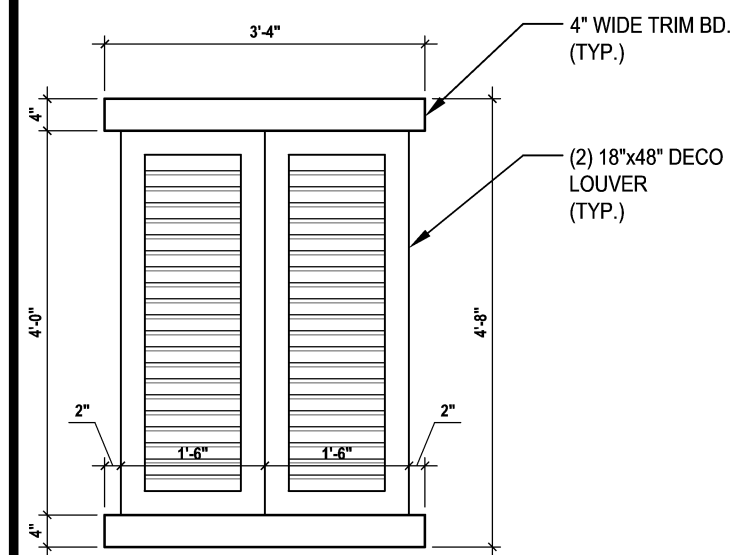

## Detail #2


SCALE: 1/2" = 1'-0" (12x18) 1" = 1'-0" (24x36)

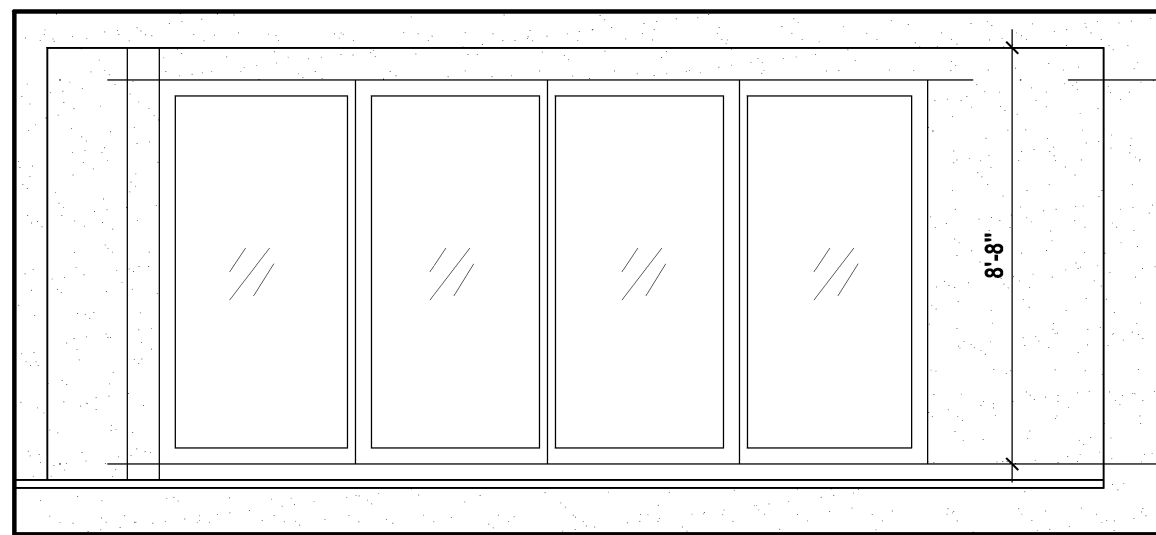

## Rear Elevation

(Opt. Pocket SGD Dr.)


SCALE: 1/8" = 1'-0" (12x18) 1/4" = 1'-0" (24x36)

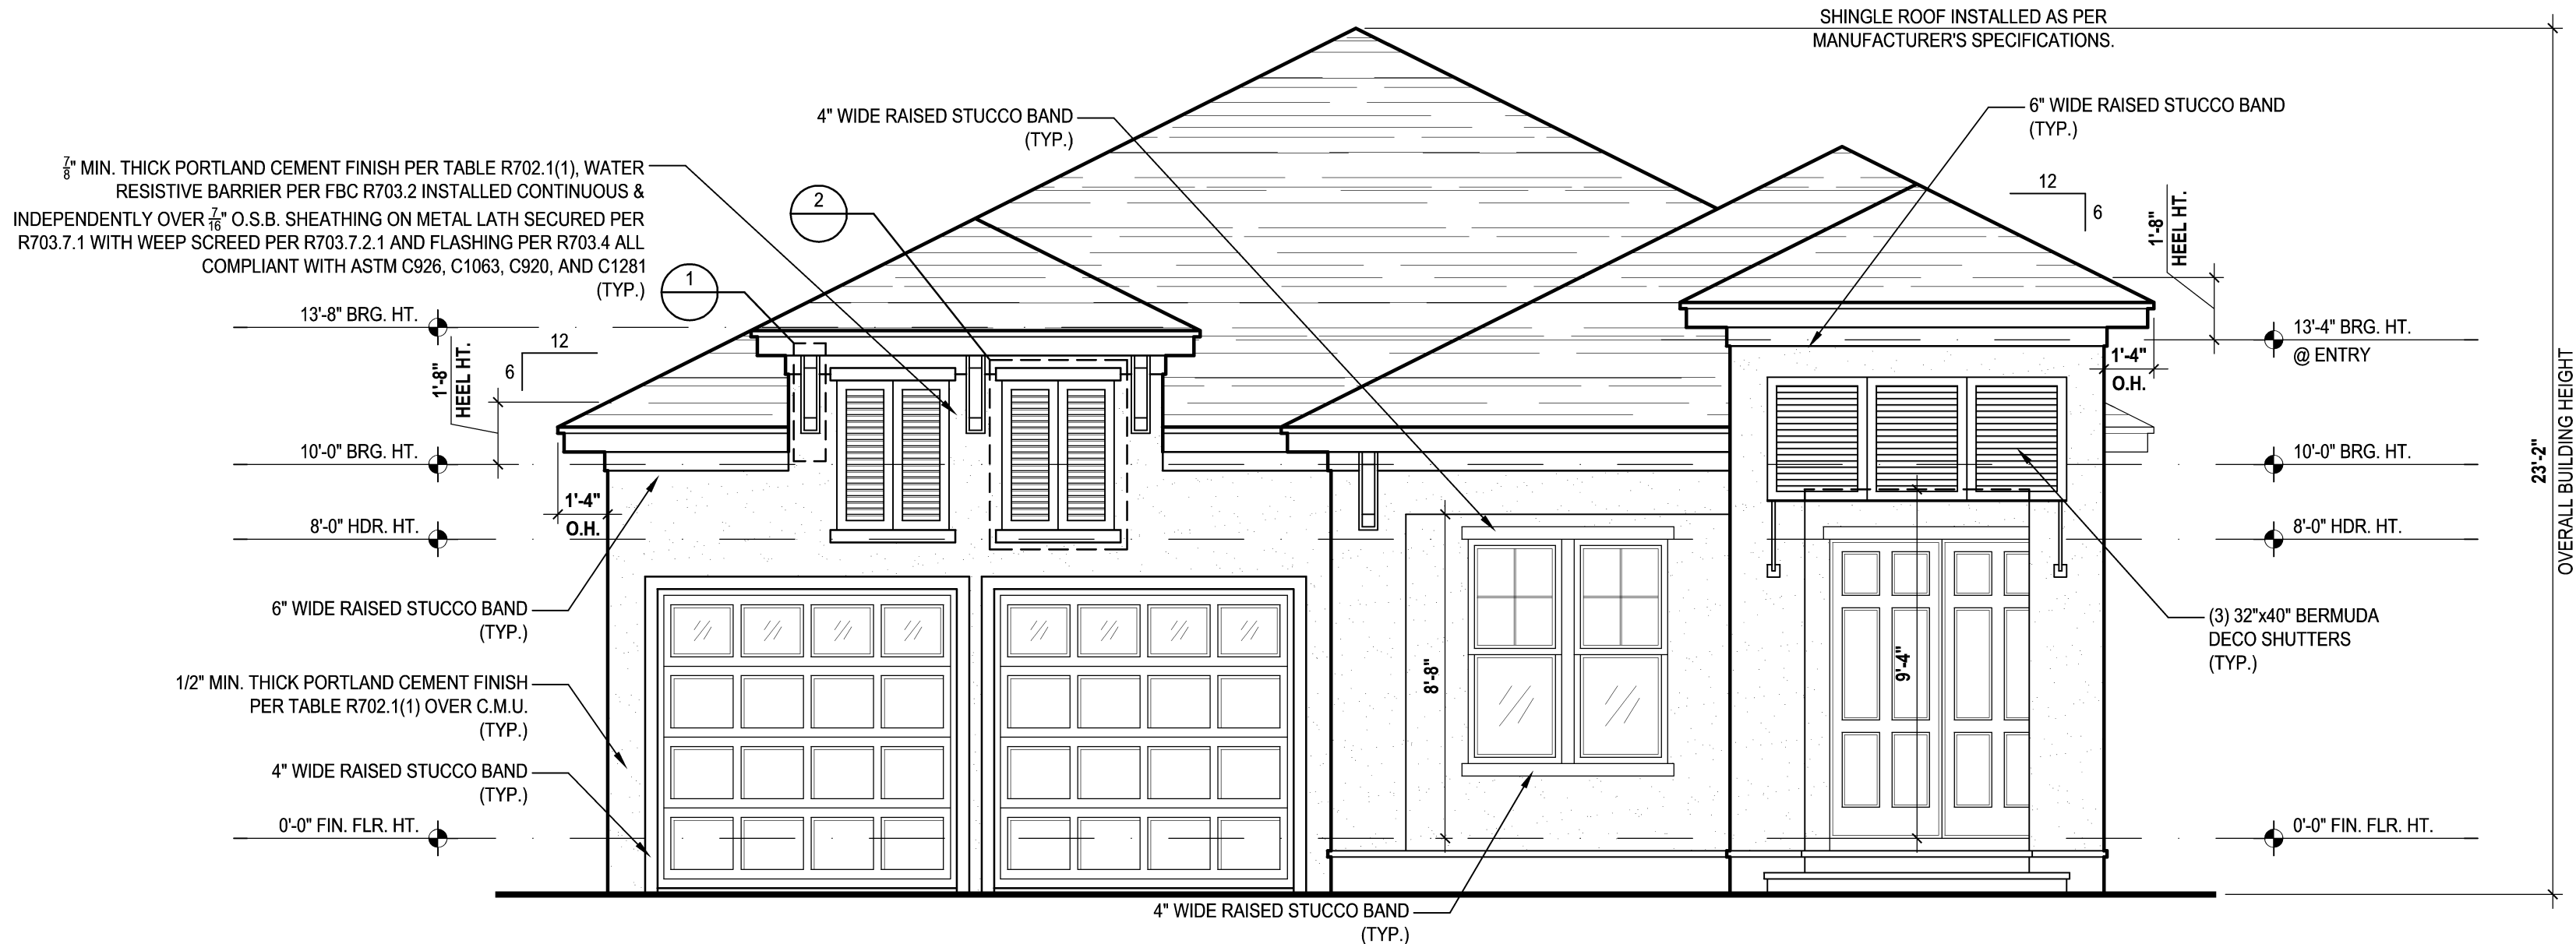

### Front Elevation "C"

(Opt. Extended Lanai)


SCALE: 1/8" = 1'-0" (12x18) 1/4" = 1'-0" (24x36)

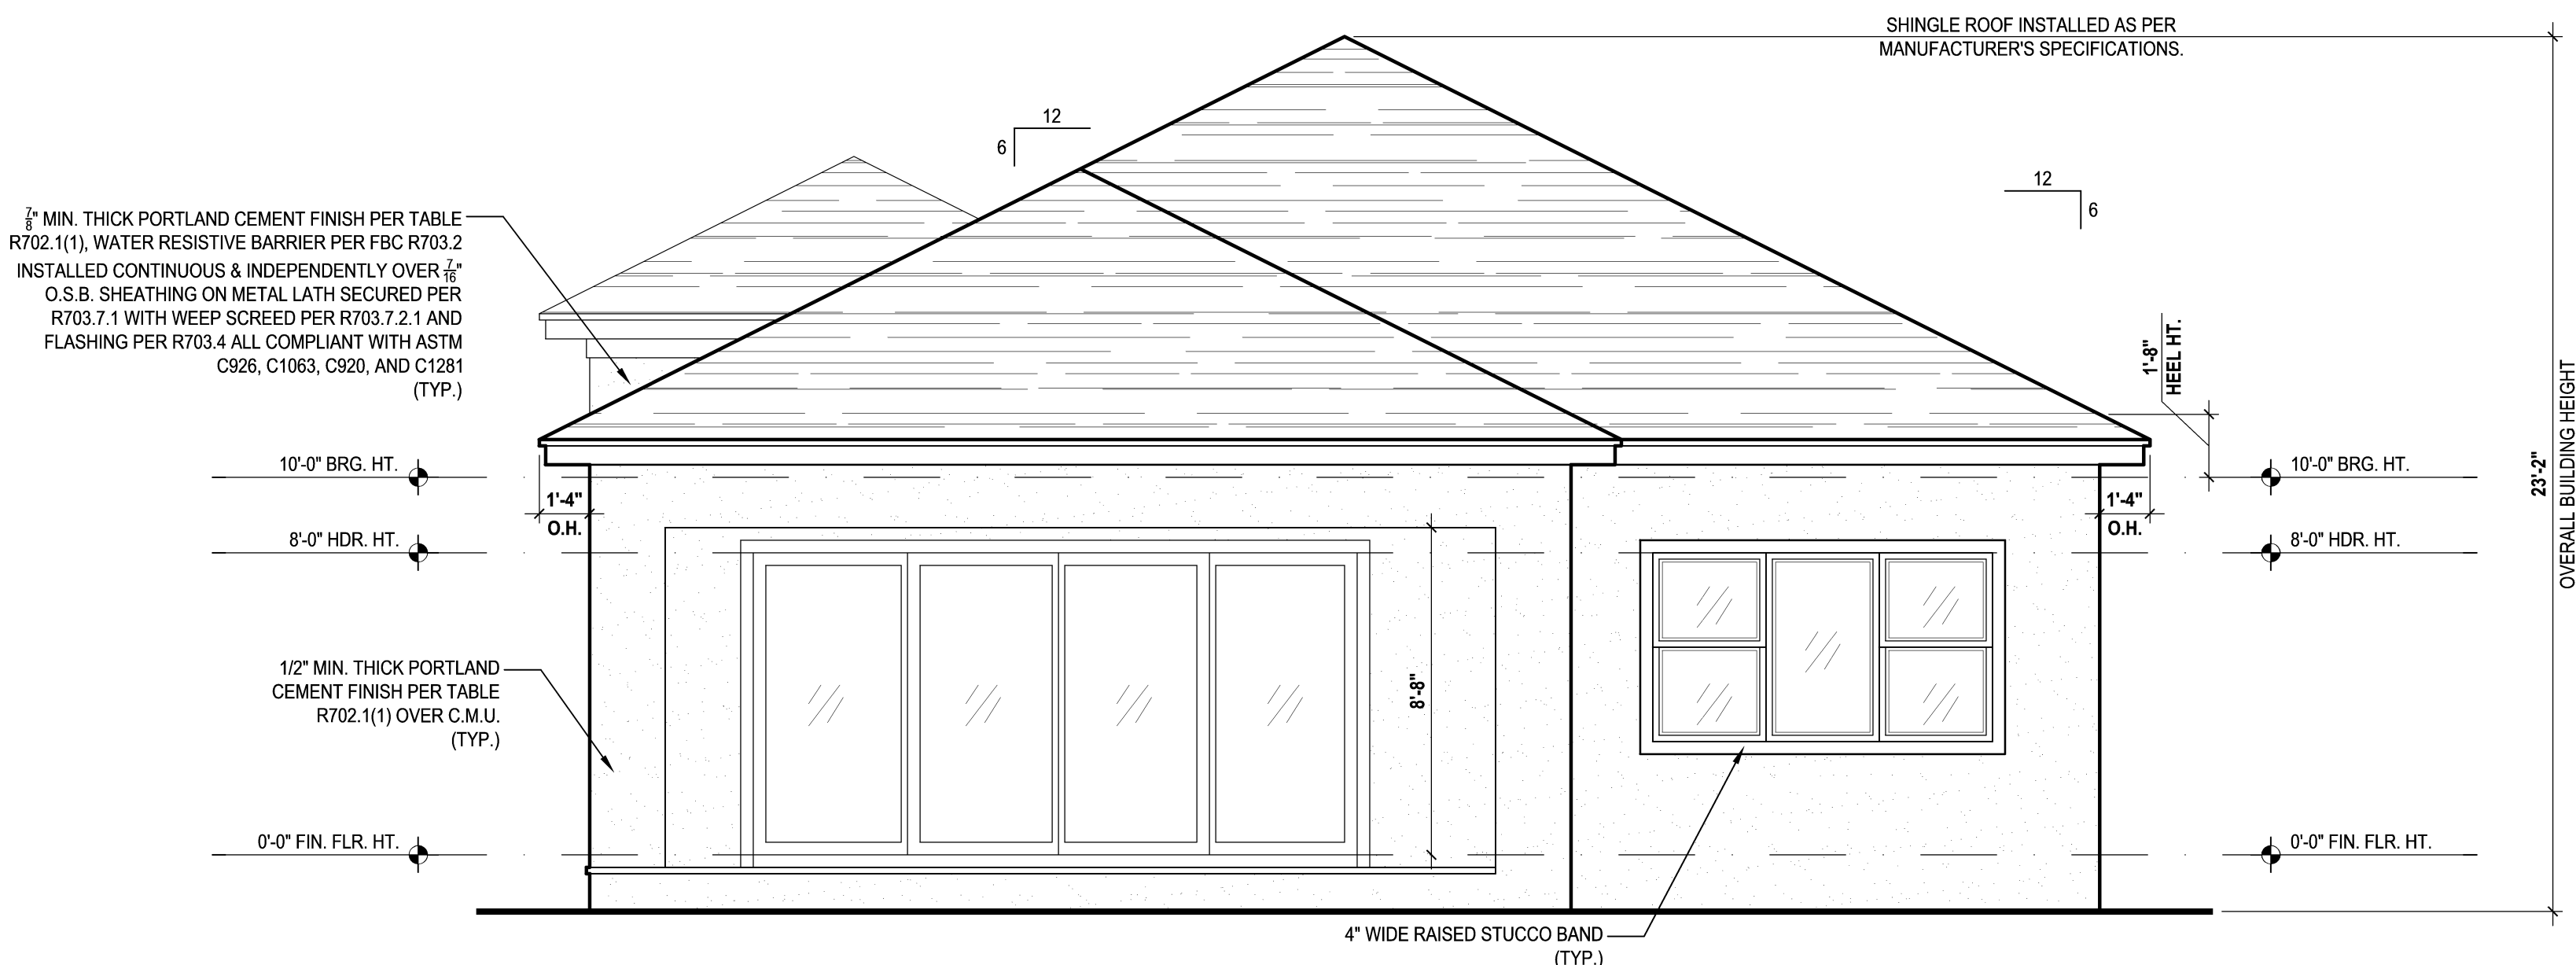

## Rear Elevation "C"

(Opt. Extended Lanai)

SCALE: 1/8" = 1'-0" (12x18) 1/4" = 1'-0" (24x36)

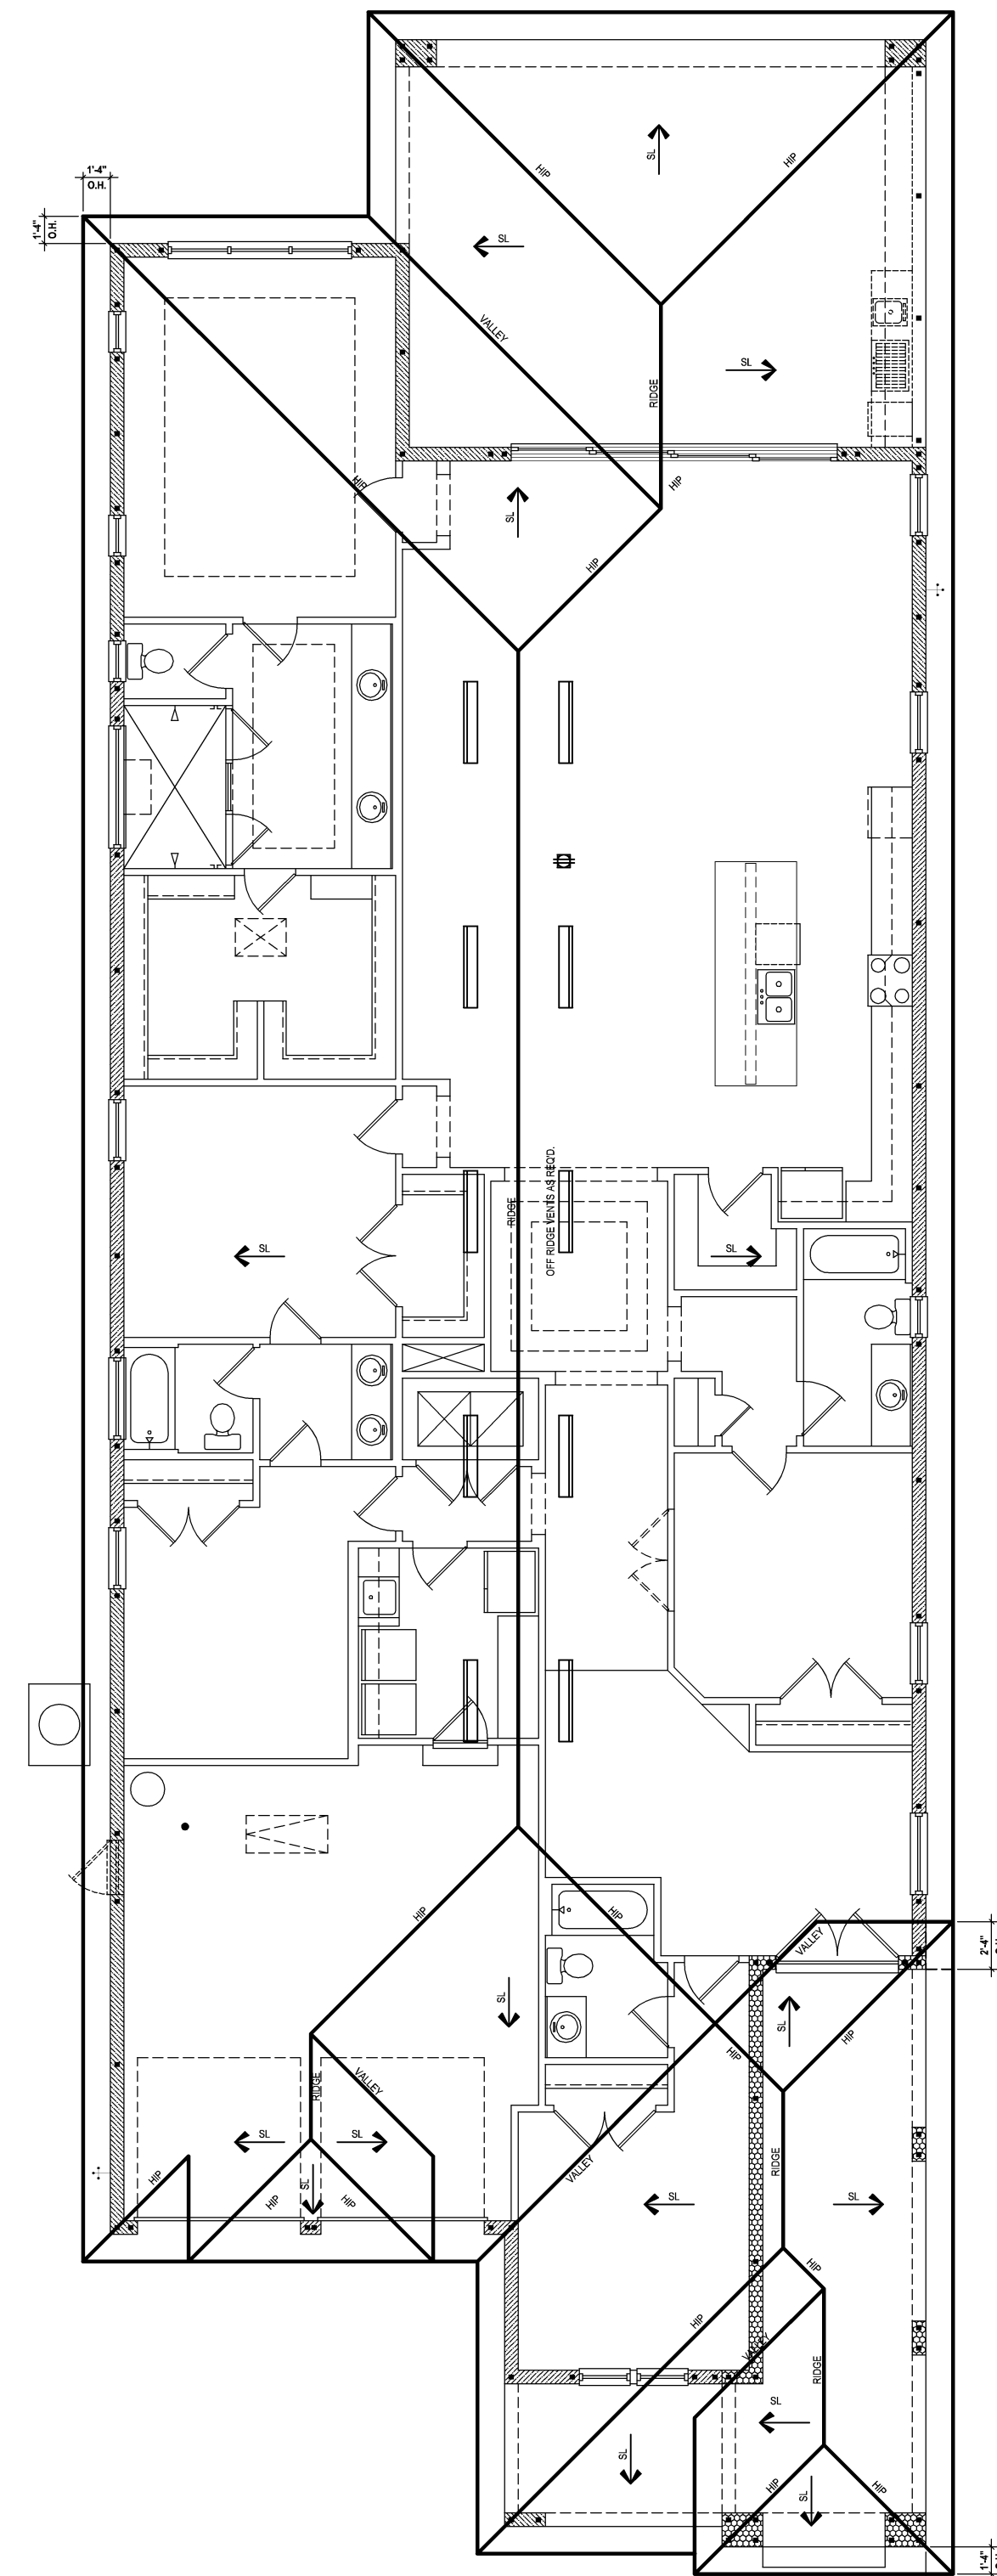

## Roof Layout

(Standard)

SCALE: 1/16" = 1'-0" (11x17) 1/8" = 1'-0" (22x34)

# ATTIC VENT CALC'S:

2017 FLORIDA BUILDING CODE (16TH EDITION) SECTION R905  
MIN. 40% - MAX. 50% OF REQUIRED VENTILATION TO BE  
IN UPPER PORTION OF ATTIC SPACE AND THE BALANCE TO BE  
IN LOWER PORTION (EAVES).  
(OFF-RIDGE VENT MAXIMUM OPENING SIZES)

MINIMUM NET VENTILATION AREA SHALL BE  $\frac{1}{16}$  OF VENTED  
SPACE.


TOTAL VENTED SPACE:  $4.842 = \frac{16.14 \text{ SF.}}{300}$  NET FREE  
REQUIRED


UPPER PORTION VENTILATION TOTAL: 6.548 SF.  
TO BE PROVIDED w/ OFF RIDGE VENTS:  
10 VENTS @ .683/PER VENT

TILE: O'HAGIN MODEL S/L. SHINGLE: LOMANCO 770-D).

LOWER PORTION VENTILATION TOTAL: 0.684 SF.  
TO BE PROVIDED w/ SOFFITS @ EAVE:  
80.00 LF @ 0.121 SF. VENTING/LF.


UPPER ROOF PERCENTAGE: 40%  
LOWER ROOF PERCENTAGE: 60%

<p><b>A division of Park Square Enterprises Inc.</b></p> <p><b>5200 Vineland Rd. Suite #200</b></p> <p><b>Oriando, FL 32811</b></p> <p><b>Phone: (407) 529-3000</b></p>		<p><b>40-3164</b></p>		<p><b>DORCHESTER</b></p>		<p><b>MJS</b></p> <p>Custom home design DESIGNERS - PLANNERS    <b>www.mjshomedesigns.com</b></p>		<p><b>815 Orienta Ave. Suite# 1040</b> <b>Altamonte Springs, FL. 32701</b> <b>Ph: (407) 629-6711</b> <b>Fax: (407) 629-6776</b></p>		 <p><b>PREMIER</b> STRUCTURAL ENGINEERING INC. FL PER #: 60239</p>		<p><b>235 Maitland Avenue S.</b> <b>Suite 108-A</b> <b>Maitland, FL. 32751</b> <b>Ph: (407) 227-7416</b> <b>www.premier-structural.com</b> <b>FL CERT. AUTH.: 28113</b></p>	
<p><b>Park Square HOMES</b></p>				<p><b>Street Address</b></p>		<p><b>Lot Info</b></p>		<p><b>City, State, Zip</b></p>		<p><b>WRITTEN DIMENSIONS SHALL HAVE PRECEDENCE OVER SCALE DIMENSIONS.</b> Contractors shall verify and be responsible for dimensions and conditions of the job and M.J.S., Inc. must be notified in writing of any changes to the dimensions, conditions and specifications appearing on these plans.</p>		<p>When plans have been electronically signed &amp; sealed by your Signature, you are deemed to have accepted the terms of this document as not considered signed &amp; sealed. Signatures must be verified on any electronic copies.</p>	
<p><b>ISSUE DATE:</b> 00/00/0000</p>													
<p><b>REVISIONS</b></p>													
<p><b>PROJECT:</b> 00-0000</p>													
<p><b>SCALE:</b> AS NOTED</p>													
<p><b>DRAWN BY:</b> C.C.</p>													
<p><b>DESIGNED BY:</b> MUS</p>													
<p><b>ELEVATIONS "C"</b></p>													
<p><b>04.C2</b></p>													

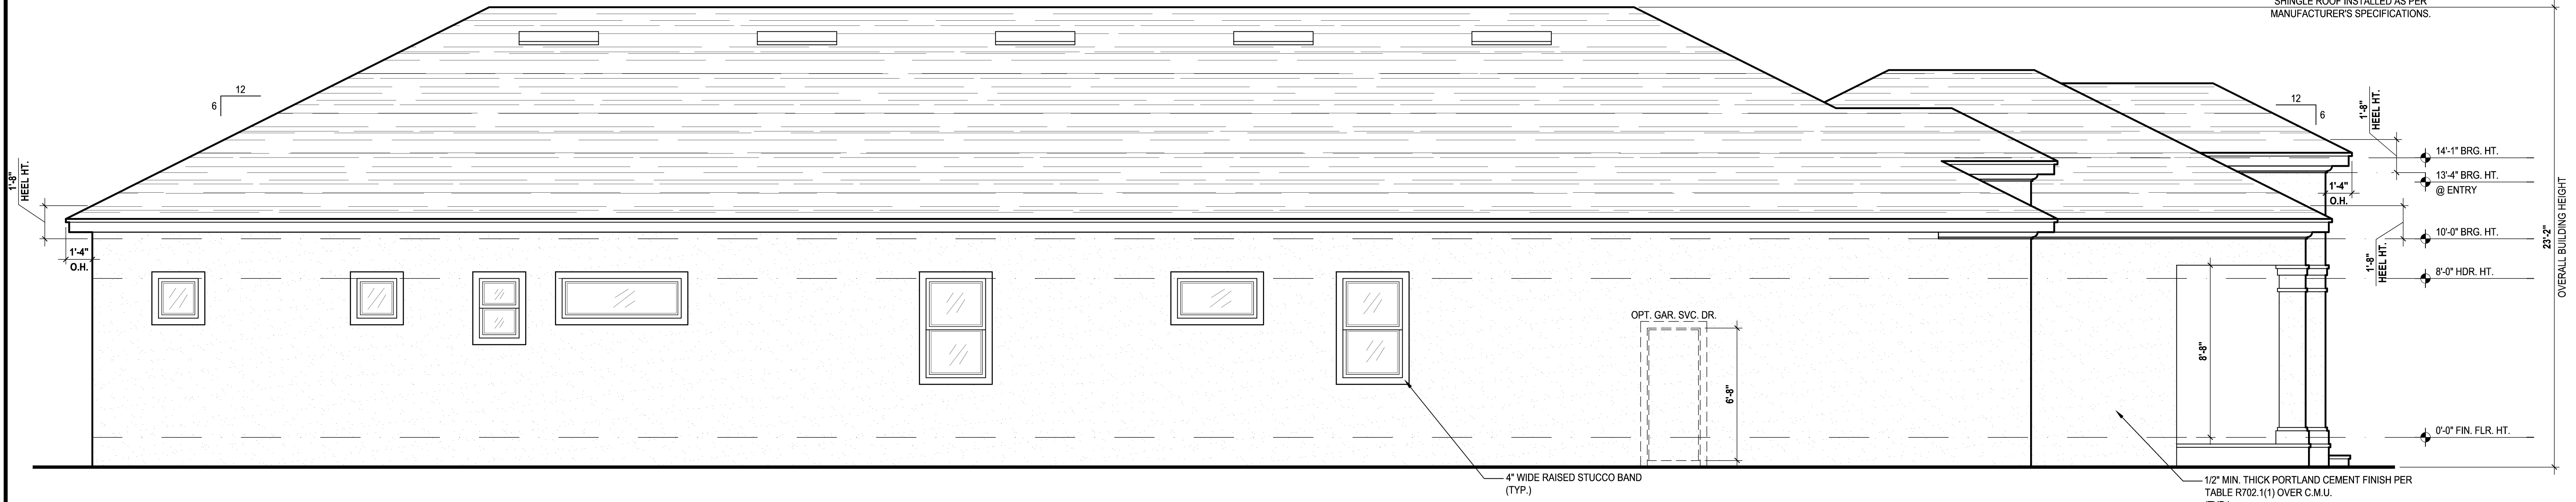


Left Elevation "A"  
(Standard)

SCALE 1/8" = 1'-0" (12x18) 1/4" = 1'-0" (24x36)

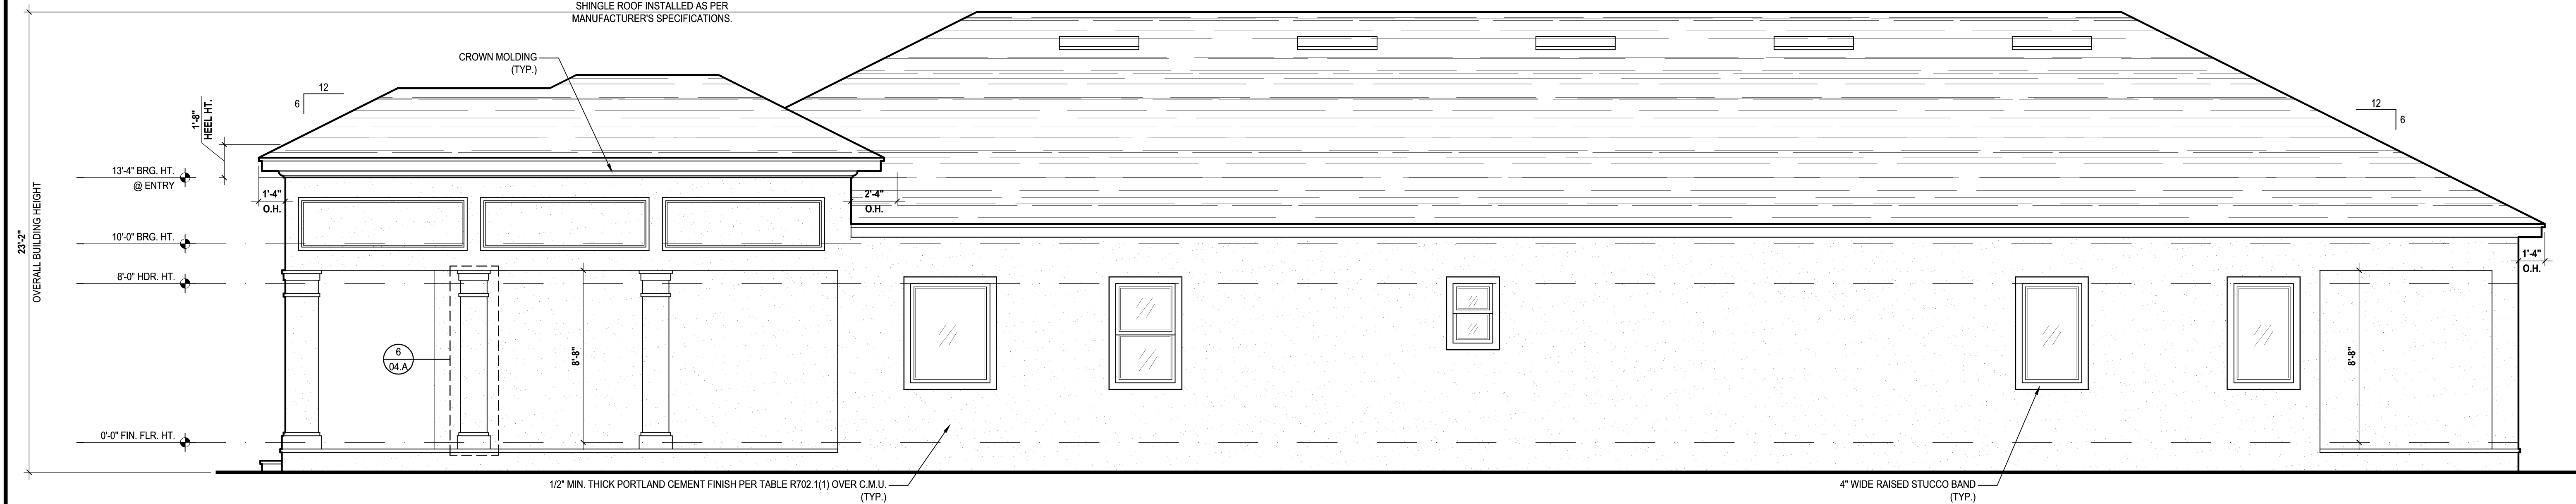

Right Elevation "A"  
(Standard)

SCALE 1/8" = 1'-0" (12x18) 1/4" = 1'-0" (24x36)

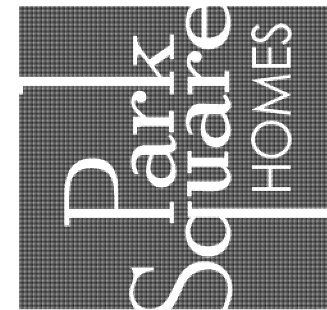


A division of Park Square  
Enterprises Inc.  
5200 Vineland Rd., Suite #200  
Orlando, FL 32811  
Phone: (407) 528-3000

40-3164  
DORCHESTER  
Street Address  
Lot Info  
City, State, Zip

**MJS**  
815 Orienta Ave, Suite# 1040  
Altamonte Springs, FL 32701  
Ph: (407) 629-6711  
Fax: (407) 629-6776  
CUSTOM HOME DESIGN  
DESIGNERS - PLANNERS  
www.mjshomedesigns.com




235 Maitland Avenue S.  
Suite 108-A  
Maitland, FL 32751  
Ph: (407) 227-7416  
www.premier-structural.com  
FL CERT. AUTH.: 28113  
FL PER#: 80289

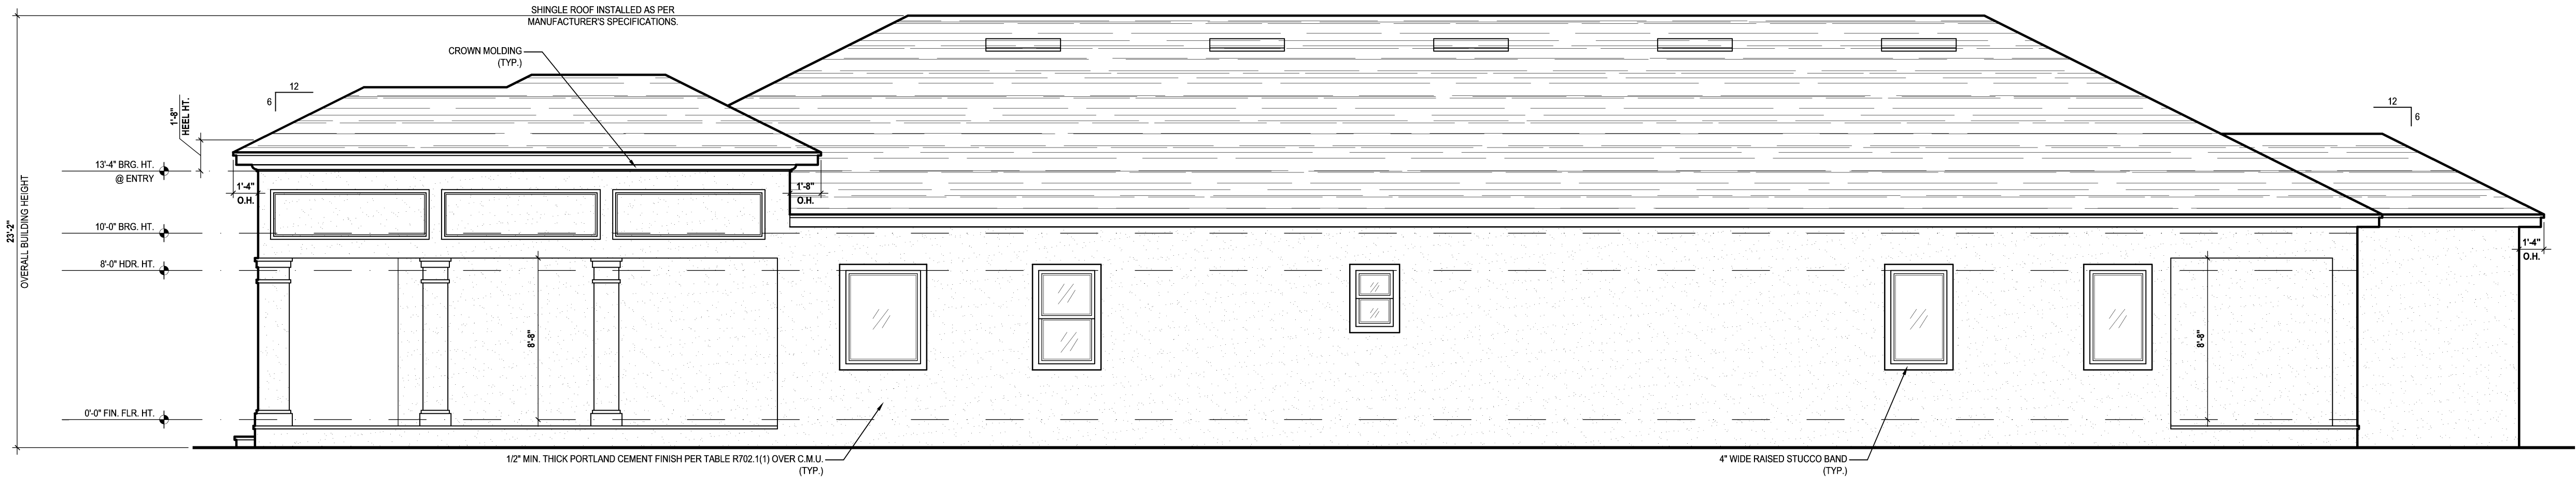

Right Elevation "A"

(Opt. Sitting Rm.)

SCALE 3/16" = 1'-0" (12x18) 3/8" = 1'-0" (24x36)

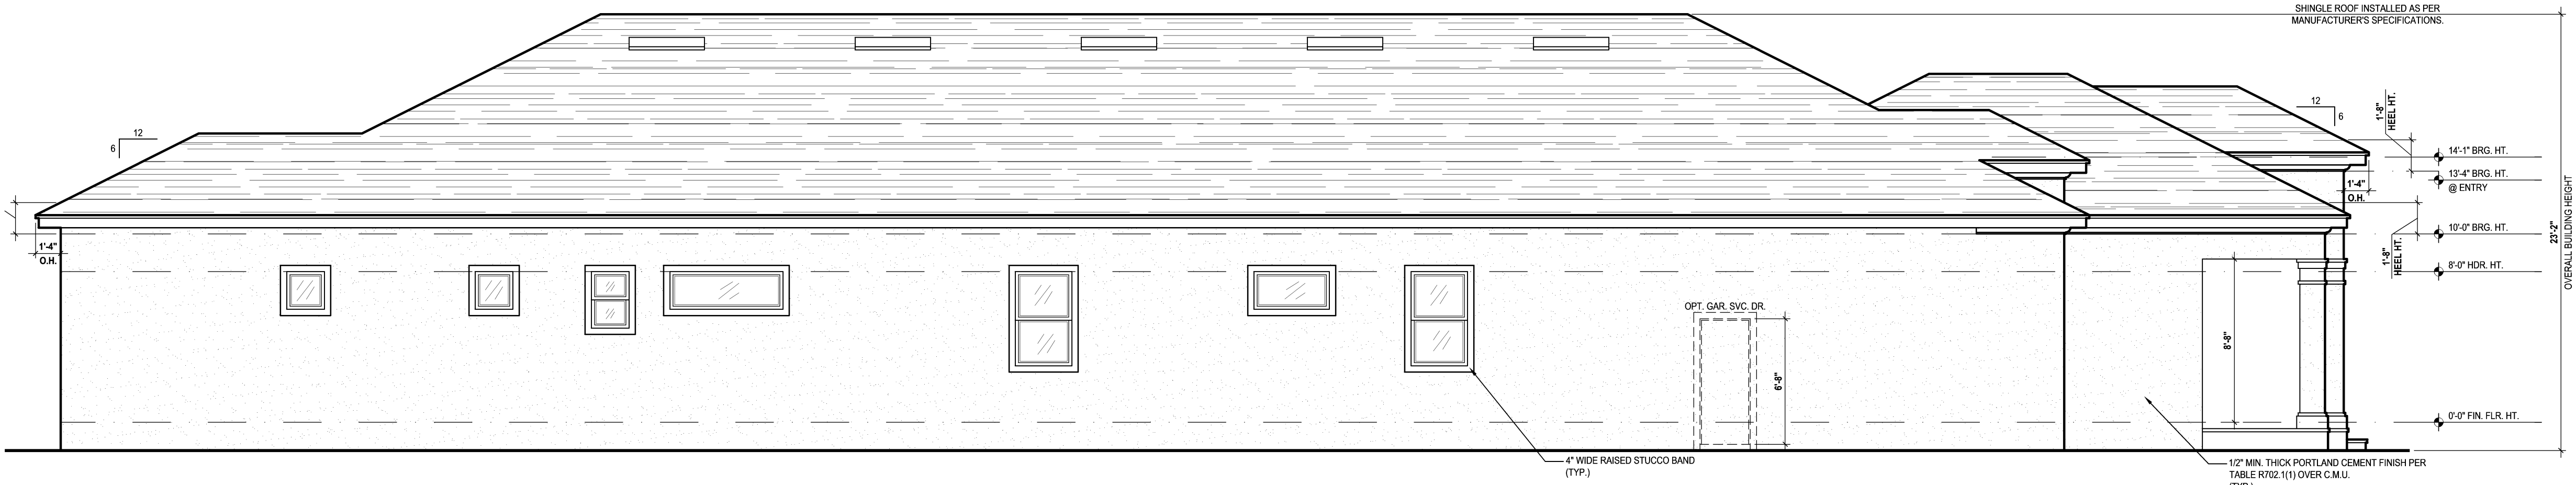

Left Elevation "A"

(Opt. Sitting Rm.)

SCALE 3/16" = 1'-0" (12x18) 3/8" = 1'-0" (24x36)







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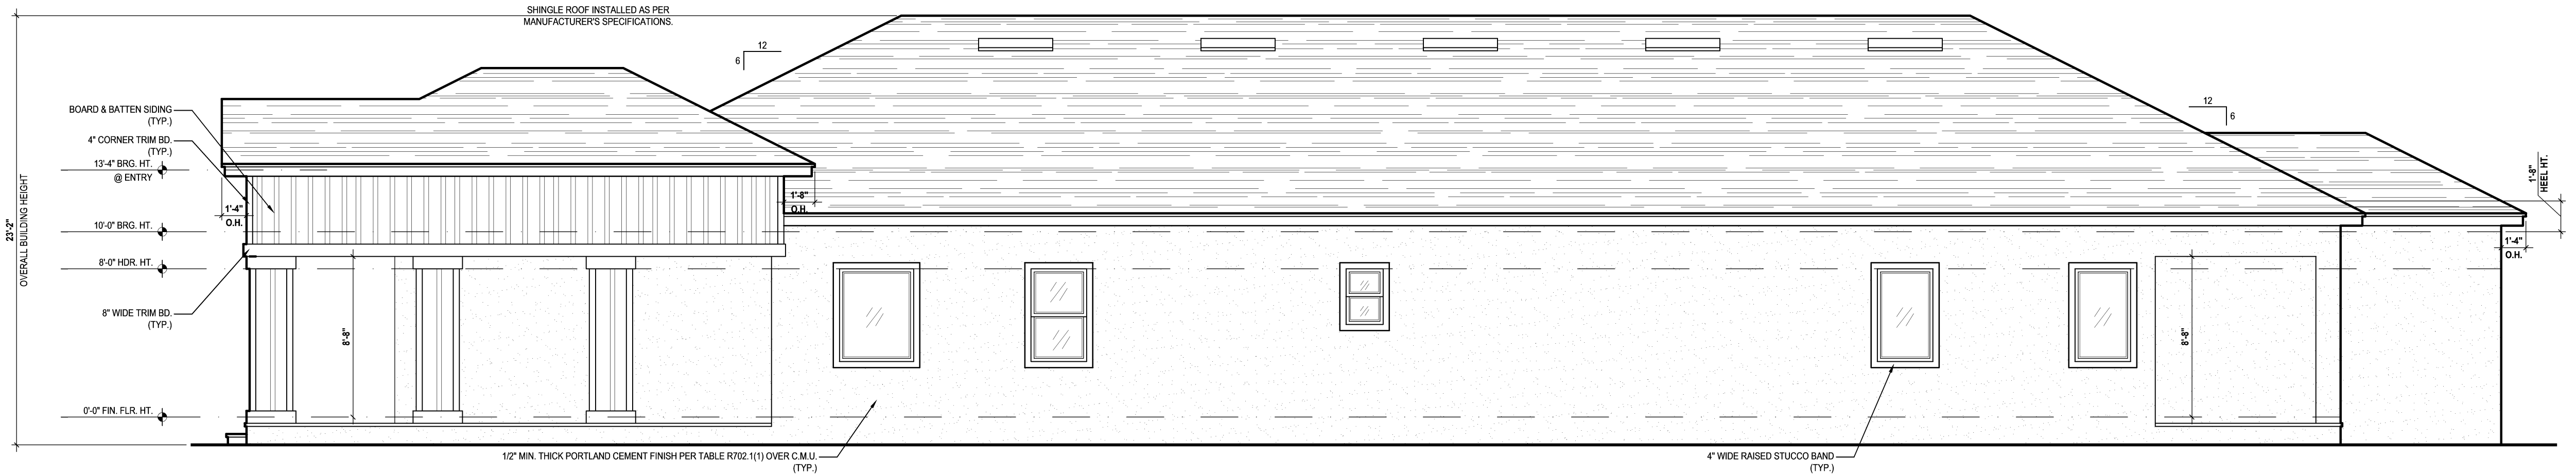
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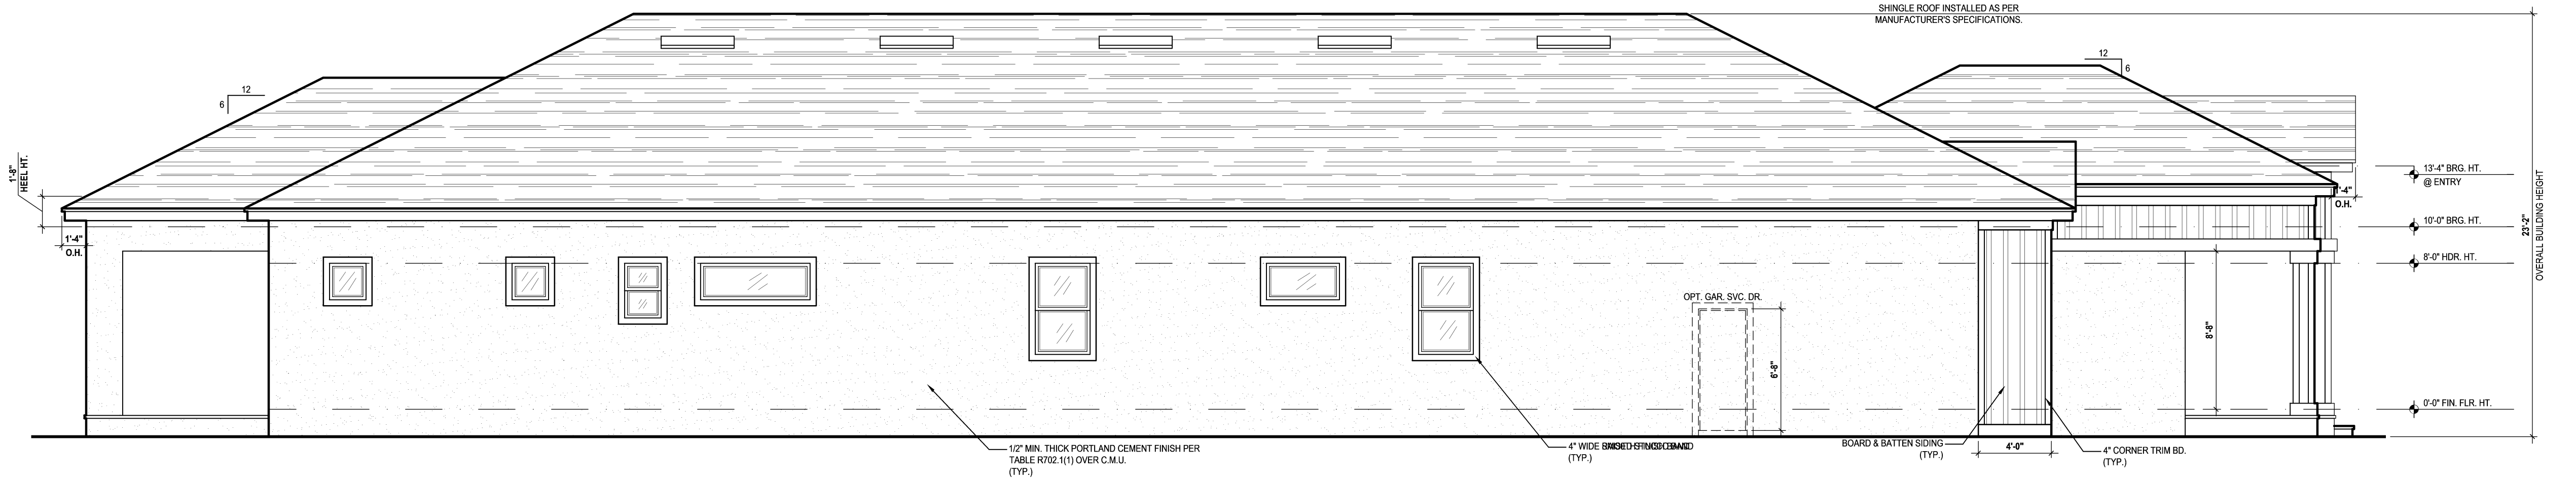






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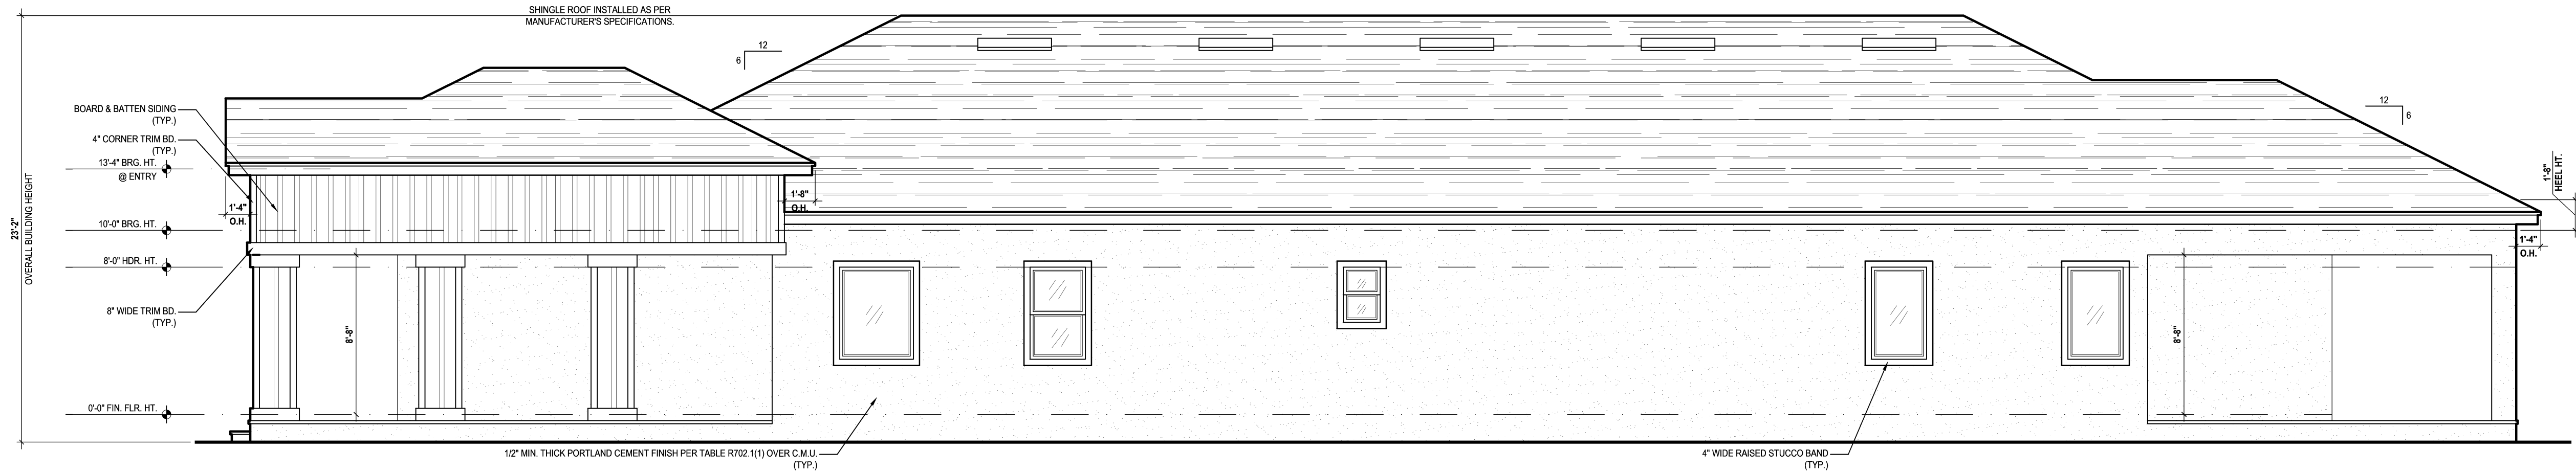
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## Left Elevation "B"

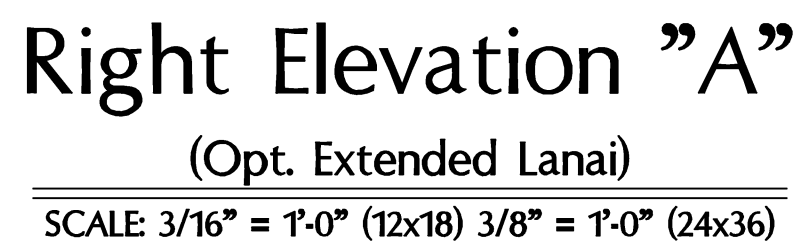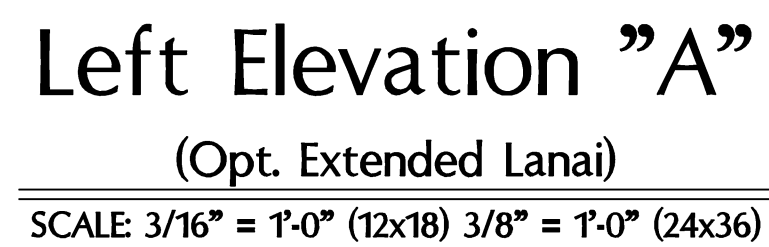(Opt. Extended Lanai)

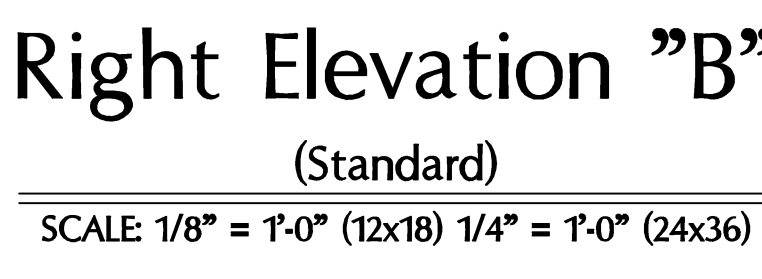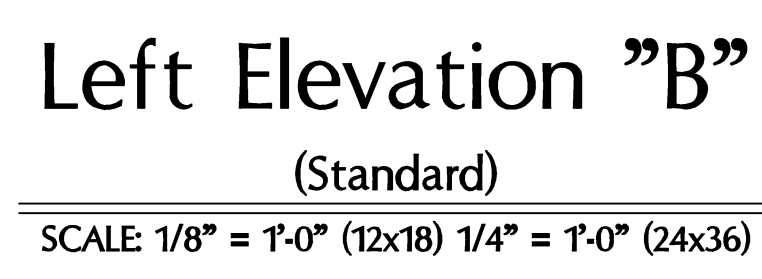
SCALE 3/16" = 1'-0" (12x18) 3/8" = 1'-0" (24x36)



## Right Elevation "B"

(Opt. Extended Lanai)

SCALE 3/16" = 1'-0" (12x18) 3/8" = 1'-0" (24x36)

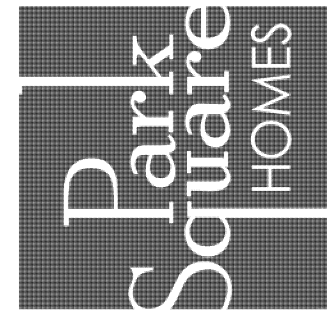

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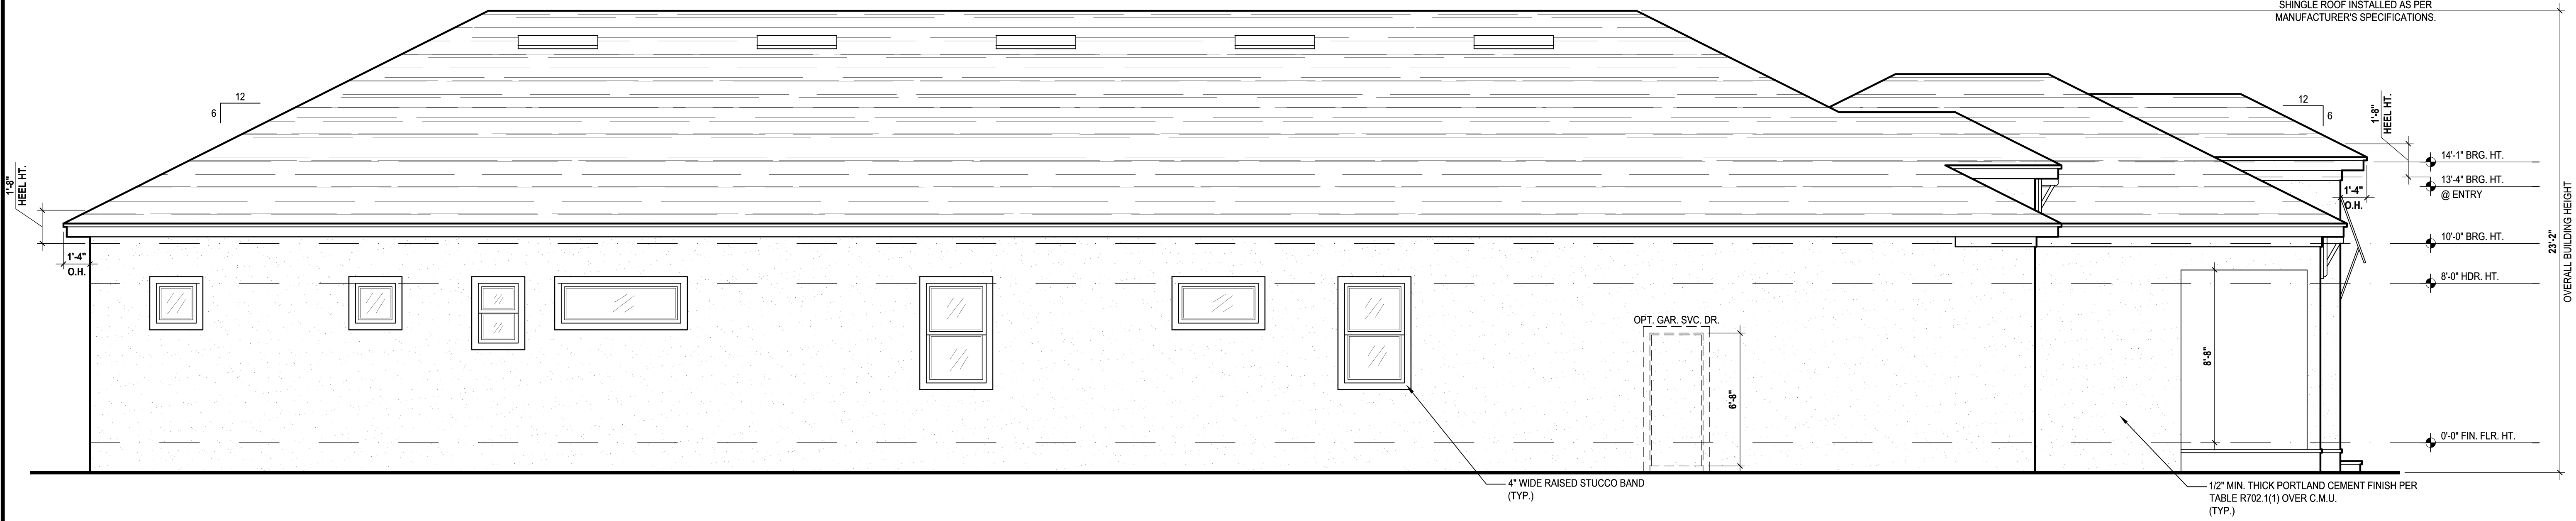
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Corrections and errors are the responsibility of the designer. The user must be responsible for dimensions and conditions of the job and must be aware of the fact that the drawings are not to be used for construction without the approval of the designer.




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Left Elevation "C"  
(Standard)

SCALE 1/8" = 1'-0" (12x18) 1/4" = 1'-0" (24x36)



Right Elevation "C"  
(Standard)


SCALE 1/8" = 1'-0" (12x18) 1/4" = 1'-0" (24x36)
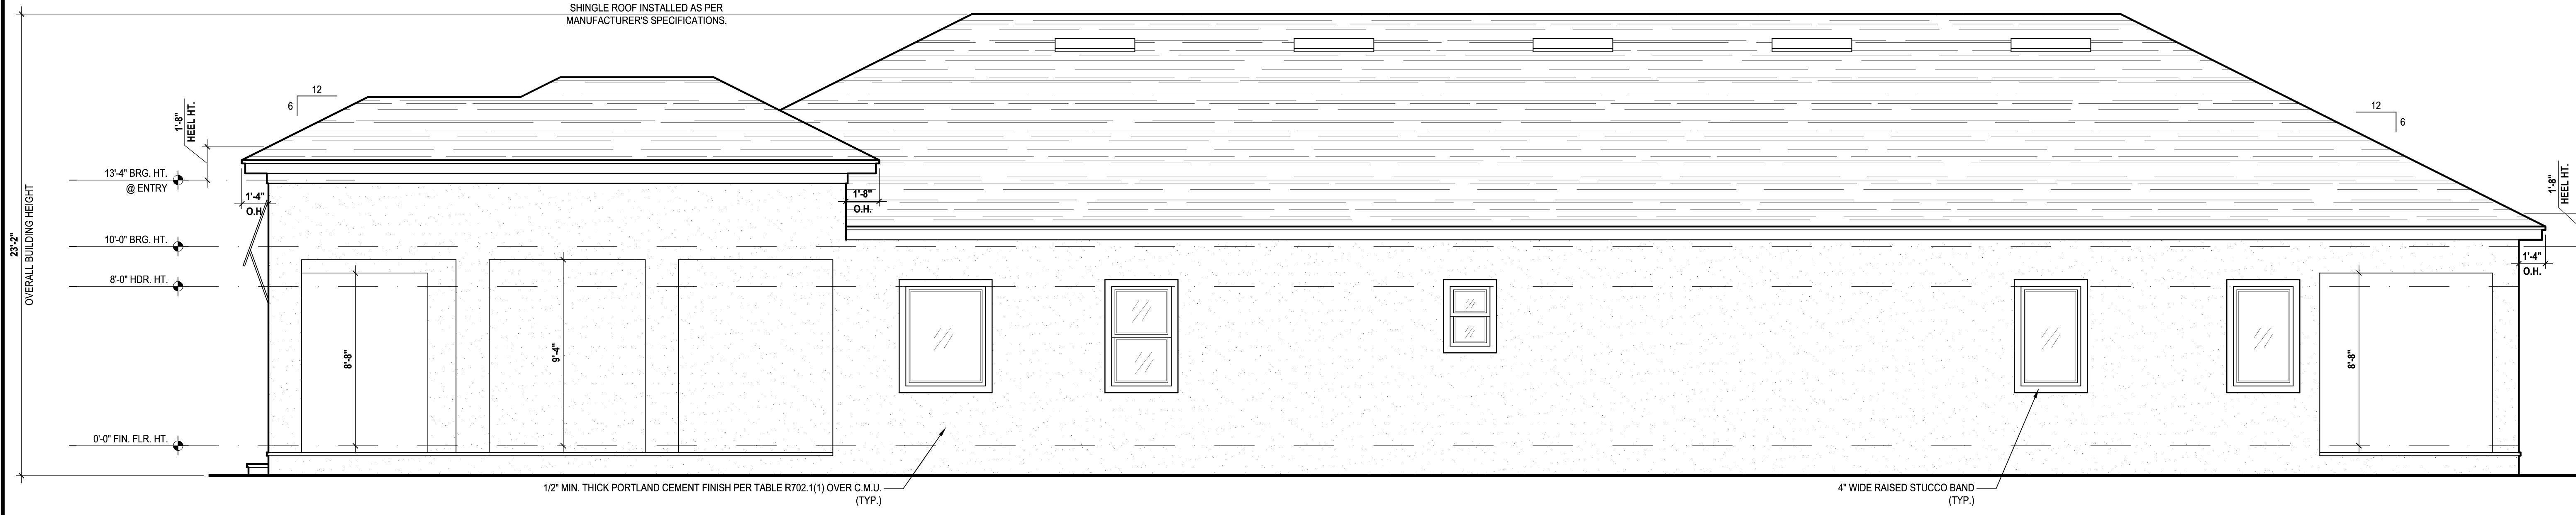
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ELEVATIONS "C"

05.C

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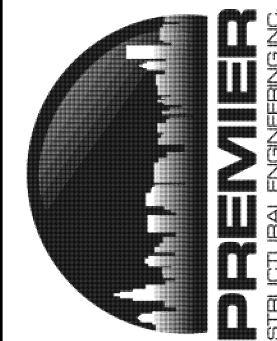


ISSUE DATE: 00/00/0000  
REVISIONS:  
PROJECT: 00-0000  
SCALE: AS NOTED  
DRAWN BY: C.C.  
DESIGNED BY: MJS

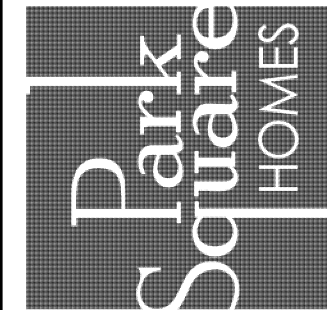
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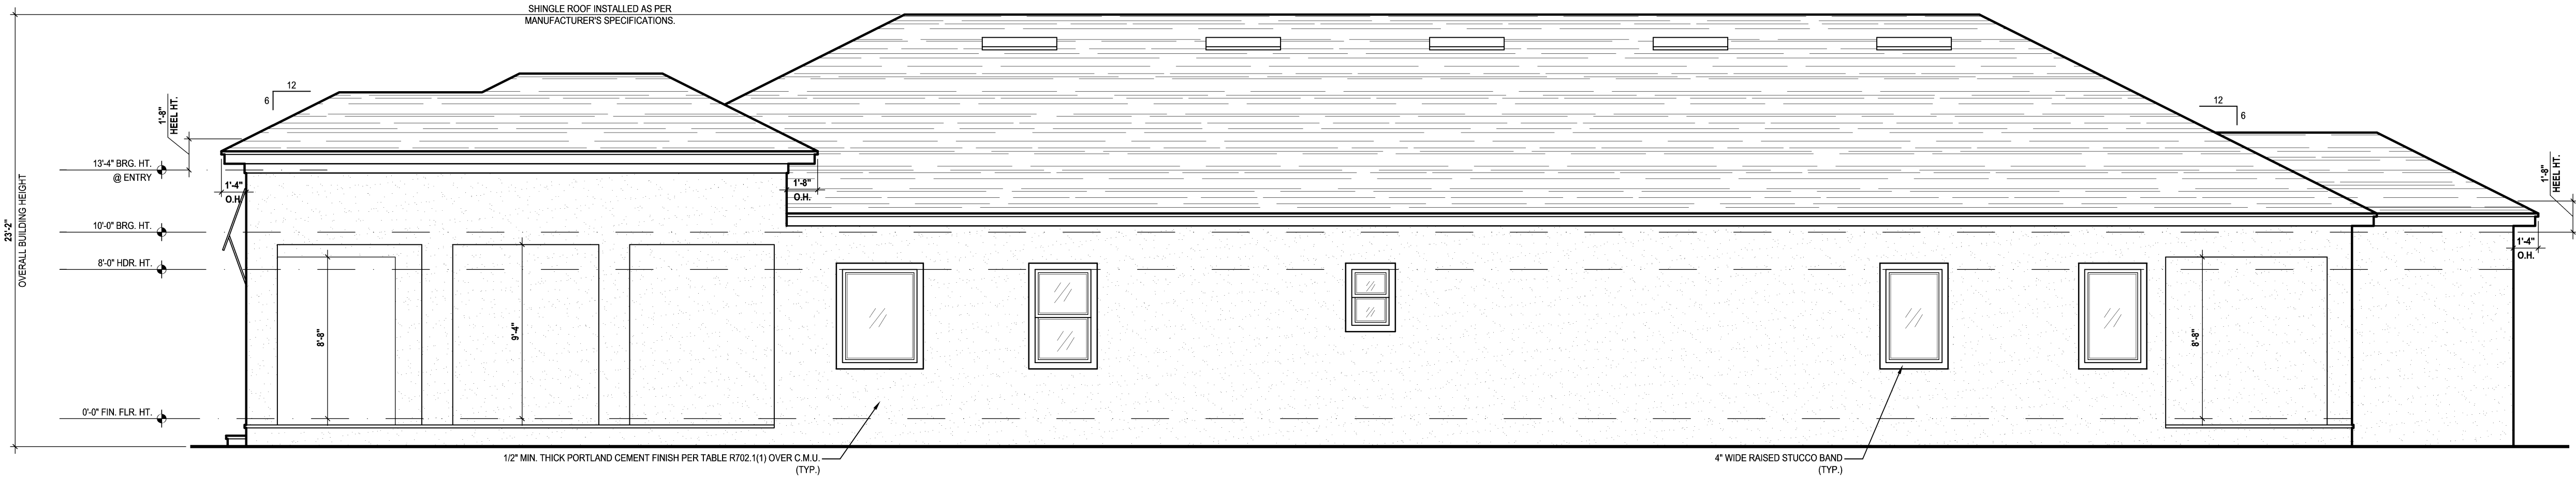
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Left Elevation "C"

(Opt. Sitting Rm.)


SCALE 3/16" = 1'-0" (12x18) 3/8" = 1'-0" (24x36)



Right Elevation "C"
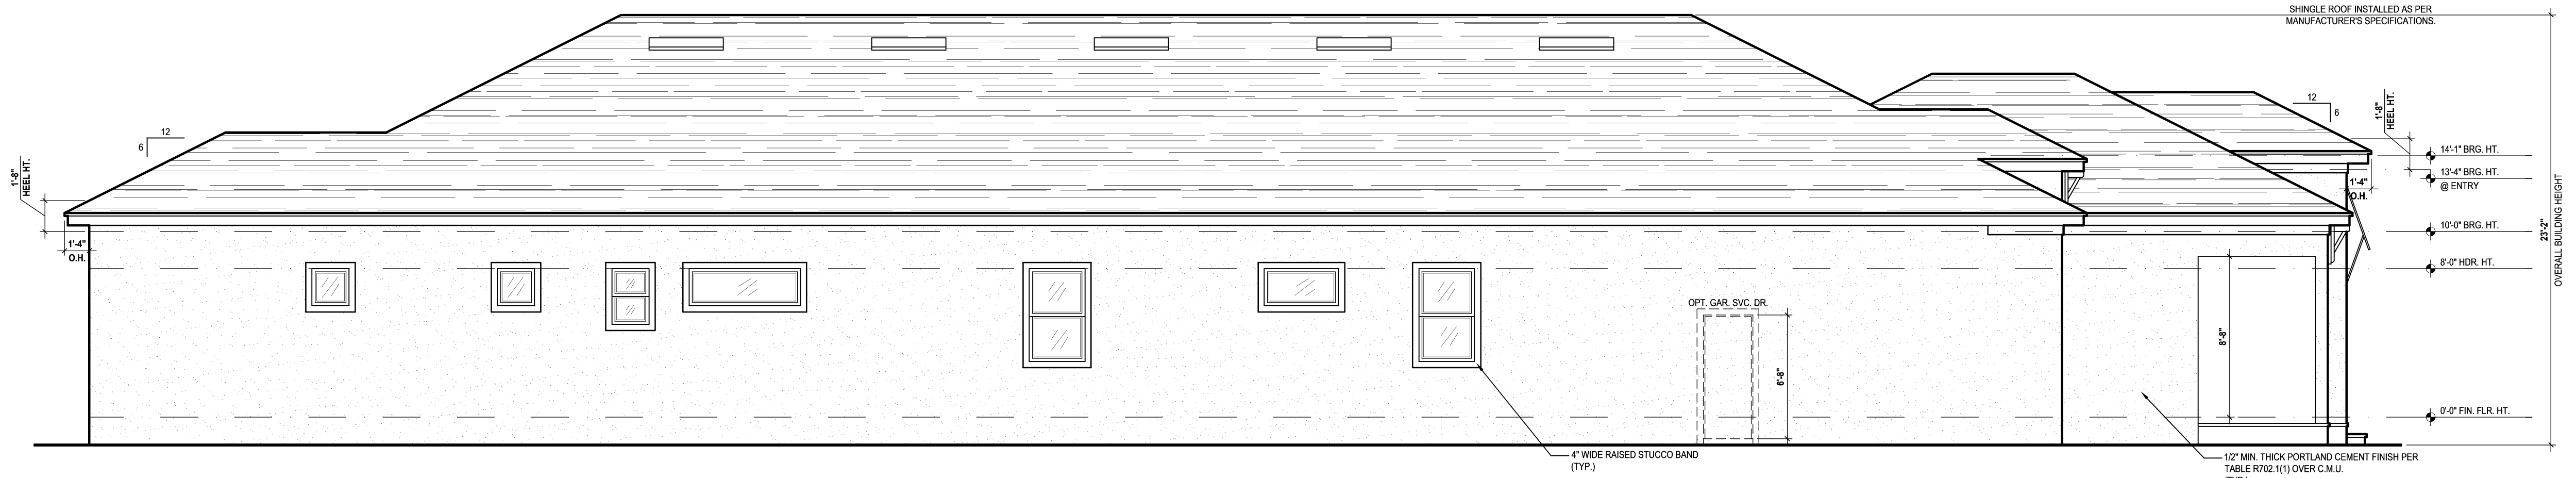
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SCALE 3/16" = 1'-0" (12x18) 3/8" = 1'-0" (24x36)

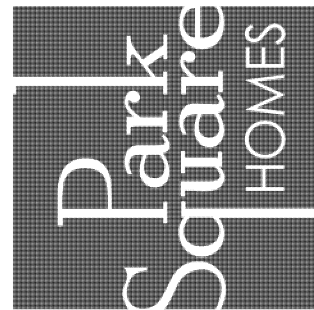

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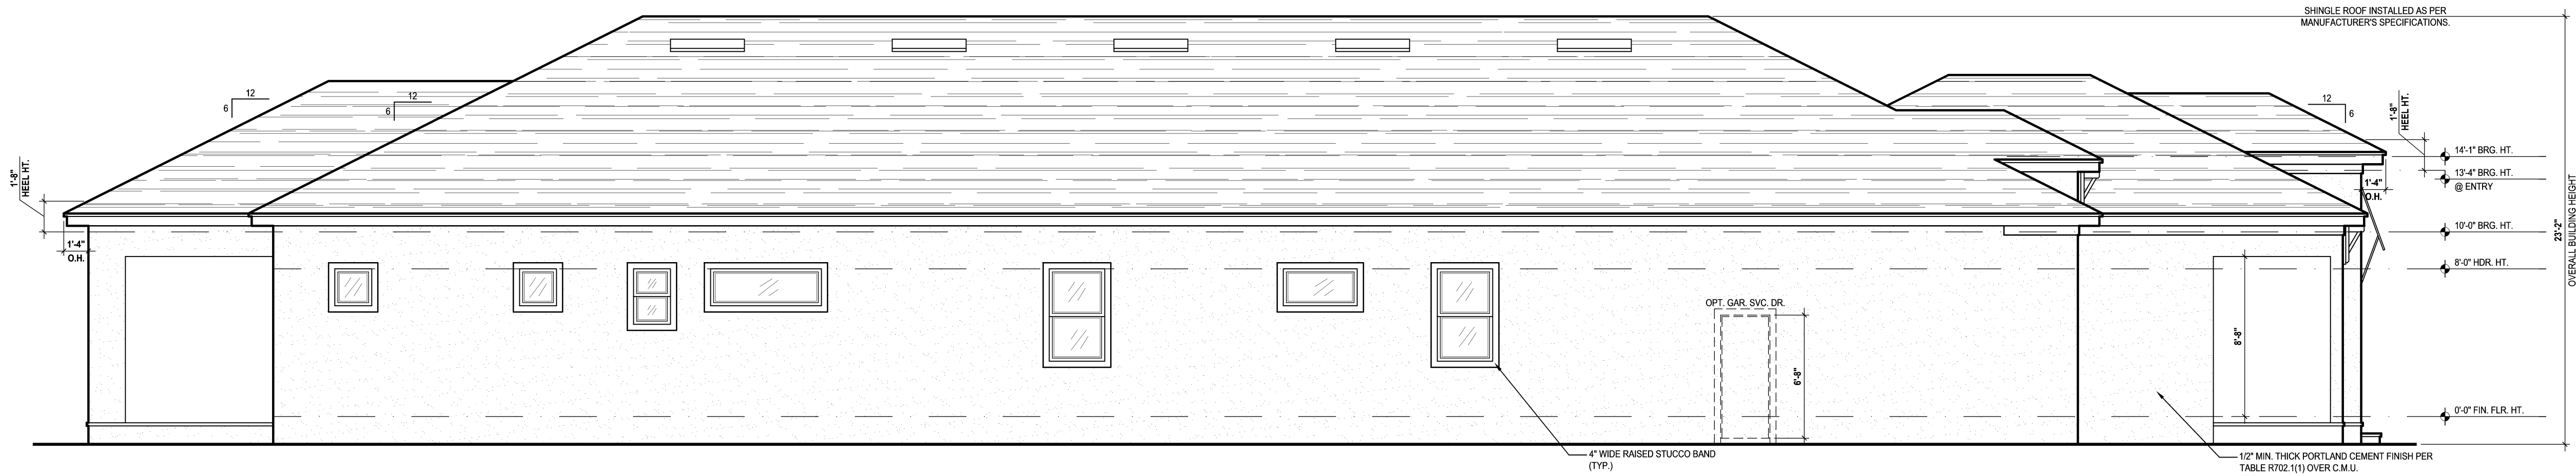
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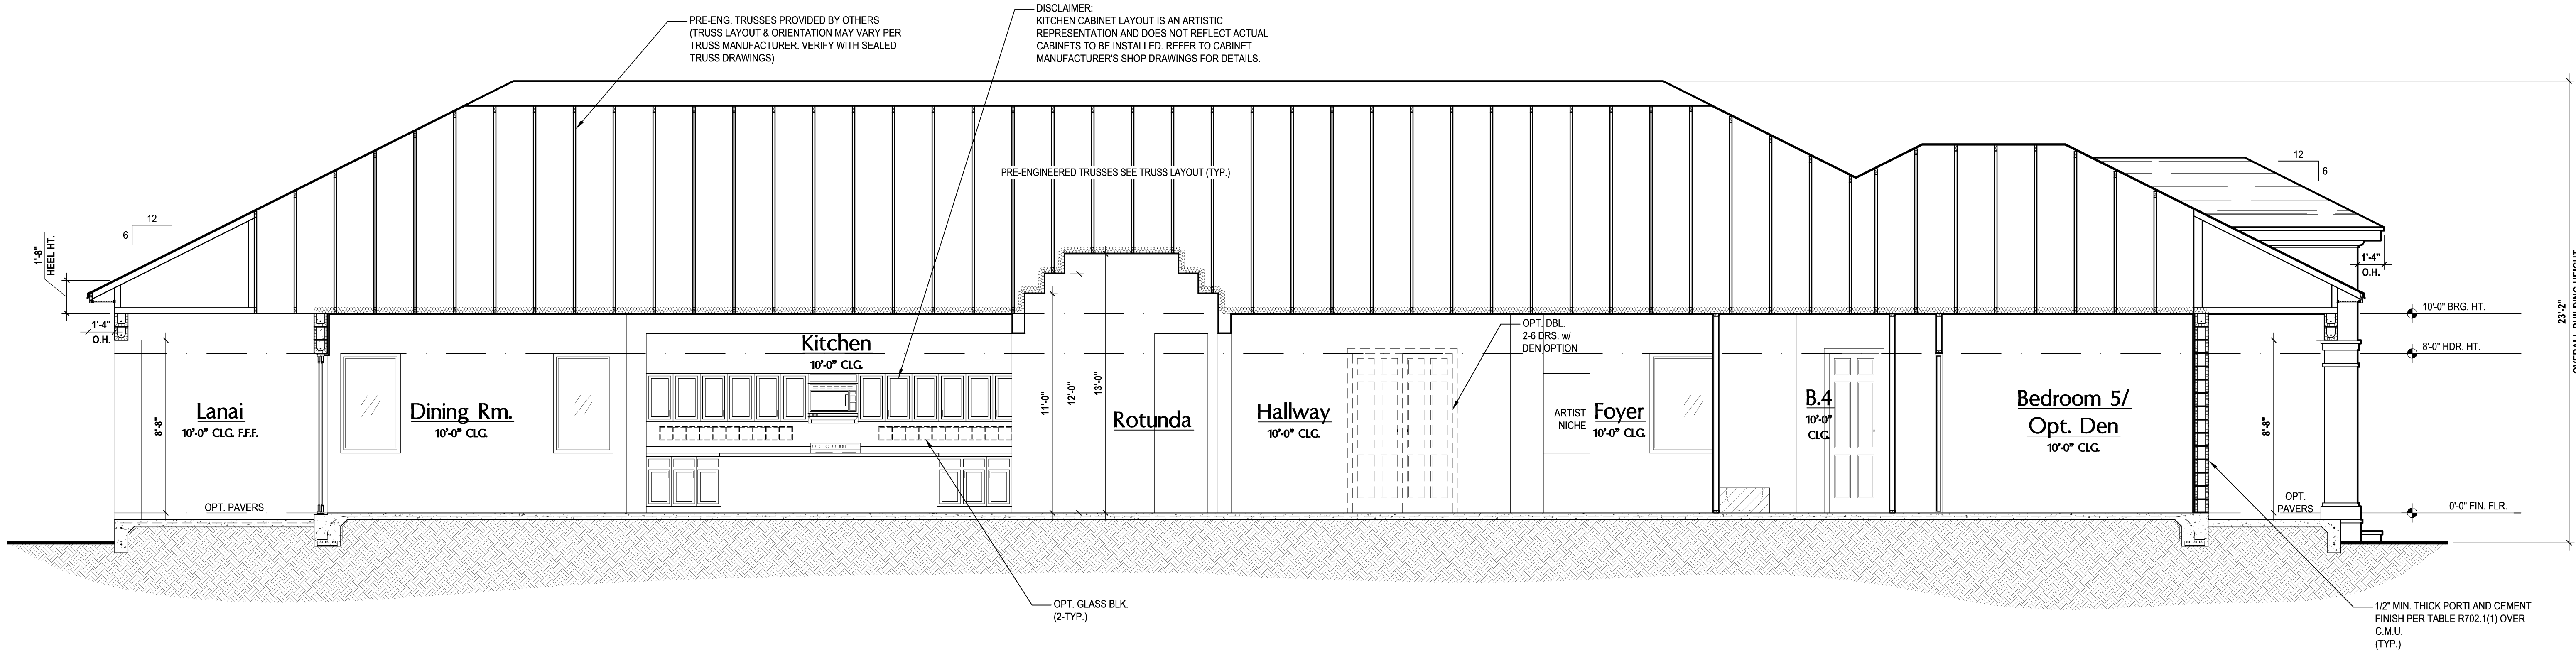


(Opt. Extended Lanai)

SCALE: 3/16" = 1'-0" (12x18) 3/8" = 1'-0" (24x36)

(Opt. Extended Lanai)

SCALE: 3/16" = 1'-0" (12x18) 3/8" = 1'-0" (24x36)



Building Section "A"  
(Standard)

SCALE: 1/8" = 1'-0" (12x18) 1/4" = 1'-0" (24x36)

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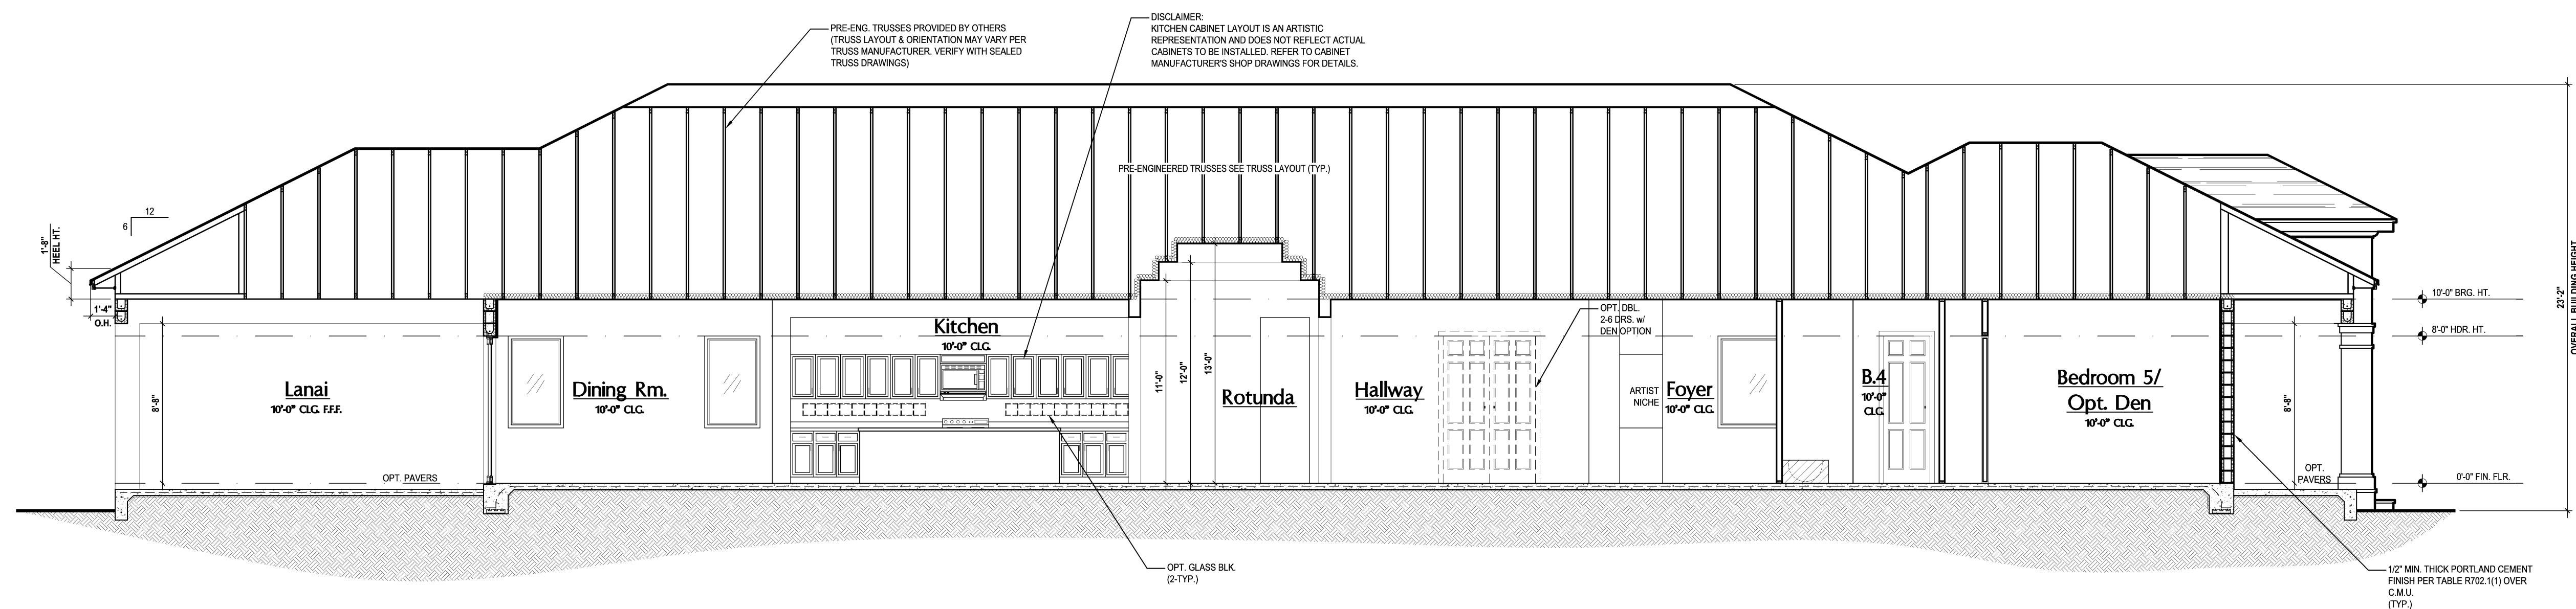
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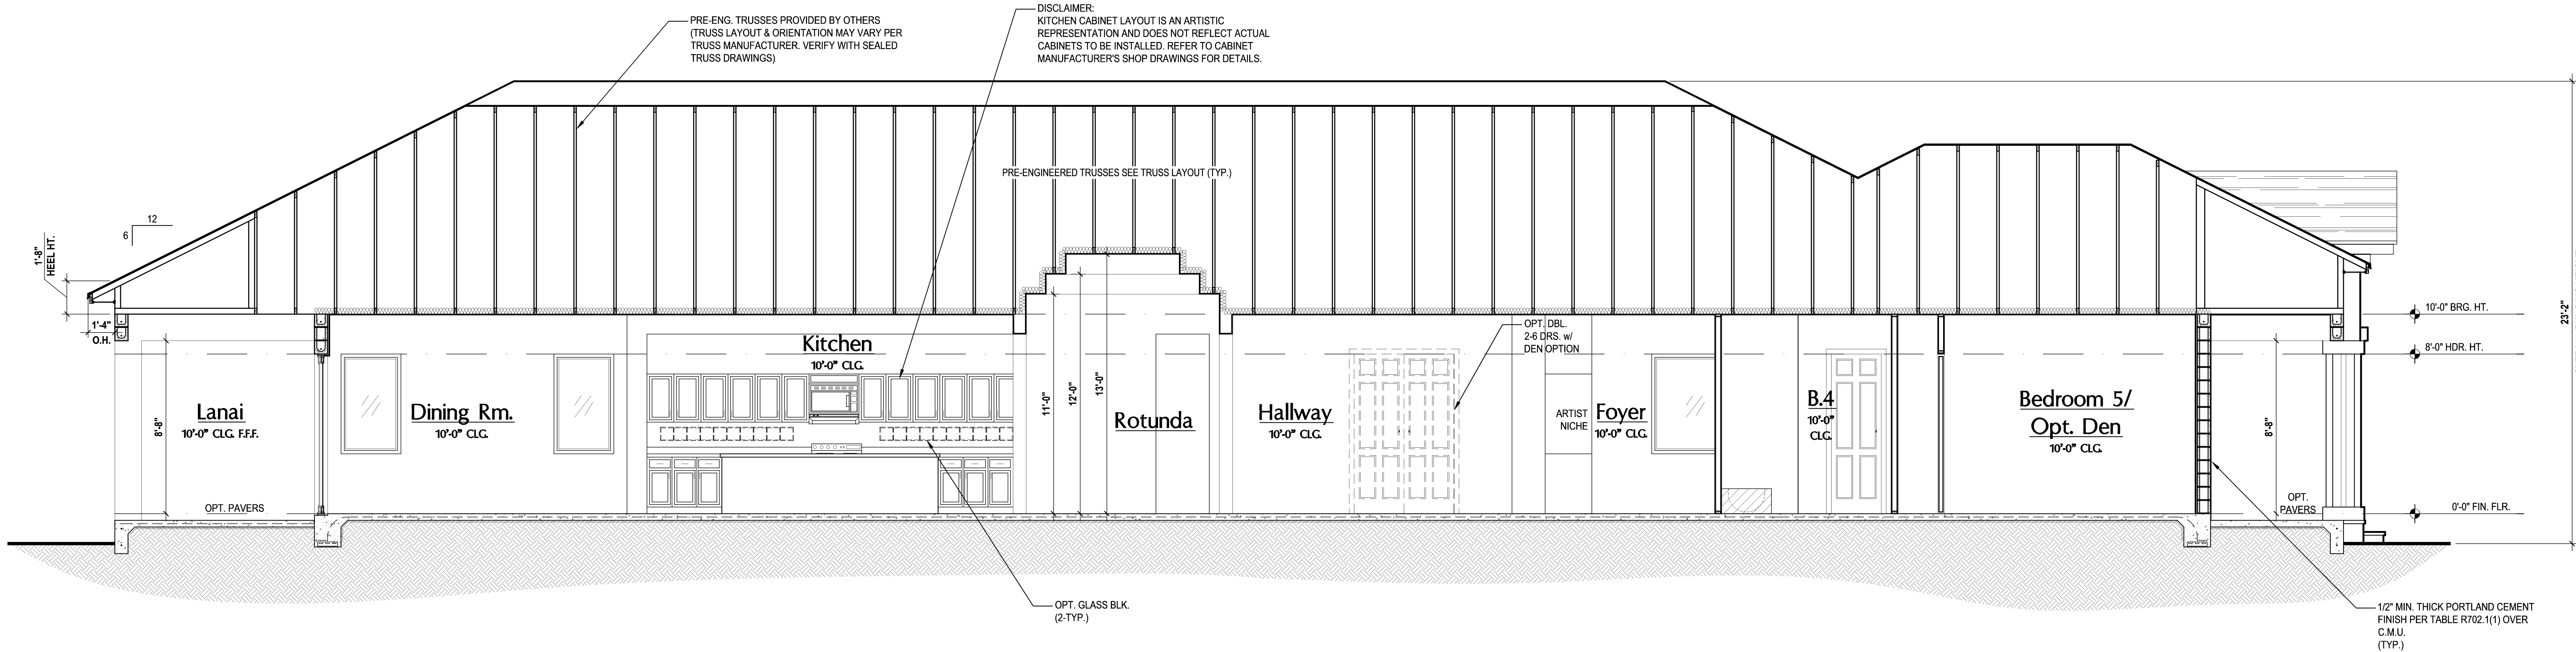
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## Building Section "A"

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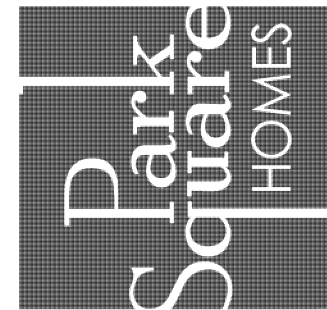
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Building Section "B"  
(Standard)

SCALE: 1/8" = 1'-0" (12x18) 1/4" = 1'-0" (24x36)

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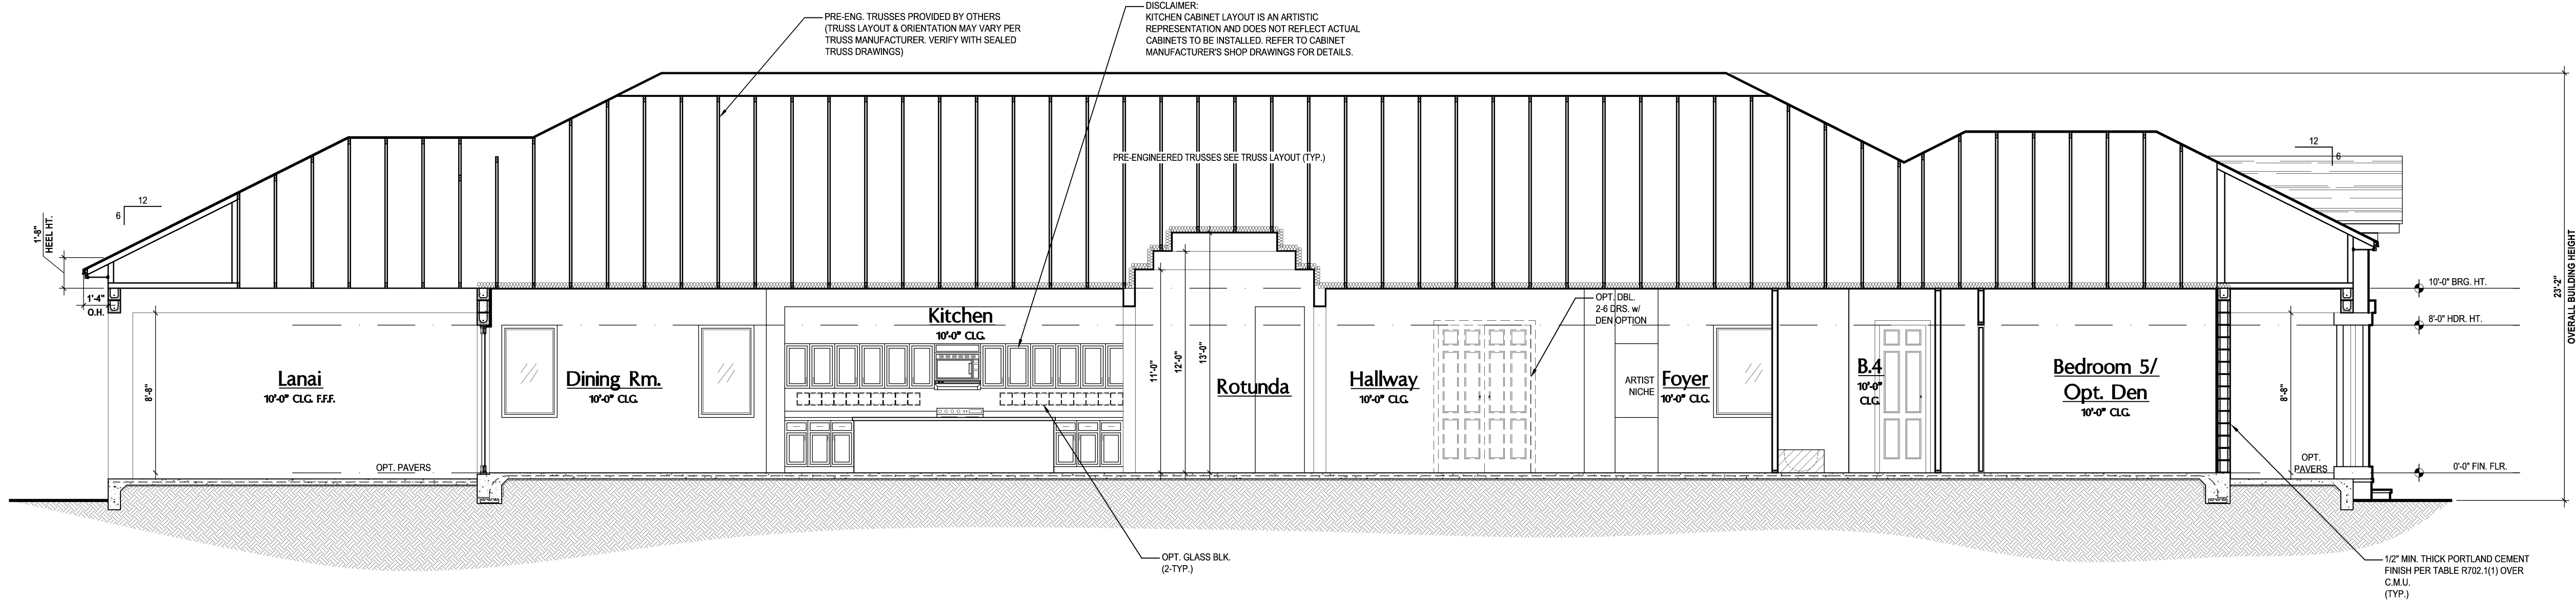
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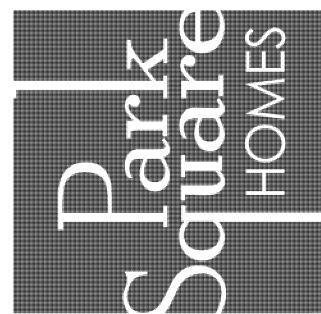


# Building Section "B"

(Opt. Extended Lanai)

SCALE: 3/16" = 1'-0" (12x18) 3/8" = 1'-0" (24x36)

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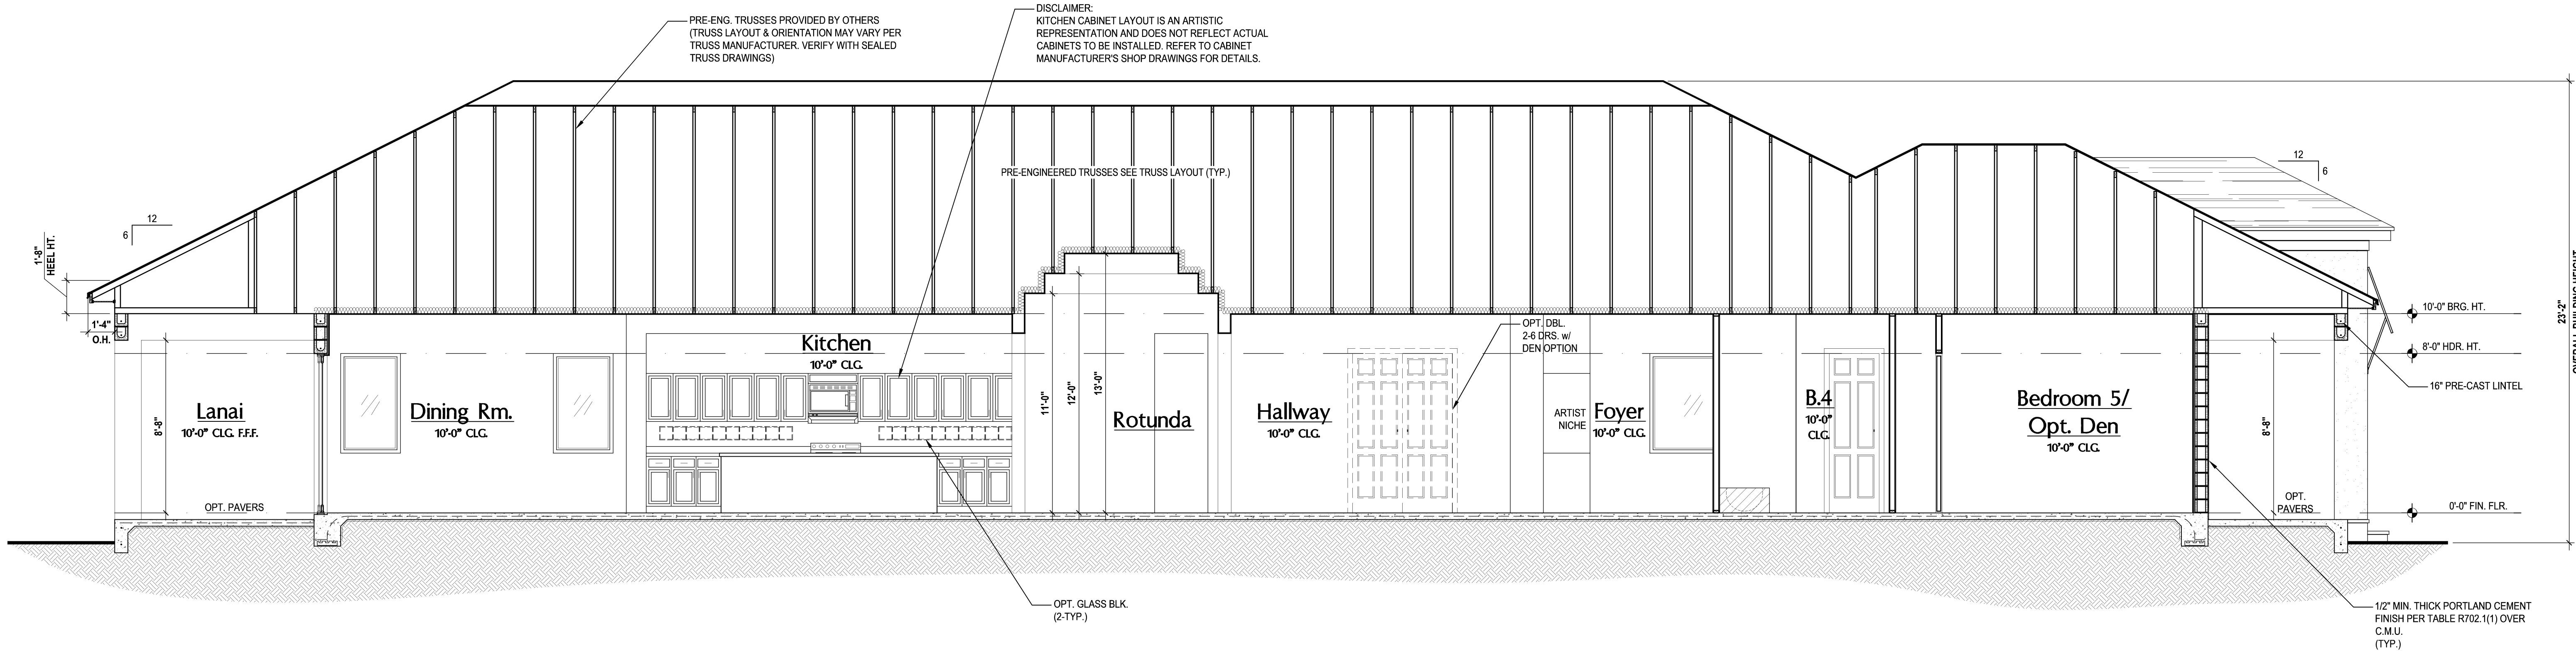
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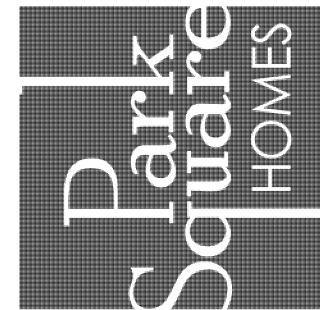
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Building Section "C"  
(Standard)

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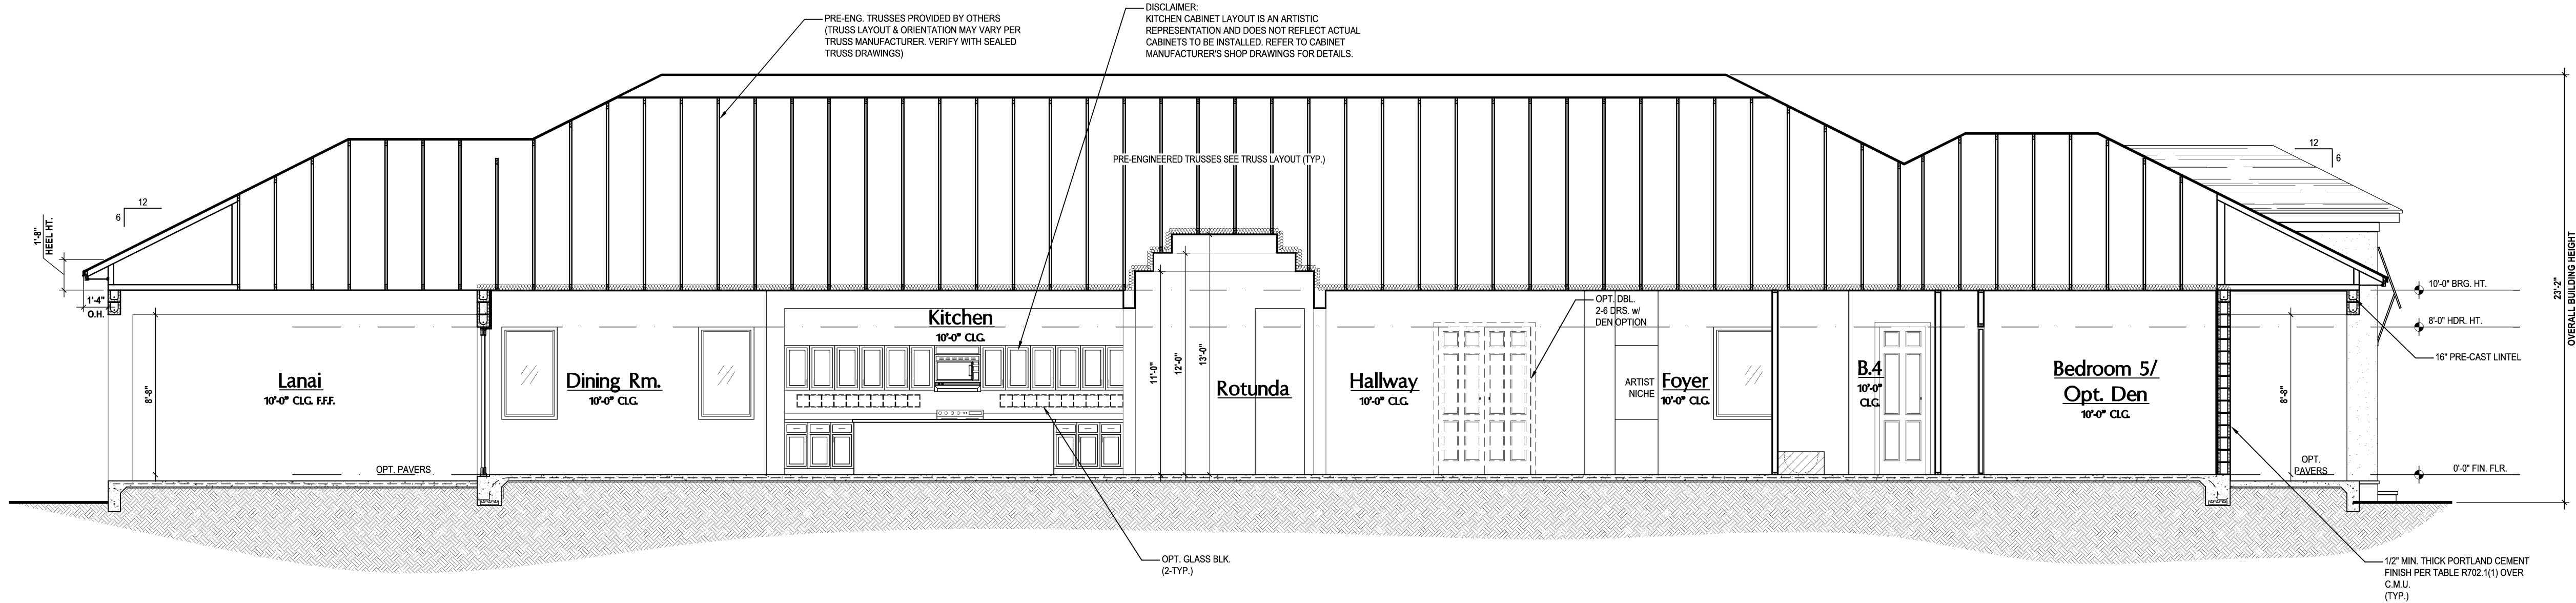
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# Building Section "C"

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**MJS**  
815 Orienta Ave, Suite# 1040  
Altamonte Springs, FL 32701  
Ph: (407) 629-6711  
Fax: (407) 629-6776  
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BUILDING SECTION

06.C1

- GENERAL NOTES KEY:
1. BUILDER TO VERIFY EXACT LOCATION OF FLOOR OUTLETS IN FIELD.

2. ALL OUTLETS ARE TO BE AFCI PROTECTED.

3. ALL 15A AND 20A 120V BRANCH CIRCUITS WILL BE AFCI PROTECTED.

4. ALL 15A AND 20A 120V BRANCH CIRCUITS LOCATED IN THE GARAGE AND LAUNDRY WILL BE GFCI PROTECTED.

5. ALL GARAGE BAYS WILL HAVE DEDICATED GFCI OUTLET.

6. ALL OUTLETS LOCATED IN THE KITCHEN AND BATHROOMS ARE TO BE GFCI PROTECTED.

7. DW. AND GARBAGE DISPOSAL ARE TO BE GFCI PROTECTED.

8. EXCEPTIONS TO THE GFCI STIPULATION WILL BE ALLOWED ONLY IF ALLOWED PER CURRENT NFPA / NEC.

9. OUTLETS LOCATED IN THE LAUNDRY ARE TO BE GFCI AND AFCI PROTECTED.

10. OUTLETS LOCATED WITHIN 6'-0" OF A WET AREA ARE TO BE GFCI PROTECTED.

11. ALL OUTLETS OVER COUNTERTOPS TO BE 42" A.F.F. (U.N.O.).

12. ALL SMOKE/CARBON MONOXIDE DETECTORS ARE TO BE HARD WIRED, INTERCONNECTED AND AFCI PROTECTED.

13. 8'-0" HEIGHT VANITY LIGHTS IN MASTER BATHROOM AND 7'-0" IN ALL OTHER BATHROOMS.

14. IN AREAS SPECIFIED IN SECTION E3901.1, 125-VOLT, 15- AND 20-AMPERE RECEPTACLES SHALL BE LISTED TAMPER-RESISTANT RECEPTACLES.

NOTES:


THIS DIAGRAMMATIC PLAN IS INTENDED TO SHOW LIGHTING AND CONVENIENCE OUTLETS ONLY. IT IS THE ELECTRICAL CONTRACTORS RESPONSIBILITY TO VERIFY THE REQUIREMENT AND LOCATIONS OF ALL ELECTRICAL EQUIPMENT, (INCLUDING KITCHEN EQUIPMENT) AND PROVIDE AND INSTALL COMPLETE ELECTRICAL SERVICE AS REQUIRED PER NFPA, NEC, FBC CODES AND ALL REIGNING MUNICIPALITY CODES, STANDARDS AND ORDINANCES.

LOCATION OF FIXTURES AND / OR OUTLETS ARE SUGGESTED LOCATIONS AND MEET MOST LOCAL CODE REQUIREMENTS. ADDITIONS OR ADJUSTMENTS MAY BE MADE BETWEEN THE OWNER AND BUILDER IN THE FIELD.

ALL ELECTRICAL WORK AND APPLIANCES ARE IN FULL COMPLIANCE WITH N.E.F.P.A., N.E.C., F.B.C. 6TH EDITION (2017) RESIDENTIAL, AND ALL APPLICABLE LOCAL STANDARDS, CODES, AND ORDINANCES.

VARIOUS SYMBOLS ON ELECTRICAL LEGEND MAY OR MAY NOT BE USED ON THIS PLAN.


ELECTRICAL KEY:					
	CEILING MOUNTED LIGHT		FLOOR RECEPTACLE		CHIME
	PULL CHAIN LIGHT		PRE-WIRE FOR CLG. FAN		DOOR BELL / GARAGE DOOR SWITCH
	RECESSED LIGHT		GROUND FAULT INTERRUPT		DISCONNECT SWITCH
	WALL MOUNTED LIGHT		WALL SWITCH		ELECTRICAL METER
	WALL WASH RECESSED		3-WAY SWITCH		SMOKE DETECTOR
	DUPLEX RECEPTACLE		DIMMER SWITCH		CARBON MONOXIDE / SMOKE DETECTOR
	220 V RECEPTACLE		TELEPHONE JACK		CEILING FAN
	1/2 HOT, 1/2 SWITCHED		CABLE JACK		WALL SCONCE
	WATER PROOF RECEPTACLE		PRE-WIRE GARAGE DOOR OPENER		CHANDELIER
			FLUORESCENT LIGHT		SPOT LIGHT
			ELECTRICAL PANEL		

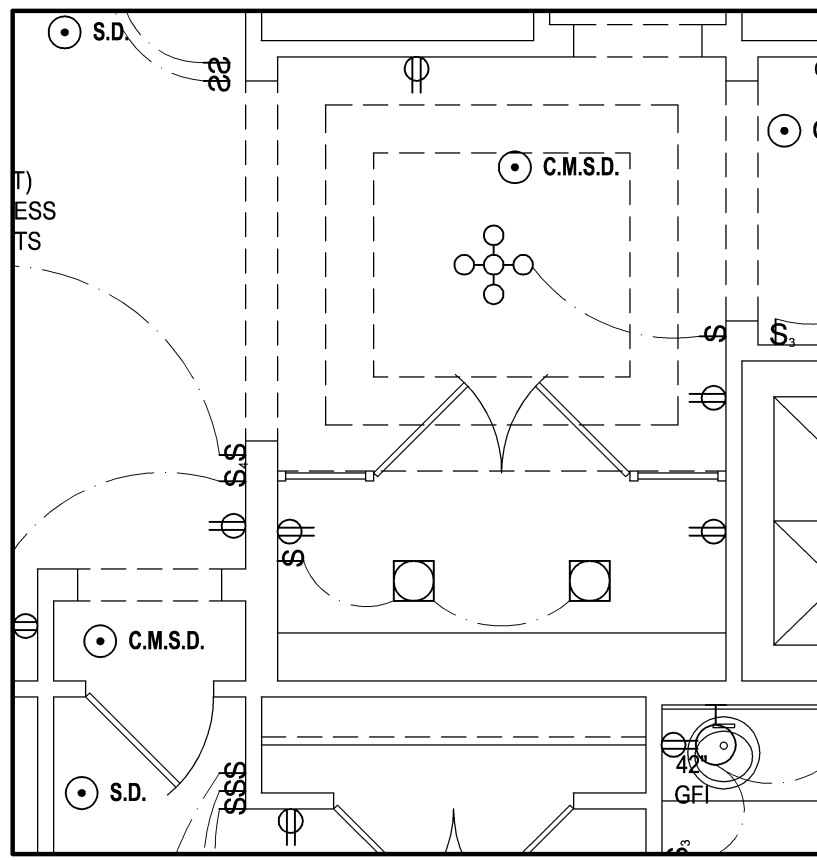

Electrical Plan


(Opt. Wine Room)

SCALE: 1/8" = 1'-0" (12x18) 1/4" = 1'-0" (24x36)

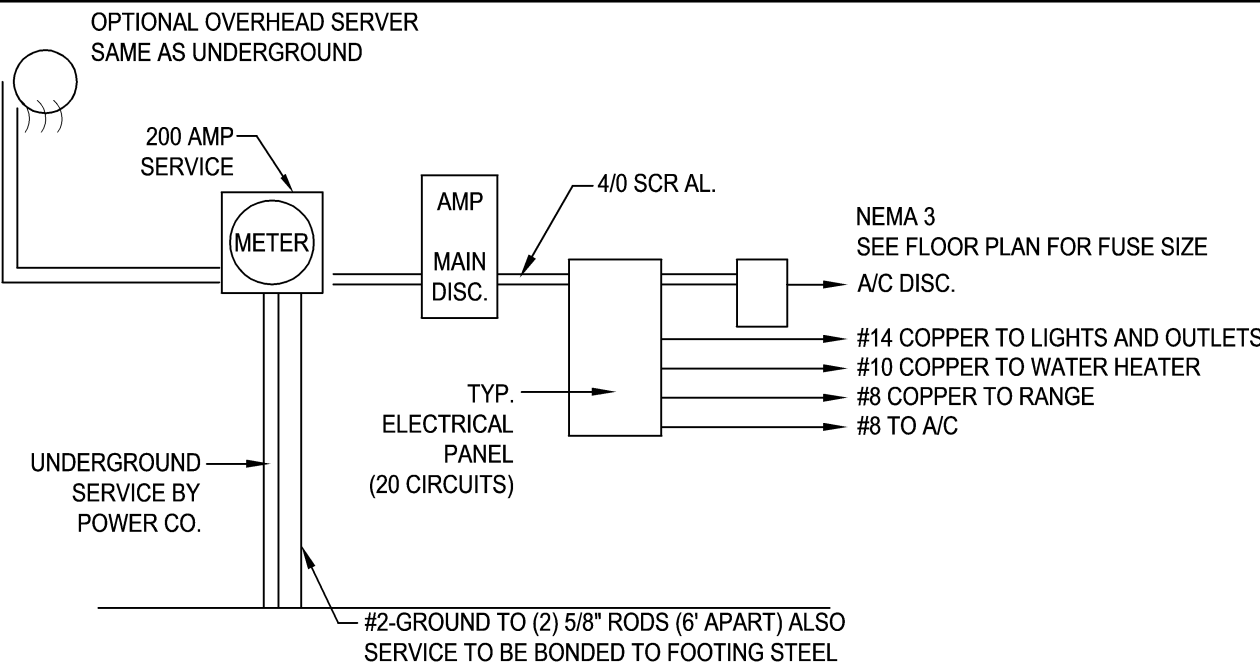

NOTE:  
ALL ELECTRICAL WORK AND MATERIAL PROVIDED SHALL COMPLY WITH THE FLORIDA BUILDING CODE. (2017) THE ABOVE ELECTRICAL LAYOUT IS FOR BID PURPOSE ONLY.

200 AMP ELECTRICAL RISER

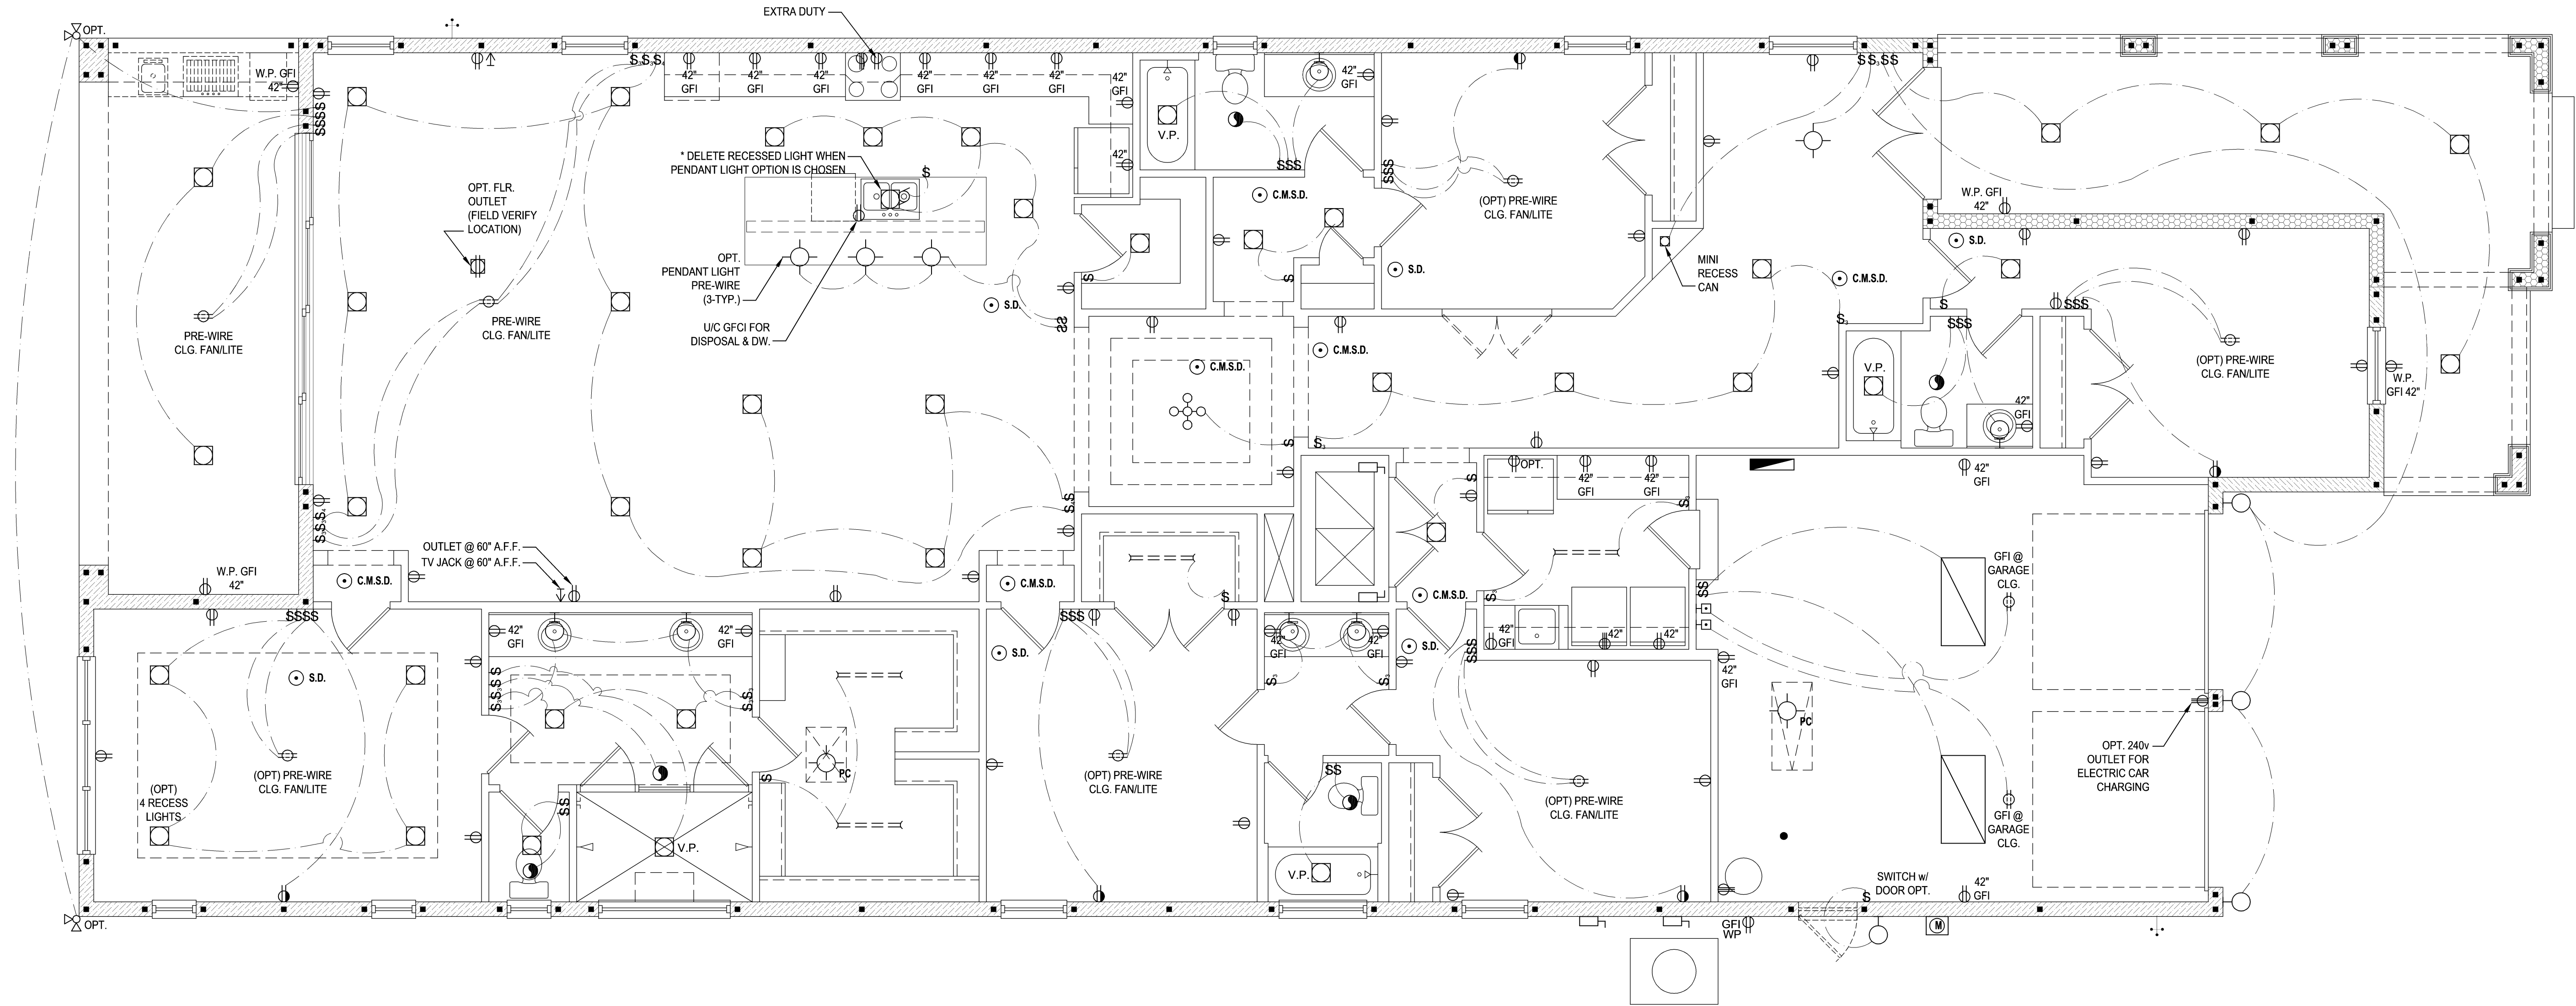

Electrical Plan "A"

(Standard)

SCALE: 1/8" = 1'-0" (12x18) 1/4" = 1'-0" (24x36)

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Phone: (407) 528-3000

ISSUE DATE

00/00/0000

REVISIONS

PROJECT:

00-0000

SCALE:

AS NOTED

DRAWN BY:

C.C.

DESIGNED BY:

MJS

Spark Square HOMES

07.A

815 Orienta Ave. Suite# 1040

Altamonte Springs, FL 32701

Ph: (407) 629-6711

Fax: (407) 629-6776

www.mjshomedesigns.com

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Suite 108-A

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Ph: (407) 227-7416

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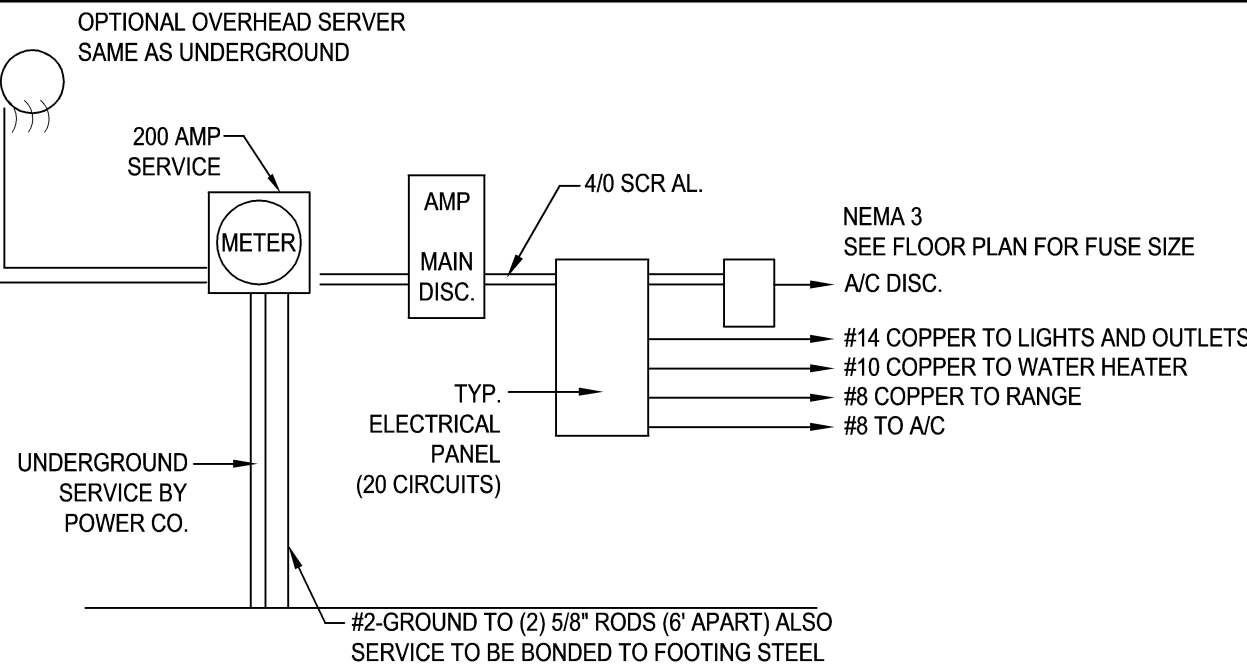
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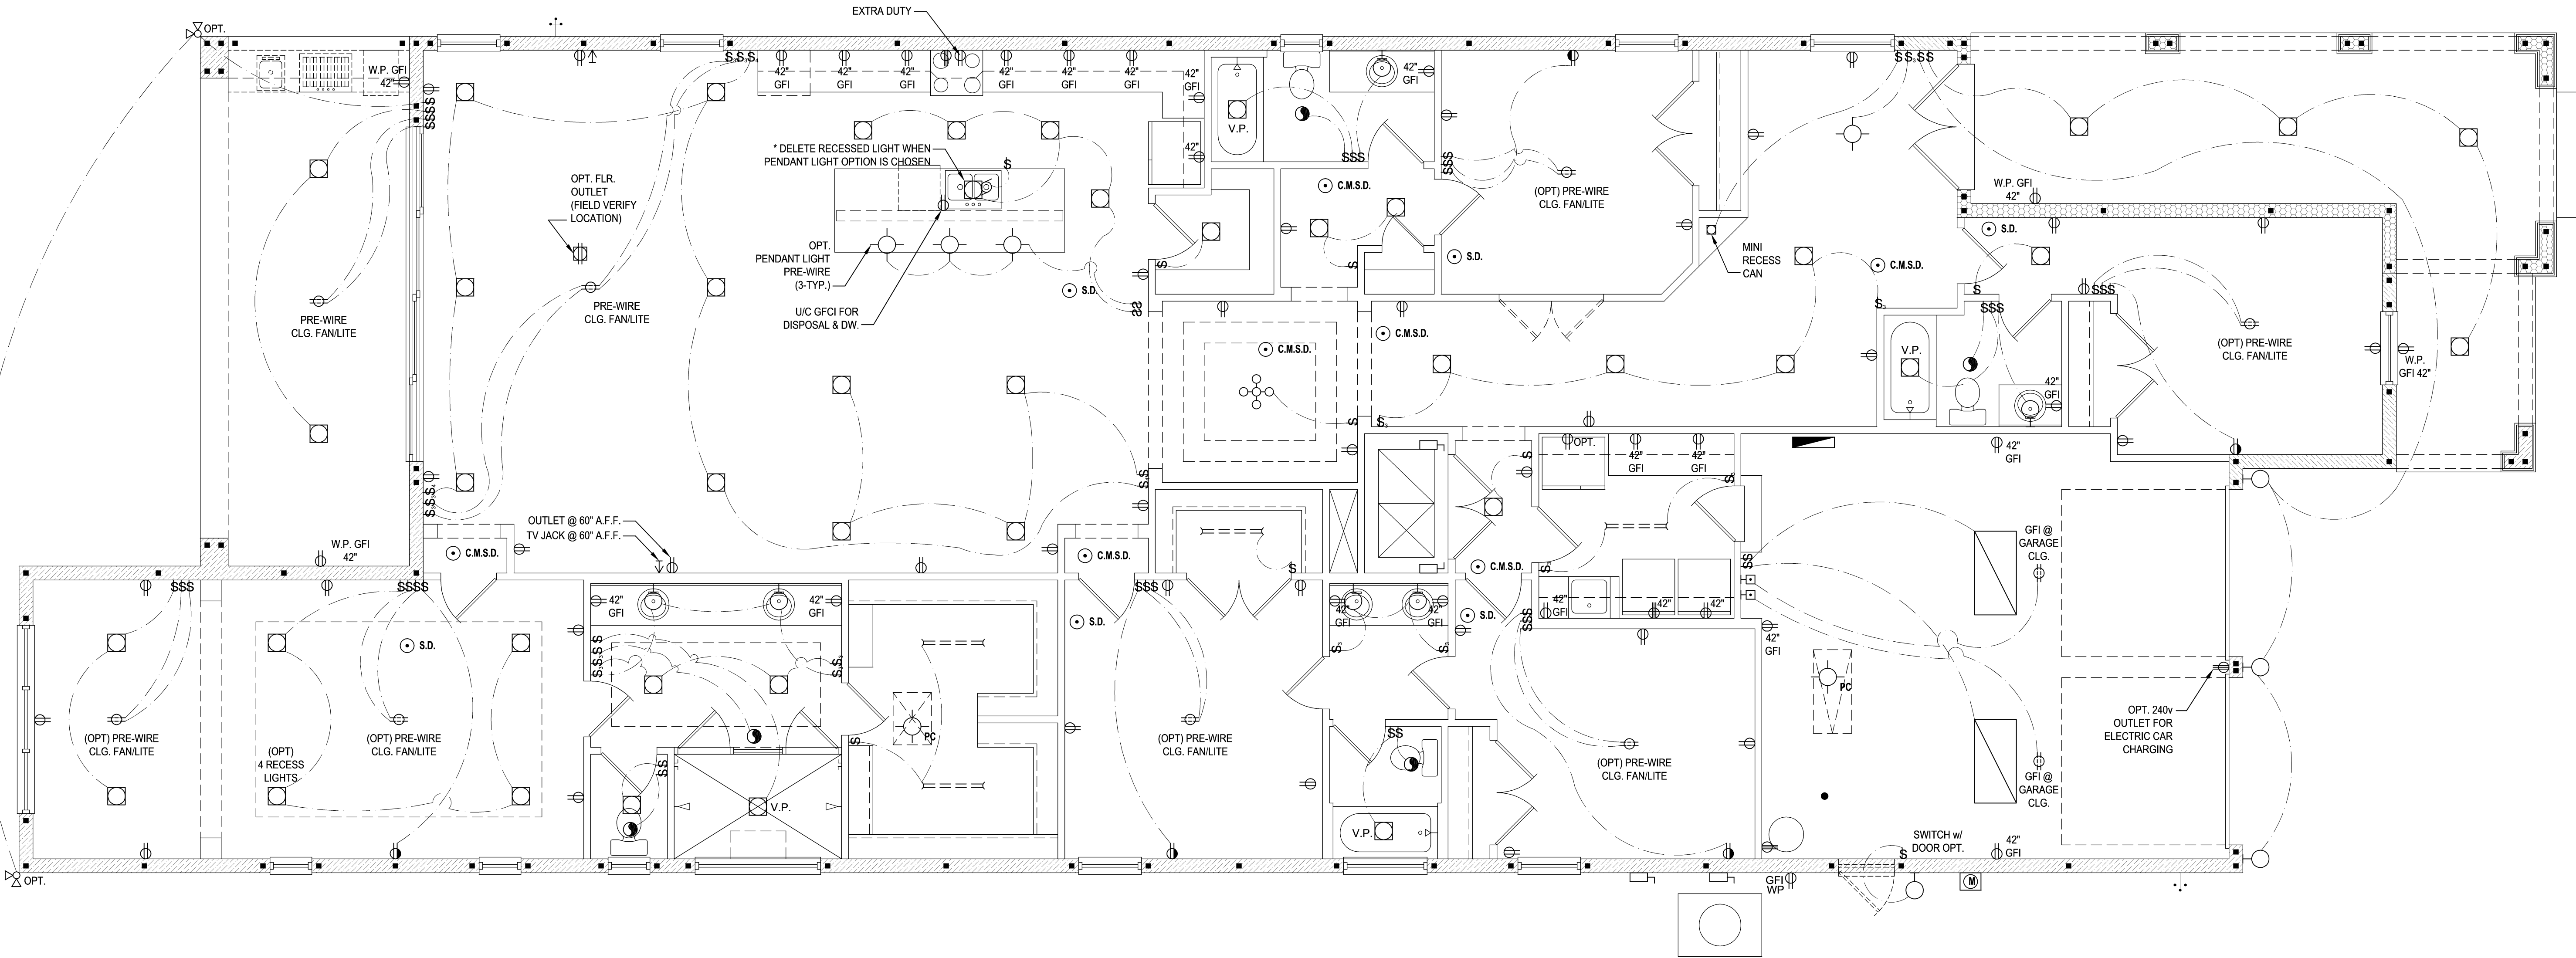
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GENERAL NOTES KEY:			ELECTRICAL KEY:			
1. BUILDER TO VERIFY EXACT LOCATION OF FLOOR OUTLETS IN FIELD.	9. OUTLETS LOCATED IN THE LAUNDRY ARE TO BE GFCI AND AFCI PROTECTED.	<b>NOTES:</b> <ul style="list-style-type: none"><li>THIS DIAGRAMMATIC PLAN IS INTENDED TO SHOW LIGHTING AND CONVENIENCE OUTLETS ONLY. IT IS THE ELECTRICAL CONTRACTORS RESPONSIBILITY TO VERIFY THE REQUIREMENT AND LOCATIONS OF ALL ELECTRICAL EQUIPMENT, (INCLUDING KITCHEN EQUIPMENT) AND PROVIDE AND INSTALL COMPLETE ELECTRICAL SERVICE AS REQUIRED PER NFPA, NEC, FBC CODES AND ALL REIGNING MUNICIPALITY CODES, STANDARDS AND ORDINANCES.</li><li>LOCATION OF FIXTURES AND / OR OUTLETS ARE SUGGESTED LOCATIONS AND MEET MOST LOCAL CODE REQUIREMENTS. ADDITIONS OR ADJUSTMENTS MAY BE MADE BETWEEN THE OWNER AND BUILDER IN THE FIELD.</li><li>ALL ELECTRICAL WORK AND APPLIANCES ARE IN FULL COMPLIANCE WITH N.E.P.A., N.E.C., F.B.C. 6TH EDITION (2017) RESIDENTIAL, AND ALL APPLICABLE LOCAL STANDARDS, CODES, AND ORDINANCES.</li><li>VARIOUS SYMBOLS ON ELECTRICAL LEGEND MAY OR MAY NOT BE USED ON THIS PLAN.</li></ul>	CEILING MOUNTED LIGHT	FLOOR RECEPTACLE	CHIME	FLUSH MOUNT FLUORESCENT LIGHT
2. ALL OUTLETS ARE TO BE AFCI PROTECTED.			PULL CHAIN LIGHT	PRE-WIRE FOR CLG. FAN	FAN / LIGHT COMBINATION	
3. ALL 15A AND 20A 120V BRANCH CIRCUITS WILL BE AFCI PROTECTED.			RECESSED LIGHT	GFI	DISCONNECT SWITCH	GARBAGE DISPOSAL MOTOR
4. ALL 15A AND 20A 120V BRANCH CIRCUITS LOCATED IN THE GARAGE AND LAUNDRY WILL BE GFCI PROTECTED.			WALL MOUNTED LIGHT	WALL SWITCH	ELECTRICAL METER	SPEAKER
5. ALL GARAGE BAYS WILL HAVE DEDICATED GFCI OUTLET.			WALL WASH RECESSED	3-WAY SWITCH	SMOKE DETECTOR	JUNCTION BOX
6. ALL OUTLETS LOCATED IN THE KITCHEN AND BATHROOMS ARE TO BE GFCI PROTECTED.			DUPLEX RECEPTACLE	DIMMER SWITCH	CARBON MONOXIDE / SMOKE DETECTOR	L.V.
7. DW. AND GARBAGE DISPOSAL ARE TO BE GFCI PROTECTED.			220 V RECEPTACLE	TELEPHONE JACK	CEILING FAN	V.P.
8. EXCEPTIONS TO THE GFCI STIPULATION WILL BE ALLOWED ONLY IF ALLOWED PER CURRENT NFPA / NEC.			1/2 HOT, 1/2 SWITCHED	CABLE JACK	WALL SCONCE	A.F.
			WATER PROOF RECEPTACLE	PRE-WIRE GARAGE DOOR OPENER	CHANDELIER	
				FLUORESCENT LIGHT	SPOT LIGHT	
				ELECTRICAL PANEL		



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## 200 AMP ELECTRICAL RISER



## Electrical Plan "A"

(Opt. Sitting Room)

SCALE: 1/8" = 1'-0" (12x18) 1/4" = 1'-0" (24x36)

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5200 Vineland Rd. Suite #200  
Orlando, FL 32811  
Phone: (407) 525-3000

ISSUE DATE: 00/00/0000

REVISIONS:

PROJECT: 00-0000

SCALE: AS NOTED

DRAWN BY: C.C.

DESIGNED BY: MJS

ELECTRICAL PLAN

07.A1


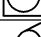
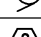
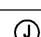




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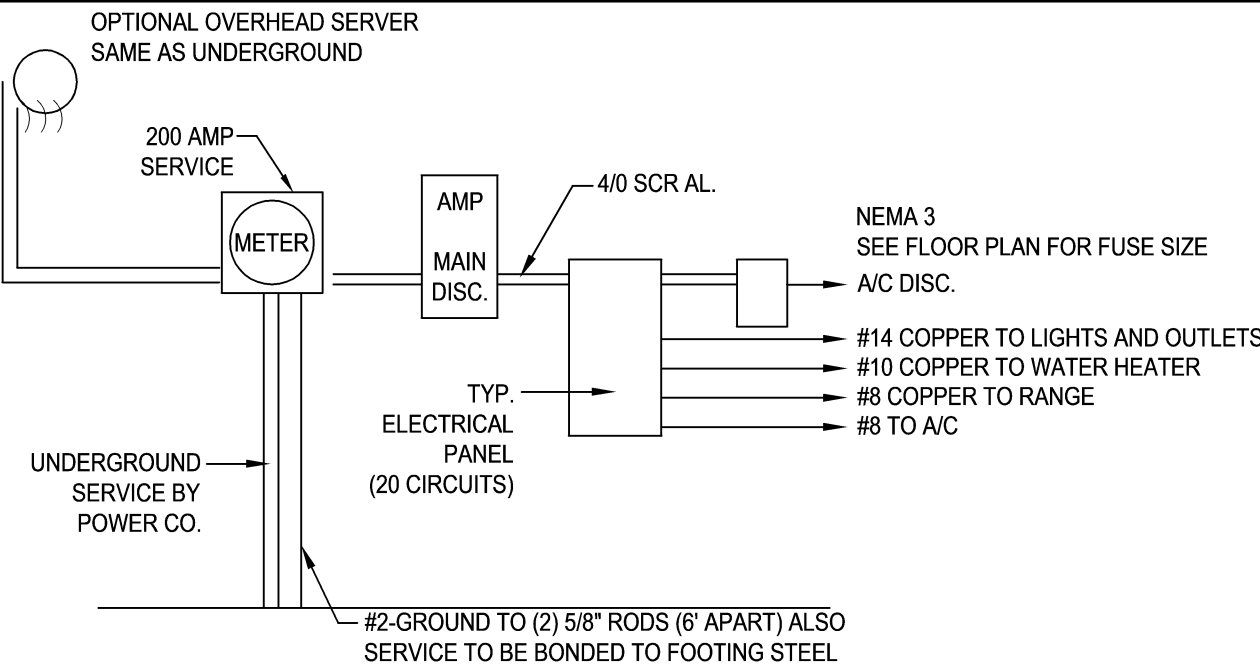
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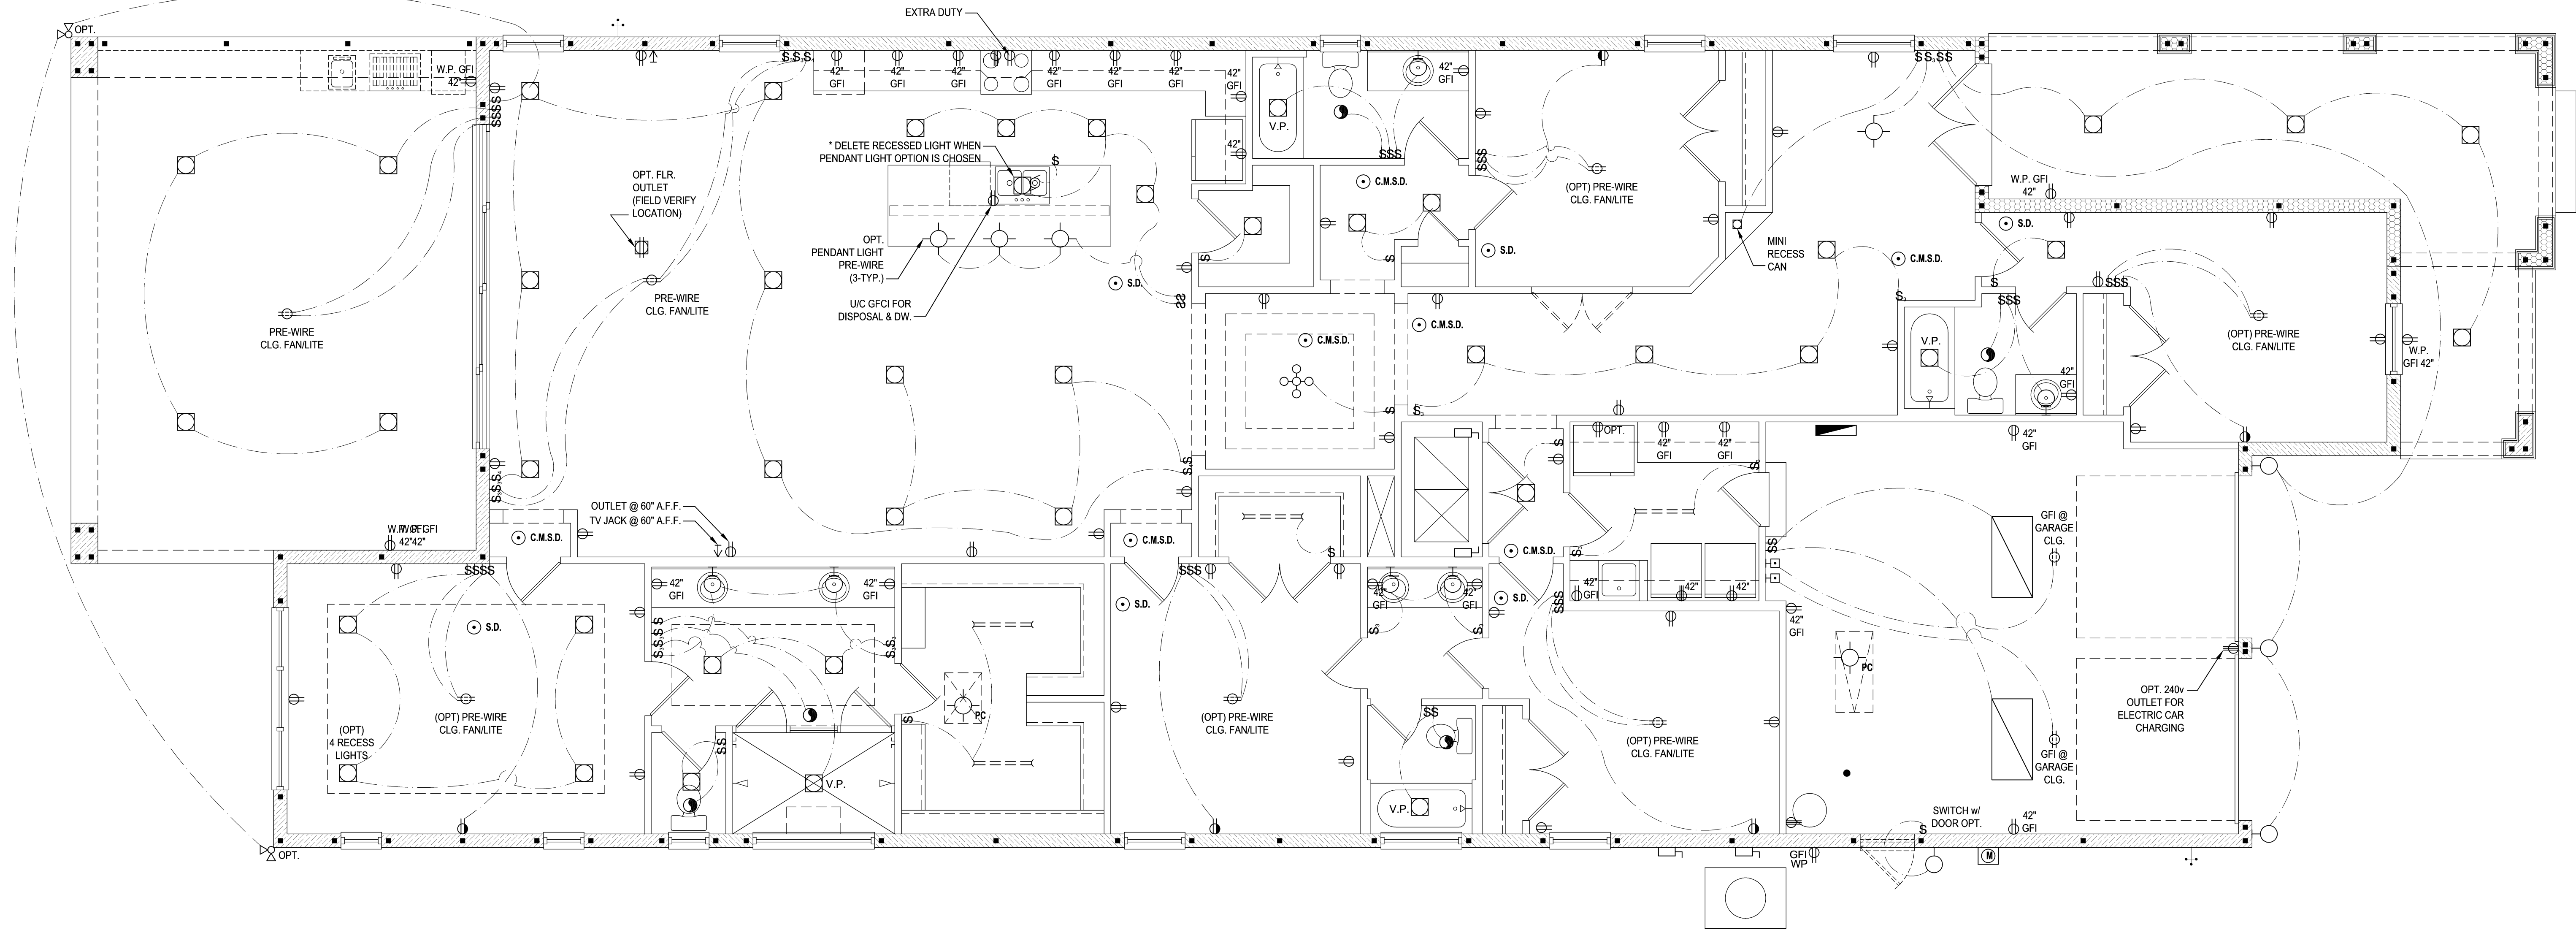
	CEILING MOUNTED LIGHT		FLOOR RECEPTACLE		CHIME
	PULL CHAIN LIGHT		PRE-WIRE FOR CLG. FAN		DOOR BELL / GARAGE DOOR SWITCH
	RECESSED LIGHT		GROUND FAULT INTERRUPT		DISCONNECT SWITCH
	WALL MOUNTED LIGHT		WALL SWITCH		ELECTRICAL METER
	DUPLEX RECEPTACLE		3-WAY SWITCH		S.M.O.K.E. DETECTOR
	220 V RECEPTACLE		DIMMER SWITCH		CARBON MONOXIDE / SMOKE DETECTOR
	1/2 HOT, 1/2 SWITCHED		TELEPHONE JACK		CEILING FAN
	WATER PROOF RECEPTACLE		CABLE JACK		WALL SCONCE
			PRE-WIRE GARAGE DOOR OPENER		CHANDELIER
			FLUORESCENT LIGHT		SPOT LIGHT
			ELECTRICAL PANEL		

	FLUSH MOUNT FLUORESCENT LIGHT
	FAN / LIGHT COMBINATION
	GARBAGE DISPOSAL MOTOR
	SPEAKER
	JUNCTION BOX
	LOW VOLTAGE
	VAPOR PROOF
	ARC FAULT PROTECTION



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## 200 AMP ELECTRICAL RISER

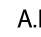

GENERAL NOTES KEY:

1. BUILDER TO VERIFY EXACT LOCATION OF FLOOR OUTLETS IN FIELD.

2. ALL OUTLETS ARE TO BE AFCI PROTECTED.

3. ALL 15A AND 20A 120V BRANCH CIRCUITS WILL BE AFCI PROTECTED.

4. ALL 15A AND 20A 120V BRANCH CIRCUITS LOCATED IN THE GARAGE AND LAUNDRY WILL BE GFCI PROTECTED.

5. ALL GARAGE BAYS WILL HAVE DEDICATED GFCI OUTLET.

6. ALL OUTLETS LOCATED IN THE KITCHEN AND BATHROOMS ARE TO BE GFCI PROTECTED.

7. DW. AND GARBAGE DISPOSAL ARE TO BE GFCI PROTECTED.

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9. OUTLETS LOCATED IN THE LAUNDRY ARE TO BE GFCI AND AFCI PROTECTED.

10. OUTLETS LOCATED WITHIN 6'-0" OF A WET AREA ARE TO BE GFCI PROTECTED.

11. ALL OUTLETS OVER COUNTERTOPS TO BE 42" A.F.F. (U.N.O.).

12. ALL SMOKE/CARBON MONOXIDE DETECTORS ARE TO BE HARD WIRED, INTERCONNECTED AND AFCI PROTECTED.


13. 8'-0" HEIGHT VANITY LIGHTS IN MASTER BATHROOM AND 7'-0" IN ALL OTHER BATHROOMS.

14. IN AREAS SPECIFIED IN SECTION E3901.1, 125-VOLT, 15- AND 20-AMPERE RECEPTACLES SHALL BE LISTED TAMPER-RESISTANT RECEPTACLES.

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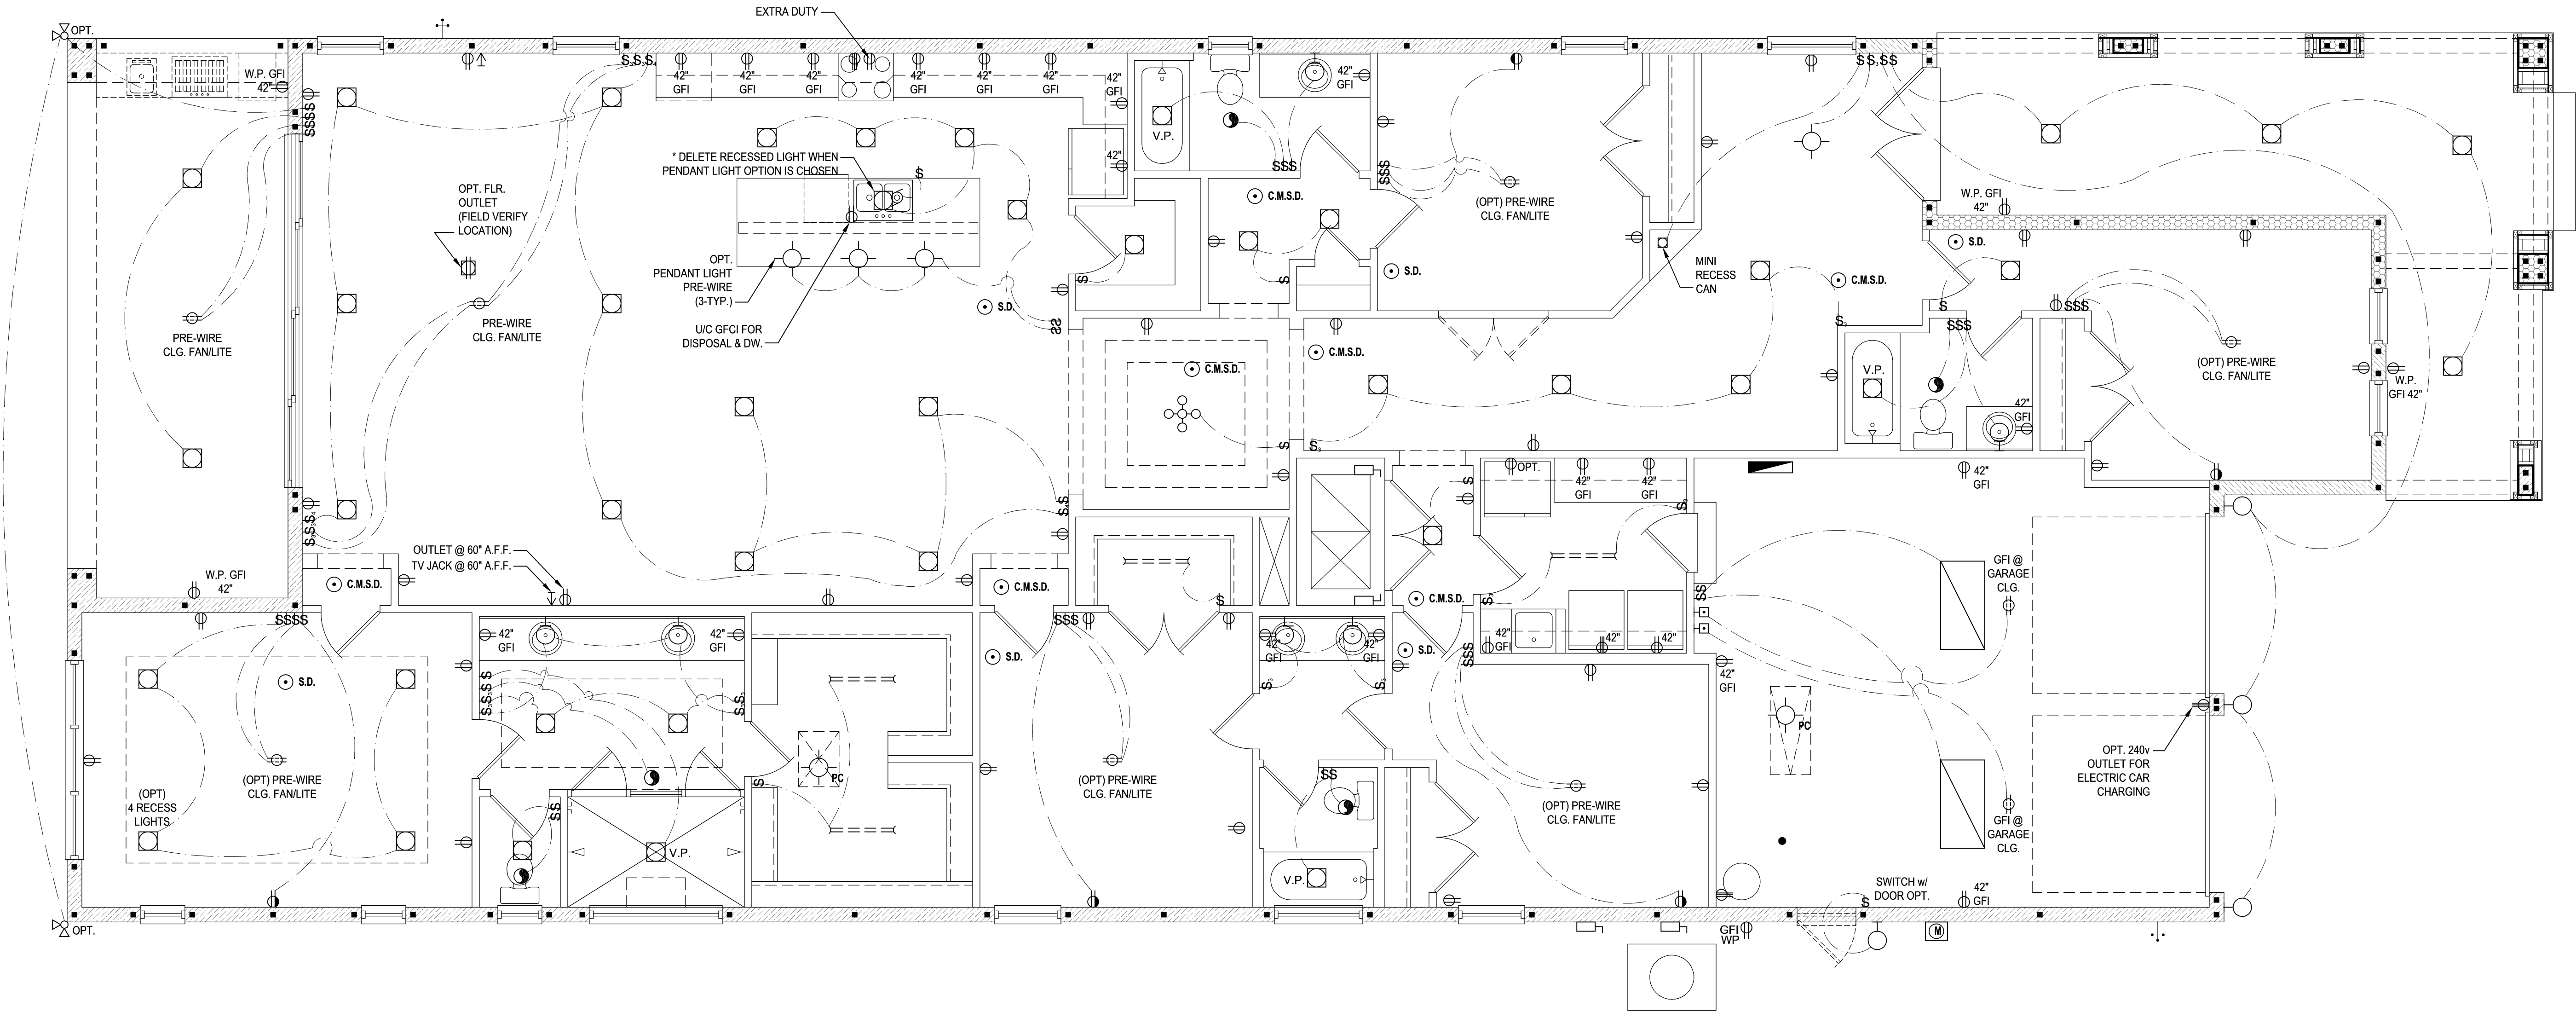
ELECTRICAL KEY:

	CEILING MOUNTED LIGHT		FLOOR RECEPTACLE		CHIME		FLUSH MOUNT FLUORESCENT LIGHT
	PULL CHAIN LIGHT		PRE-WIRE FOR CLG. FAN		DOOR BELL / GARAGE DOOR SWITCH		FAN / LIGHT COMBINATION
	RECESSED LIGHT		GROUND FAULT INTERRUPT		DISCONNECT SWITCH		GARBAGE DISPOSAL MOTOR
	WALL MOUNTED LIGHT		WALL SWITCH		ELECTRICAL METER		SPEAKER
	WALL WASH RECESSED		3-WAY SWITCH		SMOKE DETECTOR		JUNCTION BOX
	DUPLEX RECEPTACLE		DIMMER SWITCH		CARBON MONOXIDE / SMOKE DETECTOR		LOW VOLTAGE
	220 V RECEPTACLE		TELEPHONE JACK		CEILING FAN		VAPOR PROOF
	1/2 HOT, 1/2 SWITCHED		CABLE JACK		WALL SCONCE		ARC FAULT PROTECTION
	WATER PROOF RECEPTACLE		PRE-WIRE GARAGE DOOR OPENER		CHANDELIER		
			FLUORESCENT LIGHT		SPOT LIGHT		
			ELECTRICAL PANEL				

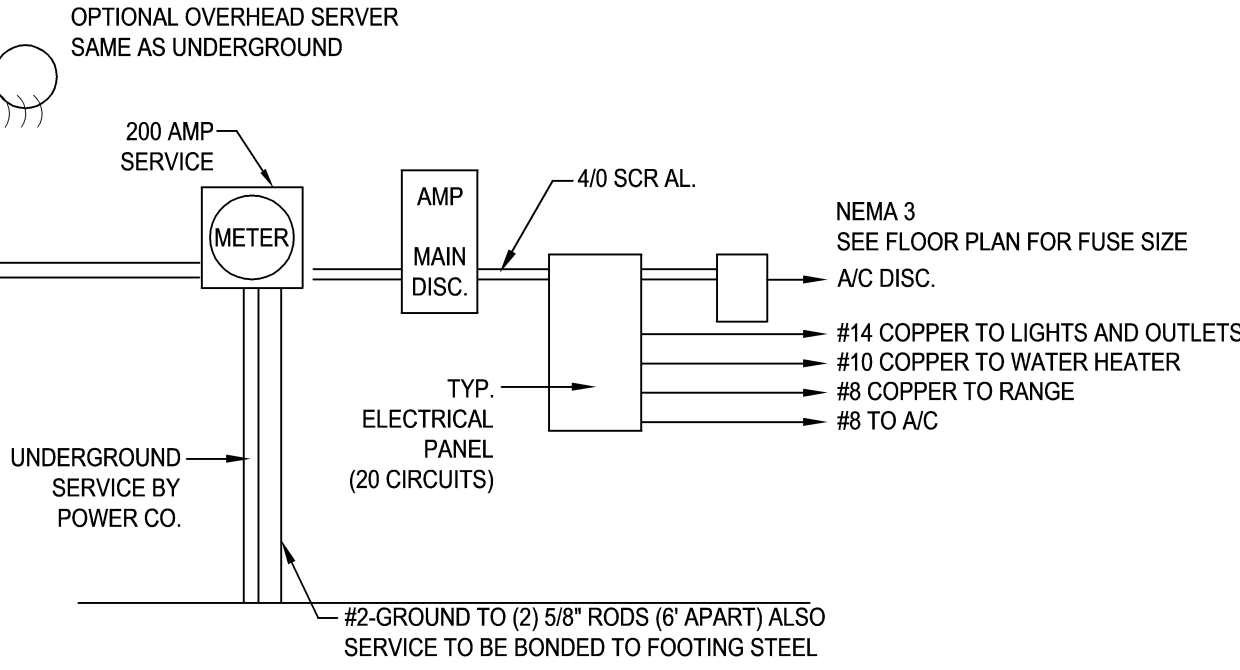

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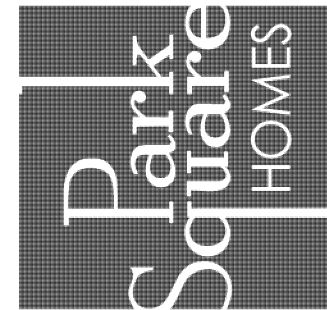
200 AMP ELECTRICAL RISER



Electrical Plan "B"

(Standard)

SCALE: 1/8" = 1'-0" (12x18) 1/4" = 1'-0" (24x36)



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815 Orienta Ave. Suite# 1040  
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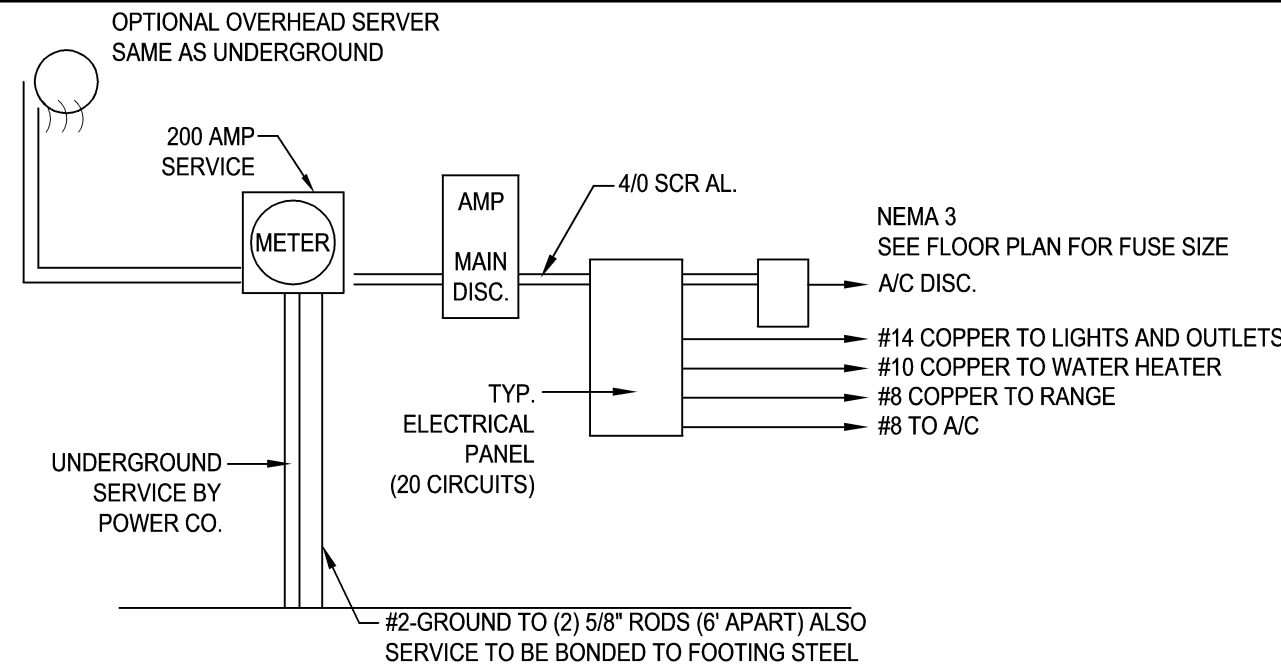


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ELECTRICAL PLAN


07.B

GENERAL NOTES KEY:			ELECTRICAL KEY:			
1. BUILDER TO VERIFY EXACT LOCATION OF FLOOR OUTLETS IN FIELD.	9. OUTLETS LOCATED IN THE LAUNDRY ARE TO BE GFCI AND AFCI PROTECTED.	<b>NOTES:</b> <ul style="list-style-type: none"><li>THIS DIAGRAMMATIC PLAN IS INTENDED TO SHOW LIGHTING AND CONVENIENCE OUTLETS ONLY. IT IS THE ELECTRICAL CONTRACTORS RESPONSIBILITY TO VERIFY THE REQUIREMENT AND LOCATIONS OF ALL ELECTRICAL EQUIPMENT, (INCLUDING KITCHEN EQUIPMENT) AND PROVIDE AND INSTALL COMPLETE ELECTRICAL SERVICE AS REQUIRED PER NFPA, NEC, FBC CODES AND ALL REIGNING MUNICIPALITY CODES, STANDARDS AND ORDINANCES.</li><li>LOCATION OF FIXTURES AND / OR OUTLETS ARE SUGGESTED LOCATIONS AND MEET MOST LOCAL CODE REQUIREMENTS. ADDITIONS OR ADJUSTMENTS MAY BE MADE BETWEEN THE OWNER AND BUILDER IN THE FIELD.</li><li>ALL ELECTRICAL WORK AND APPLIANCES ARE IN FULL COMPLIANCE WITH N.E.P.A., N.E.C., F.B.C. 6TH EDITION (2017) RESIDENTIAL, AND ALL APPLICABLE LOCAL STANDARDS, CODES, AND ORDINANCES.</li><li>VARIOUS SYMBOLS ON ELECTRICAL LEGEND MAY OR MAY NOT BE USED ON THIS PLAN.</li></ul>	CEILING MOUNTED LIGHT	FLOOR RECEPTACLE	CHIME	FLUSH MOUNT FLUORESCENT LIGHT
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5. ALL GARAGE BAYS WILL HAVE DEDICATED GFCI OUTLET.			WALL WASH RECESSED	3-WAY SWITCH	SMOKE DETECTOR	JUNCTION BOX
6. ALL OUTLETS LOCATED IN THE KITCHEN AND BATHROOMS ARE TO BE GFCI PROTECTED.			DUPLEX RECEPTACLE	DIMMER SWITCH	CARBON MONOXIDE / SMOKE DETECTOR	L.V.
7. DW. AND GARBAGE DISPOSAL ARE TO BE GFCI PROTECTED.			220 V RECEPTACLE	TELEPHONE JACK	CEILING FAN	V.P.
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			WATER PROOF RECEPTACLE	PRE-WIRE GARAGE DOOR OPENER	CHANDELIER	
				FLUORESCENT LIGHT	SPOT LIGHT	
				ELECTRICAL PANEL		



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## 200 AMP ELECTRICAL RISER

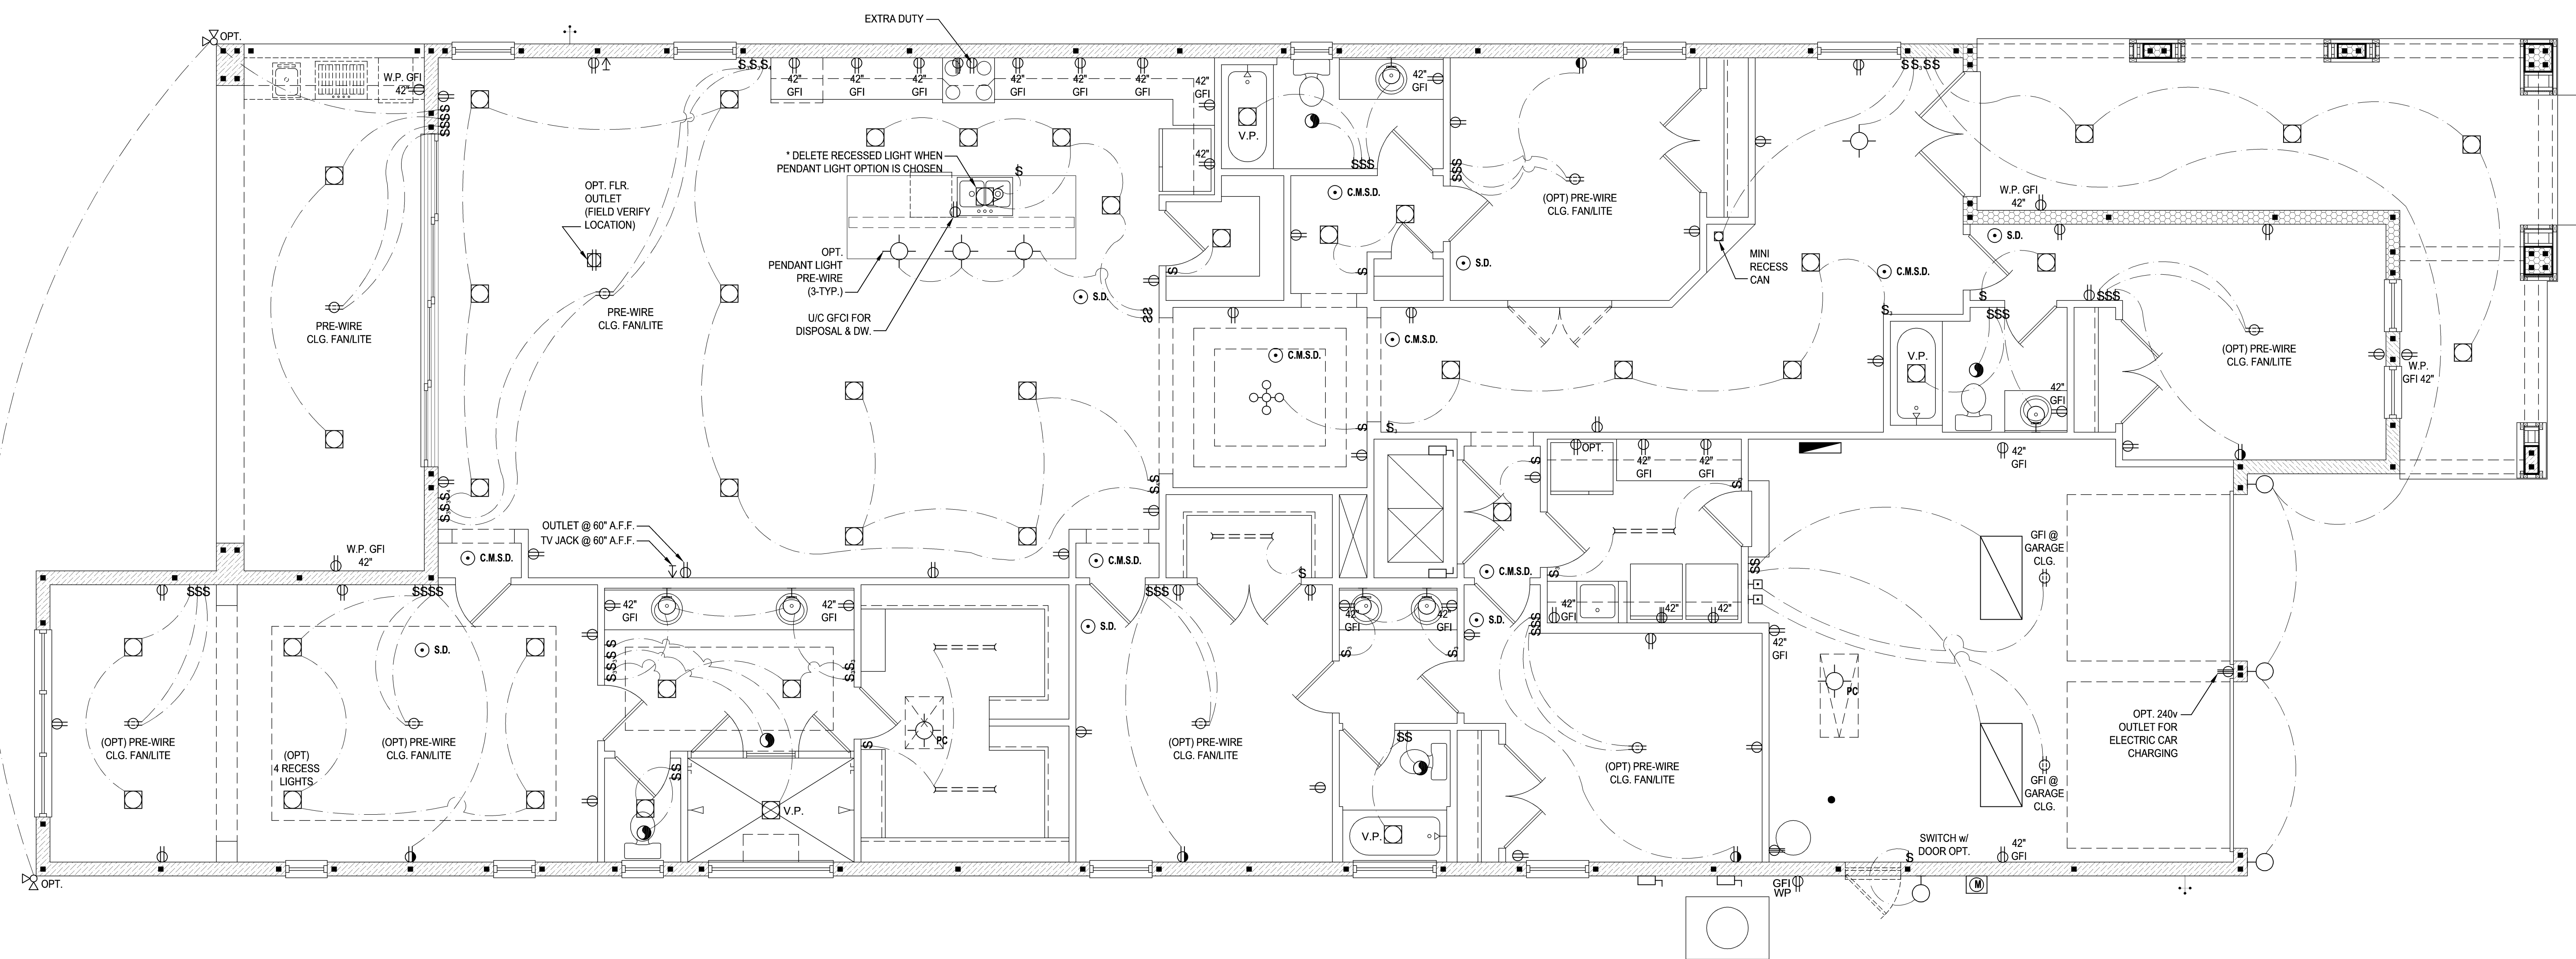

Electrical Plan "B"  
(Opt. Sitting Room)  
SCALE: 1/8" = 1'-0" (12x18) 1/4" = 1'-0" (24x36)

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ISSUE DATE 00/00/0000  
REVISIONS  
PROJECT: 00-0000  
SCALE: AS NOTED  
DRAWN BY: C.C.  
DESIGNED BY: MJS

ELECTRICAL PLAN  
07.B1

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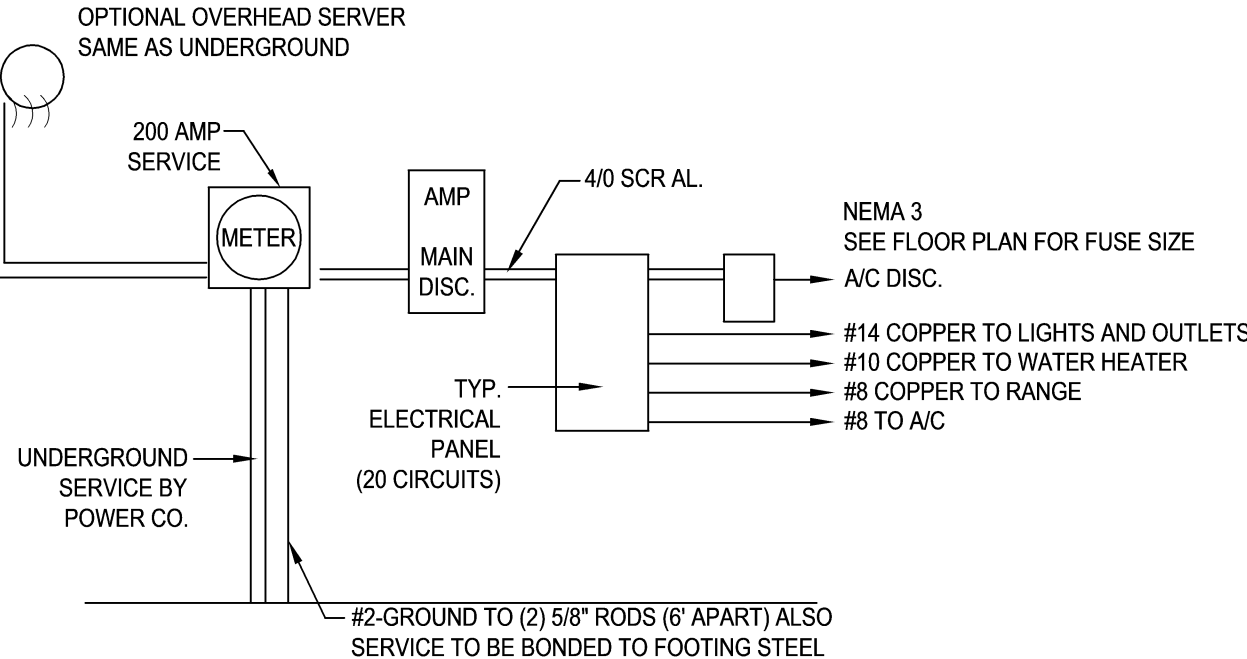
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	PULL CHAIN LIGHT		PRE-WIRE FOR CLG. FAN		DOOR BELL / GARAGE DOOR SWITCH
	RECESSED LIGHT		GROUND FAULT INTERRUPT		DISCONNECT SWITCH
	WALL MOUNTED LIGHT		WALL SWITCH		ELECTRICAL METER
	WALL WASH RECESSED		3-WAY SWITCH		SMOKE DETECTOR
	DUPLEX RECEPTACLE		DIMMER SWITCH		CARBON MONOXIDE / SMOKE DETECTOR
	220 V RECEPTACLE		TELEPHONE JACK		CEILING FAN
	1/2 HOT, 1/2 SWITCHED		CABLE JACK		WALL SCONCE
	WATER PROOF RECEPTACLE		PRE-WIRE GARAGE DOOR OPENER		CHANDELIER
			FLUORESCENT LIGHT		SPOT LIGHT
			ELECTRICAL PANEL		


ELECTRICAL KEY:

	FLUSH MOUNT FLUORESCENT LIGHT
	FAN / LIGHT COMBINATION
	GARBAGE DISPOSAL MOTOR
	SPEAKER
	JUNCTION BOX
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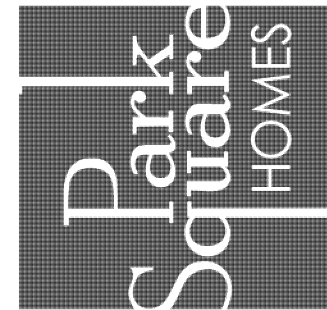
200 AMP ELECTRICAL RISER



Electrical Plan "B"

(Opt. Extended Lanai)
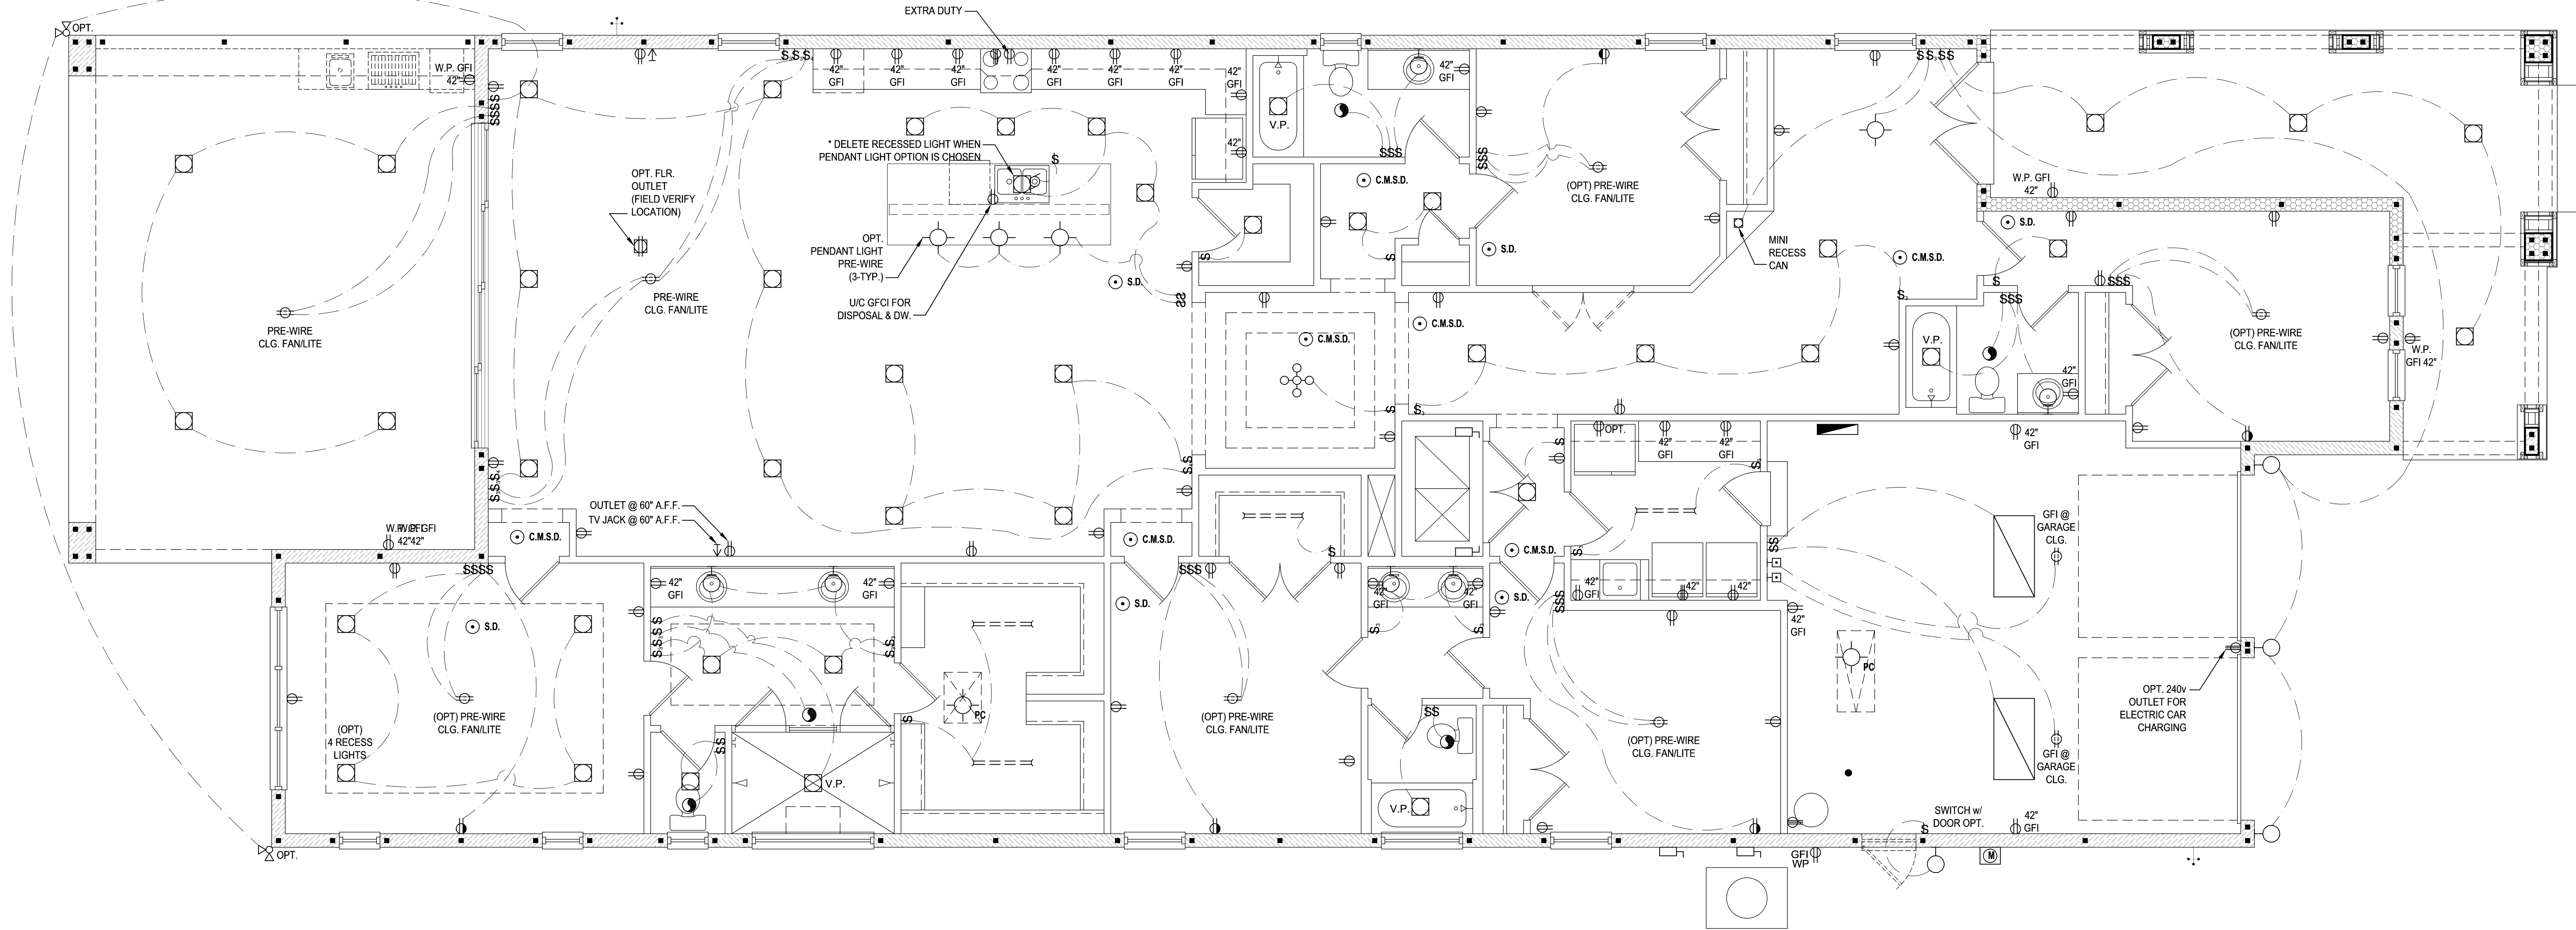
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City, State, Zip







































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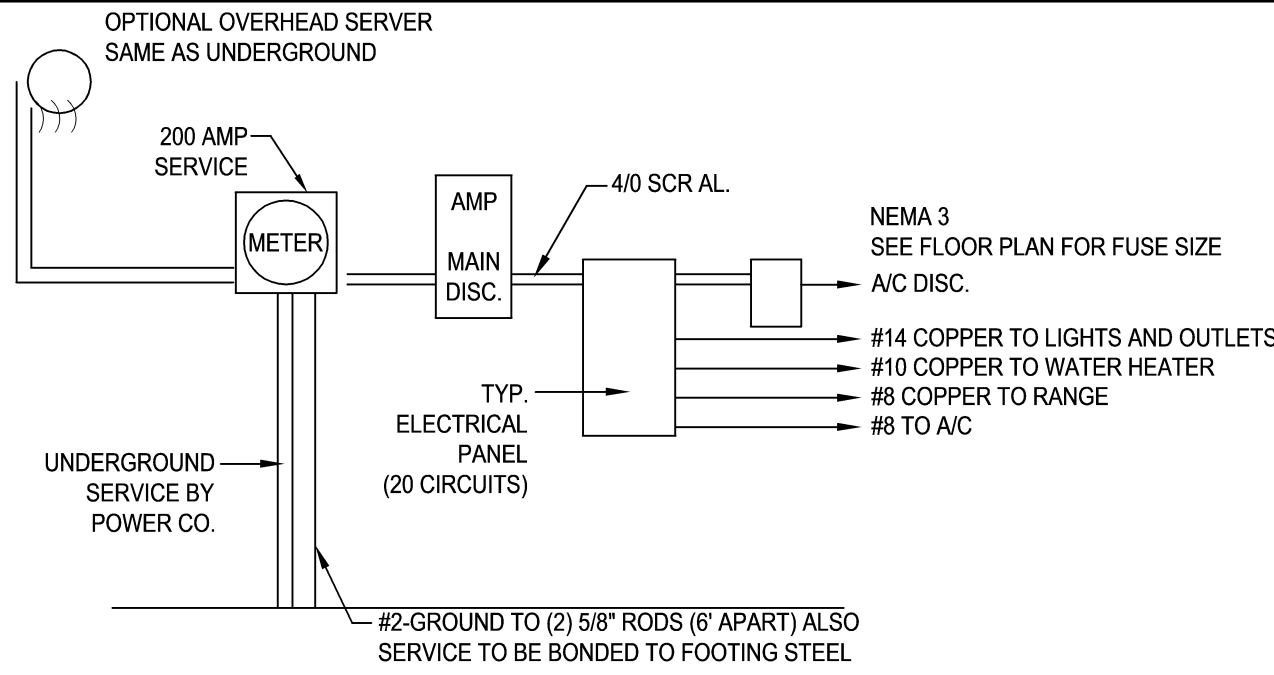
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www.premier-structural.com  
FL CERT. AUTH.: 28113  
FL. PE# 60269



## ELECTRICAL KEY:


- NOTES:**
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  - LOCATION OF FIXTURES AND / OR OUTLETS ARE SUGGESTED ADDITIONS OR ADJUSTMENTS MAY BE MADE BETWEEN THE OWNER AND BUILDER IN THE FIELD.
  - ALL ELECTRICAL WORK AND APPLIANCES ARE IN FULL COMPLIANCE WITH N.F.P.A., N.E.C., F.B.C. 6TH EDITION (2017) RESIDENTIAL, AND ALL APPLICABLE LOCAL STANDARDS, CODES, AND ORDINANCES.
  - VARIOUS SYMBOLS ON ELECTRICAL LEGEND MAY OR MAY NOT BE USED ON THIS PLAN.

	CEILING MOUNTED LIGHT		FLOOR RECEPTACLE		CHIME		FLUSH MOUNT FLUORESCENT LIGHT
	PULL CHAIN LIGHT		PRE-WIRE FOR CLG. FAN		DOOR BELL / GARAGE DOOR SWITCH		FAN / LIGHT COMBINATION
	RECESSED LIGHT		GROUND FAULT INTERRUPT		DISCONNECT SWITCH		GARBAGE DISPOSAL MOTOR
	WALL MOUNTED LIGHT		WALL SWITCH		ELECTRICAL METER		SPEAKER
	WALL WASH RECESSED		3-WAY SWITCH		S.M.O.K.E. DETECTOR		JUNCTION BOX
	DUPLEX RECEPTACLE		DIMMER SWITCH		CARBON MONOXIDE / SMOKE DETECTOR		LOW VOLTAGE
	220 V RECEPTACLE		TELEPHONE JACK		CEILING FAN		VAPOR PROOF
	1/2 HOT, 1/2 SWITCHED		CABLE JACK		WALL SCONCE		ARC FAULT PROTECTION
	WATER PROOF RECEPTACLE		PRE-WIRE GARAGE DOOR OPENER		CHANDELIER		
			FLUORESCENT LIGHT		SPOT LIGHT		
			ELECTRICAL PANEL				



**NOTE:**  
ALL ELECTRICAL WORK AND MATERIAL PROVIDED SHALL COMPLY WITH THE FLORIDA BUILDING CODE. (2017) THE ABOVE ELECTRICAL LAYOUT IS FOR BID PURPOSE ONLY.

## 200 AMP ELECTRICAL RISER

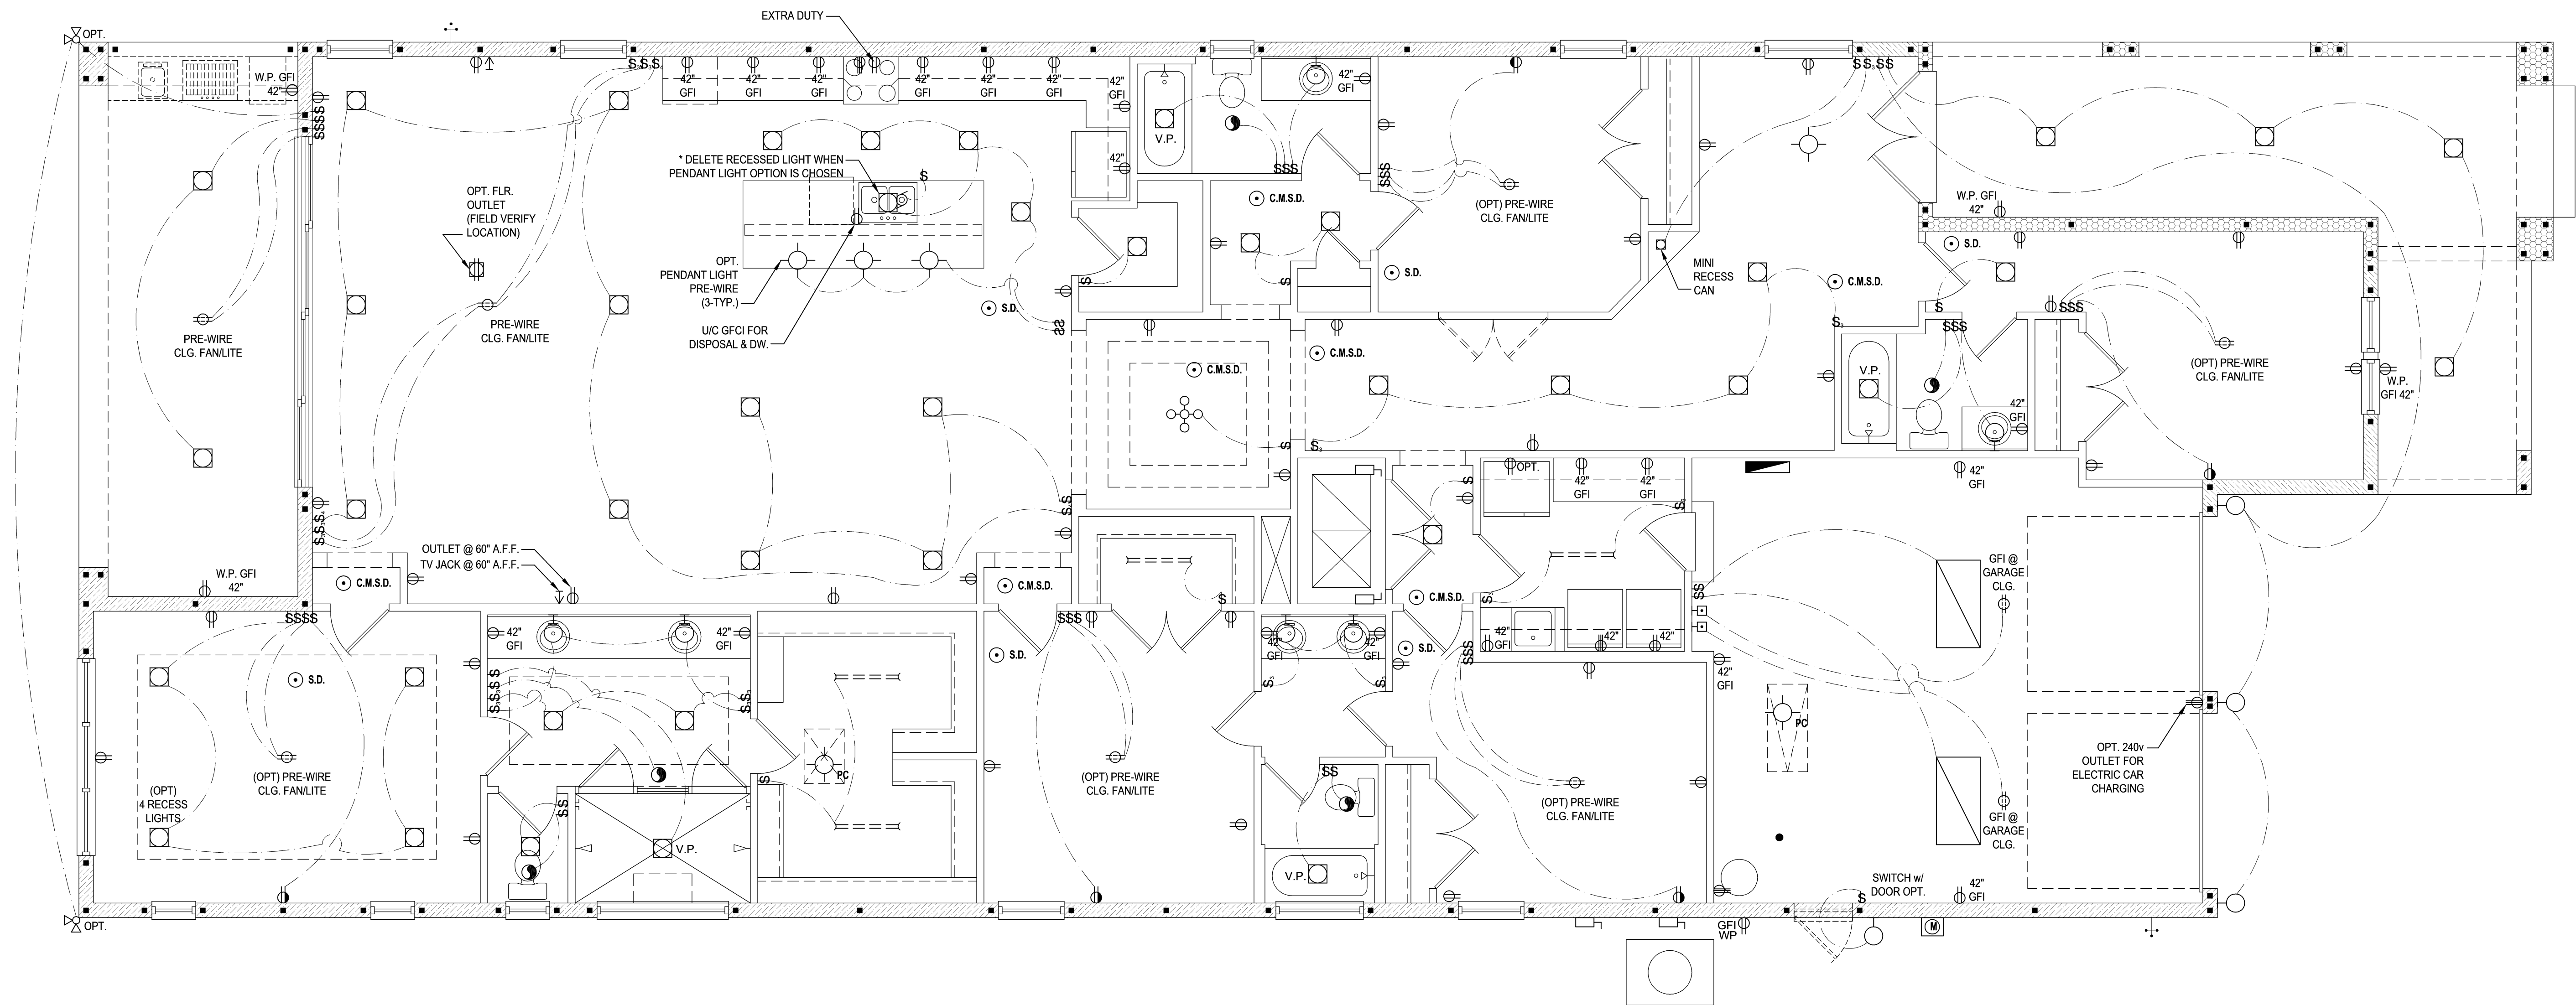

# Electrical Plan "C"

(Standard)

SCALE:  $1/8" = 1'-0"$  (12x18)  $1/4" = 1'-0"$  (24x36)

MS

40-3164  
DORCHESTER

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Enterprises Inc.  
5200 Vineland Rd. Suite #200  
Orlando, Fl. 32811  
Phone: (407) 529-3000



Park Square  
HOMES

ISSUE DATE	00/00/0000
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REVISIONS

PROJECT:	00-0000
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SCALE:	AS NOTED
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DRAWN BY:

DESIGNED BY: MJS

ELECTRICAL PLAN

07.C
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
235 Maitland Avenue S.



**AMS**  
815 Orienta Ave. Suite# 1040  
Altamonte Springs, FL. 32701

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Orlando, Fl. 32811  
Phone: (407) 529-3000



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HOMES

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REVISIONS

PROJECT:	00-0000
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SCALE:

DESIGNED BY: MJS

ELECTRICAL PLAN

07.C
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guez, PE, using a digital signature ILO a raised seal printed copies of this document are not considered Signed & Sealed.  
Signature must be verified on any electronic copies

GENERAL NOTES KEY:

1. BUILDER TO VERIFY EXACT LOCATION OF FLOOR OUTLETS IN FIELD.

2. ALL OUTLETS ARE TO BE AFCI PROTECTED.

3. ALL 15A AND 20A 120V BRANCH CIRCUITS WILL BE AFCI PROTECTED.

4. ALL 15A AND 20A 120V BRANCH CIRCUITS LOCATED IN THE GARAGE AND LAUNDRY WILL BE GFCI PROTECTED.

5. ALL GARAGE BAYS WILL HAVE DEDICATED GFCI OUTLET.

6. ALL OUTLETS LOCATED IN THE KITCHEN AND BATHROOMS ARE TO BE GFCI PROTECTED.

7. DW. AND GARBAGE DISPOSAL ARE TO BE GFCI PROTECTED.

8. EXCEPTIONS TO THE GFCI STIPULATION WILL BE ALLOWED ONLY IF ALLOWED PER CURRENT NFPA / NEC.
9. OUTLETS LOCATED IN THE LAUNDRY ARE TO BE GFCI AND AFCI PROTECTED.

10. OUTLETS LOCATED WITHIN 6'-0" OF A WET AREA ARE TO BE GFCI PROTECTED.

11. ALL OUTLETS OVER COUNTERTOPS TO BE 42" A.F.F. (U.N.O.).

12. ALL SMOKE/CARBON MONOXIDE DETECTORS ARE TO BE HARD WIRED, INTERCONNECTED AND AFCI PROTECTED.

13. 8'-0" HEIGHT VANITY LIGHTS IN MASTER BATHROOM AND 7'-0" IN ALL OTHER BATHROOMS.


14. IN AREAS SPECIFIED IN SECTION E3901.1, 125-VOLT, 15- AND 20-AMPERE RECEPTACLES SHALL BE LISTED TAMPER-RESISTANT RECEPTACLES.

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	CEILING MOUNTED LIGHT		FLOOR RECEPTACLE		CHIME
	PULL CHAIN LIGHT		PRE-WIRE FOR CLG. FAN		DOOR BELL / GARAGE DOOR SWITCH
	RECESSED LIGHT		GROUND FAULT INTERRUPT		DISCONNECT SWITCH
	WALL MOUNTED LIGHT		WALL SWITCH		ELECTRICAL METER
	WALL WASH RECESSED		3-WAY SWITCH		SMOKE DETECTOR
	DUPLEX RECEPTACLE		DIMMER SWITCH		CARBON MONOXIDE / SMOKE DETECTOR
	220 V RECEPTACLE		TELEPHONE JACK		CEILING FAN
	1/2 HOT, 1/2 SWITCHED		CABLE JACK		WALL SCONCE
	WATER PROOF RECEPTACLE		PRE-WIRE GARAGE DOOR OPENER		CHANDELIER
			FLUORESCENT LIGHT		SPOT LIGHT
			ELECTRICAL PANEL		


ELECTRICAL KEY:

	FLUSH MOUNT FLUORESCENT LIGHT
	FAN / LIGHT COMBINATION
	GARBAGE DISPOSAL MOTOR
	SPEAKER
	JUNCTION BOX
	LOW VOLTAGE
	VAPOR PROOF
	ARC FAULT PROTECTION

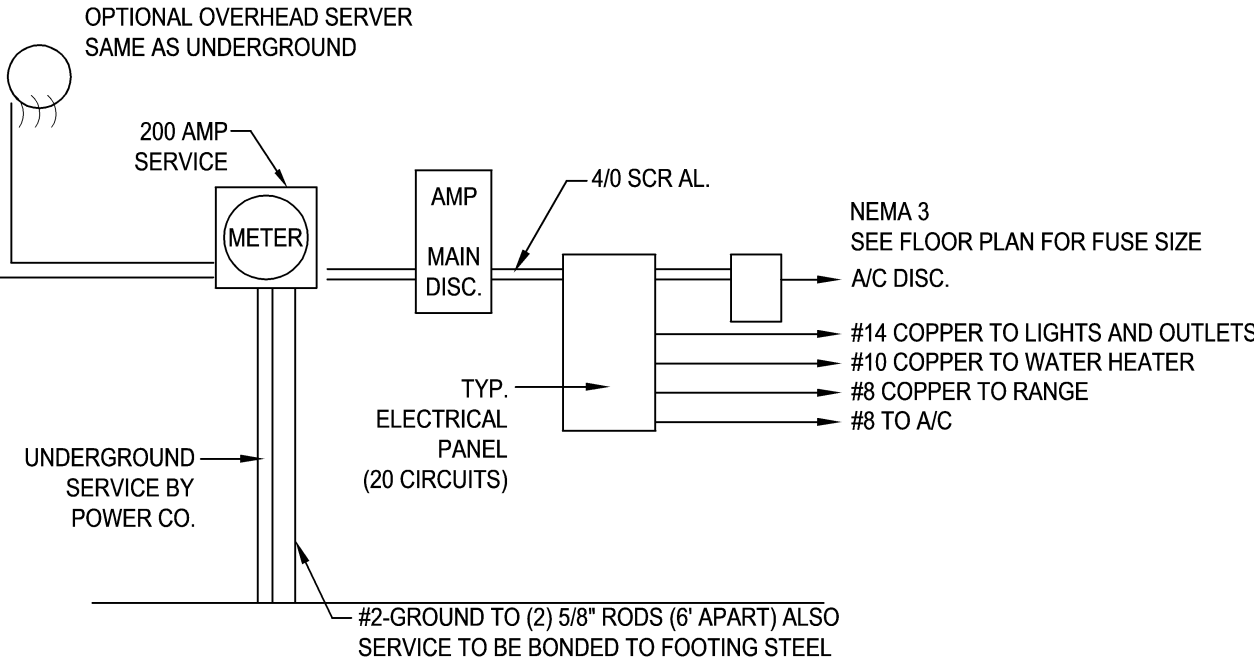

NOTE:  
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200 AMP ELECTRICAL RISER

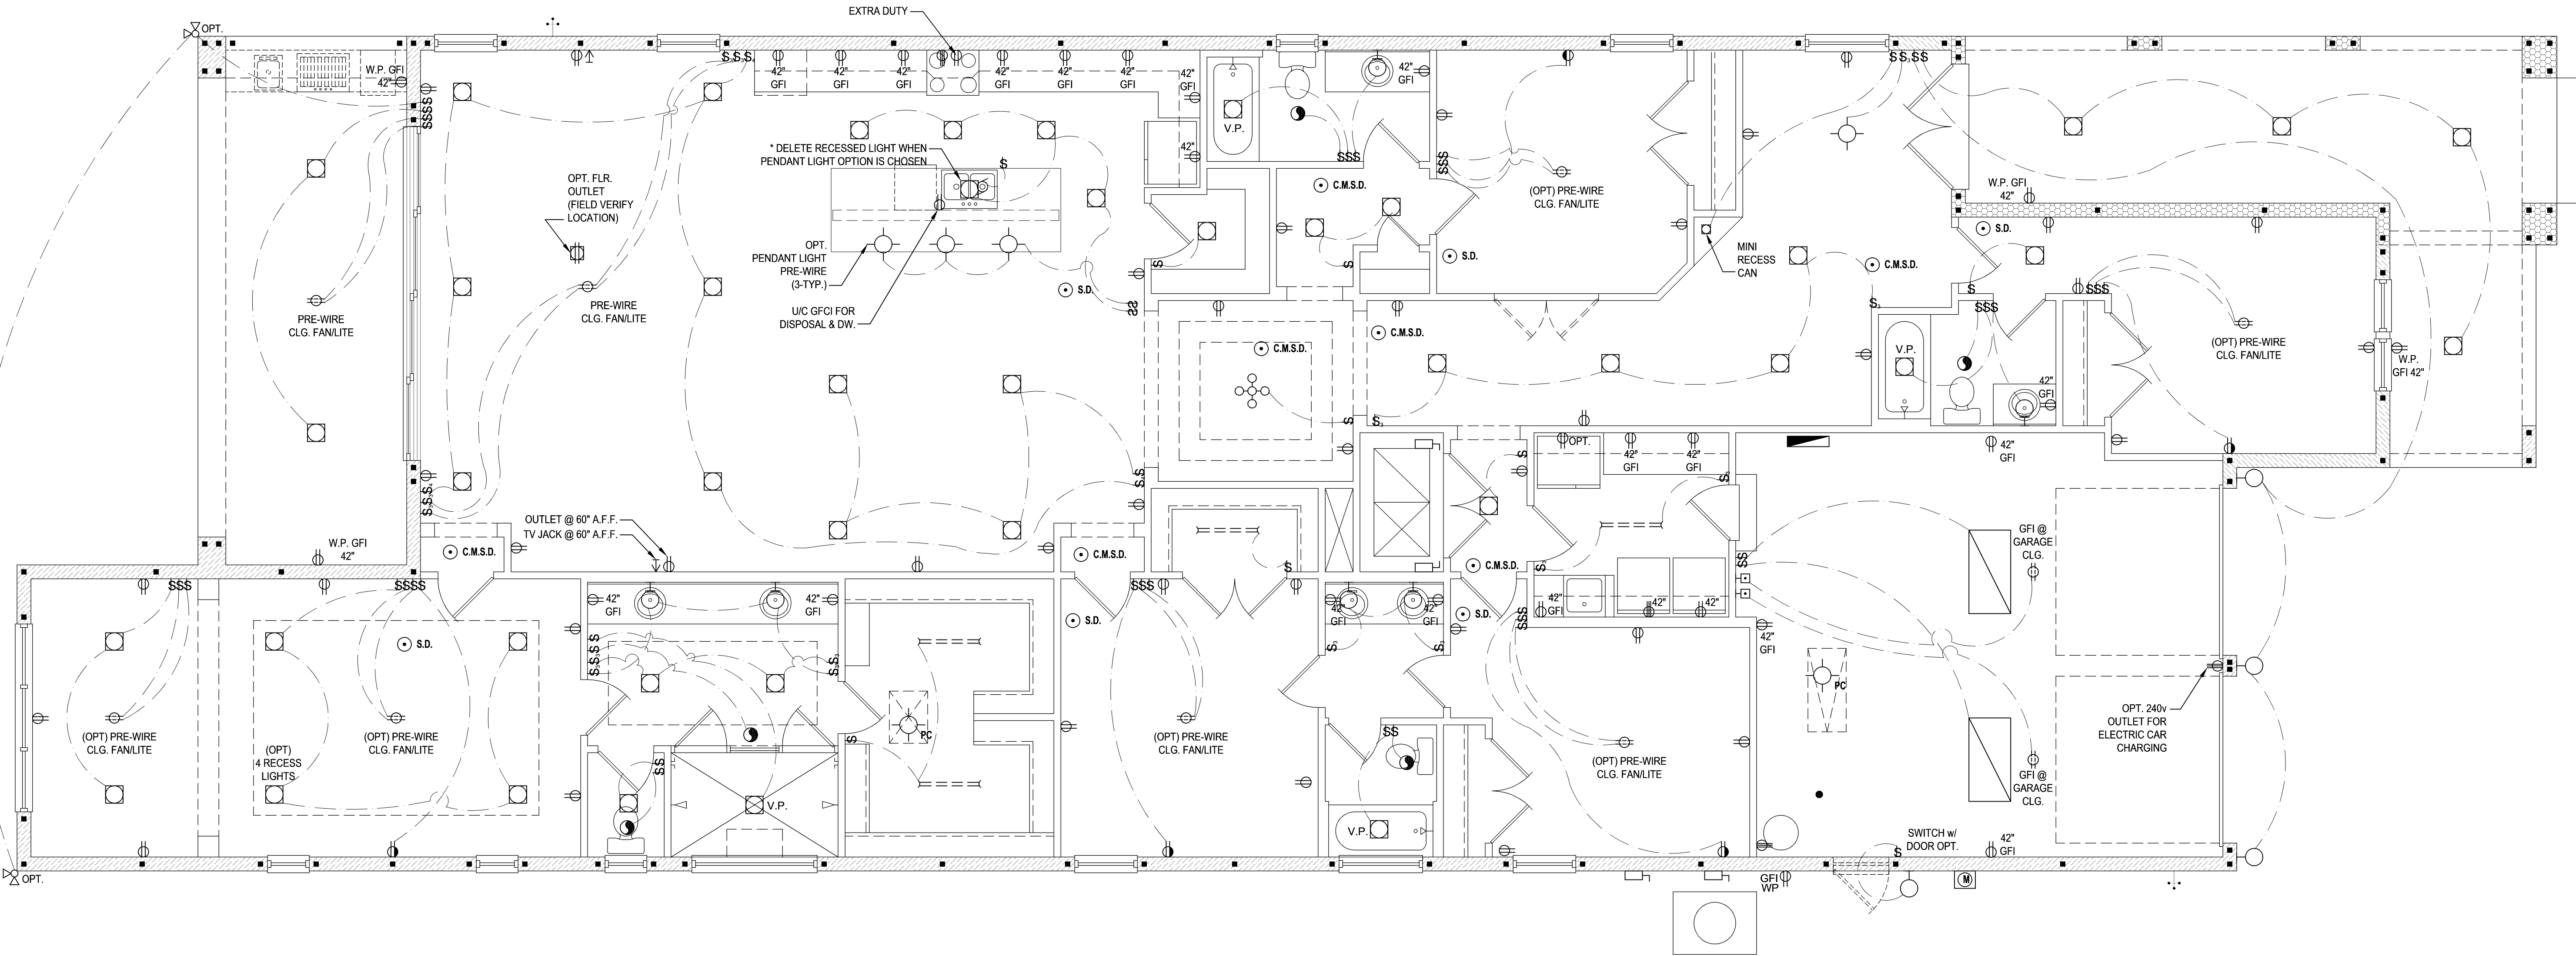


Electrical Plan "C"

(Opt. Sitting Room)

SCALE: 1/8" = 1'-0" (12x18) 1/4" = 1'-0" (24x36)


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REVISIONS	
PROJECT:	00-0000
SCALE:	AS NOTED
DRAWN BY:	C.C.
DESIGNED BY:	MJS

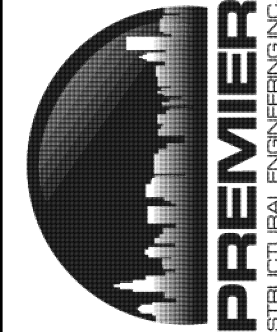ELECTRICAL PLAN

07.C1

GENERAL NOTES KEY:

1. BUILDER TO VERIFY EXACT LOCATION OF FLOOR OUTLETS IN FIELD.
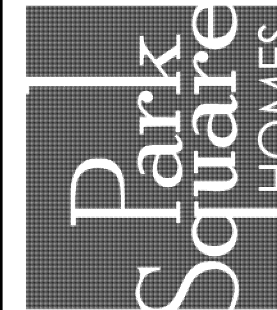
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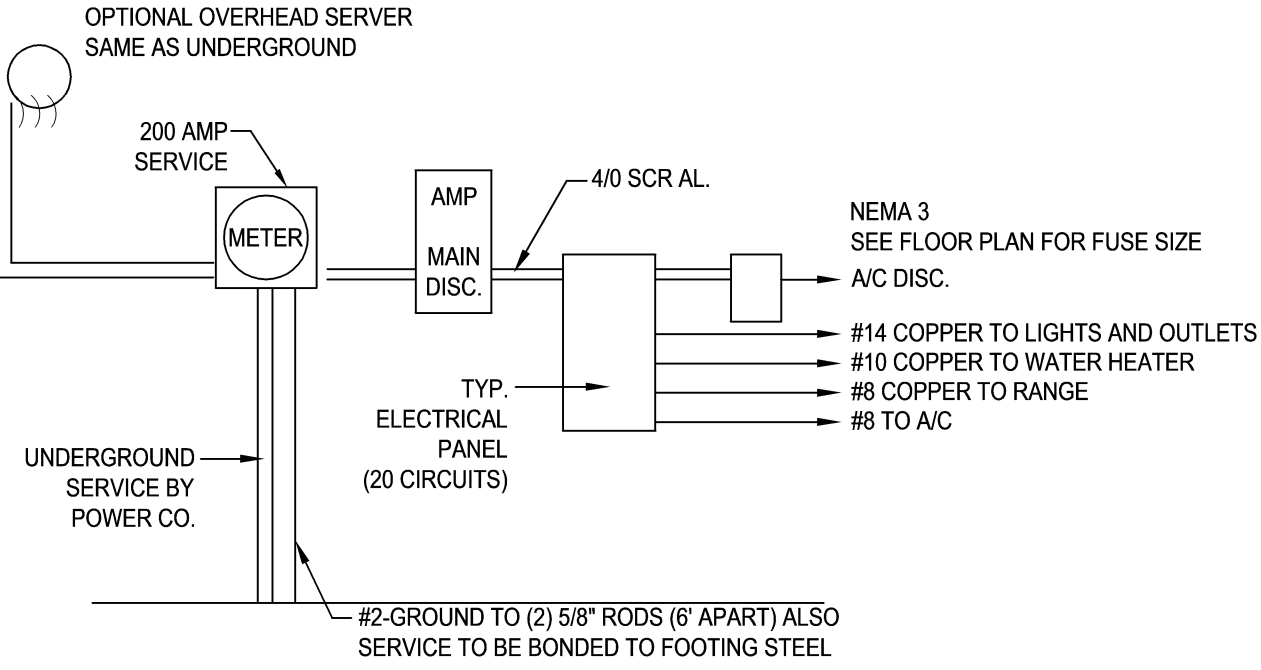
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	PULL CHAIN LIGHT		PRE-WIRE FOR CLG. FAN		DOOR BELL / GARAGE DOOR SWITCH
	RECESSED LIGHT		GROUND FAULT INTERRUPT		DISCONNECT SWITCH
	WALL MOUNTED LIGHT		WALL SWITCH		ELECTRICAL METER
	WALL WASH RECESSED		3-WAY SWITCH		SMOKE DETECTOR
	DUPLEX RECEPTACLE		DIMMER SWITCH		CARBON MONOXIDE / SMOKE DETECTOR
	220 V RECEPTACLE		TELEPHONE JACK		CEILING FAN
	1/2 HOT, 1/2 SWITCHED		CABLE JACK		WALL SCONCE
	WATER PROOF RECEPTACLE		PRE-WIRE GARAGE DOOR OPENER		CHANDELIER
			FLUORESCENT LIGHT		SPOT LIGHT
			ELECTRICAL PANEL		


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	VAPOR PROOF
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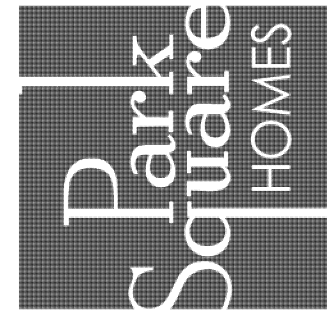
200 AMP ELECTRICAL RISER



Electrical Plan "C"

(Opt. Extended Lanai)

SCALE: 1/8" = 1'-0" (12x18) 1/4" = 1'-0" (24x36)

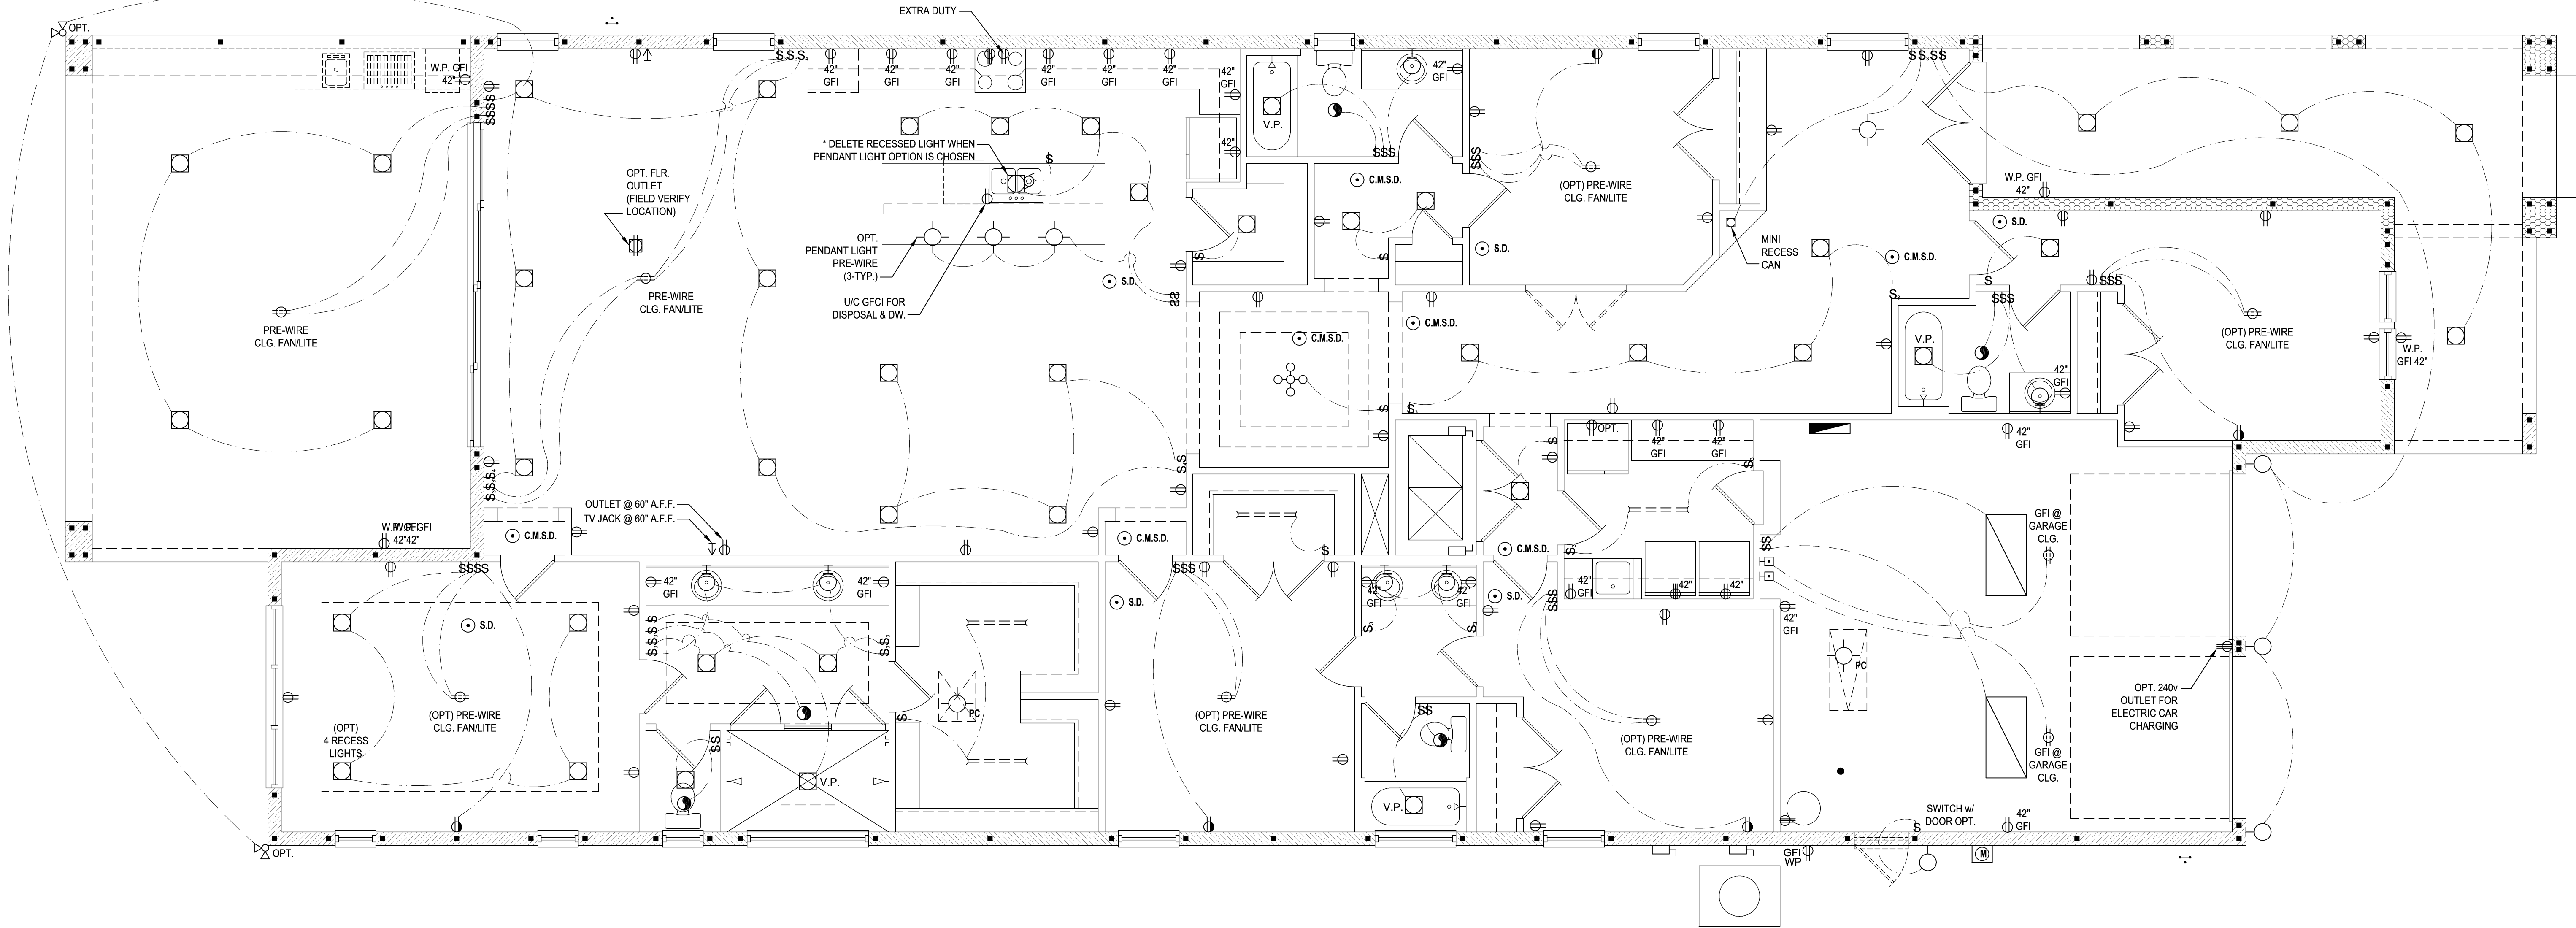

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www.mjshomedesigns.com  
Fax: (407) 629-6776  
FL CERT. AUTH.: 28113  
FL. PER#: 60269



235 Maitland Avenue S.  
Suite 108-A  
Maitland, FL 32751  
Ph: (407) 227-7416  
www.premier-structural.com  
FL CERT. AUTH.: 28113  
FL. PER#: 60269

ELECTRICAL PLAN

07.C2

SAFE GRAVITY LOADS FOR 8" PRECAST & PRESTRESSED U-LINTELS											
LENGTH	TYPE	SAFE LOAD - POUNDS PER LINEAR FOOT									
		8F8-08	8F12-08	8F16-08	8F20-08	8F24-08	8F28-08	8F32-08	8F36-08	8F40-08	8F44-08
3'-6" (42") PRECAST	2231	3069	3719	5163	6607	8054	9502	10951	12400	13849	15298
4'-0" (48") PRECAST	1966	2661	3261	4605	5949	7293	8637	9981	11325	12669	14013
4'-6" (54") PRECAST	1599	1969	2110	2931	3753	4576	5400	6224	7047	7871	8695
5'-4" (64") PRECAST	1217	1438	1538	2109	2680	3251	3822	4393	4964	5535	6106
5'-10" (70") PRECAST	1062	1105	1173	1631	2090	2549	3009	3470	3930	4391	4852
6'-6" (78") PRECAST	908	1238	1277	1740	2203	2666	3129	3592	4055	4518	4981
7'-6" (90") PRECAST	743	1011	1011	1729	2203	2666	3129	3592	4055	4518	4981
9'-4" (112") PRECAST	554	752	752	1245	1643	2041	2439	2837	3235	3633	4031
10'-6" (126") PRECAST	475	635	635	1052	1353	2093	2793	3493	4193	4893	5593
11'-4" (136") PRECAST	362	582	582	945	1166	1846	2423	3000	3577	4154	4731
12'-0" (144") PRECAST	337	540	540	873	1084	1684	2183	2683	3183	3683	4183
13'-4" (160") PRECAST	296	471	471	755	1075	1428	1838	2316	2883	3450	4017
14'-0" (168") PRECAST	279	424	424	706	1002	1326	1697	2127	2630	3133	3636
14'-8" (176") PRESTRESSED	N.R.	458	783	1370	1902	2245	2517	2712	2907	3102	3297
15'-4" (184") PRESTRESSED	N.R.	NR	NR	NR	NR	NR	NR	NR	NR	NR	NR
17'-4" (208") PRESTRESSED	N.R.	412	710	1250	1733	2058	2320	2513	2706	2899	3092
19'-4" (232") PRESTRESSED	N.R.	NR	NR	NR	NR	NR	NR	NR	NR	NR	NR
21'-4" (256") PRESTRESSED	N.R.	NR	NR	NR	NR	NR	NR	NR	NR	NR	NR
22'-0" (264") PRESTRESSED	N.R.	NR	NR	NR	NR	NR	NR	NR	NR	NR	NR
24'-0" (288") PRESTRESSED	N.R.	NR	NR	NR	NR	NR	NR	NR	NR	NR	NR

SAFE UPLIFT LOADS FOR 8" PRECAST & PRESTRESSED U-LINTELS											
LENGTH	TYPE	SAFE LOAD - POUNDS PER LINEAR FOOT									
		8F8-1T	8F12-1T	8F16-1T	8F20-1T	8F24-1T	8F28-1T	8F32-1T	8F36-1T	8F40-1T	8F44-1T
3'-6" (42") PRECAST		1569	2855	3524	4394	5263	6132	7001	7870	8739	9608
4'-0" (48") PRECAST		1569	2855	3524	4394	5263	6132	7001	7870	8739	9608
4'-6" (54") PRECAST		1207	2040	2707	3375	4043	4711	5379	6047	6715	7383
5'-4" (64") PRECAST		1016	1715	2276	2838	3399	3961	4522	5083	5644	6205
5'-10" (70") PRECAST		909	1567	2080	2593	3107	3620	4133	4646	5159	5672
6'-6" (78") PRECAST		835	1407	1868	2329	2790	3251	3712	4173	4634	5095
7'-6" (90") PRECAST		727	1224	1624	2025	2426	2827	3228	3629	4030	4431
9'-4" (112") PRECAST		591	862	1318	1643	1969	2294	2619	2944	3269	3594
10'-6" (126") PRECAST		530	575	916	1188	1461	1734	2007	2280	2553	2826
11'-4" (136") PRECAST		474	504	800	1037	1274	1511	1748	1985	2222	2459
12'-0" (144") PRECAST		494	607	1042	1372	1643	1914	2185	2456	2727	2998
13'-4" (160") PRECAST		470	458	724	938	1153	1368	1583	1798	2013	2228
14'-0" (168") PRECAST		410	425	717	903	1089	1275	1461	1647	1833	2019
14'-8" (176") PRESTRESSED		239	334	520	672	825	978	1131	1284	1437	1590
15'-4" (184") PRESTRESSED		246	395	663	980	1302	1619	1936	2253	2570	2887
17'-4" (208") PRESTRESSED		224	313	498	627	769	911	1054	1196	1338	1480
19'-4" (232") PRESTRESSED		230	368	616	908	1240	1560	1880	2200	2520	2840
21'-4" (256") PRESTRESSED		187	263	405	521	638	756	873	990	1107	1224
22'-0" (264") PRESTRESSED		192	306	506	640	774	908	1042	1176	1310	1444
24'-0" (288") PRESTRESSED		162	229	348	447	547	647	747	847	947	1047
		166	263	429	623	841	1059	1277	1495	1713	1931
		142	204	307	383	480	568	656	744	832	920
		142	232	373	537	721	905	1089	1273	1457	1641
		137	197	295	379	462	546	630	714	798	882
		137	223	358	513	688	863	1038	1213	1388	1563
		124	179	267	342	416	492	567	642	717	792
		124	202	319	455	606	757	908	1059	1210	1361

SAFE GRAVITY LOADS FOR 8" PRECAST w/ 2" RECESS DOOR U-LINTELS											
LENGTH	TYPE	SAFE LOAD - POUNDS PER LINEAR FOOT									
		8R16-08	8R16-18	8R16-24	8R16-30	8R16-36	8R16-42	8R16-48	8R16-54	8R16-60	8R16-66
4'-4" (52") PRECAST	1635	1749	3355	3280	4349	5421	6493	7567	8641	9715	10789
4'-6" (54") PRECAST	1494	1891	3699	3206	4639	6066	7493	8920	10347	11774	13201
5'-8" (68") PRECAST	866	1596	3263	2892	3968	5044	6120	7196	8272	9348	10424
5'-10" (70") PRECAST	810	1113	2342	4242	6639	9036	11433	13830	16227	18624	21021
6'-8" (80") PRECAST	797	901	1825	3120	5048	7447	9846	12245	14644	17043	19442
7'-6" (90") PRECAST	669	755	1490	2459	3776	5743	7710	9677	11644	13611	15578
9'-8" (116") PRECAST	411	526	999	1568	2253	3129	4150	5181	6212	7243	8274





SAFE UPLIFT LOADS FOR 8" PRECAST w/ 2" RECESS DOOR U-LINTELS											
LENGTH	TYPE	SAFE LOAD - POUNDS PER LINEAR FOOT									
		8R16-1T	8R16-1T	8R16-1T	8R16-1T	8R16-1T	8R16-1T	8R16-1T	8R16-1T	8R16-1T	8R16-1T
4'-4" (52") PRECAST		905	1668	2362	3056	3751	4445	5140	5835	6530	7225
4'-6" (54") PRECAST		867	1604	2272	2939	3607	4275	4943	5611	6279	6947
5'-8" (68") PRECAST		675	1289	1797	2326	2854	3382	3911	4439	4968	5497
5'-10" (70") PRECAST		655	1207	1746	2259	2773	3286	3799	4312	4825	5338
6'-8" (80") PRECAST		570	929	1530	2180	2830	3480	4130	4780	5430	6080
7'-6" (90") PRECAST		506	742	1364	1765	2166	2567	2968	3369	3770	4171
9'-8" (116") PRECAST		395	560	1072	1386	1701	2016	2331	2646	2961	3276

LINTEL SCHEDULE				
LINTEL NO.	LENGTH	TYPE	COMMENTS	
L-1	9'-4"	8F40-1B/1T		
L-2	4'-6"	8F24-0B/1T		
L-3	5'-4"	8F24-0B/1T		
L-4	7'-6"	8F24-1B/1T		
L-5	3'-6"	8F24-0B/1T		
L-6	10'-6"	8F24-1B/1T		
L-7	17'-4"	8F24-1B/1T		
L-8	24'-0"	8F16-1B/1T	MODIFY AS REQ'D	
L-9	10'-6"	8F16-1B/1T	MODIFY AS REQ'D	
L-10	7'-6"	8RF62-1B/1T		
L-11	5'-4"	8F24-1B/1T	MODIFY AS REQ'D	
L-12	4'-0"	8F48-0B/1T	OPT. SRVC. DOOR	
L-13	10'-6"	8F56-1B/1T	MODIFY AS REQ'D	
L-14	9'-4"	8F56-1B/1T	MODIFY AS REQ'D	
L-15	9'-4"	8F40-1B/1T	MODIFY AS REQ'D	
L-16	9'-4"	8F16-1B/1T	MODIFY AS REQ'D	
L-17	6'-6"	8F16-1B/1T	MODIFY AS REQ'D	
L-18	7'-6"	8F16-1B/1T	MODIFY AS REQ'D	

- GENERAL NOTES**
- Provide full mortar bed and head joints.
  - Shore filled lintels as required.
  - Installation of lintel must comply with the architectural and/or structural documents.
  - U-Intels are manufactured with 5 1/2" long notches at the ends to accommodate vertical cell reinforcing and grouting.
  - Reference the CAST-CRTE Load Deflection Graph brochure for lintel deflection information.
  - Bottom field added rebar to be located at the bottom of the lintel cavity.
  - 7/32" diameter wire stirrups are welded to the bottom steel for mechanical anchorage.
  - Cast-in-place concrete may be provided in composite lintel in lieu of concrete masonry units.
  - Safe load rating based on rational design analysis per ACI 318 and ACI 550.
  - The exterior surface of lintels installed in exterior concrete masonry walls shall have a coating of stucco applied in accordance with ASTM C-298 or other approved coating.
  - Lintels loaded simultaneously with vertical (gravity or uplift) and horizontal (lateral) loads should be checked for the combined loading with the following equation:  

$$\frac{\text{Applied vertical load}}{\text{Safe vertical load}} + \frac{\text{Applied horizontal load}}{\text{Safe horizontal load}} \leq 1.0$$
  - Additional lateral load capacity can be obtained by the designer by providing additional reinforced concrete masonry above the lintel. See detail at right.

- SAFE LOAD TABLE NOTES**
- All values based on minimum 4 inch nominal bearing. Exception: Safe loads for unfilled lintels must be reduced by 20% if bearing length is less than 6 1/2 inches.
  - N.R. = Not Rated
  - Safe loads are superimposed allowable loads.
  - Safe loads based on grade 40 or grade 60 field rebar.
  - One #7 rebar may be substituted for two #5 rebars in 8" lintels only.
  - The designer may evaluate concentrated loads from the safe load tables by calculating the maximum resisting moment and shear at d-away from face of support.
  - For composite lintel heights not shown, use safe load from next lower height shown.
  - For lintels lengths not shown, use safe load from next longest length shown.
  - All safe loads in units of pounds per linear foot.
  - All safe loads based on simply supported span.
  - The number in the the parenthesis indicates the percent reduction for grade 40 field added rebar. Example 7'-6" lintel type 8F32-1B safe gravity load = 6472.

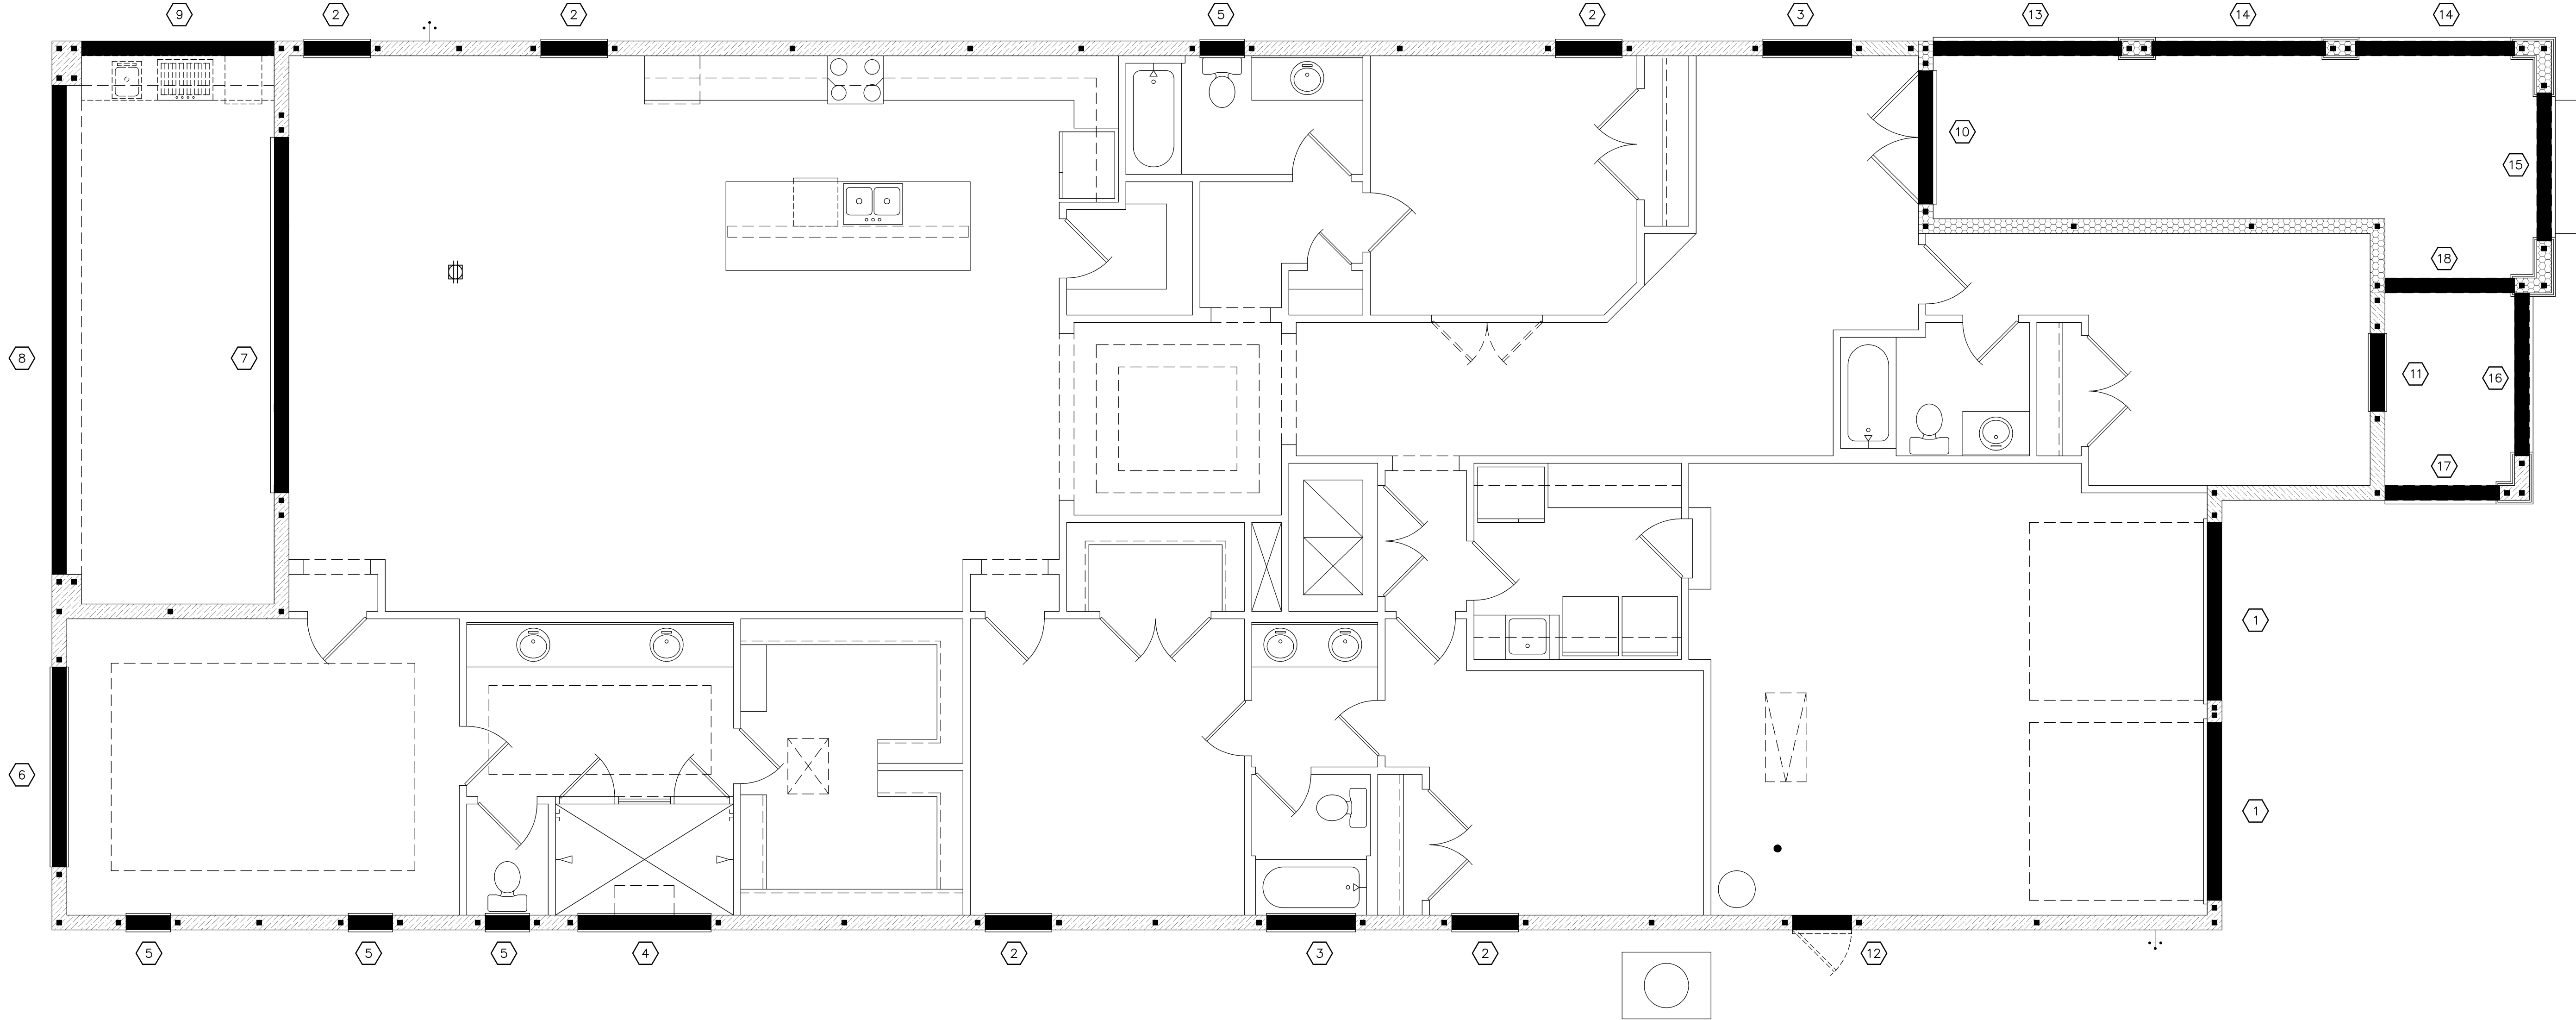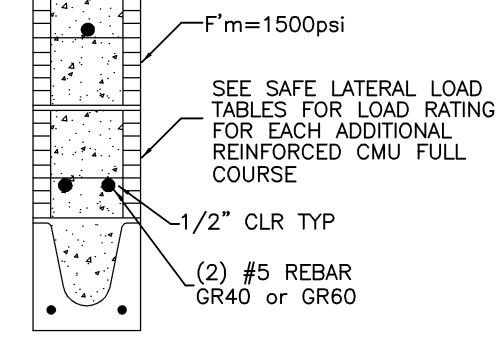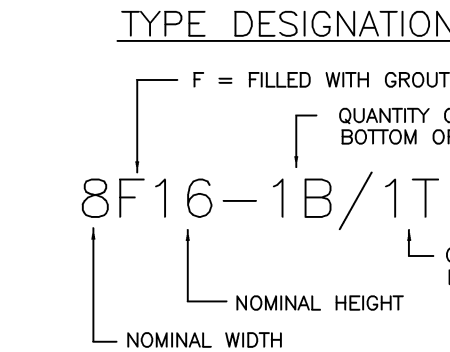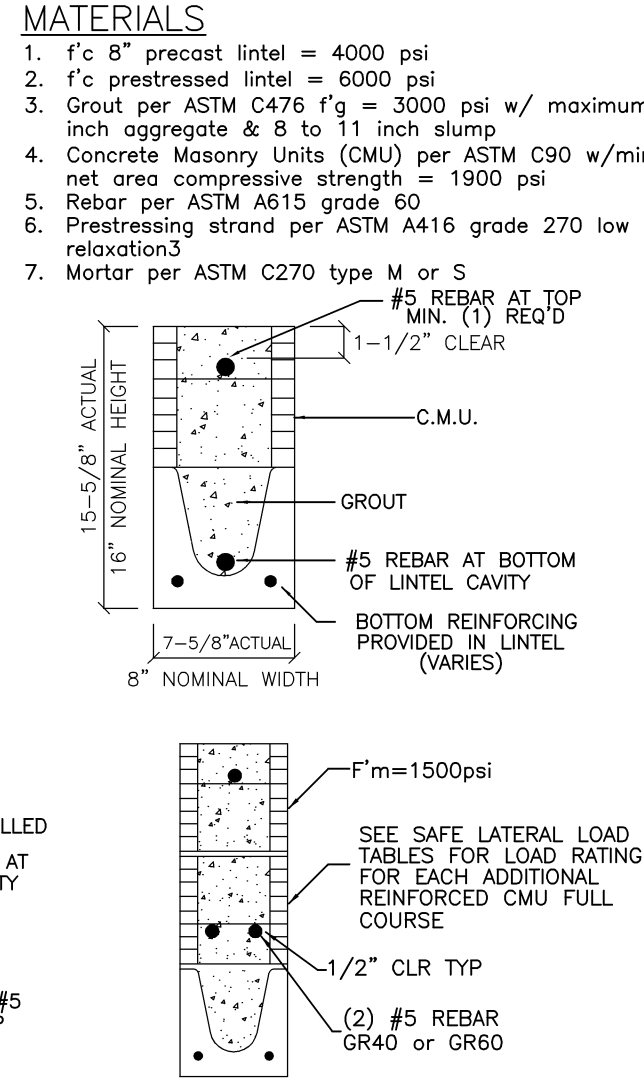

**Lintel Plan "A"**  
 (Standard)  
 SCALE: 1/8" = 1'-0" (12x18) 1/4" = 1'-0" (24x36)

235 Maitland Avenue S.  
 Suite 108-A  
 Maitland, FL 32751  
 Ph: (407) 227-7416  
 www.premier-structural.com  
 FL CERT. AUTH.: 28113  
 FL P.E.#: 80299

**PREMIER**  
 STRUCTURAL ENGINEERS, INC.

When plans have been electronically signed & sealed by Miami Rodriguez, PE, using a digital signature, the user is responsible for the accuracy of the information provided. The user is responsible for the accuracy of the information provided. The user is responsible for the accuracy of the information provided.

815 Orienta Ave. Suite# 1040  
 Altamonte Springs, FL 32701  
 Ph: (407) 629-6711  
 CUSTOM HOME DESIGN  
 DESIGNERS - PLANNERS  
 FL. CERT. AUTH.: 28113  
 www.mjshomedesigns.com

**WJS**  
 40-3164  
**DORCHESTER**  
 Street Address  
 Lot Info  
 City, State, Zip

A Division of Park Square  
 Enterprises Inc.  
 5200 Vineland Rd. Suite #200  
 Orlando, FL 32811  
 Phone: (407) 525-3000

**Park Square HOMES**

ISSUE DATE: 00/00/0000  
 REVISIONS:  
 PROJECT: 00-0000  
 SCALE: AS NOTED  
 DRAWN BY: C.C.  
 DESIGNED BY: MJS

**LINTEL PLAN**  
**08.A**

SAFE GRAVITY LOADS FOR 8" PRECAST & PRESTRESSED U-LINTELS									
LENGTH	TYPE	SAFE LOAD - POUNDS PER LINEAR FOOT							
		8F8-08	8F12-08	8F16-08	8F20-08	8F24-08	8F28-08	8F32-08	8F36-08
3'-6" (42")	PRECAST	2231	3069	3719	5163	6607	8054	9502	10951
4'-0" (48")	PRECAST	1966	2693	4605	6113	7547	8974	10394	11869
4'-6" (54")	PRECAST	1599	1969	2110	2931	3753	4576	5400	6224
5'-4" (64")	PRECAST	1217	2189	4375	6113	7547	8974	10394	11869
5'-10" (70")	PRECAST	1062	1340	1438	1999	2560	3123	3686	4249
6'-6" (78")	PRECAST	908	1217	1663	3090	5360	7547	9732	11918
7'-6" (90")	PRECAST	743	1011	1729	2661	3988	5681	8467	11253
9'-4" (112")	PRECAST	554	699	1160	1625	2564	3486	4408	5330
10'-6" (126")	PRECAST	475	752	1245	1843	2564	3486	4408	5330
11'-4" (136")	PRECAST	362	582	945	1366	1846	2423	3127	4006
12'-0" (144")	PRECAST	337	540	873	1254	1684	2193	2805	3522
13'-4" (160")	PRECAST	296	471	755	1075	1428	1838	2316	2883
14'-0" (168")	PRECAST	279	424	706	1002	1326	1697	2127	2630
14'-8" (176")	PRESTRESSED	N.R.	458	763	1370	1902	2245	2517	2712
15'-4" (184")	PRESTRESSED	N.R.	NR	NR	NR	NR	NR	NR	NR
17'-4" (208")	PRESTRESSED	N.R.	412	710	1250	1733	2058	2320	2513
19'-4" (232")	PRESTRESSED	N.R.	NR	NR	NR	NR	NR	NR	NR
21'-4" (256")	PRESTRESSED	N.R.	NR	NR	NR	NR	NR	NR	NR
22'-0" (264")	PRESTRESSED	N.R.	NR	NR	NR	NR	NR	NR	NR
24'-0" (288")	PRESTRESSED	N.R.	NR	NR	NR	NR	NR	NR	NR

SAFE UPLIFT LOADS FOR 8" PRECAST & PRESTRESSED U-LINTELS									
LENGTH	TYPE	SAFE LOAD - POUNDS PER LINEAR FOOT							
		8F8-1T	8F12-1T	8F16-1T	8F20-1T	8F24-1T	8F28-1T	8F32-1T	8F36-1T
3'-6" (42")	PRECAST	1569	2655	3524	4394	5263	6132	7001	7870
4'-0" (48")	PRECAST	1363	2305	3060	3815	4570	5325	6079	6833
4'-6" (54")	PRECAST	1207	2040	2707	3375	4043	4711	5379	6047
5'-4" (64")	PRECAST	1016	1715	2276	2838	3399	3961	4522	5083
5'-10" (70")	PRECAST	909	1567	2080	2593	3107	3620	4133	4646
6'-6" (78")	PRECAST	835	1407	1868	2329	2790	3251	3712	4173
7'-6" (90")	PRECAST	727	1224	1624	2025	2426	2827	3228	3629
9'-4" (112")	PRECAST	591	862	1318	1643	1969	2294	2619	2944
10'-6" (126")	PRECAST	530	755	1180	1472	1763	2055	2346	2637
11'-4" (136")	PRECAST	474	504	800	1037	1274	1513	1753	2000
12'-0" (144")	PRECAST	420	458	724	938	1153	1369	1585	1801
13'-4" (160")	PRECAST	410	425	717	903	1063	1223	1383	1543
14'-0" (168")	PRECAST	384	398	660	824	989	1154	1319	1484
14'-8" (176")	PRESTRESSED	239	334	429	524	619	714	809	904
15'-4" (184")	PRESTRESSED	246	305	363	421	479	537	595	653
17'-4" (208")	PRESTRESSED	224	313	388	468	548	628	708	788
19'-4" (232")	PRESTRESSED	230	368	429	487	546	605	664	723
21'-4" (256")	PRESTRESSED	187	263	306	350	394	438	482	526
22'-0" (264")	PRESTRESSED	162	229	273	317	361	405	449	493
24'-0" (288")	PRESTRESSED	137	197	231	265	299	333	367	401




SAFE GRAVITY LOADS FOR 8" PRECAST w/ 2" RECESS DOOR U-LINTELS									
LENGTH	TYPE	SAFE LOAD - POUNDS PER LINEAR FOOT							
		8R8-08	8R12-08	8R16-08	8R20-08	8R24-08	8R28-08	8R32-08	8R36-08
4'-4" (52")	PRECAST	1635	1749	3355	3280	4349	5421	6493	7567
4'-6" (54")	PRECAST	1494	1891	3699	5206	6639	8060	9479	10893
5'-8" (68")	PRECAST	866	1596	3263	2892	3968	4940	5924	6904
5'-10" (70")	PRECAST	810	1113	2342	4242	6639	8060	9479	10893
6'-8" (80")	PRECAST	797	901	1825	3120	5048	7747	9448	11149
7'-6" (90")	PRECAST	669	755	1490	2459	3776	5743	7239	8735
9'-8" (116")	PRECAST	411	526	999	1568	2253	3129	4150	5181

LINTEL SCHEDULE				
LINTEL NO.	LENGTH	TYPE	COMMENTS	
L-1	9'-4"	8F40-1B/1T		
L-2	4'-6"	8F24-0B/1T		
L-3	5'-4"	8F24-0B/1T		
L-4	7'-6"	8F24-1B/1T		
L-5	3'-6"	8F24-0B/1T		
L-6	10'-6"	8F24-1B/1T		
L-7	17'-4"	8F24-1B/1T		
L-8	24'-0"	8F16-1B/1T	MODIFY AS REQ'D	
L-9	10'-6"	8F16-1B/1T	MODIFY AS REQ'D	
L-10	7'-6"	8RF62-1B/1T		
L-11	5'-4"	8F24-1B/1T	MODIFY AS REQ'D	
L-12	4'-0"	8F48-0B/1T	OPT. SRVC. DOOR	
L-13	10'-6"	8F56-1B/1T	MODIFY AS REQ'D	
L-14	9'-4"	8F56-1B/1T	MODIFY AS REQ'D	
L-15	9'-4"	8F40-1B/1T	MODIFY AS REQ'D	
L-16	9'-4"	8F16-1B/1T	MODIFY AS REQ'D	
L-17	6'-6"	8F16-1B/1T	MODIFY AS REQ'D	
L-18	7'-6"	8F16-1B/1T	MODIFY AS REQ'D	

SAFE UPLIFT LOADS FOR 8" PRECAST w/ 2" RECESS DOOR U-LINTELS									
LENGTH	TYPE	SAFE LOAD - POUNDS PER LINEAR FOOT							
		8R8-1T	8R12-1T	8R16-1T	8R20-1T	8R24-1T	8R28-1T	8R32-1T	8R36-1T
4'-4" (52")	PRECAST	905	1668	2362	3056	3751	4445	5140	5835
4'-6" (54")	PRECAST	867	1604	2272	2939	3607	4275	4943	5611
5'-8" (68")	PRECAST	675	1289	1797	2325	2854	3382	3911	4440
5'-10" (70")	PRECAST	675	1289	1797	2325	2854	3382	3911	4440
6'-8" (80")	PRECAST	570	929	1530	1980	2429	2879	3329	3779
7'-6" (90")	PRECAST	506	742	1364	1765	2166	2567	2968	3369
9'-8" (116")	PRECAST	395	560	1072	1386	1701	2016	2331	2646

- GENERAL NOTES**
- Provide full mortar bed and head joints.
  - Shore filled lintels as required.
  - Installation of lintel must comply with the architectural and/or structural documents.
  - U-Intels are manufactured with 5 1/2" long notches at the ends to accommodate vertical cell reinforcing and grouting.
  - Reference the CAST-CRTE Load Deflection Graph brochure for lintel deflection information.
  - Bottom field added rebar to be located at the bottom of the lintel cavity.
  - 7/32" diameter wire stirrups are welded to the bottom steel for mechanical anchorage.
  - Cast-in-place concrete may be provided in composite lintel in lieu of concrete masonry units.
  - Safe load rating based on rational design analysis per ACI 318 and ACI 530.
  - The exterior surface of lintels installed in exterior concrete masonry walls shall have a coating of stucco applied in accordance with ASTM C-296 or other approved coating.
  - Lintels loaded simultaneously with vertical (gravity or uplift) and horizontal (lateral) loads should be checked for the combined loading with the following equation:  
$$\frac{\text{Applied vertical load}}{\text{Safe vertical load}} + \frac{\text{Applied horizontal load}}{\text{Safe horizontal load}} \leq 1.0$$
  - Additional lateral load capacity can be obtained by the designer by providing additional reinforced concrete masonry above the lintel. See detail at right.

- SAFE LOAD TABLE NOTES**
- All values based on minimum 4 inch nominal bearing. Exception: Safe loads for unfilled lintels must be reduced by 20% if bearing length is less than 6 1/2 inches.
  - N.R. = Not Rated
  - Safe loads are superimposed allowable loads.
  - Safe loads based on grade 40 or grade 60 field rebar.
  - One #7 rebar may be substituted for two #5 rebar in 8" lintels only.
  - The designer may evaluate concentrated loads from the safe load tables by calculating the maximum resisting moment and shear at d-away from face of support.
  - For composite lintel heights not shown, use safe load from next lower height shown.
  - For lintels lengths not shown, use safe load from next longest length shown.
  - All safe loads in units of pounds per linear foot.
  - All safe loads based on simply supported span.
  - The number in the the parenthesis indicates the percent reduction for grade 40 field added rebar. Example 7'-6" lintel type 8F32-1B safe gravity load = 6472.

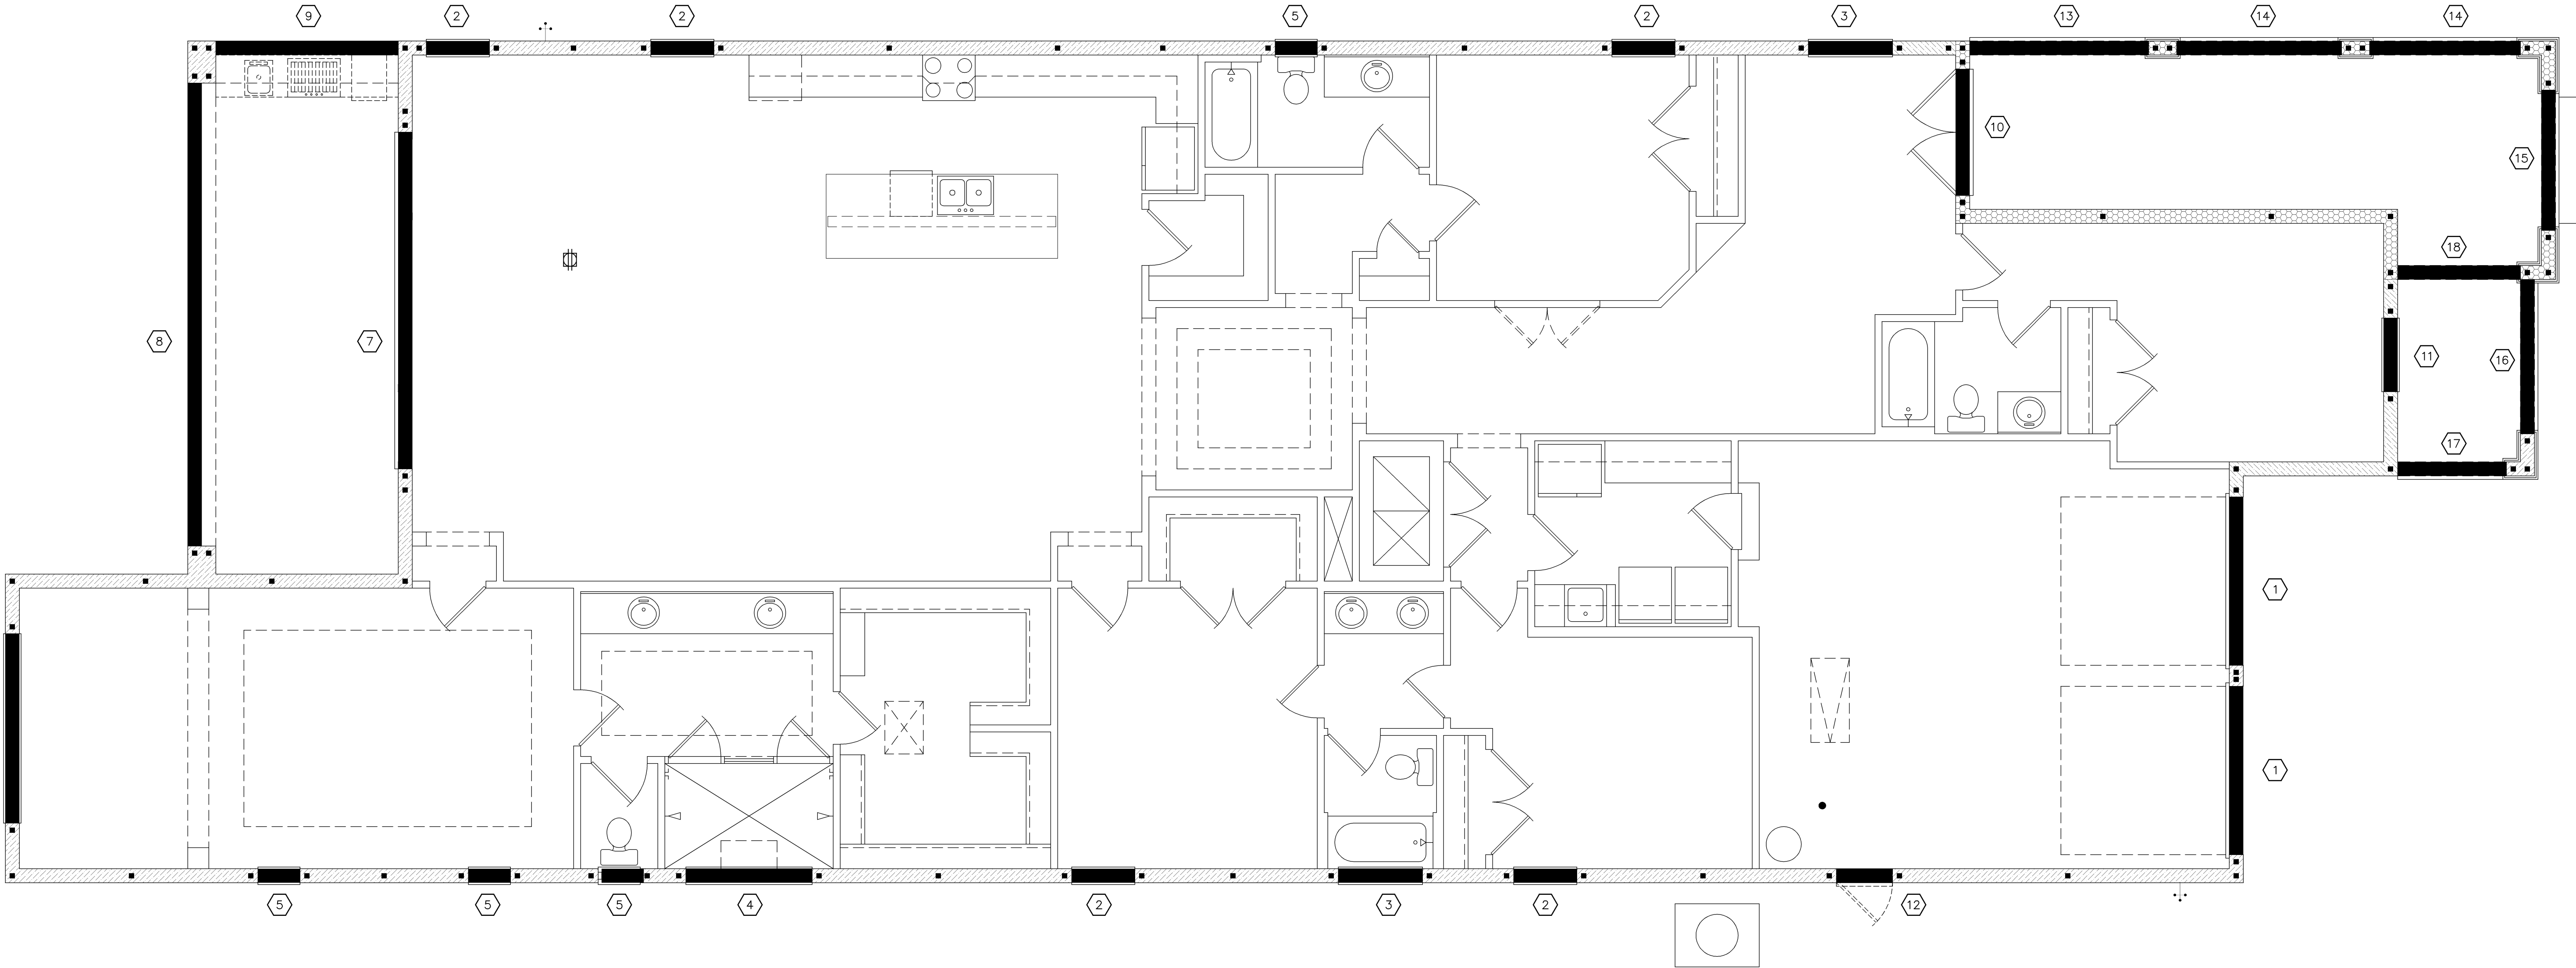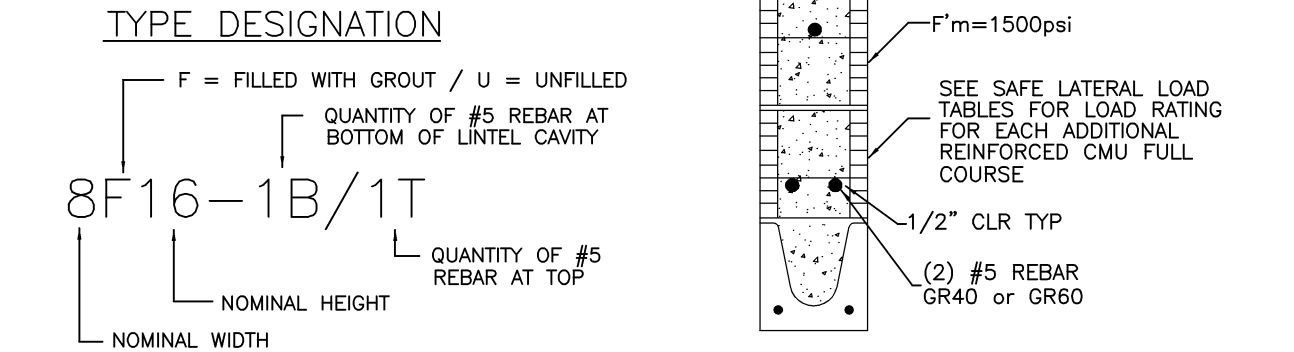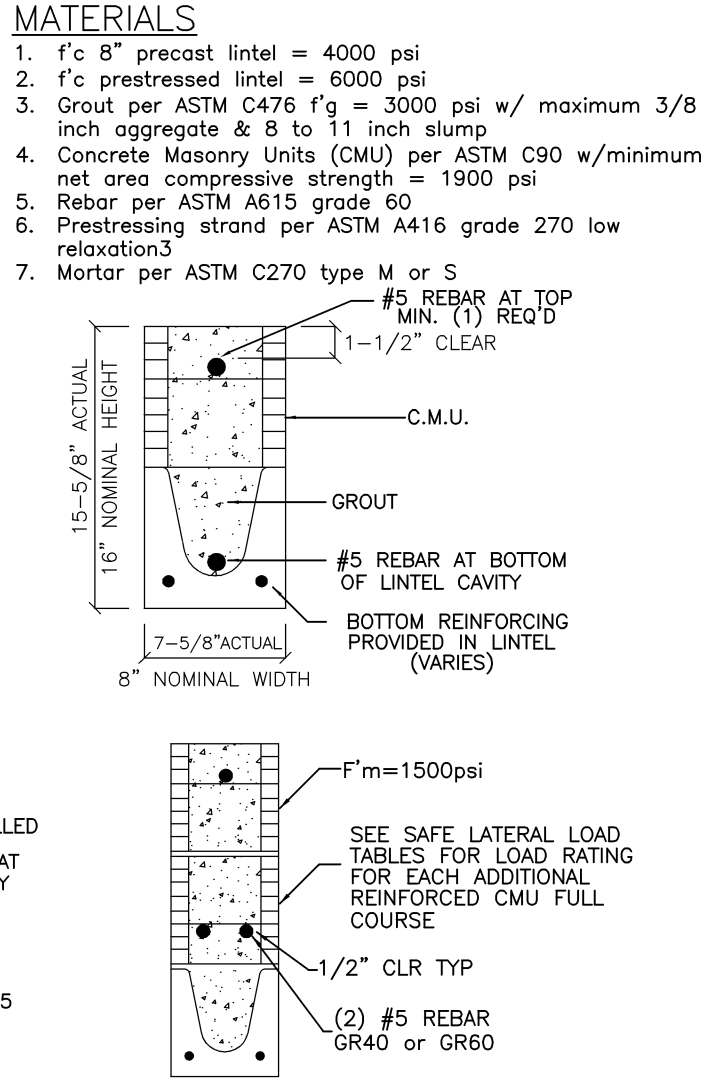

Lintel Plan "A"  
(Opt. Sitting Room)  
SCALE: 1/8" = 1'-0" (12x18) 1/4" = 1'-0" (24x36)

235 Maitland Avenue S.  
Suite 108-A  
Maitland, FL 32751  
Ph: (407) 227-7416  
www.premier-structural.com  
FL CERT. AUTH.: 28113  
FL. P.E.#: 80269

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STRUCTURAL ENGINEERS, P.A.

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815 Orienta Ave. Suite# 1040  
Altamonte Springs, FL 32701  
Ph: (407) 629-6711  
Fax: (407) 629-6716  
www.mjshomedesigns.com

**MJS**  
CUSTOM HOME DESIGN  
DESIGNERS - PLANNERS

WRITTEN DIMENSIONS SHALL HAVE PRECEDENCE OVER SCALE DIMENSIONS.  
Contractor shall verify and be responsible for dimensions and conditions of the job and MJS shall not be responsible for any errors or omissions on drawings or specifications. Verify all dimensions on site.

40-3164  
**DORCHESTER**  
Street Address  
Lot Info  
City, State, Zip

A Division of Park Square  
Enterprises Inc.  
5200 Vineland Rd. Suite #200  
Orlando, FL 32811  
Phone: (407) 525-3000

**Park Square HOMES**

ISSUE DATE: 00/00/0000

REVISIONS

PROJECT: 00-0000  
SCALE: AS NOTED  
DRAWN BY: C.C.  
DESIGNED BY: MJS

LINTEL PLAN  
**08.A1**

SAFE GRAVITY LOADS FOR 8" PRECAST & PRESTRESSED U-LINTELS											
LENGTH	TYPE	BUB	SAFE LOAD - POUNDS PER LINEAR FOOT								
			8F8-08	8F12-08	8F16-08	8F20-08	8F24-08	8F28-08	8F32-08		
3'-6" (42")	PRECAST	2231	3069	3719	5163	6607	8054	9502	10951		
4'-0" (48")	PRECAST	1966	2693	4605	6113	7547	8974	10394	11809		
4'-6" (54")	PRECAST	1599	1969	2110	2931	3753	4576	5400	6224		
5'-4" (64")	PRECAST	1217	2189	4375	6113	7547	8974	10394	11809		
5'-10" (70")	PRECAST	1062	1340	1438	1999	2560	3123	3686	4249		
6'-6" (78")	PRECAST	908	1217	1663	3090	5365	7547	9729	11911		
7'-6" (90")	PRECAST	743	1011	1729	2632	3225	3818	4411	5004		
9'-4" (112")	PRECAST	554	752	1245	1843	2554	3266	3978	4690		
10'-6" (126")	PRECAST	475	535	899	1353	2053	2777	3501	4225		
11'-4" (136")	PRECAST	362	582	945	1366	1846	2423	3127	4006		
12'-0" (144")	PRECAST	337	540	873	1254	1684	2193	2805	3552		
13'-4" (160")	PRECAST	296	471	755	1075	1428	1838	2316	2883		
14'-0" (168")	PRECAST	279	424	706	1002	1326	1697	2127	2630		
14'-8" (176")	PRESTRESSED	N.R.	458	763	1370	1902	2245	2517	2712		
15'-4" (184")	PRESTRESSED	N.R.	NR	NR	NR	NR	NR	NR	NR		
17'-4" (208")	PRESTRESSED	N.R.	412	710	1250	1733	2058	2320	2513		
19'-4" (232")	PRESTRESSED	N.R.	NR	NR	NR	NR	NR	NR	NR		
21'-4" (256")	PRESTRESSED	N.R.	NR	NR	NR	NR	NR	NR	NR		
22'-0" (264")	PRESTRESSED	N.R.	NR	NR	NR	NR	NR	NR	NR		
24'-0" (288")	PRESTRESSED	N.R.	NR	NR	NR	NR	NR	NR	NR		

SAFE UPLIFT LOADS FOR 8" PRECAST & PRESTRESSED U-LINTELS											
LENGTH	TYPE	BUB	SAFE LOAD - POUNDS PER LINEAR FOOT								
			8F8-1T	8F12-1T	8F16-1T	8F20-1T	8F24-1T	8F28-1T	8F32-1T		
3'-6" (42")	PRECAST	1569	2655	3524	4394	5263	6132	7001			
4'-0" (48")	PRECAST	1363	2305	3060	3815	4570	5325	6079			
4'-6" (54")	PRECAST	1207	2040	2707	3375	4043	4711	5379			
5'-4" (64")	PRECAST	1016	1715	2276	2838	3399	3961	4522			
5'-10" (70")	PRECAST	909	1567	2080	2593	3107	3620	4133			
6'-6" (78")	PRECAST	835	1407	1868	2329	2790	3251	3712			
7'-6" (90")	PRECAST	727	1224	1624	2025	2426	2827	3228			
9'-4" (112")	PRECAST	591	862	1318	1643	1969	2294	2619			
10'-6" (126")	PRECAST	530	575	916	1185	1461	1736	2011			
11'-4" (136")	PRECAST	474	504	800	1037	1274	1513	1753			
12'-0" (144")	PRECAST	434	467	740	977	1214	1453	1693			
13'-4" (160")	PRECAST	418	458	724	958	1195	1432	1669			
14'-0" (168")	PRECAST	410	425	717	948	1185	1422	1659			
14'-8" (176")	PRESTRESSED	239	334	520	672	825	978	1131			
15'-4" (184")	PRESTRESSED	246	395	663	980	1303	1616	1929			
17'-4" (208")	PRESTRESSED	224	313	498	627	759	891	1024			
19'-4" (232")	PRESTRESSED	230	368	616	908	1240	1572	1904			
21'-4" (256")	PRESTRESSED	187	263	405	521	638	756	873			
22'-0" (264")	PRESTRESSED	192	306	506	740	974	1208	1442			
24'-0" (288")	PRESTRESSED	162	229	348	447	547	647	747			
		166	263	429	623	816	1009	1202			
		142	204	307	383	480	568	655			
		142	232	373	537	721	905	1089			
		137	197	295	379	462	546	630			
		137	223	358	513	688	863	1038			
		124	179	267	342	416	492	567			
		124	202	319	455	606	757	907			

SAFE GRAVITY LOADS FOR 8" PRECAST w/ 2" RECESS DOOR U-LINTELS											
LENGTH	TYPE	BUB	SAFE LOAD - POUNDS PER LINEAR FOOT								
			8F8-08	8F10-08	8F14-08	8F18-08	8F22-08	8F26-08	8F30-08		
4'-4" (52")	PRECAST	1635	1749	3355	3280	4349	5421	6493	7567		
4'-6" (54")	PRECAST	1494	1891	3699	5206	6639	8066	9479	10893		
5'-8" (68")	PRECAST	866	1596	3263	2892	3968	4640	5324	6004		
5'-10" (70")	PRECAST	810	1113	2342	4242	6639	8066	9479	10893		
6'-8" (80")	PRECAST	797	901	1825	3120	5048	7747	9448	7360		
7'-6" (90")	PRECAST	669	755	1490	2459	3776	5743	7239	5623		
9'-8" (116")	PRECAST	411	466	999	1568	2253	3129	4150	5891		

SAFE UPLIFT LOADS FOR 8" PRECAST w/ 2" RECESS DOOR U-LINTELS											
LENGTH	TYPE	BUB	SAFE LOAD - POUNDS PER LINEAR FOOT								
			8F8-1T	8F10-1T	8F14-1T	8F18-1T	8F22-1T	8F26-1T	8F30-1T		
4'-4" (52")	PRECAST	905	1668	2362	3056	3751	4445	5140			
4'-6" (54")	PRECAST	867	1604	2272	2939	3607	4275	4943			
5'-8" (68")	PRECAST	675	1289	1797	2326	2854	3382	3911			
5'-10" (70")	PRECAST	655	1207	1746	2259	2773	3286	3799			
6'-8" (80")	PRECAST	570	929	1530	1980	2429	2879	3329			
7'-6" (90")	PRECAST	506	742	1364	1765	2166	2567	2968			
9'-8" (116")	PRECAST	395	560	1072	1386	1701	2016	2331			




LINTEL SCHEDULE				
LINTEL NO.	LENGTH	TYPE	COMMENTS	
L-1	9'-4"	8F40-1B/1T		
L-2	4'-6"	8F24-0B/1T		
L-3	5'-4"	8F24-0B/1T		
L-4	7'-6"	8F24-1B/1T		
L-5	3'-6"	8F24-0B/1T		
L-6	10'-6"	8F24-1B/1T		
L-7	17'-4"	8F24-1B/1T		
L-8	10'-6"	8F16-1B/1T	MODIFY AS REQ'D	
L-9	24'-0"	8F16-1B/1T	MODIFY AS REQ'D	
L-10	21'-4"	8F16-1B/1T	MODIFY AS REQ'D	
L-11	7'-6"	8RF62-1B/1T		
L-12	5'-4"	8F24-1B/1T	MODIFY AS REQ'D	
L-13	4'-0"	8F48-0B/1T	OPT. SRVC. DOOR	
L-14	10'-6"	8F56-1B/1T	MODIFY AS REQ'D	
L-15	9'-4"	8F56-1B/1T	MODIFY AS REQ'D	
L-16	9'-4"	8F40-1B/1T	MODIFY AS REQ'D	
L-17	9'-4"	8F16-1B/1T	MODIFY AS REQ'D	
L-18	6'-6"	8F16-1B/1T	MODIFY AS REQ'D	
L-19	7'-6"	8F16-1B/1T	MODIFY AS REQ'D	

**GENERAL NOTES**

- Provide full mortar bed and head joints.
- Shore filled lintels as required.
- Installation of lintel must comply with the architectural and/or structural documents.
- U-Intels are manufactured with 5 1/2" long notches at the ends to accommodate vertical cell reinforcing and grouting.
- Reference the CAST-CRTE Load Deflection Graph brochure for lintel deflection information.
- Bottom field added rebar to be located at the bottom of the lintel cavity.
- 7/32" diameter wire stirrups are welded to the bottom steel for mechanical anchorage.
- Cast-in-place concrete may be provided in composite lintel in lieu of concrete masonry units.
- Safe load rating based on rational design analysis per ACI 318 and ACI 550.
- The exterior surface of lintels installed in exterior concrete masonry walls shall have a coating of stucco applied in accordance with ASTM C-298 or other approved coating.
- Lintels loaded simultaneously with vertical (gravity or uplift) and horizontal (lateral) loads should be checked for the combined loading with the following equation:  
$$\frac{\text{Applied vertical load}}{\text{Safe vertical load}} + \frac{\text{Applied horizontal load}}{\text{Safe horizontal load}} \leq 1.0$$
- Additional lateral load capacity can be obtained by the designer by providing additional reinforced concrete masonry above the lintel. See detail at right.

**SAFE LOAD TABLE NOTES**

- All values based on minimum 4 inch nominal bearing. Exception: Safe loads for unfilled lintels must be reduced by 20% if bearing length is less than 6 1/2 inches.
- N.R. = Not Rated
- Safe loads are superimposed allowable loads.
- Safe loads based on grade 40 or grade 60 field rebar.
- One #7 rebar may be substituted for two #5 rebars in 8" lintels only.
- The designer may evaluate concentrated loads from the safe load tables by calculating the maximum resisting moment and shear at d-away from face of support.
- For composite lintel heights not shown, use safe load from next lower height shown.
- For lintels lengths not shown, use safe load from next longest length shown.
- All safe loads in units of pounds per linear foot.
- All safe loads based on simply supported span.
- The number in the the parenthesis indicates the percent reduction for grade 40 field added rebar. Example 7'-6" lintel type 8F32-1B safe gravity load = 6472.

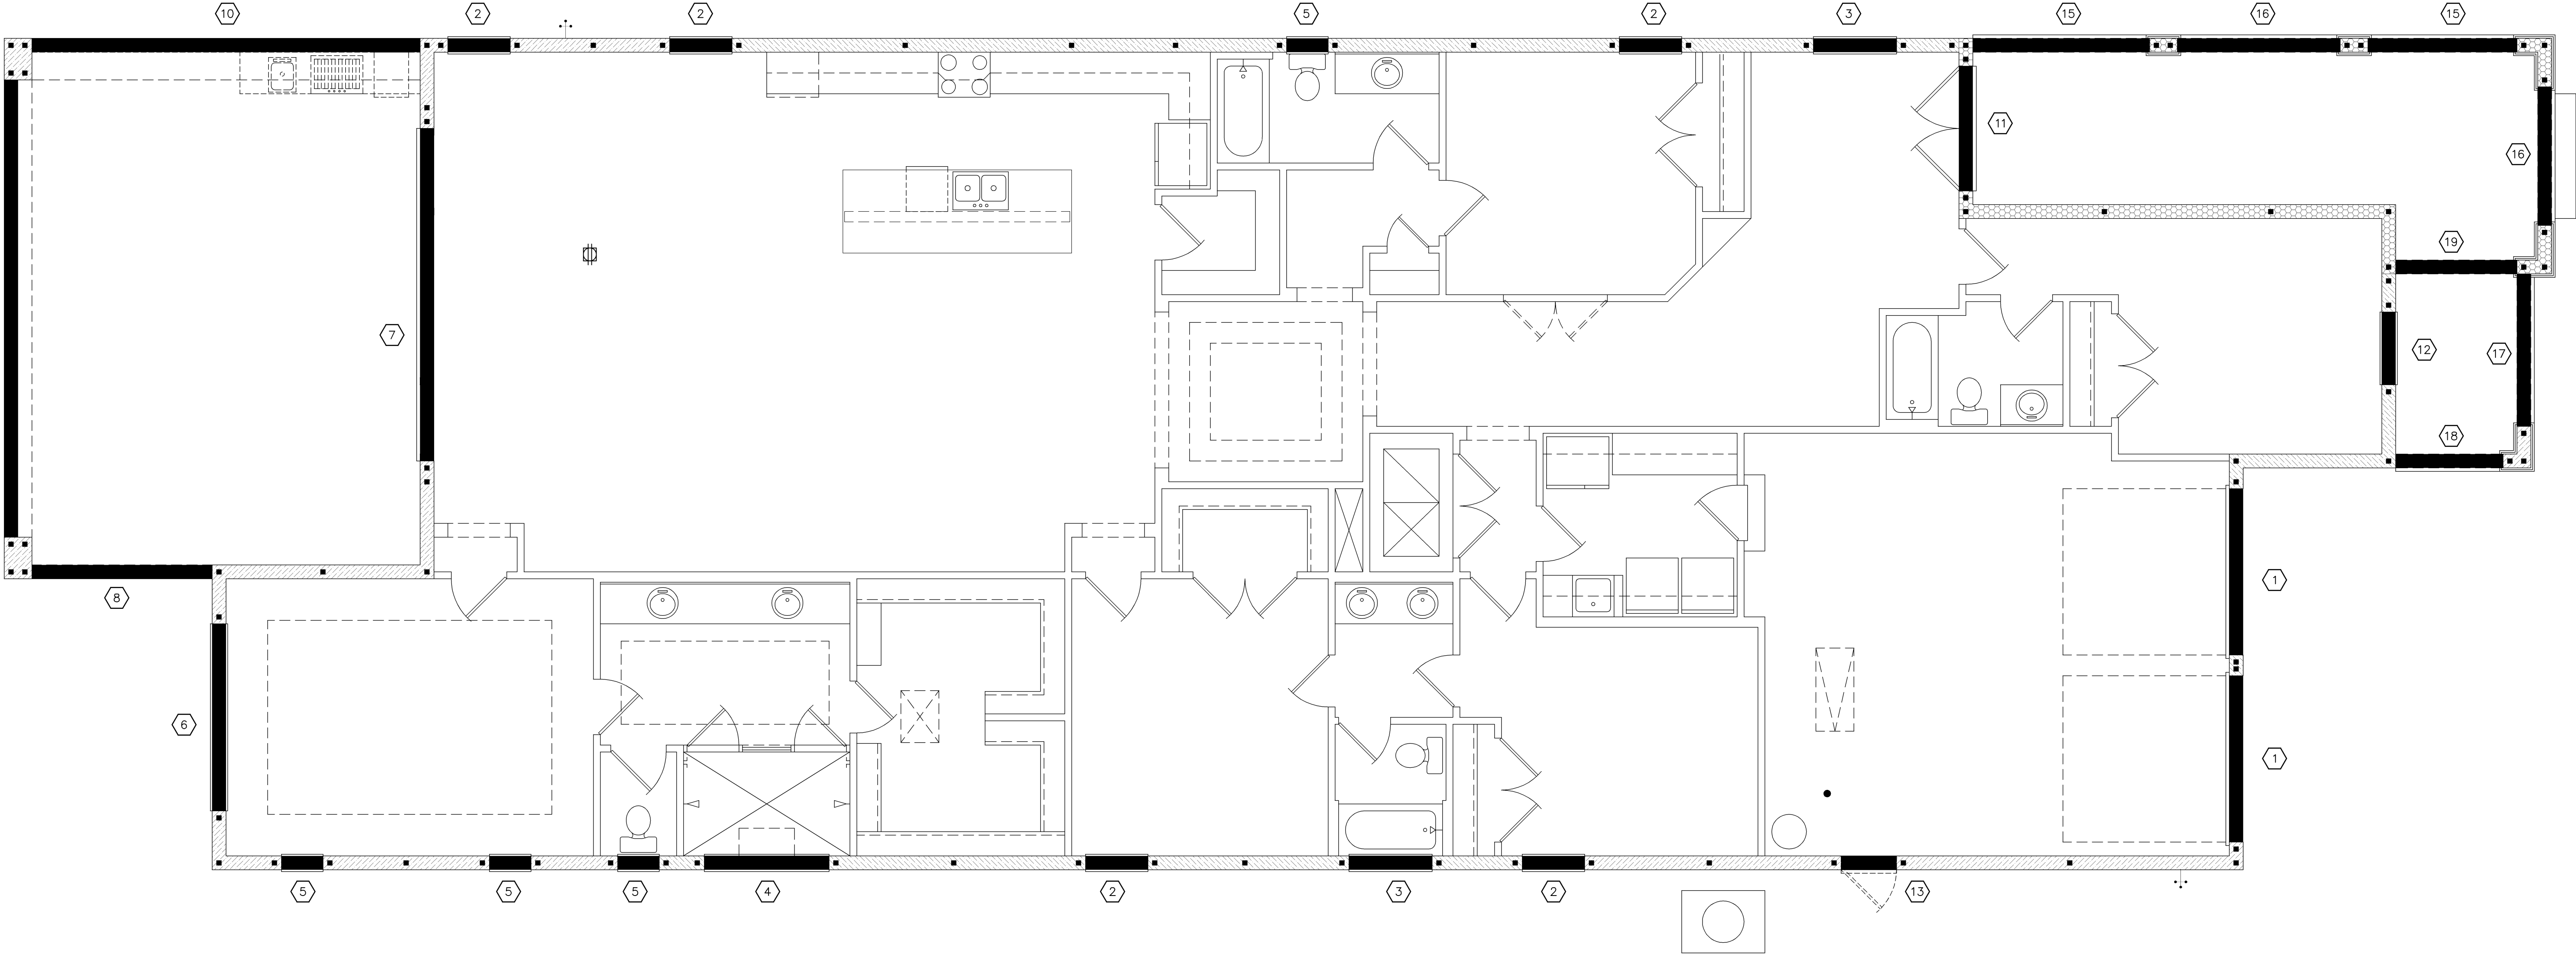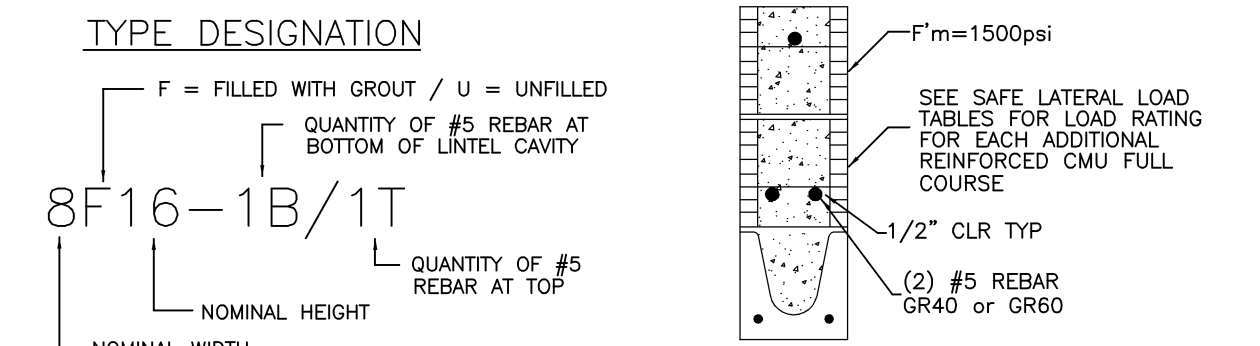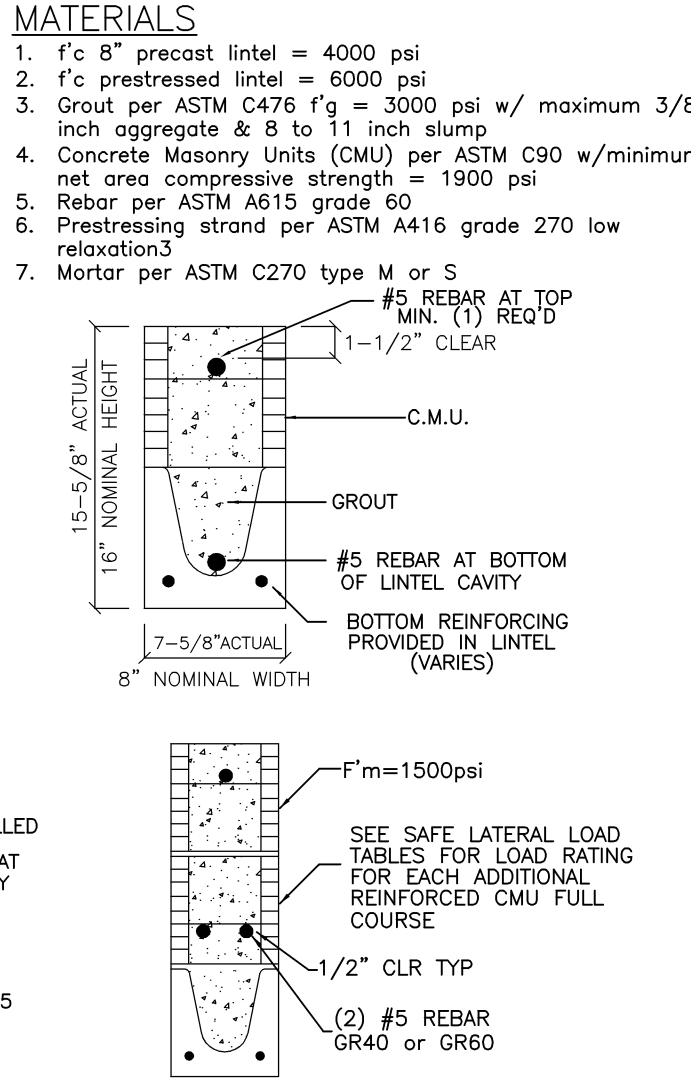

**Lintel Plan "A"**  
(Opt. Extended Lanai)  
SCALE: 1/8" = 1'-0" (12x18) 1/4" = 1'-0" (24x36)

40-3164

**DORCHESTER**

Street Address  
Lot Info  
City, State, Zip

A Division of Park Square  
Enterprises Inc.  
5200 Vineland Rd., Suite #200  
Orlando, FL 32811  
Phone: (407) 529-3000

**Park Square HOMES**

ISSUE DATE: 00/00/0000

REVISIONS

PROJECT: 00-0000  
SCALE: AS NOTED  
DRAWN BY: C.C.  
DESIGNED BY: MJS

LINTEL PLAN

**08.A2**

235 Maitland Avenue S.  
Suite 108-A  
Maitland, FL 32751  
Ph: (407) 227-7416  
www.premier-structural.com  
FL CERT AUTH: 28113  
FL REG: 80269

**PREMIER**  
STRUCTURAL ENGINEERS, INC.

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815 Orienta Ave. Suite# 1040  
Altamonte Springs, FL 32701  
Ph: (407) 629-6711  
CUSTOM home design  
DESIGNERS - PLANNERS  
www.mjshomedesigns.com

WRITTEN DIMENSIONS SHALL HAVE PRECEDENCE OVER SCALE DIMENSIONS.  
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SAFE UPLIFT LOADS FOR 8' PRECAST & PRESTRESSED U-LIMITS								
		SAFE LOAD - POUNDS PER LINEAR FOOT						
LENGTH	TYPE	8'8"-11'	8'12"-11'	8'16"-11'	8'20"-11'	8'24"-11'	8'28"-11'	8'32"-11'
		8'8"-11'	8'12"-11'	8'16"-11'	8'20"-11'	8'24"-11'	8'28"-11'	8'32"-11'
3'-6" (42")	PRECAST	1989	2655	3321	3987	4653	5319	5985
		1565	855	3524	394	5263	1312	7001
4'-0" (48")	PRECAST	1363	2305	3060	3815	4570	5325	6079
		1363	2305	3060	3815	4570	5325	6079
4'-6" (54")	PRECAST	1207	2040	2707	3375	4043	4711	5379
		1207	2040	2707	3375	4043	4711	5379
5'-4" (64")	PRECAST	909	1751(11)	2276	2838	3399	3961	4522
		1016	1715	2217	2739	3259	3780	4301
5'-10" (70")	PRECAST	929	1567(10)	2090(8)	2593	3107	3620	4133
		929	1567	2090	2593	3107	3620	4133
6'-6" (78")	PRECAST	835	1407	1868(9)	2329	2790	3251(10)	3712(11)
		835	1407	1868	2329	2790	3251	3712
7'-6" (90")	PRECAST	727	1063(8)	1624(4)	2025(9)	2426(10)	2827(11)	3228(12)
		727	1063	1624	2025	2426	2827	3228
8'-4" (112")	PRECAST	591	708	1136(4)	1474(26)	1815(15)	2157	2500(10)
		591	708	1136	1474	1815	2157	2500
10'-6" (126")	PRECAST	591	862	1318	1643	1969	2294	2619
		530	575	916	1188	1461(10)	1736(11)	2011(12)
		530	695	1180	1472	1763	2055	2346
11'-4" (136")	PRECAST	474	504	800	1037	1273(8)	1515(13)	1753(18)
		474	504	800	1037	1273	1515	1753
12'-0" (144")	PRECAST	474	507	1042(13)	1372(14)	1643	1918	2187
		474	507	1042	1372	1643	1918	2187
13'-0" (160")	PRECAST	470	550	940	1302	1560(10)	1818(11)	2075
		418	386	627	785	964	1143	1323
13'-4" (160")	PRECAST	428	460	760	1159	1418(10)	1655(11)	1887
		384	368	580	724	889	1054	1229
14'-0" (168")	PRECAST	410	425	717	1063	1358(10)	1582	1807
		234	334	520	672	825	978	1131
14'-8" (176")	PRESTRESSED	246	395	663	980	1193(10)	1389	1582
		224	313	588	687	769	851	934
15'-4" (184")	PRESTRESSED	224	338	616	908	1240	1460(12)	1668
		187	263	405	521	637	756	873
16'-4" (208")	PRESTRESSED	192	263	506	740	1000(10)	1271(11)	1473(13)
		128	229	348	467	547	647	747
19'-4" (232")	PRESTRESSED	166	263	429	623	841	1059	1277
		124	204	307	393	480	568	655
21'-4" (256")	PRESTRESSED	137	232	373	537	721	905	1048
		137	197	319	379	462	546	632
22'-0" (264")	PRESTRESSED	137	223	358	513	688	863	999
		124	179	287	342	416	492	567
24'-0" (288")	PRESTRESSED	124	202	319	455	606	757	876

SAFE UPLIFT LOADS FOR 8" PRECAST w/ 2" RECESS DOOR U-LINTELS									
<div> <div></div> <div>TYPE</div> </div>		SAFE LOAD - POUNDS PER LINEAR FOOT							
		BRF6-1T	BRF10-1T	BRF14-1T	BRF18-1T	BRF22-1T	BRF26-1T	BRF30-1T	BRF30-2T
4'-4" (52")	PRECAST	BRF6-1T	BRF10-1T	BRF14-1T	BRF18-1T	BRF22-1T	BRF26-1T	BRF30-1T	BRF30-2T
		905	1668	2362	3056	3751	4445	5140	
		905	1668	2362	3056	3751	4445	5140	
4'-6" (54")	PRECAST	867	1604	2272	2939	3607	4275	4943	
		867	1604	2272	2939	3607	4275	4943	
5'-8" (68")	PRECAST	675	1269 <sub>(10)</sub>	1797	2326 <sub>(10)</sub>	2854 <sub>(10)</sub>	3382	3911	
		675	1269	1797	2326	2854	3382	3911	
5'-10" (70")	PRECAST	655	1207 <sub>(10)</sub>	1746 <sub>(11)</sub>	2259 <sub>(10)</sub>	2773 <sub>(10)</sub>	3286 <sub>(10)</sub>	3799 <sub>(10)</sub>	
		655	1233	1746	2259	2773	3286	3799	
6'-8" (80")	PRECAST	570	923 <sub>(10)</sub>	1530 <sub>(10)</sub>	1980 <sub>(10)</sub>	2429 <sub>(10)</sub>	2879 <sub>(10)</sub>	3322 <sub>(10)</sub>	
		570	1080	1530	1980	2429	2879	3329	
7'-6" (90")	PRECAST	506	742 <sub>(10)</sub>	1364 <sub>(10)</sub>	1765 <sub>(10)</sub>	2166 <sub>(10)</sub>	2567 <sub>(10)</sub>	2968 <sub>(10)</sub>	
		506	898	1364	1765	2166	2567	2968	
9'-8" (116")	PRECAST	395	468 <sub>(10)</sub>	884 <sub>(10)</sub>	1222 <sub>(10)</sub>	1540 <sub>(10)</sub>	1859 <sub>(10)</sub>	2180 <sub>(10)</sub>	
		395	560	1072	1386	1701	2016	2331	

## SAFE LOAD TABLE NOTES

1. All values based on minimum 4 inch nominal bearing. Exception: Safe loads for unfilled lintels must be reduced by 20% if bearing length is less than 6 1/2 inches.
2. N.R. = Not Rated
3. Safe loads are superimposed allowable loads.
4. Safe loads based on grade 40 or grade 60 field rebar.
5. One #7 rebar may be substituted for two #5 rebars in 8" lintels only.
6. The designer may evaluate concentrated loads from the safe load tables by calculating the maximum resisting moment and shear at d-away from face of support.
7. For composite lintel heights not shown, use safe load from next lower height shown.
8. For lintels lengths not shown, use safe load from next longest length shown.
9. All safe loads in units of pounds per linear foot.
10. All safe loads based on simply supported span.
11. The number in the parenthesis indicates the percent reduction for grade 40 field added rebar. Example 7-5" lintel type 8F32-18 safe gravity load = 6472.

## TYPE DESIGNATION

F = FILLED WITH GROUT / U = UNFILLED  
 QUANTITY OF #5 REBAR  
 BOTTOM OF LINTEL CAVITY

# 8F16-1B/1T

QUANTITY OF  
 REBAR AT TOP

NOMINAL HEIGHT  
 NOMINAL WIDTH

## MATERIALS

1. 8" C<sub>p</sub> precast lintel = 4000 psi
2. 1" C<sub>p</sub> prestressed lintel = 6000 psi
3. Grout per ASTM C476 f<sub>c</sub> = 3000 psi w/ maximum 3/8 inch aggregate & 8 to 11 inch slump
4. Concrete Masonry Units (CMU) per ASTM C90 w/minimum net area compressive strength = 1900 psi
5. Rebar per ASTM A615 grade 60
6. Prestressing strand per ASTM A416 grade 270 low relaxation
7. Mortar per ASTM C270 type M or S

15'-5/8" ACTUAL  
16" NOMINAL HEIGHT

1-1/2" CLEAR

#5 REBAR AT TOP  
MIN. (1) REQ'D

C.M.U.

GROUT

#5 REBAR AT BOTTOM  
LINTEL CAVITY

7'-5/8" ACTUAL  
8" NOMINAL WIDTH

BOTTOM REINFORCING  
PROVIDED IN LINTEL  
(VARIES)

#5 REBAR AT TOP  
MIN. (1) REQ'D

SEE SAFE LATERAL LOAD  
TABLES FOR LOAD RATING  
FOR EACH ADDITIONAL  
REINFORCED CMU FULL  
COURSE

1/2" CLR TYP


(2) #5 REBAR  
GR40 OR GR60

F<sub>m</sub>=1500psi

AT  
ITY

#5  
6"

THIRD PARTY WITHOUT FIRST OBTAINING THE EXPRESS WRITTEN PERMISSION FROM PARK SQUARE HOMES.

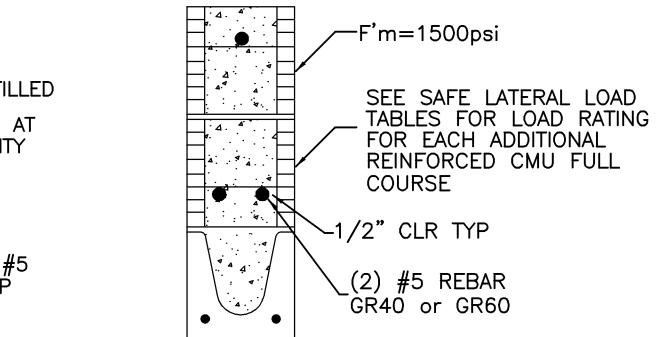



SAFE UPLIFT LOADS FOR 8' PRECAST & PRESTRESSED U-LIMITS								
LENGTH	TYPE	SAFE LOAD - POUNDS PER LINEAR FOOT						
		8'8"-11'	8'12"-11'	8'6"-11'	8'20"-11'	8'24"-11'	8'28"-11'	8'32"-11'
3'-6" (42") PRECAST		1559	2685	4394	5834	6153	6153	7001
		1569	2695	3524	4394	5263	5132	
4'-0" (48") PRECAST		1363	2305	3060	3815	4570	5325	6079
		1363	2305	3060	3815	4570	5325	6079
4'-6" (54") PRECAST		1207	2040	2707	3375	4043	4711	5379
		1207	2040	2707	3375	4043	4711	5379
5'-4" (64") PRECAST		1016	1715(10)	2276	2838	3399	3961	4523
		1016	1715	2276	2838	3399	3961	4523
5'-10" (70") PRECAST		909	1567(10)	2090	2593	3101	3620	4132
		909	1567	2090	2593	3101	3620	4132
6'-6" (78") PRECAST		835	1407	1868(8)	2329	2790(8)	3251(8)	3712(10)
		835	1407	1868	2329	2790	3251	3712
6'-8" (80") PRECAST		727	1267	1684	2025(8)	2426(8)	2827(8)	3228(10)
		727	1267	1684	2025	2426	2827	3228
8'-4" (112") PRECAST		591	708	1136(8)	1474	1815(8)	2157(8)	2500(10)
		591	708	1136	1474	1815	2157	2500
10'-6" (126") PRECAST		591	862	1316	1643	1969	2294	2619
		530	675	916	1188	1461	1736	2011
12'-6" (144") PRECAST		530	595	1110	1442	1763	2055	2346
		474	504	805	1037	1274	1515	1753
14'-6" (168") PRECAST		474	507	1042(12)	1372(12)	1643	1915	2187
		470	485	1042	1372	1643	1915	2187
12'-0" (144") PRECAST		470	550	940	1302	1560(10)	1818(10)	2075(10)
		418	386	907	1267	1585	1923	2261
13'-4" (160") PRECAST		428	450	780	1159	1418	1653(8)	1887(10)
		384	358	560	874	1084	1324	1564
14'-0" (168") PRECAST		410	425	717	1063	1358	1582	1807
		239	334	520	772	1153	1396	1588
14'-8" (176") PRECAST		246	395	663	980	1303(10)	1518(10)	1734(10)
		224	313	508	762	1087	1360	1594
15'-4" (184") PRESTRESSED		230	358	616	908	1240(8)	1460(10)	1668(10)
		187	263	405	521	638	756	873
17'-4" (208") PRESTRESSED		192	306	506	740	950	1271	1475
		147	228	345	477	595	747	864
19'-4" (232") PRESTRESSED		166	263	433	632	841	1059	1227
		144	204	307	493	680	868	1045
21'-4" (256") PRESTRESSED		142	232	373	537	721	905	1048
		137	197	295	379	482	546	613
22'-0" (264") PRESTRESSED		123	232	358	513	688	863	999
		124	179	267	422	542	616	692
24'-0" (288") PRESTRESSED		124	202	319	455	606	757	876

SAFE UPLIFT LOADS FOR 8" PRECAST w/ 2" RECESS DOOR U-LINTELS									
LENGTH \ TYPE		SAFE LOAD - POUNDS PER LINEAR FOOT							
		BRF6-1T	BRF10-1T	BRF14-1T	BRF18-1T	BRF22-1T	BRF26-1T	BRF30-1T	BRF30-2T
4'-4" (52")	PRECAST	905	1668	2362	3056	3751	4445	5140	
4'-6" (54")	PRECAST	867	1604	2272	2939	3607	4275	4943	
5'-8" (68")	PRECAST	867	1604	2272	2939	3607	4275	4943	
5'-10" (70")	PRECAST	855	1233	1746	2259	2773	3286	3799	
6'-8" (80")	PRECAST	570	928 <sub>(04)</sub>	1530 <sub>(04)</sub>	1980 <sub>(04)</sub>	2429 <sub>(04)</sub>	2879 <sub>(04)</sub>	3329 <sub>(04)</sub>	
7'-6" (90")	PRECAST	506	898	1364	1765	2166 <sub>(04)</sub>	2567 <sub>(04)</sub>	2968 <sub>(04)</sub>	
9'-8" (116")	PRECAST	395	468 <sub>(04)</sub>	884 <sub>(04)</sub>	1222 <sub>(04)</sub>	1540 <sub>(04)</sub>	1859 <sub>(04)</sub>	2180 <sub>(04)</sub>	
		395	560	1072	1386	1701	2016	2331	

- ## SAFE LOAD TABLE NOTES
1. All values based on minimum 4 inch nominal bearing. Exception: Safe loads for uniform loads may be reduced if the bearing length is less than 6 1/2 inches.
  2. N.R. = Not Rated
  3. Safe loads may be superimposed allowable loads.
  4. Safe loads based on grade 40 or grade 60 reinforcement.
  5. One #7 rebar may be substituted for two #5 rebars in 8" intervals only.
  6. The designer may evaluate concentrated loads by using the following formulae by calculating the maximum resisting moment and shear at d-away from the face of support.
  7. For spans less than 10 feet, use safe load from next lower height shown.
  8. For intels lengths not shown, use safe load from next lower height shown.
  9. All safe loads in units of pounds per linear foot.
  10. All safe loads based on simply supported span.
  11. The number in the parenthesis indicates the percent reduction for grade 40 steel added rebar. Example 7-6" intel type 8F32-18 safe gravity load = 6472.

**TERIALS**

f'c 8" precast lintel = 4000 psi  
f'c prestressed lintel = 6000 psi  
Grout per ASTM C-476 f'c = 3000 psi w/ maximum  
inch aggregate & 8 to 11 inch slump  
Concrete Masonry Units (CMU) per ASTM C90 w/  
net area compressive strength = 1900 psi  
Rebar per ASTM A615 grade 60  
Prestressing strand per ASTM A416 grade 270 to  
relaxation 3  
Mortar per ASTM C270 type M or S

#5 REBAR AT TOP  
MIN. (1) REQ'D  
1-1/2" CLEAR  
C.M.U.  
GROUT  
#5 REBAR AT BOTTOM  
OF LINTEL. REINFORCING  
BOTTOM REINFORCING  
PROVIDED IN LINTEL  
(VARIES)

15-15/8" ACTUAL  
16" NOMINAL HEIGHT  
8" NOMINAL WIDTH  
7-5/8" ACTUAL

TYPE DESIGNATION

F = FILLED WITH GROUT / U = UNFILLED

QUANTITY OF #5 REBAR AT BOTTOM OF LINTEL CAVITY

QUANTITY OF #5 REBAR AT TOP

NOMINAL WIDTH

NOMINAL HEIGHT


8F16-1B/1T

SEE EACH LATERAL LOAD TABLE FOR LOAD RATIO FOR EACH ADDITIONAL REINFORCED CMU FULL COURSE

1/2" CLR TYP

(2) #5 REBAR GR40 or GR60

F'm=1500psi

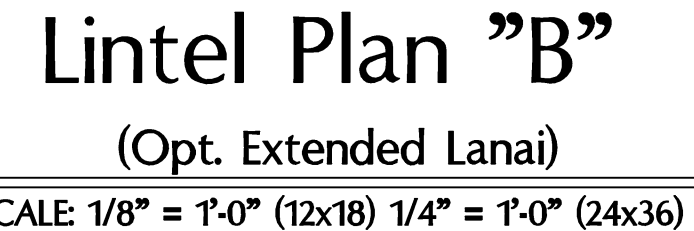



SAFE GRAVITY LOADS FOR 8" PRECAST & PRESTRESSED U-LINTELS									
SAFE LOAD - POUNDS PER LINEAR FOOT									
LENGTH	TYPE	8U8	8F8-08	8F12-08	8F16-08	8F20-08	8F24-08	8F28-08	8F32-08
3'-6" (42")	PRECAST	2231	3069	3719	5163	6607	8054	9502	10951
4'-0" (48")	PRECAST	1966	2689	4605	6113	7547	8974	10394	11869
4'-6" (54")	PRECAST	1599	1969	2110	2931	3753	4576	5400	6224
5'-4" (64")	PRECAST	1217	2189	4375	6113	7547	8974	10394	11869
5'-10" (70")	PRECAST	1062	1340	1438	1999	2560	3123	3686	4249
6'-6" (78")	PRECAST	908	1217	1663	3090	5360	7547	9732	11918
7'-6" (90")	PRECAST	743	1011	1729	2632	3225	2698	3191	3685
9'-4" (112")	PRECAST	554	699	1160	1625	2564	3486	2818	3302
10'-6" (126")	PRECAST	475	752	1245	1843	2564	3486	4705	6390
11'-4" (136")	PRECAST	362	582	890	1247	2093	2777	2163	2536
12'-0" (144")	PRECAST	337	540	873	1254	1884	2193	2805	3552
13'-4" (160")	PRECAST	296	471	755	1075	1428	1838	2316	2883
14'-0" (168")	PRECAST	279	424	706	1002	1326	1697	2127	2630
14'-8" (176")	PRESTRESSED	N.R.	458	783	1370	1902	2245	2517	2712
15'-4" (184")	PRESTRESSED	N.R.	NR	NR	NR	NR	NR	NR	NR
17'-4" (208")	PRESTRESSED	N.R.	NR	NR	NR	NR	NR	NR	NR
19'-4" (232")	PRESTRESSED	N.R.	NR	NR	NR	NR	NR	NR	NR
21'-4" (256")	PRESTRESSED	N.R.	NR	NR	NR	NR	NR	NR	NR
22'-0" (264")	PRESTRESSED	N.R.	NR	NR	NR	NR	NR	NR	NR
24'-0" (288")	PRESTRESSED	N.R.	NR	NR	NR	NR	NR	NR	NR

(#) THE NUMBERS IN PARENTHESIS ARE PERCENT REDUCTIONS FOR GRADE 40 FIELD ADDED REBAR.

NOTE:  
ALL LINTELS OVER 9'-0" IN LENGTH NEED TO BE SHORED DURING GROUTING.  
CONTRACTOR SHALL FOLLOW PRECAST MANUFACTURER'S RECOMMENDATIONS REGARDING THE SHORING OF GROUTED LINTELS

SAFE UPLIFT LOADS FOR 8" PRECAST & PRESTRESSED U-LINTELS									
SAFE LOAD - POUNDS PER LINEAR FOOT									
LENGTH	TYPE	8F8-1T	8F12-1T	8F16-1T	8F20-1T	8F24-1T	8F28-1T	8F32-1T	8F32-1T
3'-6" (42")	PRECAST	1569	2655	3524	4394	5263	6132	7001	7870
4'-0" (48")	PRECAST	1363	2305	3060	3815	4570	5325	6079	6833
4'-6" (54")	PRECAST	1207	2040	2707	3375	4043	4711	5379	6047
5'-4" (64")	PRECAST	1016	1715	2276	2838	3399	3961	4522	5083
5'-10" (70")	PRECAST	929	1567	2080	2593	3107	3620	4133	4646
6'-6" (78")	PRECAST	835	1407	1868	2329	2790	3251	3712	4173
7'-6" (90")	PRECAST	727	1224	1624	2025	2426	2827	3228	3629
9'-4" (112")	PRECAST	591	708	1136	1474	1815	2157	2500	2842
10'-6" (126")	PRECAST	530	575	916	1188	1461	1736	2011	2286
11'-4" (136")	PRECAST	474	504	800	1037	1274	1513	1753	2000
12'-0" (144")	PRECAST	424	454	704	904	1104	1304	1504	1704
13'-4" (160")	PRECAST	384	414	634	834	1034	1234	1434	1634
14'-0" (168")	PRECAST	344	374	574	774	974	1174	1374	1574
14'-8" (176")	PRESTRESSED	239	334	429	524	619	714	809	904
15'-4" (184")	PRESTRESSED	246	395	663	980	1303	1618	1934	2249
17'-4" (208")	PRESTRESSED	224	313	498	627	769	911	1054	1196
19'-4" (232")	PRESTRESSED	230	368	618	908	1240	1560	1880	2200
21'-4" (256")	PRESTRESSED	187	263	405	521	638	756	873	990
22'-0" (264")	PRESTRESSED	192	306	508	740	1005	1271	1537	1803
24'-0" (288")	PRESTRESSED	162	229	348	447	547	647	747	847
22'-0" (264")	PRESTRESSED	166	263	429	623	841	1059	1277	1495
24'-0" (288")	PRESTRESSED	142	204	307	383	480	568	655	742
22'-0" (264")	PRESTRESSED	142	232	373	537	721	905	1048	1191
24'-0" (288")	PRESTRESSED	137	197	295	379	462	546	630	714
22'-0" (264")	PRESTRESSED	137	223	358	513	688	863	999	1135
24'-0" (288")	PRESTRESSED	124	179	267	342	416	492	567	642
24'-0" (288")	PRESTRESSED	124	202	319	455	606	757	907	1057

SAFE GRAVITY LOADS FOR 8" PRECAST w/ 2" RECESS DOOR U-LINTELS									
SAFE LOAD - POUNDS PER LINEAR FOOT									
LENGTH	TYPE	8RU8	8F8-08	8F10-08	8F14-08	8F18-08	8F22-08	8F26-08	8F30-08
4'-4" (52")	PRECAST	1635	1749	3355	3280	4349	5421	6493	7567
4'-6" (54")	PRECAST	1494	1891	3699	5206	6639	8060	9479	10893
5'-8" (68")	PRECAST	866	1596	3263	2892	3968	4940	5924	6904
5'-10" (70")	PRECAST	810	1113	2342	4242	6639	8060	9479	10893
6'-8" (80")	PRECAST	797	901	1825	3120	5048	7747	9448	11149
7'-6" (90")	PRECAST	669	755	1490	2459	3776	5743	7239	8735
9'-8" (116")	PRECAST	411	466	999	1568	2253	3129	4150	5891




(#) THE NUMBERS IN PARENTHESIS ARE PERCENT REDUCTIONS FOR GRADE 40 FIELD ADDED REBAR.

LINTEL SCHEDULE				
LINTEL NO.	LENGTH	TYPE	COMMENTS	
L-1	9'-4"	8F40-1B/1T		
L-2	4'-6"	8F24-0B/1T		
L-3	5'-4"	8F24-0B/1T		
L-4	7'-6"	8F24-1B/1T		
L-5	3'-6"	8F24-0B/1T		
L-6	10'-6"	8F24-1B/1T		
L-7	17'-4"	8F24-1B/1T		
L-8	24'-0"	8F16-1B/1T	MODIFY AS REQ'D	
L-9	10'-6"	8F16-1B/1T	MODIFY AS REQ'D	
L-10	7'-6"	8RF62-1B/1T		
L-11	6'-6"	8F24-1B/1T	MODIFY AS REQ'D	
L-12	9'-4"	8F48-1B/1T	MODIFY AS REQ'D	
L-13	7'-6"	8F48-1B/1T		
L-14	7'-6"	8F16-1B/1T		
L-15	4'-0"	8F48-0B/1T	OPT. SRVC. DOOR	

SAFE UPLIFT LOADS FOR 8" PRECAST w/ 2" RECESS DOOR U-LINTELS									
SAFE LOAD - POUNDS PER LINEAR FOOT									
LENGTH	TYPE	8F8-1T	8F10-1T	8F14-1T	8F18-1T	8F22-1T	8F26-1T	8F30-1T	8F32-1T
4'-4" (52")	PRECAST	905	1668	2362	3056	3751	4445	5140	5835
4'-6" (54")	PRECAST	867	1604	2272	2939	3607	4275	4943	5611
5'-8" (68")	PRECAST	675	1289	1797	2326	2854	3382	3911	4440
5'-10" (70")	PRECAST	675	1289	1797	2326	2854	3382	3911	4440
6'-8" (80")	PRECAST	570	929	1530	2186	2879	3572	4265	4958
7'-6" (90")	PRECAST	506	742	1364	1785	2186	2587	2988	3389
9'-8" (116")	PRECAST	395	468	884	1222	1540	1859	2180	2501

- GENERAL NOTES
- Provide full mortar bed and head joints.
  - Shore filled lintels as required.
  - Installation of lintel must comply with the architectural and/or structural documents.
  - U-Lintels are manufactured with 5 1/2" long notches at the ends to accommodate vertical cell reinforcing and grouting.
  - Reference the CAST-CRTE Load Deflection Graph brochure for lintel deflection information.
  - Bottom field added rebar to be located at the bottom of the lintel cavity.
  - 7/32" diameter wire stirrups are welded to the bottom steel for mechanical anchorage.
  - Cast-in-place concrete may be provided in composite lintel in lieu of concrete masonry units.
  - Reference the CAST-CRTE Load Deflection Graph brochure for lintel deflection information.
  - The exterior surface of lintels installed in exterior concrete masonry walls shall have a coating of stucco applied in accordance with ASTM C-296 or other approved coating.
  - Lintels loaded simultaneously with vertical (gravity or uplift) and horizontal (lateral) loads should be checked for the combined loading with the following equation:  
$$\frac{\text{Applied vertical load}}{\text{Safe vertical load}} + \frac{\text{Applied horizontal load}}{\text{Safe horizontal load}} \leq 1.0$$
  - Additional lateral load capacity can be obtained by the designer by providing additional reinforced concrete masonry above the lintel. See detail at right.

- SAFE LOAD TABLE NOTES
- All values based on minimum 4 inch nominal bearing. Exception: Safe loads for unfilled lintels must be reduced by 20% if bearing length is less than 6 1/2 inches.
  - N.R. = Not Rated
  - Safe loads are superimposed allowable loads.
  - Safe loads based on grade 40 or grade 60 field rebar.
  - One #7 rebar may be substituted for two #5 rebars in 8" lintels only.
  - The designer may evaluate concentrated loads from the safe load tables by calculating the maximum resisting moment and shear at d-away from face of support.
  - For composite lintel heights not shown, use safe load from next lower height shown.
  - For lintels lengths not shown, use safe load from next longest length shown.
  - All safe loads in units of pounds per linear foot.
  - All safe loads based on simply supported span.
  - The number in the the parenthesis indicates the percent reduction for grade 40 field added rebar. Example 7'-6" lintel type 8F32-1B safe gravity load = 6472.

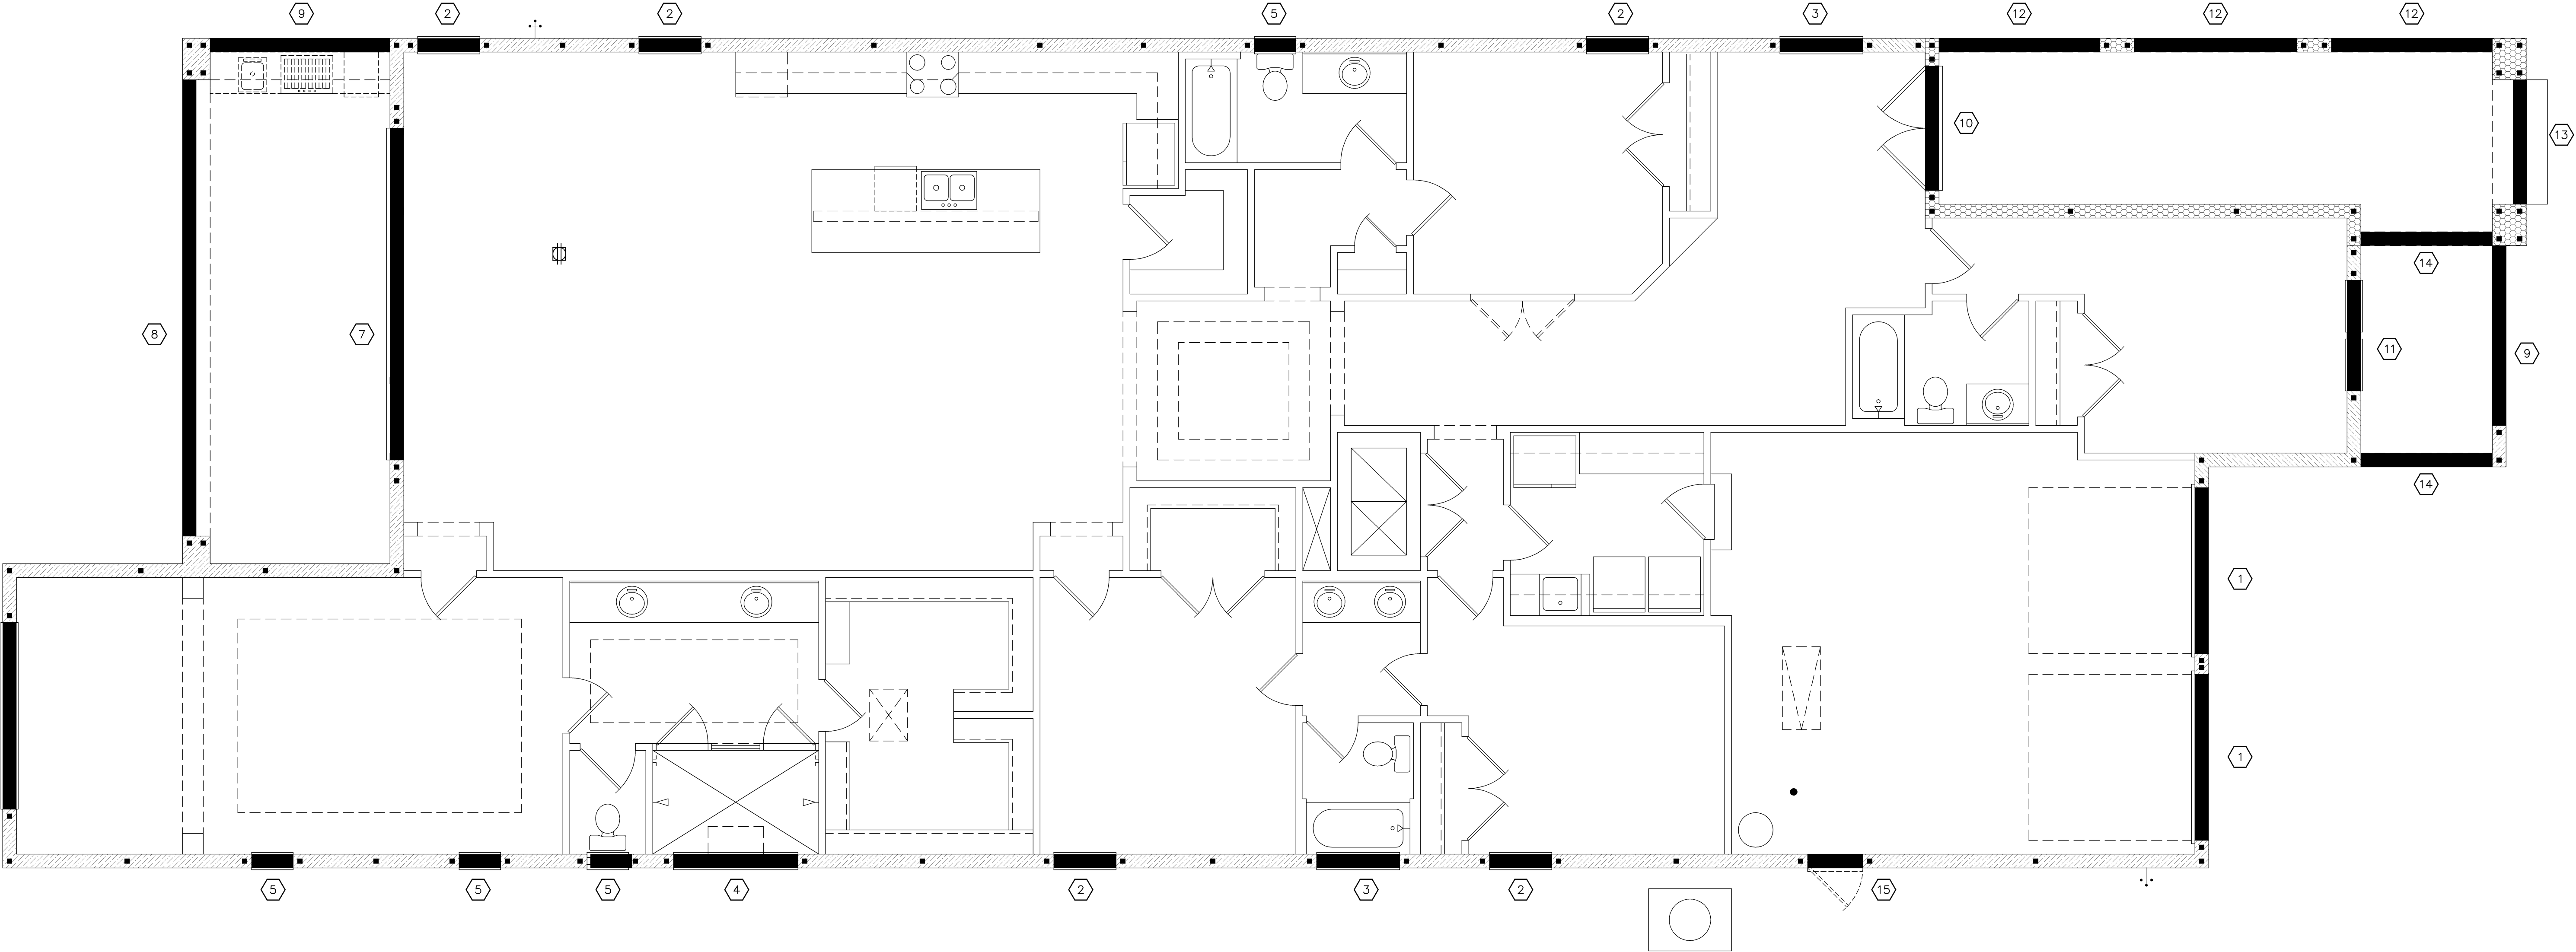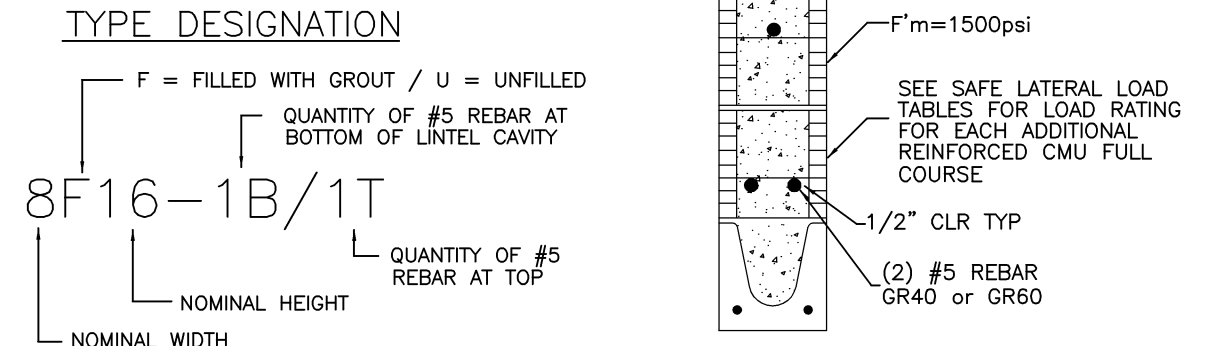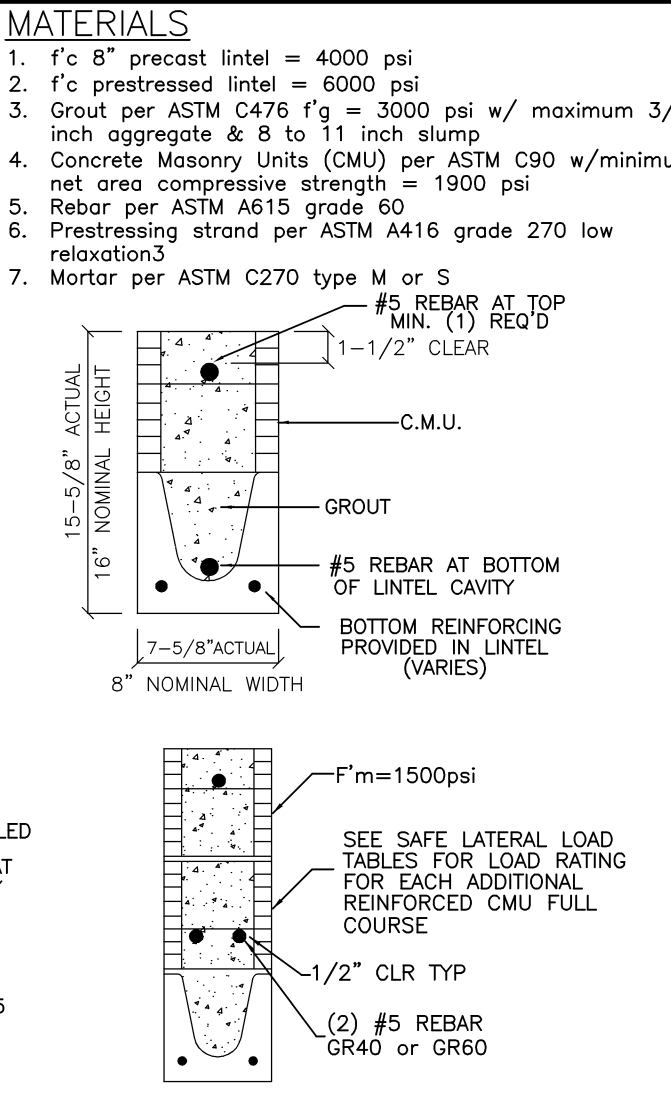

Lintel Plan "C"  
(Opt. Sitting Room)  
SCALE: 1/8" = 1'-0" (12x18) 1/4" = 1'-0" (24x36)

40-3164

DORCHESTER

Street Address

Lot Info

City, State, Zip

A Division of Park Square Enterprises Inc.

5200 Vineland Rd. Suite #200

Orlando, FL 32811

Phone: (407) 525-3000

ISSUE DATE: 00/00/0000

REVISIONS:

PROJECT: 00-0000

SCALE: AS NOTED

DRAWN BY: C.C.

DESIGNED BY: MJS

INTTEL PLAN

08.C1

815 Orienta Ave. Suite# 1040

Altamonte Springs, FL 32701

Ph: (407) 629-6711

Fax: (407) 629-6776

CUSTOM HOME DESIGN

DESIGNERS - PLANNERS

www.mjshomedesigns.com

When plans have been electronically signed & sealed by M.J.S. Designers, Inc. the original signature is not required. Plans must be verified on electronic copies.

235 Maitland Avenue S.

Suite 108-A

Maitland, FL 32751

Ph: (407) 227-7416

www.premier-structural.com

FL CERT. AUTH.: 28113

FL. P.E.#: 80269

PREMIER

STRUCTURAL ENGINEERS, INC.

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SAFE GRAVITY LOADS FOR 8" PRECAST & PRESTRESSED U-LINTELS									
LENGTH	TYPE	BUB	SAFE LOAD - POUNDS PER LINEAR FOOT						
			8F8-08	8F12-08	8F16-08	8F20-08	8F24-08	8F28-08	8F32-08
3'-6" (42")	PRECAST	2231	3069	3719	5163	6607	8054	9502	10951
4'-0" (48")	PRECAST	1966	3069	4605	6113	7547	8974	10394	11869
4'-6" (54")	PRECAST	1599	2561	2751	3620	4680	5861	7034	8107
5'-4" (64")	PRECAST	1217	2693	4605	6113	7547	8974	10394	11869
5'-10" (70")	PRECAST	1062	1969	2110	2931	3753	4576	5400	6224
6'-6" (78")	PRECAST	908	2189	4375	6113	7547	8974	10394	11869
7'-6" (90")	PRECAST	743	1340	1438	1999	2560	3123	3686	4249
9'-4" (112")	PRECAST	554	1663	3090	5365	7547	9729	11911	14093
10'-6" (126")	PRECAST	475	1105	1173	1631	2090	2549	3009	3470
11'-4" (136")	PRECAST	362	1451	2622	4360	7168	9976	12784	15592
12'-0" (144")	PRECAST	337	1238	2177	3480	5031	6707	8383	10059
13'-4" (160")	PRECAST	296	1011	1729	2632	3535	4438	5341	6244
14'-0" (168")	PRECAST	279	1011	1729	2661	3698	5681	7664	9647
14'-8" (176")	PRESTRESSED	N.R.	699	1160	1625	2564	3466	4368	5270
15'-4" (184")	PRESTRESSED	N.R.	752	1245	1843	2564	3466	4368	5270
17'-4" (208")	PRESTRESSED	N.R.	535	899	1247	2093	2777	3461	4145
19'-4" (232")	PRESTRESSED	N.R.	458	783	1370	1902	2245	2517	2712
21'-4" (256")	PRESTRESSED	N.R.	NR	NR	NR	NR	NR	NR	NR
22'-0" (264")	PRESTRESSED	N.R.	NR	NR	NR	NR	NR	NR	NR
24'-0" (288")	PRESTRESSED	N.R.	NR	NR	NR	NR	NR	NR	NR

SAFE UPLIFT LOADS FOR 8" PRECAST & PRESTRESSED U-LINTELS									
LENGTH	TYPE	BUB	SAFE LOAD - POUNDS PER LINEAR FOOT						
			8F8-1T	8F12-1T	8F16-1T	8F20-1T	8F24-1T	8F28-1T	8F32-1T
3'-6" (42")	PRECAST	1569	2655	3524	4394	5263	6132	7001	7870
4'-0" (48")	PRECAST	1363	2305	3060	3815	4570	5325	6079	6834
4'-6" (54")	PRECAST	1207	2040	2707	3375	4043	4711	5379	6047
5'-4" (64")	PRECAST	1016	1715	2276	2838	3399	3961	4522	5083
5'-10" (70")	PRECAST	909	1567	2080	2593	3107	3620	4133	4646
6'-6" (78")	PRECAST	835	1407	1868	2329	2790	3251	3712	4173
7'-6" (90")	PRECAST	727	1224	1624	2025	2426	2827	3228	3629
9'-4" (112")	PRECAST	591	862	1318	1843	2368	2893	3418	3943
10'-6" (126")	PRECAST	530	575	916	1188	1461	1735	2010	2284
11'-4" (136")	PRECAST	474	504	800	1037	1274	1513	1753	1993
12'-0" (144")	PRECAST	494	467	704	941	1178	1415	1652	1889
13'-4" (160")	PRECAST	410	425	717	954	1191	1428	1665	1902
14'-0" (168")	PRECAST	384	358	608	845	1082	1319	1556	1793
14'-8" (176")	PRESTRESSED	239	334	520	672	825	978	1131	1284
15'-4" (184")	PRESTRESSED	246	395	663	980	1303	1616	1929	2242
17'-4" (208")	PRESTRESSED	224	313	496	627	759	891	1023	1155
19'-4" (232")	PRESTRESSED	230	368	616	908	1240	1572	1904	2236
21'-4" (256")	PRESTRESSED	187	263	405	521	638	756	873	990
22'-0" (264")	PRESTRESSED	192	306	506	740	974	1208	1442	1676
24'-0" (288")	PRESTRESSED	162	229	348	447	547	647	747	847
22'-0" (264")	PRESTRESSED	166	263	429	623	817	1011	1205	1399
24'-0" (288")	PRESTRESSED	142	204	307	393	480	568	655	743
22'-0" (264")	PRESTRESSED	142	232	373	537	721	905	1089	1273
24'-0" (288")	PRESTRESSED	137	197	295	379	462	546	630	714
22'-0" (264")	PRESTRESSED	137	223	358	513	677	841	1005	1169
24'-0" (288")	PRESTRESSED	124	179	267	342	416	492	567	643
22'-0" (264")	PRESTRESSED	124	202	319	455	599	743	887	1031



SAFE GRAVITY LOADS FOR 8" PRECAST w/ 2" RECESS DOOR U-LINTELS									
LENGTH	TYPE	BUB	SAFE LOAD - POUNDS PER LINEAR FOOT						
			8F8-08	8F10-08	8F14-08	8F18-08	8F22-08	8F26-08	8F30-08
4'-4" (52")	PRECAST	1635	1749	3355	3280	4349	5421	6493	7567
4'-6" (54")	PRECAST	1494	1891	3699	5206	6639	8060	9479	10893
5'-8" (68")	PRECAST	866	1596	3263	2892	3968	4640	5312	5984
5'-10" (70")	PRECAST	810	1756	3699	5206	6639	8060	9479	10893
6'-8" (80")	PRECAST	797	920	1770	1716	2277	2839	3402	3966
7'-6" (90")	PRECAST	669	1167	2481	4567	6389	8060	9731	11402
9'-8" (116")	PRECAST	411	859	1653	1600	2124	2649	3174	3700
9'-8" (116")	PRECAST	411	1113	2342	4242	6639	8060	9479	10893
9'-8" (116")	PRECAST	411	901	1825	3120	5048	7747	9448	11149
9'-8" (116")	PRECAST	411	901	1825	3120	5048	7915	9479	10893
9'-8" (116")	PRECAST	411	755	1490	2459	3776	5743	7239	8623
9'-8" (116")	PRECAST	411	466	999	1568	2253	3129	4150	5891

LINTEL SCHEDULE				
LINTEL NO.	LENGTH	TYPE	COMMENTS	
L-1	9'-4"	8F40-1B/1T		
L-2	4'-6"	8F24-0B/1T		
L-3	5'-4"	8F24-0B/1T		
L-4	7'-6"	8F24-1B/1T		
L-5	3'-6"	8F24-0B/1T		
L-6	10'-6"	8F24-1B/1T		
L-7	17'-4"	8F24-1B/1T		
L-8	10'-6"	8F16-1B/1T	MODIFY AS REQ'D	
L-9	24'-0"	8F16-1B/1T	MODIFY AS REQ'D	
L-10	21'-4"	8F16-1B/1T	MODIFY AS REQ'D	
L-11	7'-6"	8RF62-1B/1T		
L-12	6'-6"	8F24-1B/1T	MODIFY AS REQ'D	
L-13	9'-4"	8F48-1B/1T	MODIFY AS REQ'D	
L-14	7'-6"	8F48-1B/1T		
L-15	7'-6"	8F16-1B/1T		
L-16	4'-0"	8F48-0B/1T	OPT. SRVC. DOOR	

SAFE UPLIFT LOADS FOR 8" PRECAST w/ 2" RECESS DOOR U-LINTELS									
LENGTH	TYPE	BUB	SAFE LOAD - POUNDS PER LINEAR FOOT						
			8F8-1T	8F10-1T	8F14-1T	8F18-1T	8F22-1T	8F26-1T	8F30-1T
4'-4" (52")	PRECAST	1635	905	1668	2362	3056	3751	4445	5140
4'-6" (54")	PRECAST	1494	905	1668	2362	3056	3751	4445	5140
5'-8" (68")	PRECAST	866	867	1604	2272	2939	3607	4275	4943
5'-10" (70")	PRECAST	810	867	1604	2272	2939	3607	4275	4943
6'-8" (80")	PRECAST	797	675	1289	1797	2325	2854	3382	3911
7'-6" (90")	PRECAST	669	675	1289	1797	2325	2854	3382	3911
9'-8" (116")	PRECAST	411	655	1207	1746	2259	2773	3286	3799
9'-8" (116")	PRECAST	411	655	1233	1746	2259	2773	3286	3799
9'-8" (116")	PRECAST	411	570	929	1530	1980	2429	2879	3329
9'-8" (116")	PRECAST	411	570	1080	1530	1980	2429	2879	3329
9'-8" (116")	PRECAST	411	506	742	1364	1765	2166	2567	2968
9'-8" (116")	PRECAST	411	506	898	1364	1765	2166	2567	2968
9'-8" (116")	PRECAST	411	395	468	884	1222	1540	1859	2180
9'-8" (116")	PRECAST	411	395	560	1072	1386	1701	2016	2331

- GENERAL NOTES**
- Provide full mortar bed and head joints.
  - Shore filled lintels as required.
  - Installation of lintel must comply with the architectural and/or structural documents.
  - U-Intels are manufactured with 5 1/2" long notches at the ends to accommodate vertical cell reinforcing and grouting.
  - Reference the CAST-CRTE Load Deflection Graph brochure for lintel deflection information.
  - Bottom field added rebar to be located at the bottom of the lintel cavity.
  - 7/32" diameter wire stirrups are welded to the bottom steel for mechanical anchorage.
  - Cast-in-place concrete may be provided in composite lintel in lieu of concrete masonry units.
  - Safe load rating based on rational design analysis per ACI 318 and ACI 550.
  - The exterior surface of lintels installed in exterior concrete masonry walls shall have a coating of stucco applied in accordance with ASTM C-296 or other approved coating.
  - Lintels loaded simultaneously with vertical (gravity or uplift) and horizontal (lateral) loads should be checked for the combined loading with the following equation:  
$$\frac{\text{Applied vertical load}}{\text{Safe vertical load}} + \frac{\text{Applied horizontal load}}{\text{Safe horizontal load}} \leq 1.0$$
  - Additional lateral load capacity can be obtained by the designer by providing additional reinforced concrete masonry above the lintel. See detail at right.

- SAFE LOAD TABLE NOTES**
- All values based on minimum 4 inch nominal bearing. Exception: Safe loads for unfilled lintels must be reduced by 20% if bearing length is less than 6 1/2 inches.
  - N.R. = Not Rated
  - Safe loads are superimposed allowable loads.
  - Safe loads based on grade 40 or grade 60 field rebar.
  - One #7 rebar may be substituted for two #5 rebars in 8" lintels only.
  - The designer may evaluate concentrated loads from the safe load tables by calculating the maximum resisting moment and shear at d-away from face of support.
  - For composite lintel heights not shown, use safe load from next lower height shown.
  - For lintels lengths not shown, use safe load from next longest length shown.
  - All safe loads in units of pounds per linear foot.
  - All safe loads based on simply supported span.
  - The number in the parenthesis indicates the percent reduction for grade 40 field added rebar. Example 7'-6" lintel type 8F32-1B safe gravity load = 6472.

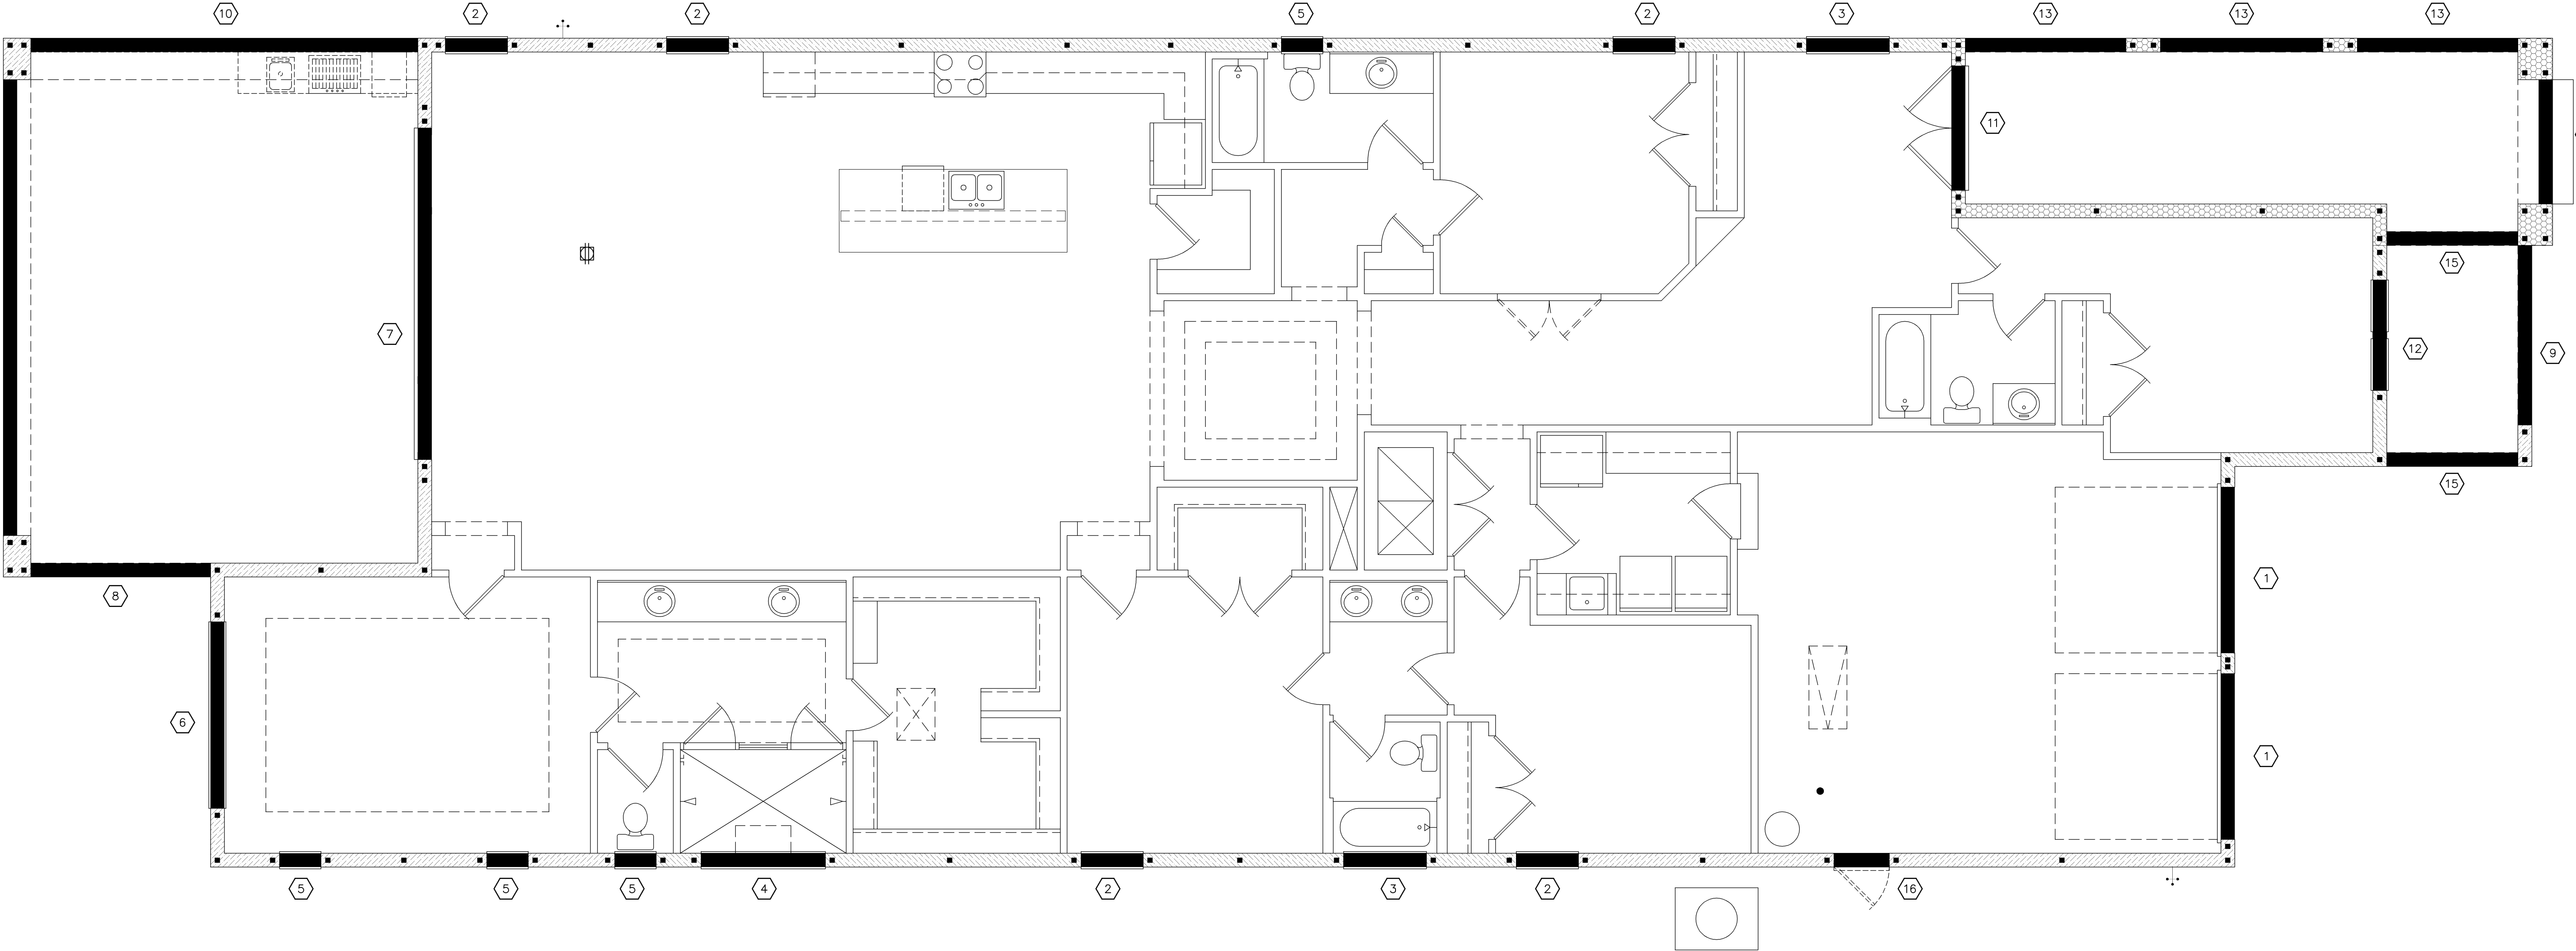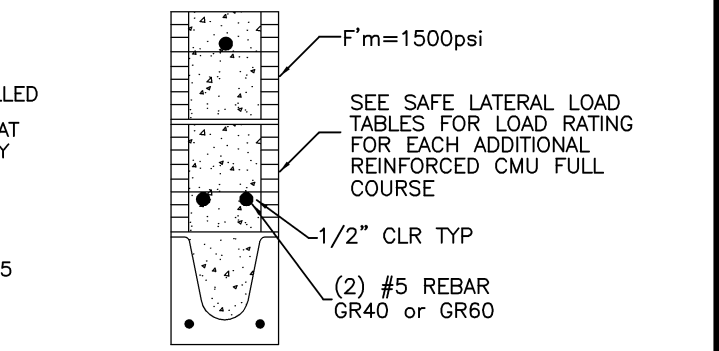

Lintel Plan "C"  
(Opt. Extended Lanai)  
SCALE: 1/8" = 1'-0" (12x18) 1/4" = 1'-0" (24x36)

235 Maitland Avenue S.  
Suite 108-A  
Maitland, FL 32751  
Ph: (407) 227-7416  
www.premier-structural.com  
FL CERT. AUTH.: 28113  
PE: #0029

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Altamonte Springs, FL 32701  
Ph: (407) 629-6711  
Fax: (407) 629-6716  
www.mjshomedesigns.com

**MJS**  
CUSTOM HOME DESIGN  
DESIGNERS - PLANNERS

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Contractor shall verify and be responsible for dimensions and conditions of the job and MJS shall not be responsible for any errors or omissions on the part of the contractor.

40-3164  
**DORCHESTER**  
Street Address  
Lot Info  
City, State, Zip

A Division of Park Square  
Enterprises Inc.  
5200 Vineland Rd. Suite #200  
Orlando, FL 32811  
Phone: (407) 525-3000

**Park Square HOMES**

ISSUE DATE: 00/00/0000

REVISIONS

PROJECT: 00-0000  
SCALE: AS NOTED  
DRAWN BY: C.C.  
DESIGNED BY: MJS

LINTEL PLAN  
**08.C2**

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### BRG. HT. LEGEND

- (E)** 5/16"x1/2" 18E PARALLAM PSL COLUMN SECURED W/ SIMPSON HTT-5 AT BOTTOM AND (3) HTS-20 AT TOP
- (H-1)** SPECIAL HEADERS:  
(1) 1 1/2" x 12" L.V.L. HEADER SUPPORTED ON EA. SIDE BY (3) 2x JACK STUDS WITH (3) 2x FULL LENGTH STUDS ADJACENT. USE SP-1 @ BOTTOM OF EACH STUD & (2) MSTA-24 FROM STUD TO HEADER AT TOP ON EACH SIDE.
- (H-2)** (2) 2"x12" BEAM WITH 1/2" PLYWOOD FLITCH SUPPORTED ON EACH SIDE WITH (2) 2x JACK STUDS WITH (2) 2x FULL LENGTH STUDS ADJACENT. USE SP-1 @ BOTTOM OF EACH STUD & (2) LSTA-24 FROM STUD TO HEADER AT TOP ON EACH SIDE.

1. EACH FLOOR TRUSS ATTACHED TO CMU WITH (1) HETA-16 AND (1) MTS-12 AT FRAME CONNECTION (U.N.O.)
2. EACH ROOF TRUSS / RAFTER AT CMU. TO BE ATTACHED WITH (1) HETA-16 (U.N.O.) SEE CONNECTOR SCHEDULE FOR NAILING REQUIRED.
3. EACH ROOF TRUSS / RAFTER AT FRAME CONNECTION TO BE (1) MTS-12 AT ALL COMMON TRUSSES & (1) H2.5 AT ALL HIP JACKS (U.N.O.) SEE CONNECTOR SCHEDULE FOR NAILING REQUIRED.
4. END JACKS AND CORNER SETS MAY BE (1) H2.5 (U.N.O.)
5. ROOF SHEATHING TO BE 1/2" NOMINAL OR GREATER OSB. OR CDX. TYPE PLYWOOD NAILED WITH .0992" RING

SHANK NAILS @ 6" O.C. EXCEPT FIRST 4'-0" OF ENTIRE PERIMETER WHICH SHALL BE 6" O.C. FIELD 4" O.C. EDGE WALL SHEATHING TO BE 7/16" OSB. OR 1/2" CDX. NAILED WITH 8d CORROSION RESISTANT NAILS @ 6" O.C. IN FIELD & 4" O.C. @ EDGE (U.N.O.). SEE SHEATHING DETAIL.

6. FLOOR SHEATHING TO BE  $\frac{3}{4}$ " PLYWOOD OR OSB (U.N.O), WITH LONG DIMENSION PERPENDICULAR TO SUPPORT (FLOOR TRUSSES). NAILS: NAILS USED IN ALL FLOORING APPLICATIONS SHALL BE 8d, RING OR SPIRAL SHANK, HAND OR GUN DRIVEN NAILS. GUN DRIVEN NAILS SHALL HAVE HEAD SIZE EQUIVALENT TO HAND DRIVEN NAILS, SPACING SHALL BE 6" ON EDGES AND 12" IN FIELD.

1. TRUSS LAYOUT IS AN ARTISTIC REPRESENTATION AND MAY VARY FROM FINAL LAYOUT SUBMITTED BY TRUSS MANUFACTURER. ALL TRUSS LAYOUTS AND PROFILES SHALL BE DESIGNED AND CERTIFIED BY TRUSS MANUFACTURER'S REGISTERED ENGINEER.
- IF TRUSS LAYOUT / ENGINEERING IS CHANGED OR ALTERED FROM ITS ORIGINAL MASTER FILE, THE E.O.R AND DESIGNER MUST BE NOTIFIED IMMEDIATELY AND WILL NOT BE HELD LIABLE.
2. TRUSS MANUFACTURER TO VERIFY ALL TRUSS MANUFACTURER SLOPES, BEARING POINTS, & DIMENSIONS BEFORE FABRICATION. TRUSS MANUFACTURER SHALL COORDINATE LOCATIONS FOR MECHANICAL AND PLUMBING CHASES TO AVOID CONFLICT. ALSO, TRUSS MANUFACTURER TO PROVIDE SHOP DRAWINGS FOR APPROVAL BEFORE FABRICATION.
3. ALL ROOF PITCHES ARE TO BE SET AS INDICATED ON PLANS AND ELEVATIONS.
4. TOP PLATE HEIGHTS VARY. SEE BUILDING SECTIONS, WALL SECTIONS, & ELEVATIONS FOR BEARING HEIGHTS.


6. TRUSS SPACING SHALL BE 24" O.C. (U.N.O.) CONVENTIONAL FRAMING SHALL BE 16" O.C.
7. TRUSS MANUFACTURER TO PROVIDE ALL GABLE END TRUSSES WITH INTERMEDIATE STUD MEMBERS @ 16" O.C.
8. ROOF DECKING AS SPECIFIED.
9. ALL ROOF OVERHANGS TO BE 12" UNLESS NOTED OTHERWISE.
10. FRAME WALLS UP TO UNDERSIDE OF ROOF TRUSSES AT ALL NON BEARING WALLS AND AT VOLUME AREAS (U.N.O.).
11. ALIGN TRUSSES AND HAND FRAMING SO AS ALL GYPSUM WALL BOARD TO BE CONTINUOUS FROM FLOOR TO CEILING.
12. TRUSS MANUFACTURER TO INSURE DESIGN CONSIDERATION TO THE FOLLOWING ADDITIONAL LOADS:

- 12.1. ALL CEILING HUNG SHOWS AND SHOWS IN CABINETS AS SHOWN ON PLANS.
- 12.2. ATTIC LOCATED HVAC UNITS AS SHOWN ON PLANS.
13. PROVIDE AND INSTALL FLASHING & ROOFING AS PER NATIONAL ROOFING AND SHEET METAL ASSOC. STANDARDS AND/OR ACCEPTABLE INDUSTRY PRACTICE, IN ACCORDANCE WITH FBCR 2017, 6TH EDITION
14. TRUSSES SHALL BE BRACED TO PREVENT ROTATION & PROVIDE LATERAL STABILITY IN ACCORDANCE WITH THE REQUIREMENTS SPECIFIED IN THE CONSTRUCTION DOCUMENTS FOR BRACING OF AN INDIVIDUAL TRUSS DESIGN DRAWINGS. IN THE ABSENCE OF SPECIFIC BRACING REQUIREMENTS, TRUSSES SHALL BE BRACED IN ACCORDANCE WITH TPWPCA BC51.1
15. REFER TO TRUSS MANUFACTURERS DRAWINGS FOR TRUSS PLACEMENT & TRUSS TO TRUSS CONNECTIONS.
16. SHINGLE ROOF: UNDERLAYMENT TO BE INSTALLED IAW FBCR 2017, 6TH EDITION

■ INDICATES A CONCRETE FILLED CELL WITHIN AN 8" C-MU LAID CONTAINING (1) VERT. #5 REBAR CONT. FROM FOUNDATION SLAB TO BOND BEAM. PROVIDE A MIN. OF 25" LAP ON ALL STEEL REINFORCING BARS.

9'-4" BRG. HT.	12'-0" BRG. HT.	15'-0" BRG. HT.
0'-0" BRG. HT.	13'-4" BRG. HT.	16'-0" BRG. HT.
1'-4" BRG. HT.	14'-0" BRG. HT.	BRG. PER PLAN

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235 Maitland Avenue S

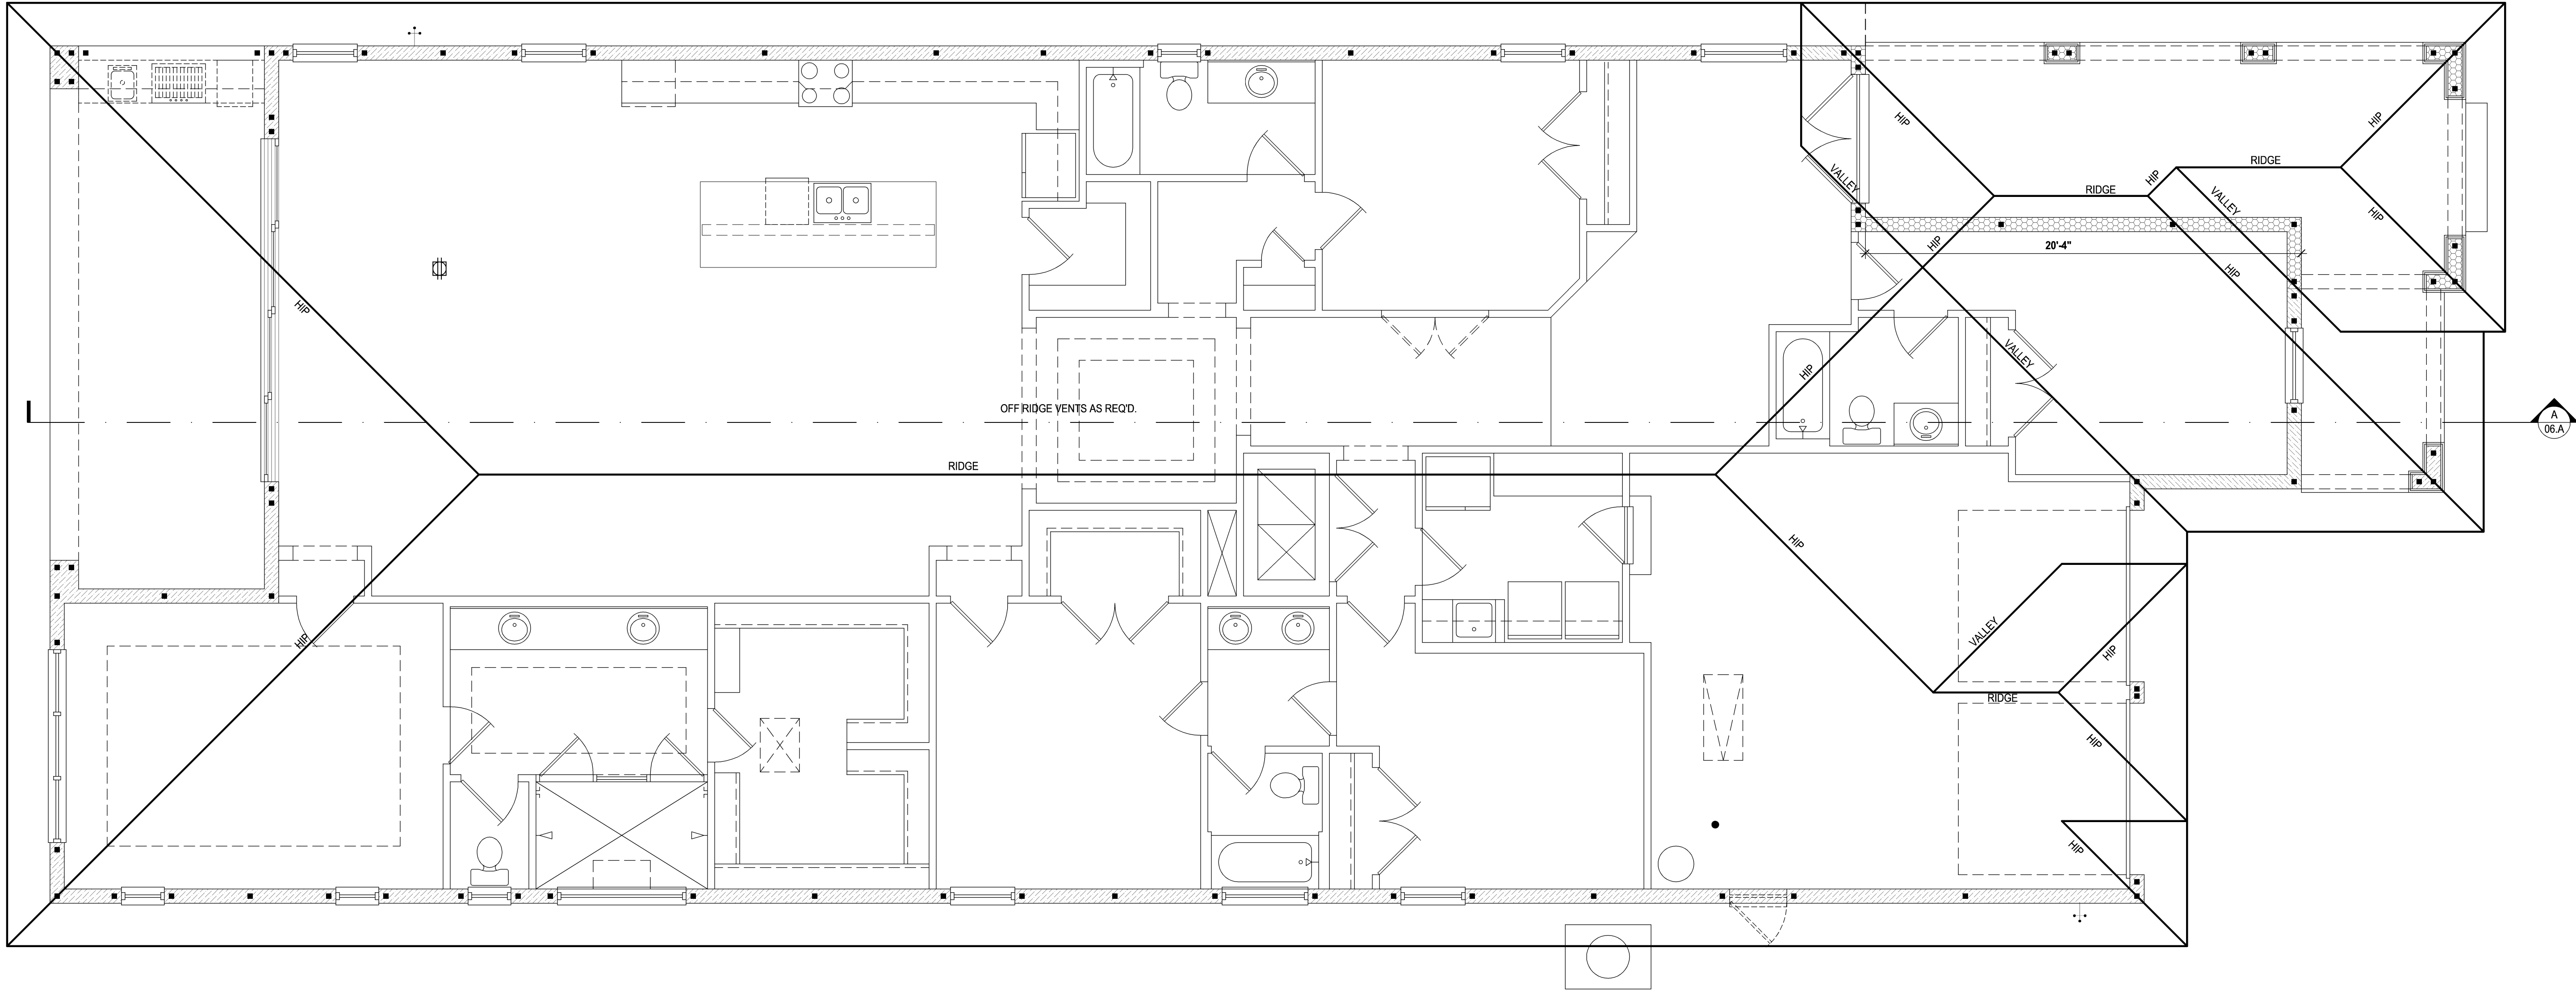235 Maitland Avenue  
Suite 108-A

Maitland, FL 32751  
Ph: (407) 227-7416  
www.premier-structural.com  
FL CERT. AUTH.: 29113

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# DORCHESTER

Street Address

A division of Park Square

Enterprises Inc.

5200 Vineland Rd. Suite #200  
Orlando, FL 32811

01111111, Fl. 32011  
01111111, Fl. 32011

ISSUE DATE	00/00/0000
REVISIONS	
PROJECT:	00-0000
SCALE:	AS NOTED
DRAWN BY:	C.C.
DESIGNED BY:	MJS

TRUSS PLAN










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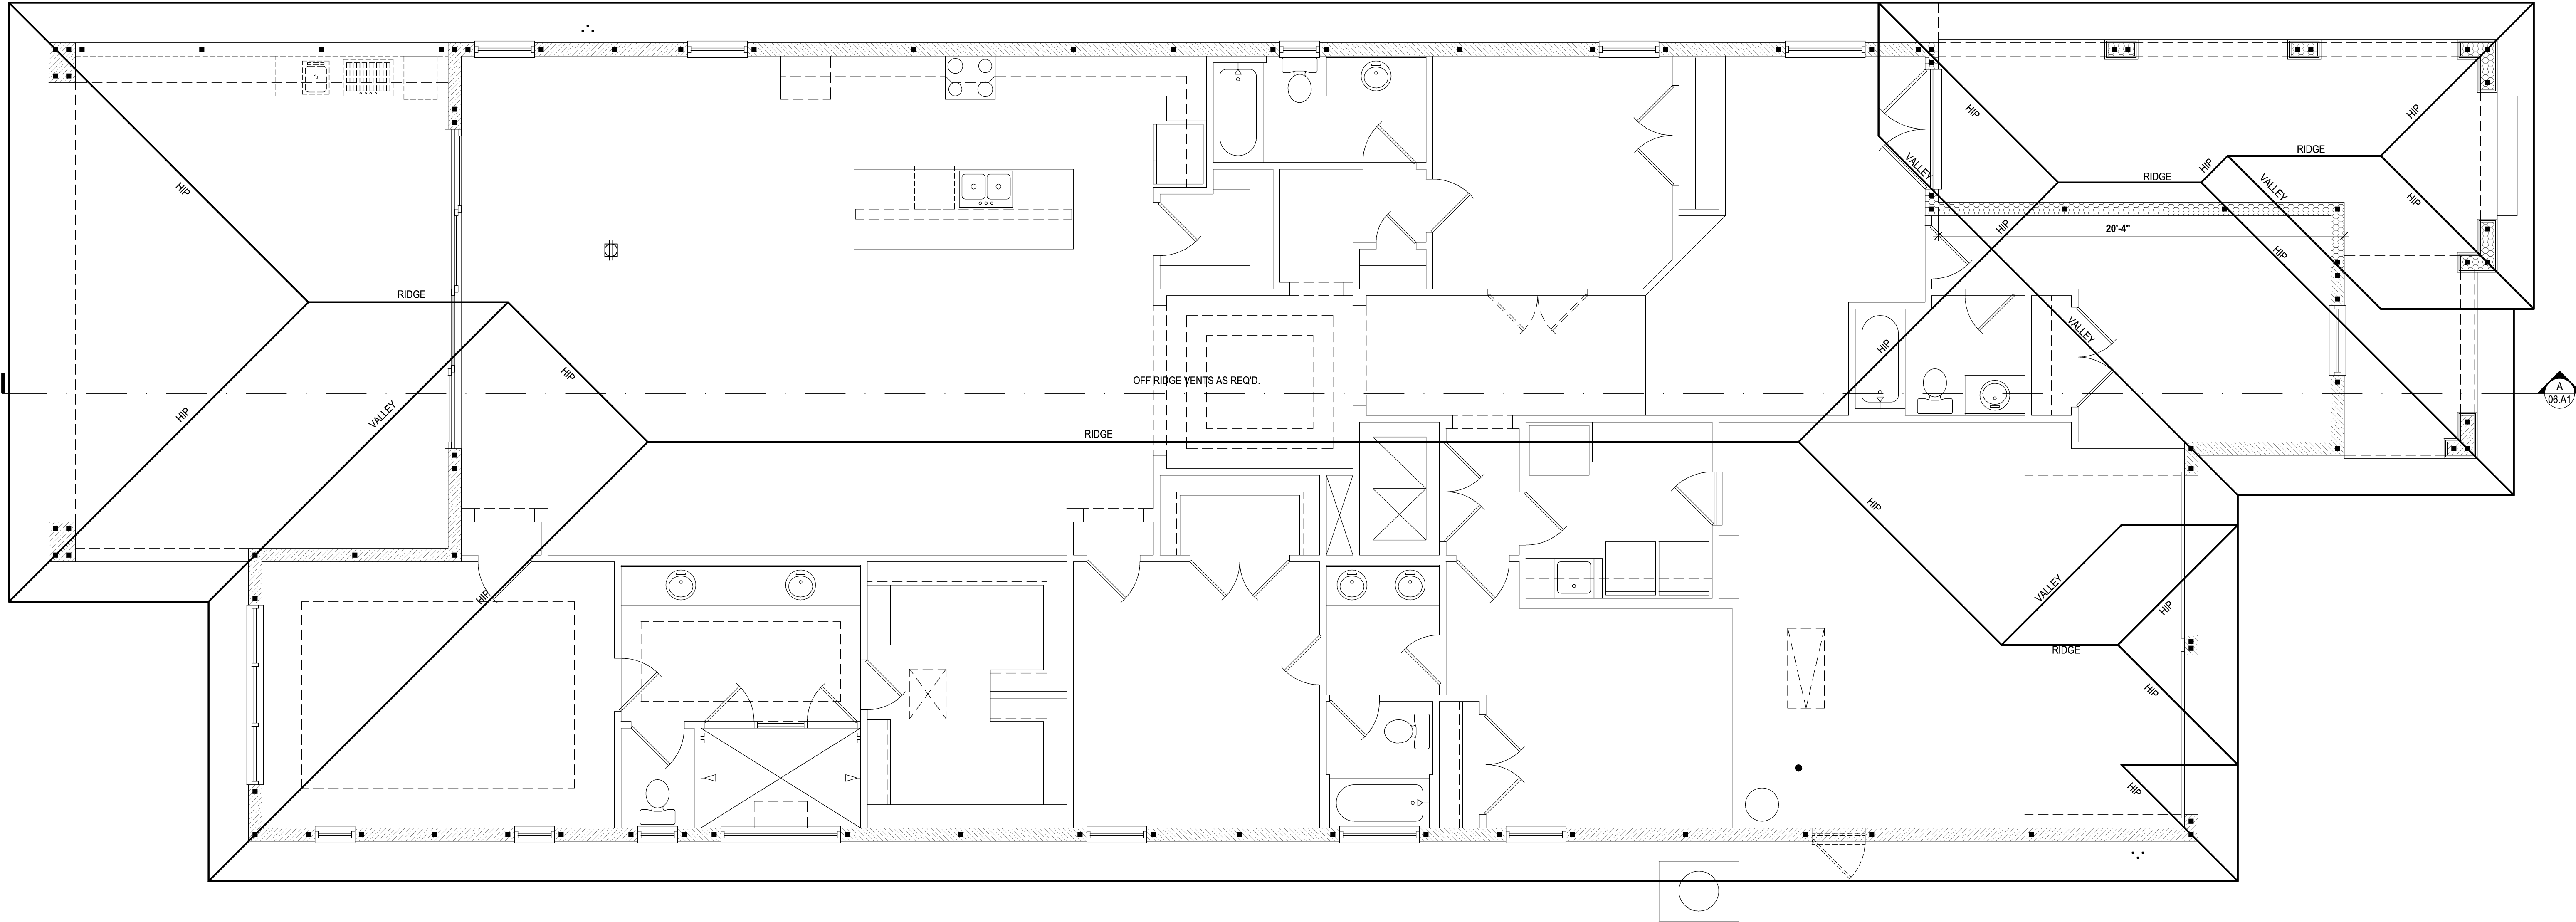
### BRG. HT. LEGEND

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9'-4" BRG. HT.	12'-0" BRG. HT.	15'-0" BRG. HT.
		
10'-0" BRG. HT.	13'-4" BRG. HT.	16'-0" BRG. HT.
		
11'-4" BRG. HT.	14'-0" BRG. HT.	BRG. PER PLAN

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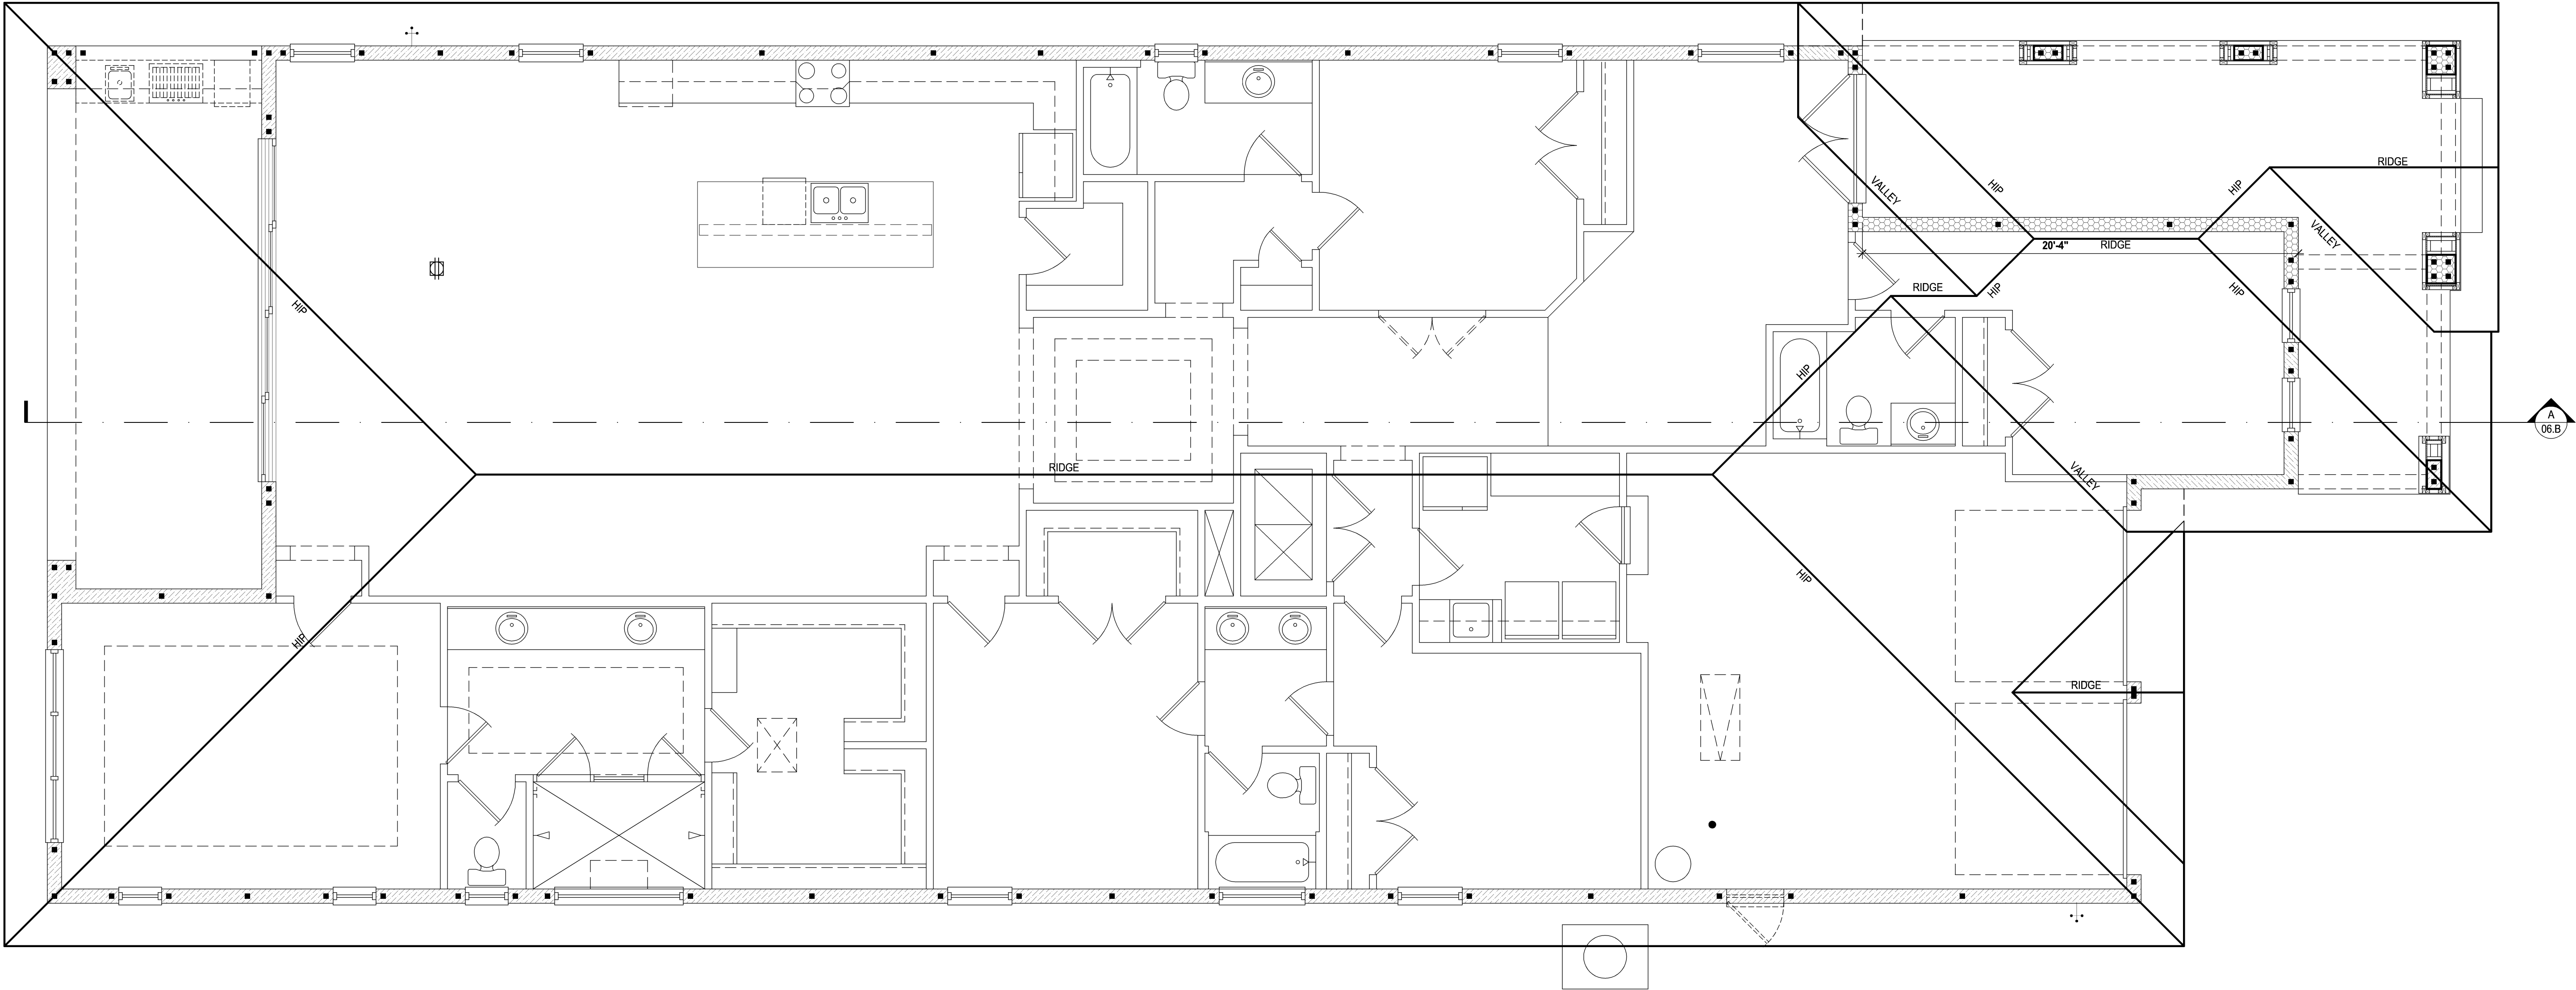
BRG. HT. LEGEND

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9'-4" BRG. HT.	12'-0" BRG. HT.	15'-0" BRG. HT.
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1'-4" BRG. HT.	14'-0" BRG. HT.	

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SCALE:  $1/8" = 1'-0"$  (12x18)  $1/4" = 1'-0"$  (24x36)

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Truss Plan "B"

(Opt. Sitting Rm.)

SCALE: 1/8" = 1'-0" (12x18) 1/4" = 1'-0" (24x36)



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### BRG. HT. LEGEND

1. EACH FLOOR TRUSS ATTACHED TO CMU WITH (1) H2A-16 (U.N.O.) & (1) MTS-12 AT FRAME CONNECTION (U.N.O.)
2. EACH ROOF TRUSS / RAFTER AT CMU. TO BE ATTACHED WITH (1) H2A-16 (U.N.O.) SEE CONNECTOR SCHEDULE FOR NAILING REQUIRED.
3. EACH ROOF TRUSS / RAFTER AT FRAME CONNECTION TO BE (1) MTS-12 AT ALL COMMON TRUSSES & (1) H2.5 AT ALL HIP JACKS (U.N.O.) SEE CONNECTOR SCHEDULE FOR NAILING REQUIRED.
4. END JACKS AND CORNER SETS MAY BE (1) H2.5 (U.N.O.)
5. ROOF SHEATHING TO BE 1/2" NOMINAL OR GREATER OSB. OR CDX TYPE PLYWOOD NAILED WITH .0952" RING


6. FLOOR SHEATHING TO BE  $\frac{3}{4}$ " PLYWOOD OR OSB (U.N.O), WITH LONG DIMENSION PERPENDICULAR TO SUPPORT (FLOOR TRUSSES). NAILS: NAILS USED IN ALL FLOORING APPLICATIONS SHALL BE 8d, RING OR SPIRAL SHANK, HAND OR GUN DRIVEN NAILS. GUN DRIVEN NAILS SHALL HAVE HEAD SIZE EQUIVALENT TO HAND DRIVEN NAILS, SPACING SHALL BE 6" ON EDGES AND 12" IN FIELD.

- 12.1. ALL CEILING HUNG SHOWERS AND SHOFFITS W/ CABINETS AS SHOWN ON PLANS.
- 12.2. ATTIC LOCATED HVAC UNITS AS SHOWN ON PLANS.
13. PROVIDE AND INSTALL FLASHING & ROOFING AS PER NATIONAL ROOFING AND SHEET METAL ASSOC. STANDARDS AND/OR ACCEPTABLE INDUSTRY PRACTICE, IN ACCORDANCE WITH FBCR 2017, 6TH EDITION.
14. TRUSSES SHALL BE BRACED TO PREVENT ROTATION & PROVIDE LATERAL STABILITY IN ACCORDANCE WITH THE REQUIREMENTS SPECIFIED IN THE CONSTRUCTION DOCUMENTS FOR BRACING & ON INDIVIDUAL TRUSS DESIGN DRAWINGS. IN THE ABSENCE OF SPECIFIC BRACING REQUIREMENTS, TRUSSES SHALL BE BRACED IN ACCORDANCE WITH TWPCA BC51.1.
15. REFER TO TRUSS MANUFACTURERS DRAWINGS FOR TRUSS FLEXIBILITY & TRUSS TO TRUSS CONNECTIONS.
16. SHINGLE ROOF UNDERLAYMENT TO BE INSTALLED IAW FBCR 2017, 6TH EDITION


■ INDICATES A CONCRETE FILLED CELL WITHIN AN 8" C-MU LAID CONTAINING (1) VERT. #5 REBAR CONT. FROM FOUNDATION SLAB TO BOND BEAM. PROVIDE A MIN. OF 25" LAP ON ALL STEEL REINFORCING BARS.

9'-4" BRG. HT.	12'-0" BRG. HT.	15'-0" BRG. HT.
0'-0" BRG. HT.	13'-4" BRG. HT.	16'-0" BRG. HT.
1'-4" BRG. HT.	14'-0" BRG. HT.	BRG. PER PLAN

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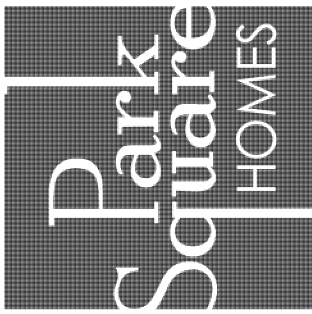
SCALE: 1/8" = 1'-0" (12x18) 1/4" = 1'-0" (24x36)

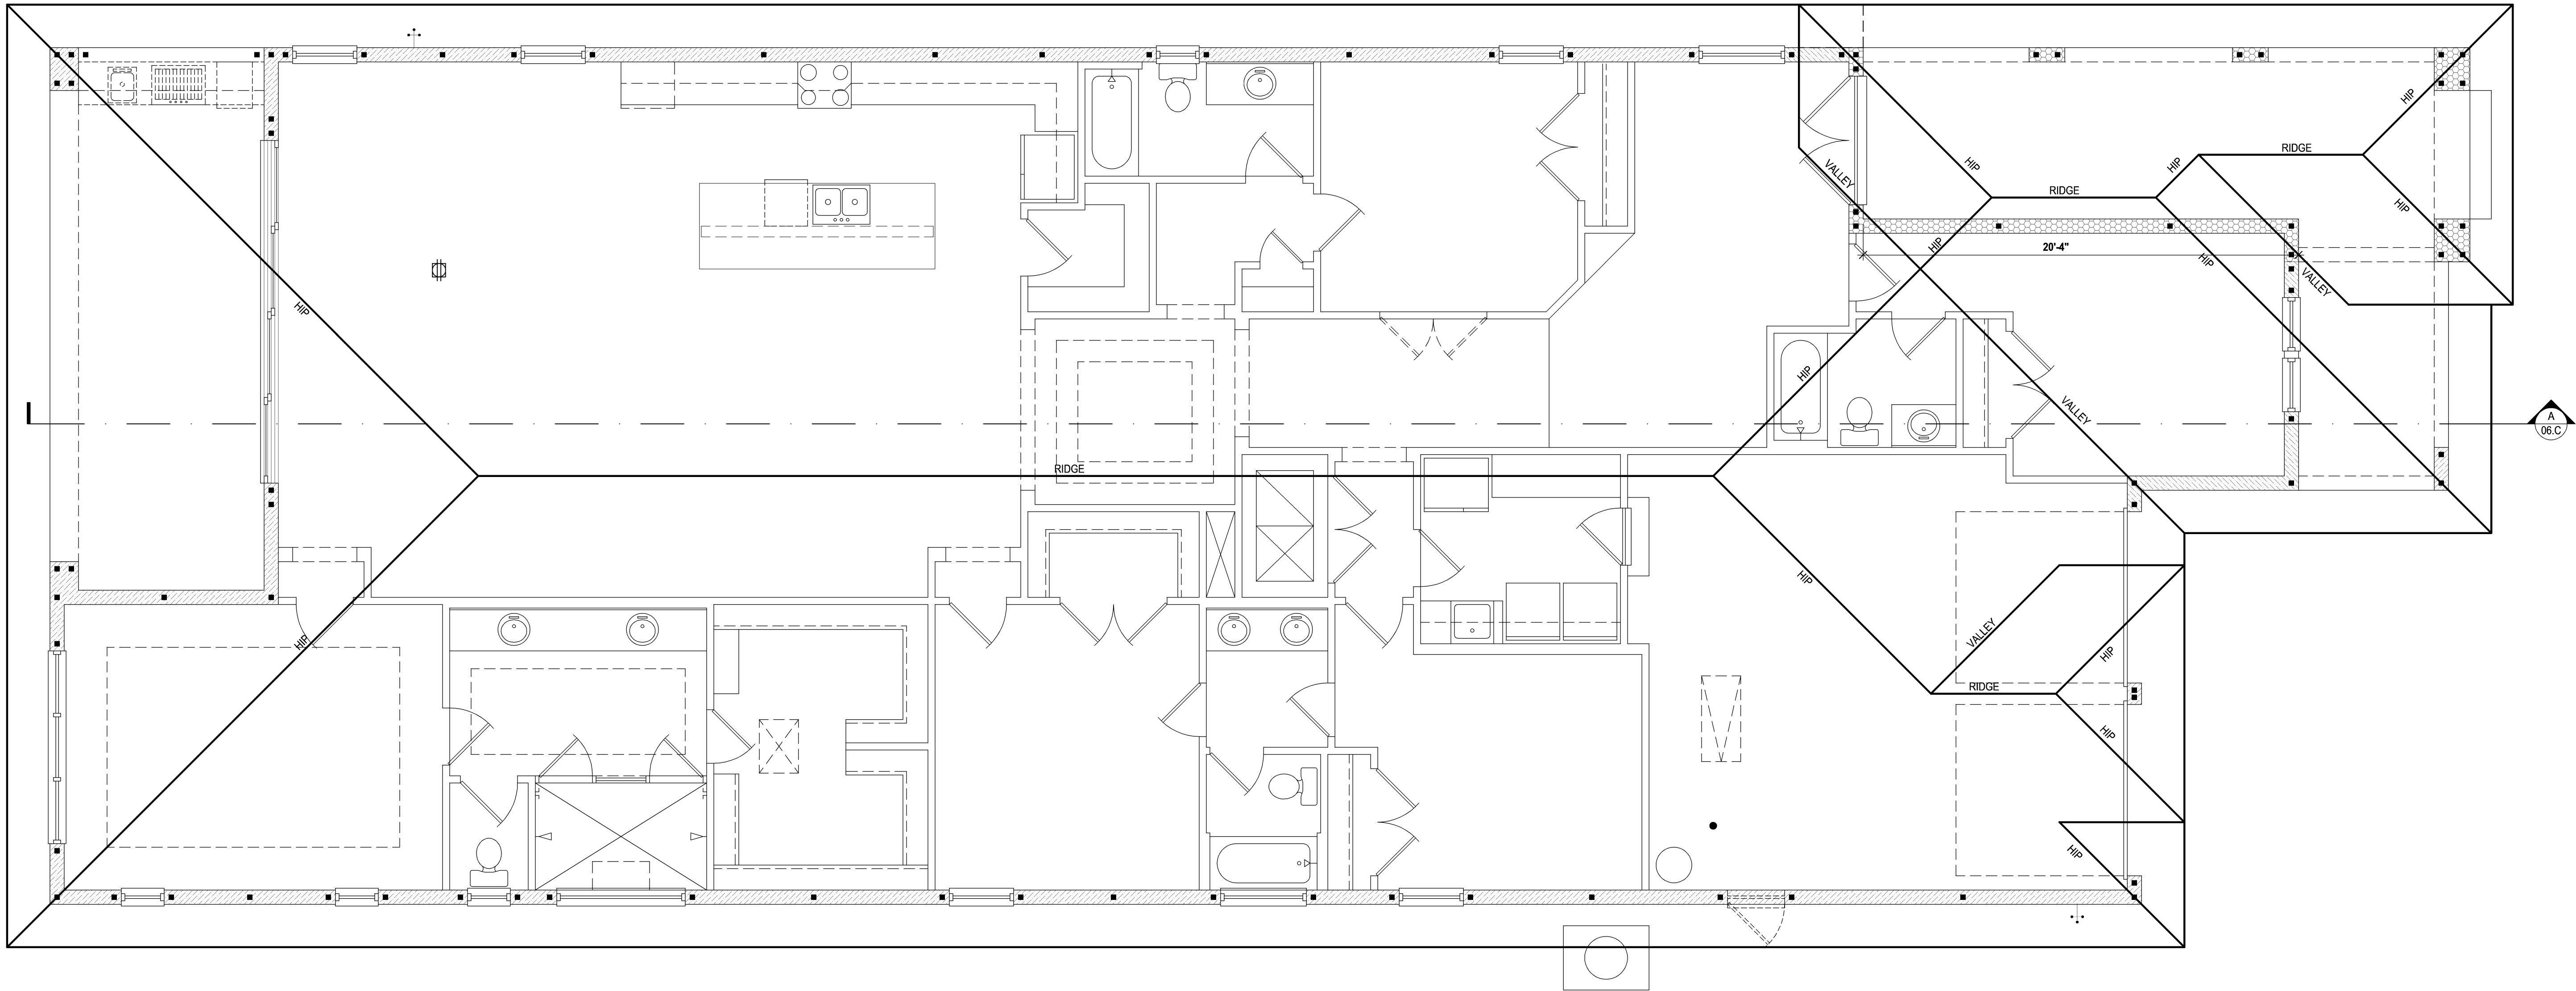

# Truss Plan "C"

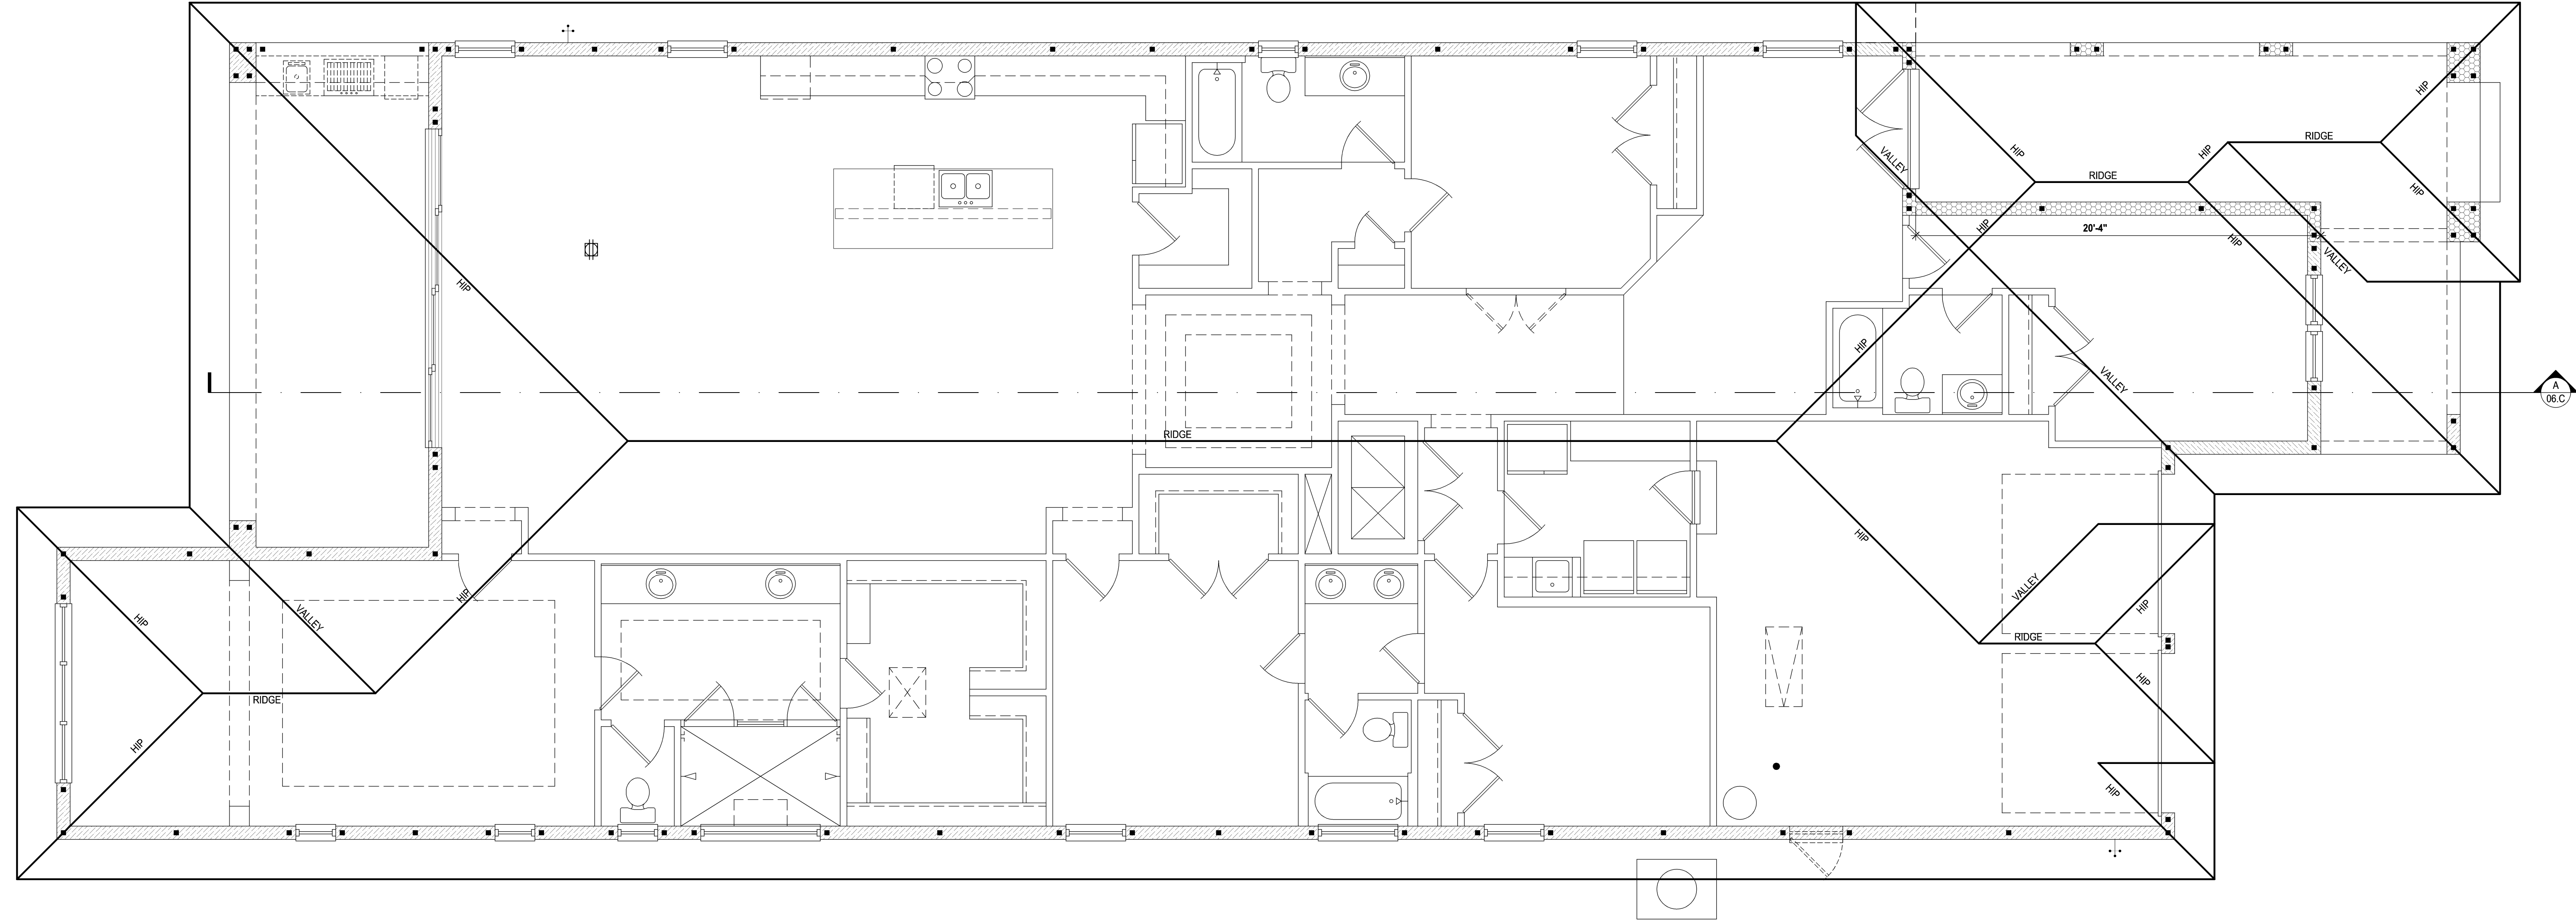(Opt. Sitting Rm.)

SCALE: 1/8" = 1'-0" (12x18) 1/4" = 1'-0" (24x36)



A Division of Park Square  
Enterprises Inc.  
5200 Vineland Rd. Suite #200  
Orlando, FL 32811  
Phone: (407) 525-3000

40-3164  
DORCHESTER  
Street Address  
Lot Info  
City, State, Zip

MJS  
815 Orienta Ave, Suite# 1040  
Altamonte Springs, FL 32701  
Ph: (407) 629-6711  
CUSTOM HOME DESIGN  
DESIGNERS - PLANNERS  
Fax: (407) 629-6776  
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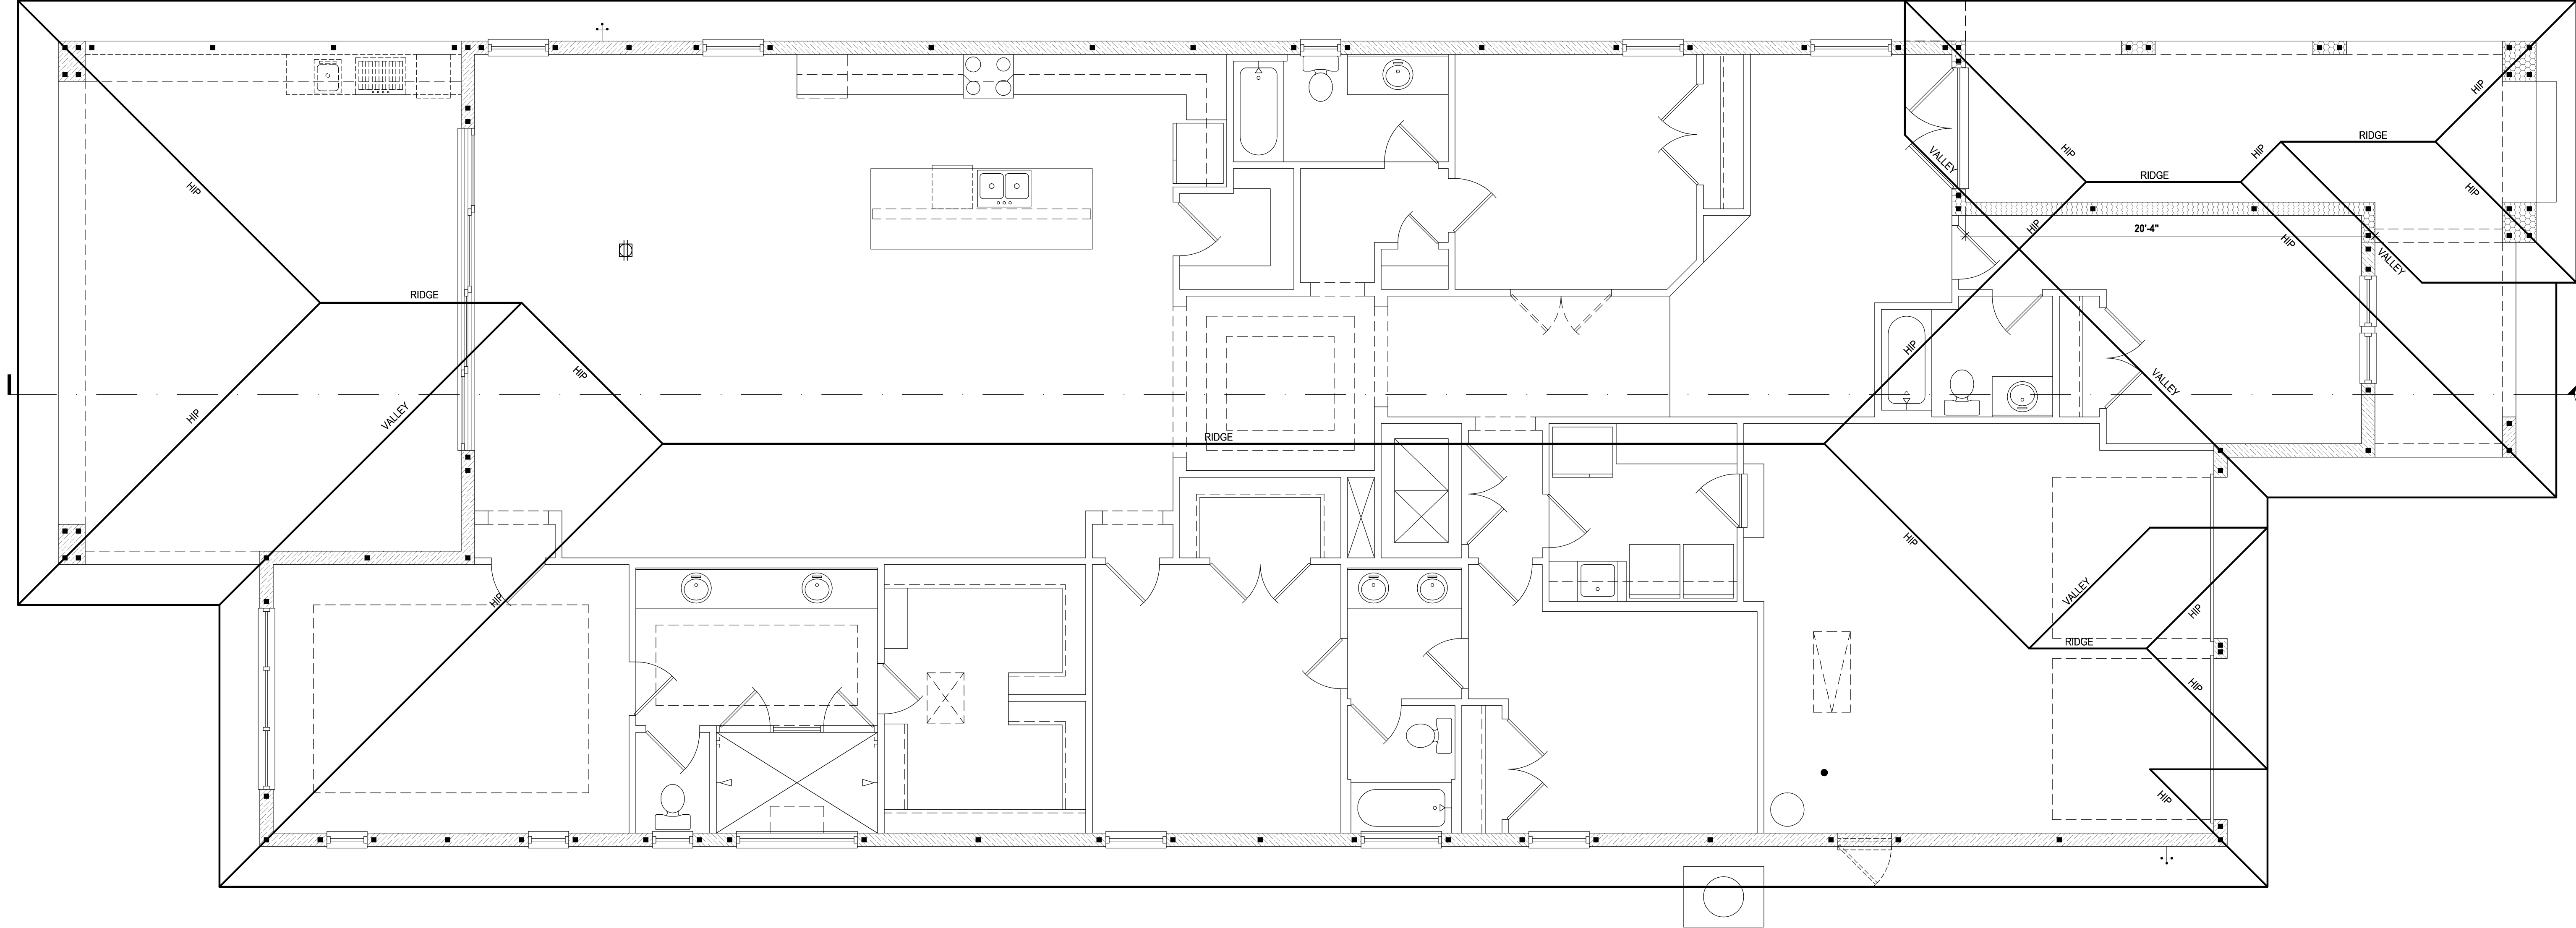
235 Maitland Avenue S.  
Suite 108-A  
Maitland, FL 32751  
Ph: (407) 227-7416  
www.premier-structural.com  
FL CERT. AUTH.: 29113  
FL. PER#: 60269

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When plans have been electronically signed & sealed by Blair Rodriguez, PE, using a digital signature, I, D a raised seal printed copies of this document are not considered signed & sealed.

TRUSS PLAN  
09.C1

POST NOTES:		CONNECTOR NOTES:		GENERAL NOTES:			BRG. HT. LEGEND		
<div><div>A</div><div>SPECIAL POSTS: (2) 2x JACK POST WITH (2) MTS-12 OR (2) MST-20 AT TOP AND SP-4 AT BOTTOM</div></div>	<div><div>E</div><div>5½"x 5½" 1.8E PARALLAM PSL COLUMN SECURED w/ SIMPSON HTT-5 AT BOTTOM AND (3) HTS-20 AT TOP.</div></div>	<div><div>B</div><div>(3) 2x JACK POST WITH (2) MTS-12 OR (2) MST-20 AT TOP &amp; (2) SP-4 AT BOTTOM OF EACH STUD W/ (14) 10d NAILS CAP=1000#</div></div>	<div><div>H-1</div><div>SPECIAL HEADERS: (2) 1½" x 12" L.V.L. HEADER SUPPORTED ON EA. SIDE BY (3) 2x JACK STUDS WITH (3) 2x FULL LENGTH STUDS ADJACENT. USE SP-1 @ BOTTOM OF EACH STUD &amp; (2) MST-24 FROM STUD TO HEADER AT TOP ON EACH SIDE.</div></div>	<div>1. EACH FLOOR TRUSS ATTACHED TO CMU WITH (1) HETA-16 AND (1) MTS-12 AT FRAME CONNECTION (U.N.O.)</div> <div>2. EACH ROOF TRUSS / RAFTER AT CMU. TO BE ATTACHED WITH (1) HETA-16 (U.N.O.) SEE CONNECTOR SCHEDULE FOR NAILING REQUIRED.</div> <div>3. EACH ROOF TRUSS / RAFTER AT FRAME CONNECTION TO BE (1) MTS-12 AT ALL COMMON TRUSSES &amp; (1) H2.5 AT ALL HIP JACKS (U.N.O.) SEE CONNECTOR SCHEDULE FOR NAILING REQUIRED.</div> <div>4. ENDJACKS AND CORNER SETS MAY BE (1) H-2.5 (U.N.O.)</div> <div>5. ROOF SHEATHING TO BE 1/2" NOMINAL OR GREATER OSB. OR CDX. TYPE PLYWOOD NAILED WITH .099x2" RING</div>	<div>SHANK NAILS @ 6" O.C. EXCEPT FIRST 4'-0" OF ENTIRE PERIMETER WHICH SHALL BE 6" O.C. FIELD 4" O.C. EDGE.</div> <div>WALL SHEATHING TO BE 7/16" OSB. OR 1/2" CDX. NAILED WITH 8d CORROSION RESISTANT NAILS @ 6" O.C. IN FIELD &amp; 4" O.C. @ EDGE (U.N.O.). SEE SHEATHING DETAIL.</div> <div>6. FLOOR SHEATHING TO BE ¾" PLYWOOD OR OSB (U.N.O.) WITH LONG DIMENSION PERPENDICULAR TO SUPPORT (FLOOR TRUSSES). NAILS: NAILS USED IN ALL FLOORING APPLICATIONS SHALL BE 8d. RING OR SPIRAL SHANK, HAND OR GUN DRIVEN NAILS. GUN DRIVEN NAILS SHALL HAVE HEAD SIZE EQUIVALENT TO HAND DRIVEN NAILS. SPACING SHALL BE 6" ON EDGES AND 12" IN FIELD.</div>	<div>1. TRUSS LAYOUT IS AN ARTISTIC REPRESENTATION AND MAY VARY FROM FINAL LAYOUT SUBMITTED BY TRUSS MANUFACTURER. ALL TRUSS LAYOUTS AND PROFILES SHALL BE DESIGNED AND CERTIFIED BY TRUSS MANUFACTURER'S REGISTERED ENGINEER.</div> <div>2. IF TRUSS LAYOUT / ENGINEERING IS CHANGED OR ALTERED FROM ITS ORIGINAL MASTER FILE, THE E.O.R AND DESIGNER MUST BE NOTIFIED IMMEDIATELY AND WILL NOT BE HELD LIABLE.</div> <div>3. TRUSS MANUFACTURER TO VERIFY ALL TRUSS SPANS, SLOPES, BEARING POINTS, &amp; DIMENSIONS BEFORE FABRICATION. TRUSS MANUFACTURER SHALL COORDINATE LOCATIONS FOR MECHANICAL AND PLUMBING CHASES TO AVOID CONFLICT. ALSO, TRUSS MANUFACTURER TO PROVIDE SHOP DRAWINGS FOR APPROVAL BEFORE FABRICATION.</div> <div>4. ALL ROOF PITCHES ARE TO BE SET AS INDICATED ON PLANS AND ELEVATIONS.</div> <div>5. TOP PLATE HEIGHTS VARY. SEE BUILDING SECTIONS, WALL SECTIONS, &amp; ELEVATIONS FOR BEARING HEIGHTS.</div>	<div>6. TRUSS SPACING SHALL BE 24" O.C. (U.N.O.) CONVENTIONAL FRAMING SHALL BE 16" O.C.</div> <div>7. TRUSS MANUFACTURER TO PROVIDE ALL GABLE END TRUSSES WITH INTERMEDIATE STUD MEMBERS @ 16" O.C.</div> <div>8. ROOF DECKING AS SPECIFIED.</div> <div>9. ALL ROOF OVERHANGS TO BE 12" UNLESS NOTED OTHERWISE.</div> <div>10. FRAME WALLS UP TO UNDERSIDE OF ROOF TRUSSES AT ALL NON BEARING WALLS AND AT VOLUME AREAS (U.N.O.)</div> <div>11. ALIGN TRUSSES AND HAND FRAMING SO AS ALL GYPSUM WALL BOARD TO BE CONTINUOUS FROM FLOOR TO CEILING.</div> <div>12. TRUSS MANUFACTURER TO INSURE DESIGN CONSIDERATION TO THE FOLLOWING ADDITIONAL LOADS:</div>	<div>12.1. ALL CEILING HUNG SOFFITS AND SOFFITS w/ CABINETS AS SHOWN ON PLANS.</div> <div>12.2. ATTIC LOCATED HVAC. UNITS AS SHOWN ON PLANS.</div> <div>13. PROVIDE AND INSTALL FLASHING &amp; ROOFING AS PER NATIONAL ROOFING AND SHEET METAL ASSOC. STANDARDS AND/OR ACCEPTABLE INDUSTRY PRACTICE, IN ACCORDANCE WITH FBC-R 2017, 6TH EDITION.</div> <div>14. TRUSSES SHALL BE BRACED TO PREVENT ROTATION &amp; PROVIDE LATERAL STABILITY IN ACCORDANCE WITH THE REQUIREMENTS SPECIFIED IN THE CONSTRUCTION DOCUMENTS FOR BUILDING &amp; ON INDIVIDUAL TRUSS DESIGN DRAWINGS. IN THE ABSENCE OF SPECIFIC BRACING REQUIREMENTS, TRUSSES SHALL BE BRACED IN ACCORDANCE WITH TPW/TCA BC511.</div> <div>15. REFER TO TRUSS MANUFACTURERS DRAWINGS FOR TRUSS PLACEMENT &amp; TRUSS TO TRUSS CONNECTIONS.</div> <div>16. SHINGLE ROOF: UNDERLAYMENT TO BE INSTALLED IAW FBC-R 2017, 6TH EDITION</div>	<div>■ - INDICATES A CONCRETE FILLED CELL WITHIN AN 8" CMU WALL CONTAINING (1) VERT. #5 REBAR CONT. FROM FOUNDATION SLAB TO BOND BEAM. PROVIDE A MIN. OF 25" LAP ON ALL STEEL REINFORCING BARS.</div> <div><div><div></div></div>9'-4" BRG. HT.</div> <div><div><div></div></div>10'-0" BRG. HT.</div> <div><div><div></div></div>11'-4" BRG. HT.</div> <div><div><div></div></div>12'-0" BRG. HT.</div> <div><div><div></div></div>13'-4" BRG. HT.</div> <div><div><div></div></div>14'-0" BRG. HT.</div> <div><div><div></div></div>15'-0" BRG. HT.</div> <div><div><div></div></div>16'-0" BRG. HT.</div> <div><div><div></div></div>BRG. PER PLAN</div>



Truss Plan "C"  
(Opt. Extended Lanai)  
SCALE: 1/8" = 1'-0" (12x18) 1/4" = 1'-0" (24x36)


POST NOTES:	
<div><div>A</div><div>SPECIAL POSTS: (2) 2x JACK POST WITH (2) MTS-12 OR (2) MSTA-20 AT TOP AND SP4 AT BOTTOM</div></div>	<div><div>E</div><div>5 7/8" x 5 1/2" 1.8E PARALLAM PSL COLUMN SECURED w/ SIMPSON HTT-5 AT BOTTOM AND (3) HTS-20 AT TOP.</div></div>
<div><div>B</div><div>(3) 2x JACK POST WITH (2) MTS-12 OR (2) MSTA-20 AT TOP &amp; (2) SP-4 AT BOTTOM OF EACH STUD W/ (14) 10d NAILS CAP=1000#</div></div>	<div><div>H-1</div><div>SPECIAL HEADERS: (2) 1 1/2" x 12" L.V.L. HEADER SUPPORTED ON EA. SIDE BY (3) 2x JACK STUDS WITH (3) 2x FULL LENGTH STUDS ADJACENT. USE SP-1 @ BOTTOM OF EACH STUD &amp; (2) MSTA-24 FROM STUD TO HEADER AT TOP ON EACH SIDE.</div></div>
<div><div>C</div><div>3 1/2" x 3 1/2" 1.8E PARALLAM PSL JACK POST WITH (2) HTS-16 ON TOP AND (1) HTT-4 AT BOTTOM.</div></div>	
<div><div>D</div><div>3 1/2" x 5 1/2" 1.8E PARALLAM PSL JACK POST WITH (2) HTS-16 ON TOP AND (1) HTT-4 AT BOTTOM.</div></div>	<div><div>H-2</div><div>(2) 2"x12" BEAM WITH 1/2" PLYWOOD FLITCH SUPPORTED ON EACH SIDE WITH (2) 2x JACK STUDS WITH (2) 2x FULL LENGTH STUDS ADJACENT. USE SP-1 @ BOTTOM OF EACH STUD &amp; (2) LSTA-24 FROM STUD TO HEADER AT TOP ON EACH SIDE.</div></div>

CONNECTOR NOTES:	
1. EACH FLOOR TRUSS ATTACHED TO CMU WITH (1) HETA-16 AND (1) MTS-12 AT FRAME CONNECTION (U.N.O.)	SHANK NAILS @ 6" O.C. EXCEPT FIRST 4'-0" OF ENTIRE PERIMETER WHICH SHALL BE 6" O.C. FIELD 4" O.C. EDGE.
2. EACH ROOF TRUSS / RAFTER AT CMU. TO BE ATTACHED WITH (1) HETA-16 (U.N.O.) SEE CONNECTOR SCHEDULE FOR NAILING REQUIRED.	WALL SHEATHING TO BE 7/16" OSB. OR 1/2" CDX. NAILED WITH 8d CORROSION RESISTANT NAILS @ 6" O.C. IN FIELD & 4" O.C. @ EDGE (U.N.O.). SEE SHEATHING DETAIL.
3. EACH ROOF TRUSS / RAFTER AT FRAME CONNECTION TO BE (1) MTS-12 AT ALL COMMON TRUSSES & (1) H2.5 AT ALL HIP JACKS (U.N.O.) SEE CONNECTOR SCHEDULE FOR NAILING REQUIRED.	6. FLOOR SHEATHING TO BE 3/4" PLYWOOD OR OSB (U.N.O.), WITH LONG DIMENSION PERPENDICULAR TO SUPPORT (FLOOR TRUSSES), NAILS: NAILS USED IN ALL FLOORING APPLICATIONS SHALL BE 8d. RING OR SPIRAL SHANK, HAND OR GUN DRIVEN NAILS. GUN DRIVEN NAILS SHALL HAVE HEAD SIZE EQUIVALENT TO HAND DRIVEN NAILS. SPACING SHALL BE 6" ON EDGES AND 12" IN FIELD.
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5. ROOF SHEATHING TO BE 1/2" NOMINAL OR GREATER OSB. OR CDX. TYPE PLYWOOD NAILED WITH .099x2" RING	

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2. IF TRUSS LAYOUT / ENGINEERING IS CHANGED OR ALTERED FROM ITS ORIGINAL MASTER FILE, THE E.O.R AND DESIGNER MUST BE NOTIFIED IMMEDIATELY AND WILL NOT BE HELD LIABLE.	7. TRUSS MANUFACTURER TO PROVIDE ALL GABLE END TRUSSES WITH INTERMEDIATE STUD MEMBERS @ 16" O.C.
3. TRUSS MANUFACTURER TO VERIFY ALL TRUSS SPANS, SLOPES, BEARING POINTS, & DIMENSIONS BEFORE FABRICATION. TRUSS MANUFACTURER SHALL COORDINATE LOCATIONS FOR MECHANICAL AND PLUMBING CHASES TO AVOID CONFLICT. ALSO, TRUSS MANUFACTURER TO PROVIDE SHOP DRAWINGS FOR APPROVAL BEFORE FABRICATION.	8. ROOF DECKING AS SPECIFIED.
4. ALL ROOF PITCHES ARE TO BE SET AS INDICATED ON PLANS AND ELEVATIONS.	9. ALL ROOF OVERHANGS TO BE 12" UNLESS NOTED OTHERWISE.
5. TOP PLATE HEIGHTS VARY. SEE BUILDING SECTIONS, WALL SECTIONS, & ELEVATIONS FOR BEARING HEIGHTS.	10. FRAME WALLS UP TO UNDERSIDE OF ROOF TRUSSES AT ALL NON BEARING WALLS AND AT VOLUME AREAS (U.N.O.).
	11. ALIGN TRUSSES AND HAND FRAMING SO AS ALL GYPSUM WALL BOARD TO BE CONTINUOUS FROM FLOOR TO CEILING.
	12. TRUSS MANUFACTURER TO INSURE DESIGN CONSIDERATION TO THE FOLLOWING ADDITIONAL LOADS:
	12.1. ALL CEILING HUNG SOFFITS AND SOFFITS W/ CABINETS AS SHOWN ON PLANS.
	12.2. ATTIC LOCATED HVAC. UNITS AS SHOWN ON PLANS.
	13. PROVIDE AND INSTALL FLASHING & ROOFING AS PER NATIONAL ROOFING AND SHEET METAL ASSOC. STANDARDS AND/OR ACCEPTABLE INDUSTRY PRACTICE, IN ACCORDANCE WITH FBC-R 2017, 6TH EDITION.
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	15. REFER TO TRUSS MANUFACTURERS DRAWINGS FOR TRUSS PLACEMENT & TRUSS TO TRUSS CONNECTIONS.
	16. SHINGLE ROOF: UNDERLAYMENT TO BE INSTALLED IAW FBC-R 2017, 6TH EDITION

BRG. HT. LEGEND	
■ - INDICATES A CONCRETE FILLED CELL. WITHIN AN 8" CMU WALL CONTAINING (1) VERT. #5 REBAR CONT. FROM FOUNDATION SLAB TO BOND BEAM. PROVIDE A MIN. OF 25" LAP ON ALL STEEL REINFORCING BARS.	
	BRG. PER PLAN

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A Division of Park Square  
Enterprises Inc.  
5200 Vineland Rd. Suite #200  
Orlando, FL 32811  
Phone: (407) 525-3000
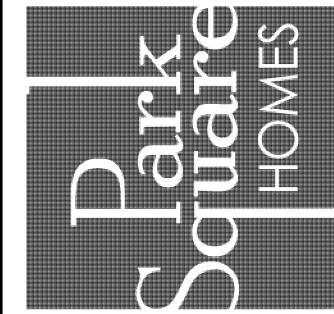
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**DORCHESTER**  
Street Address  
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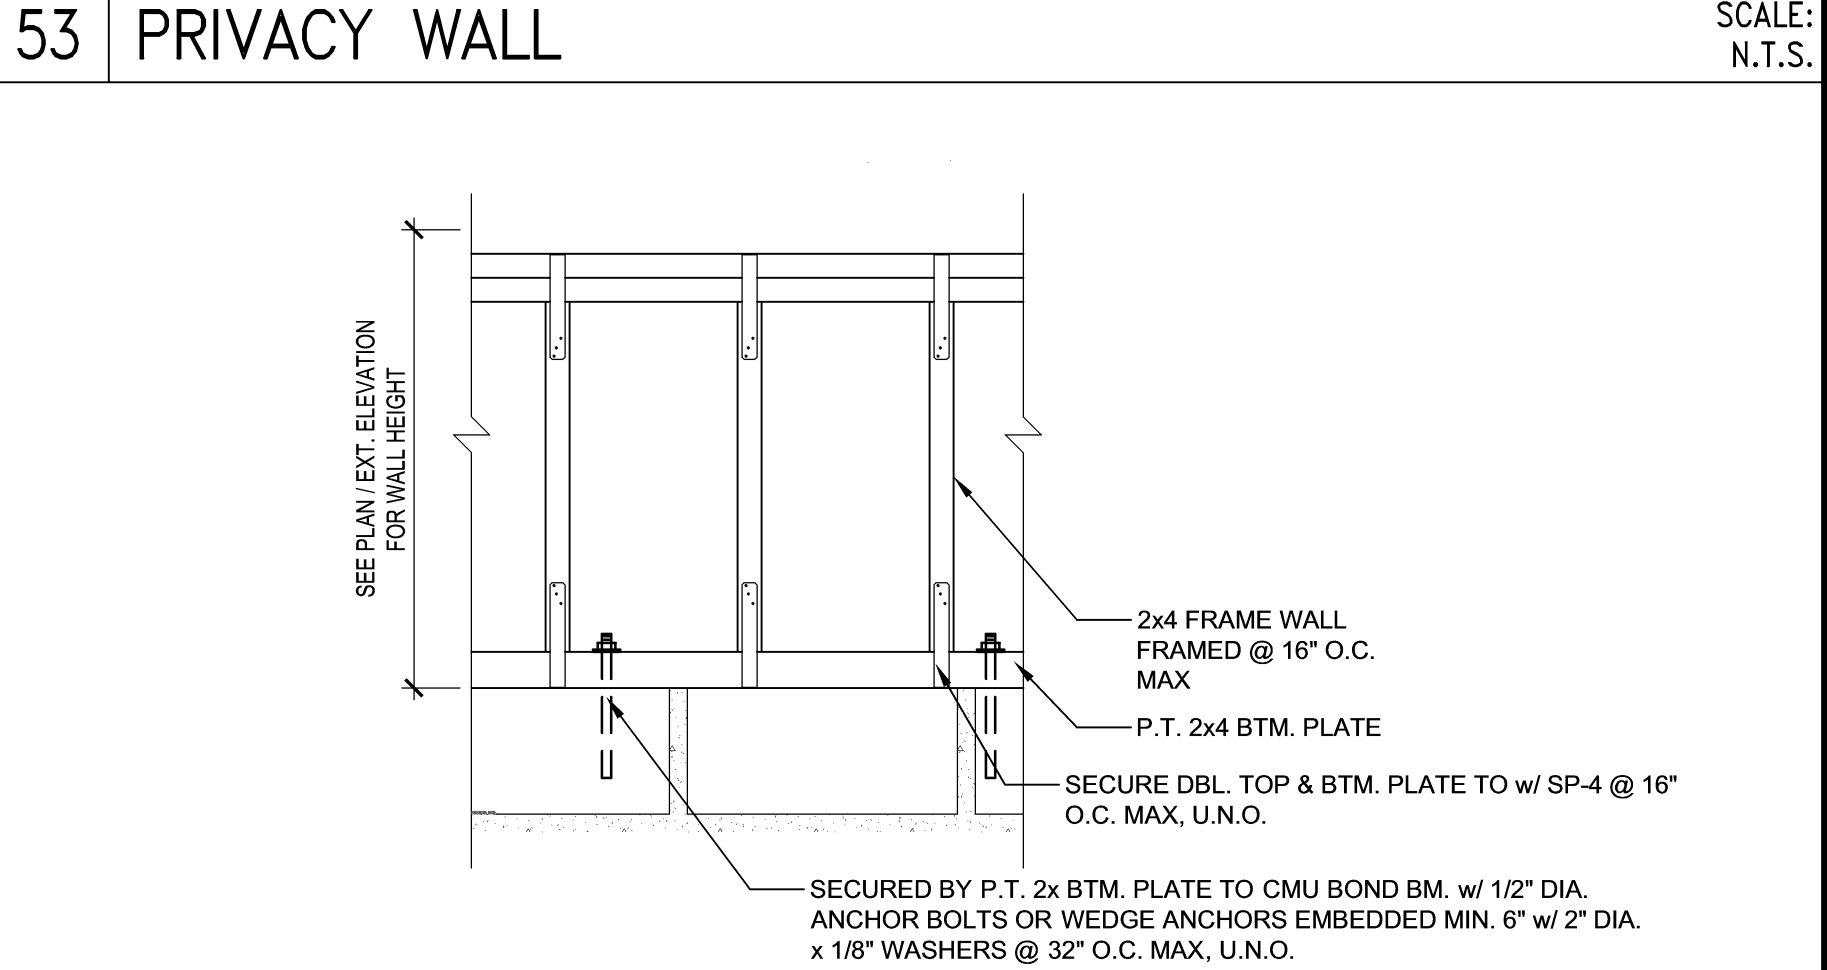
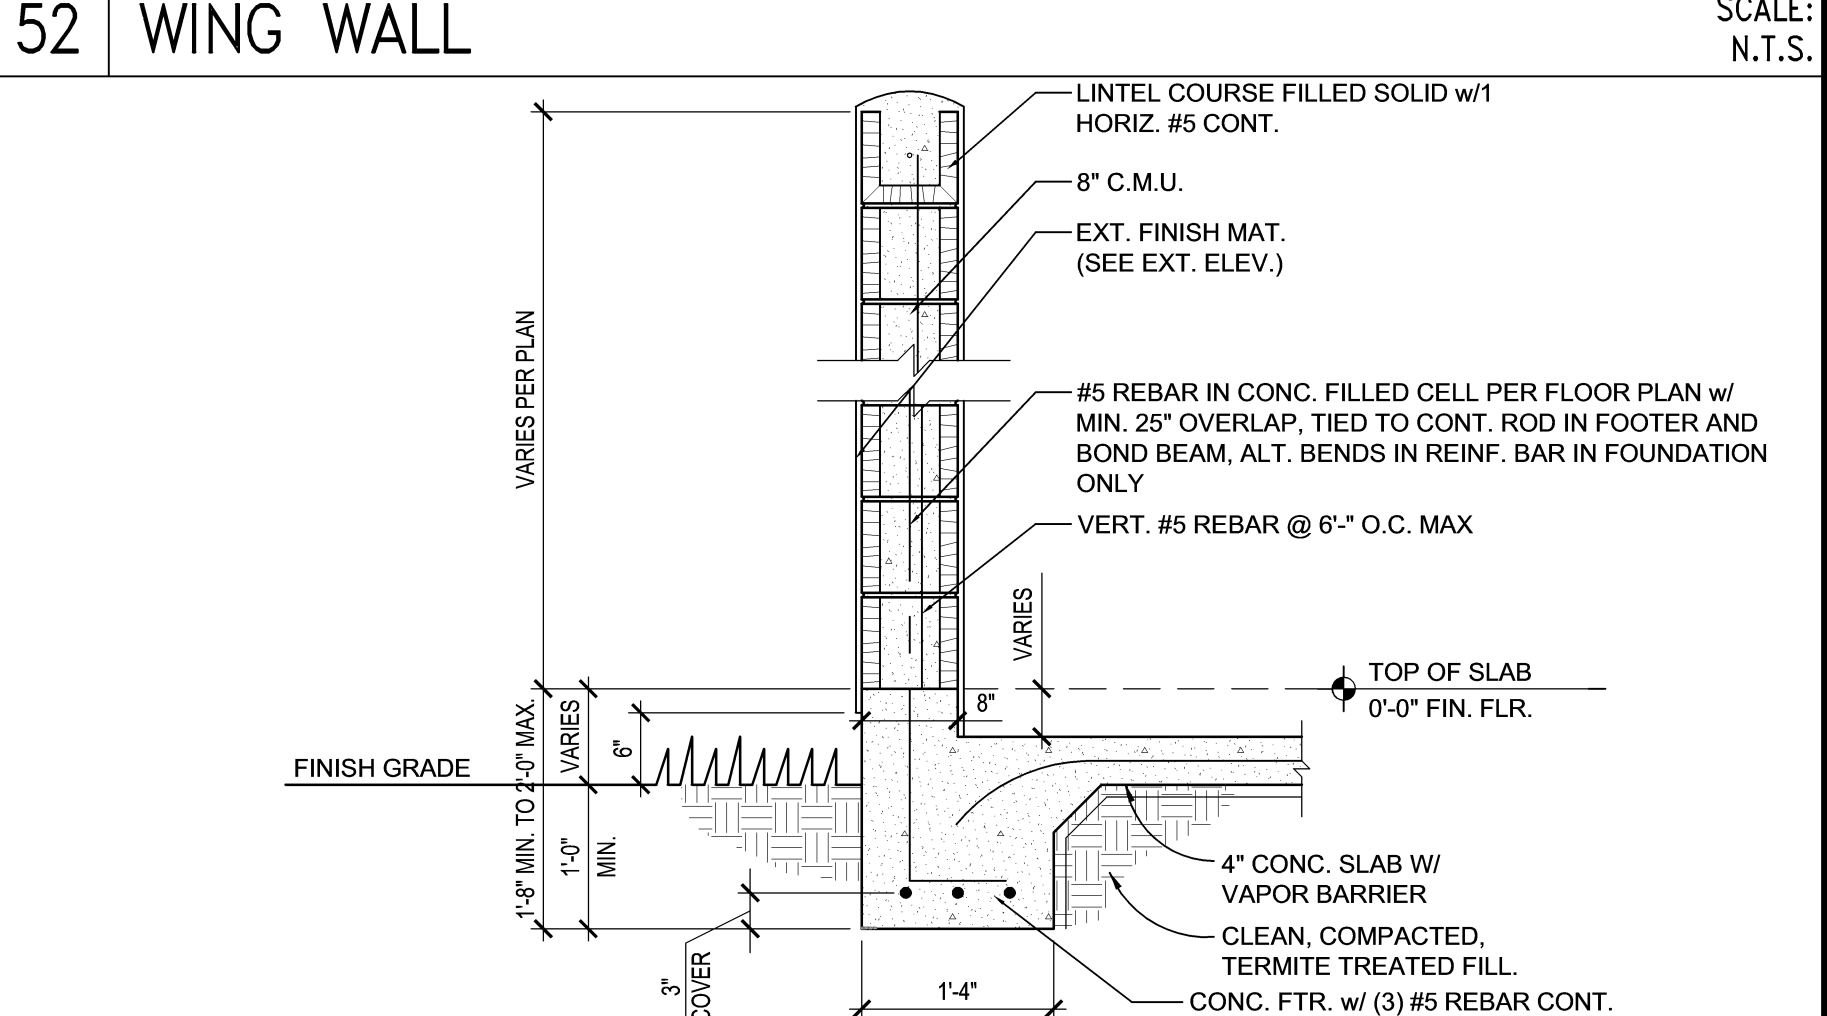
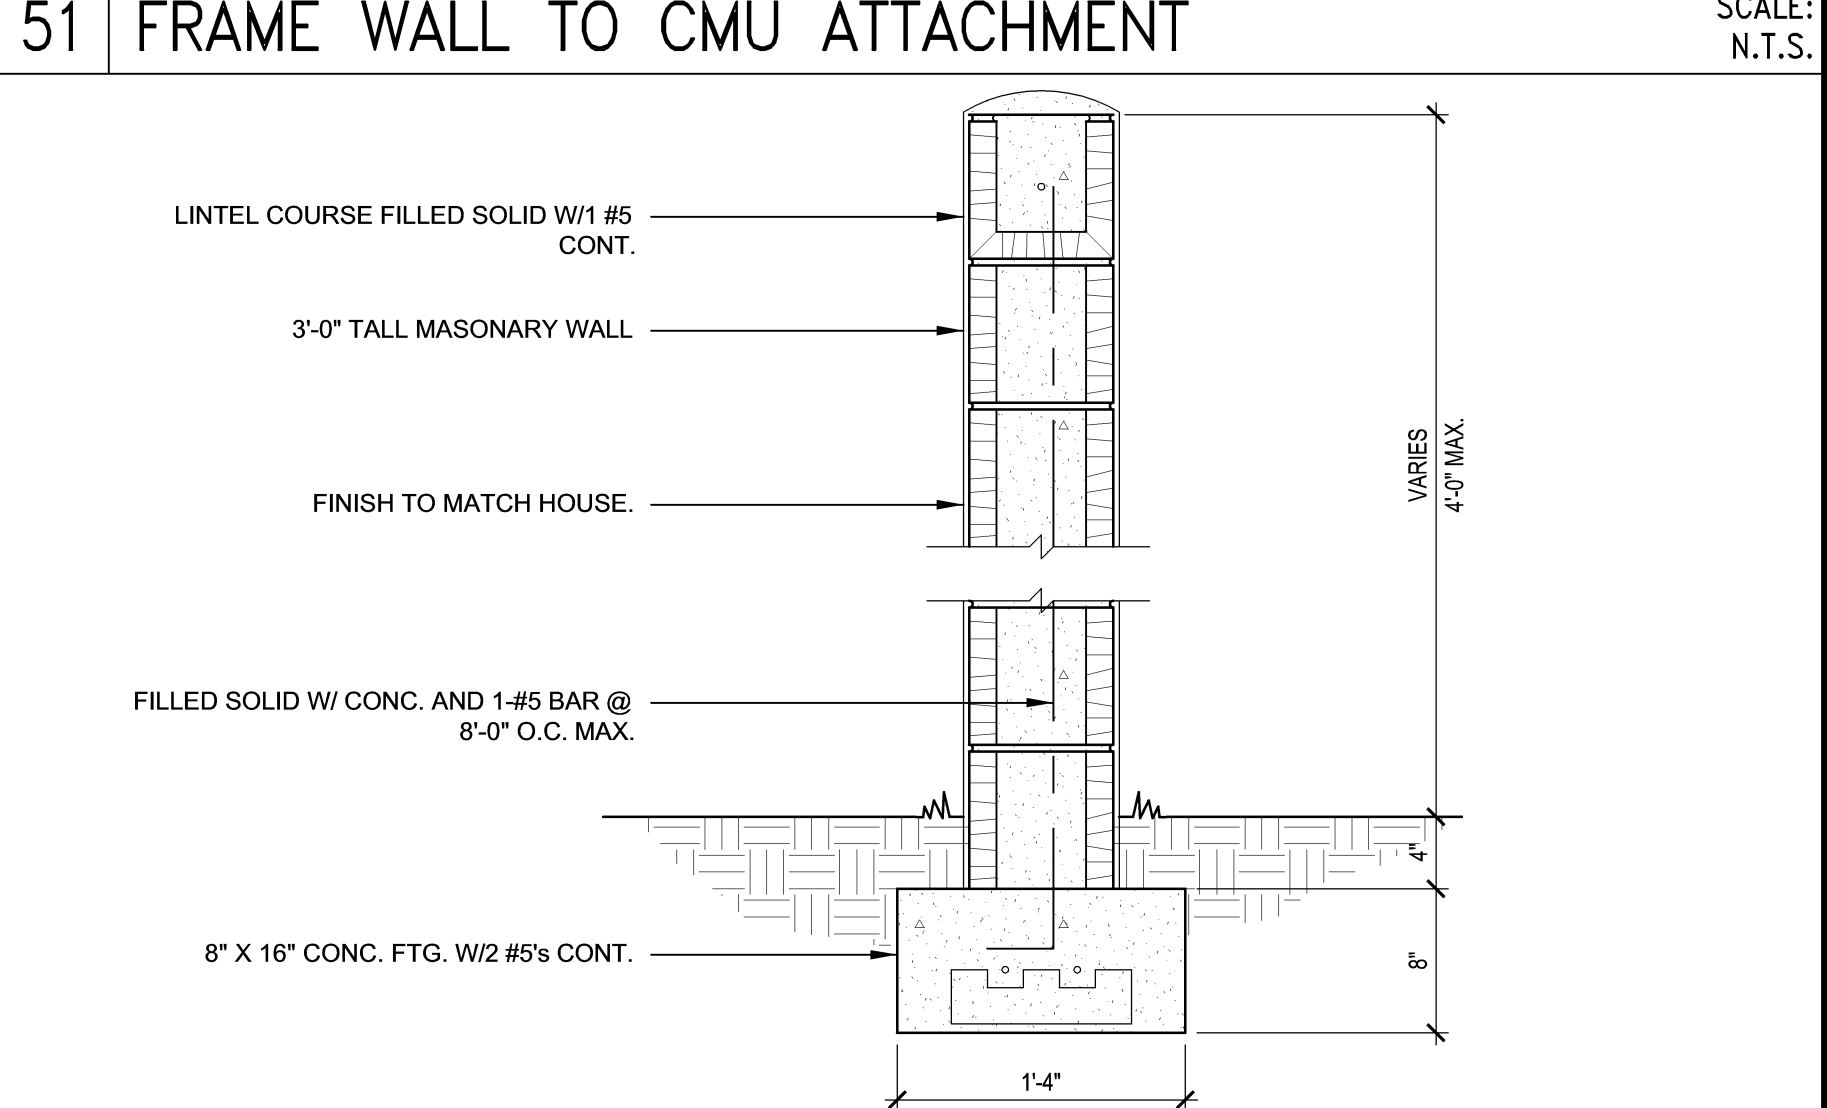
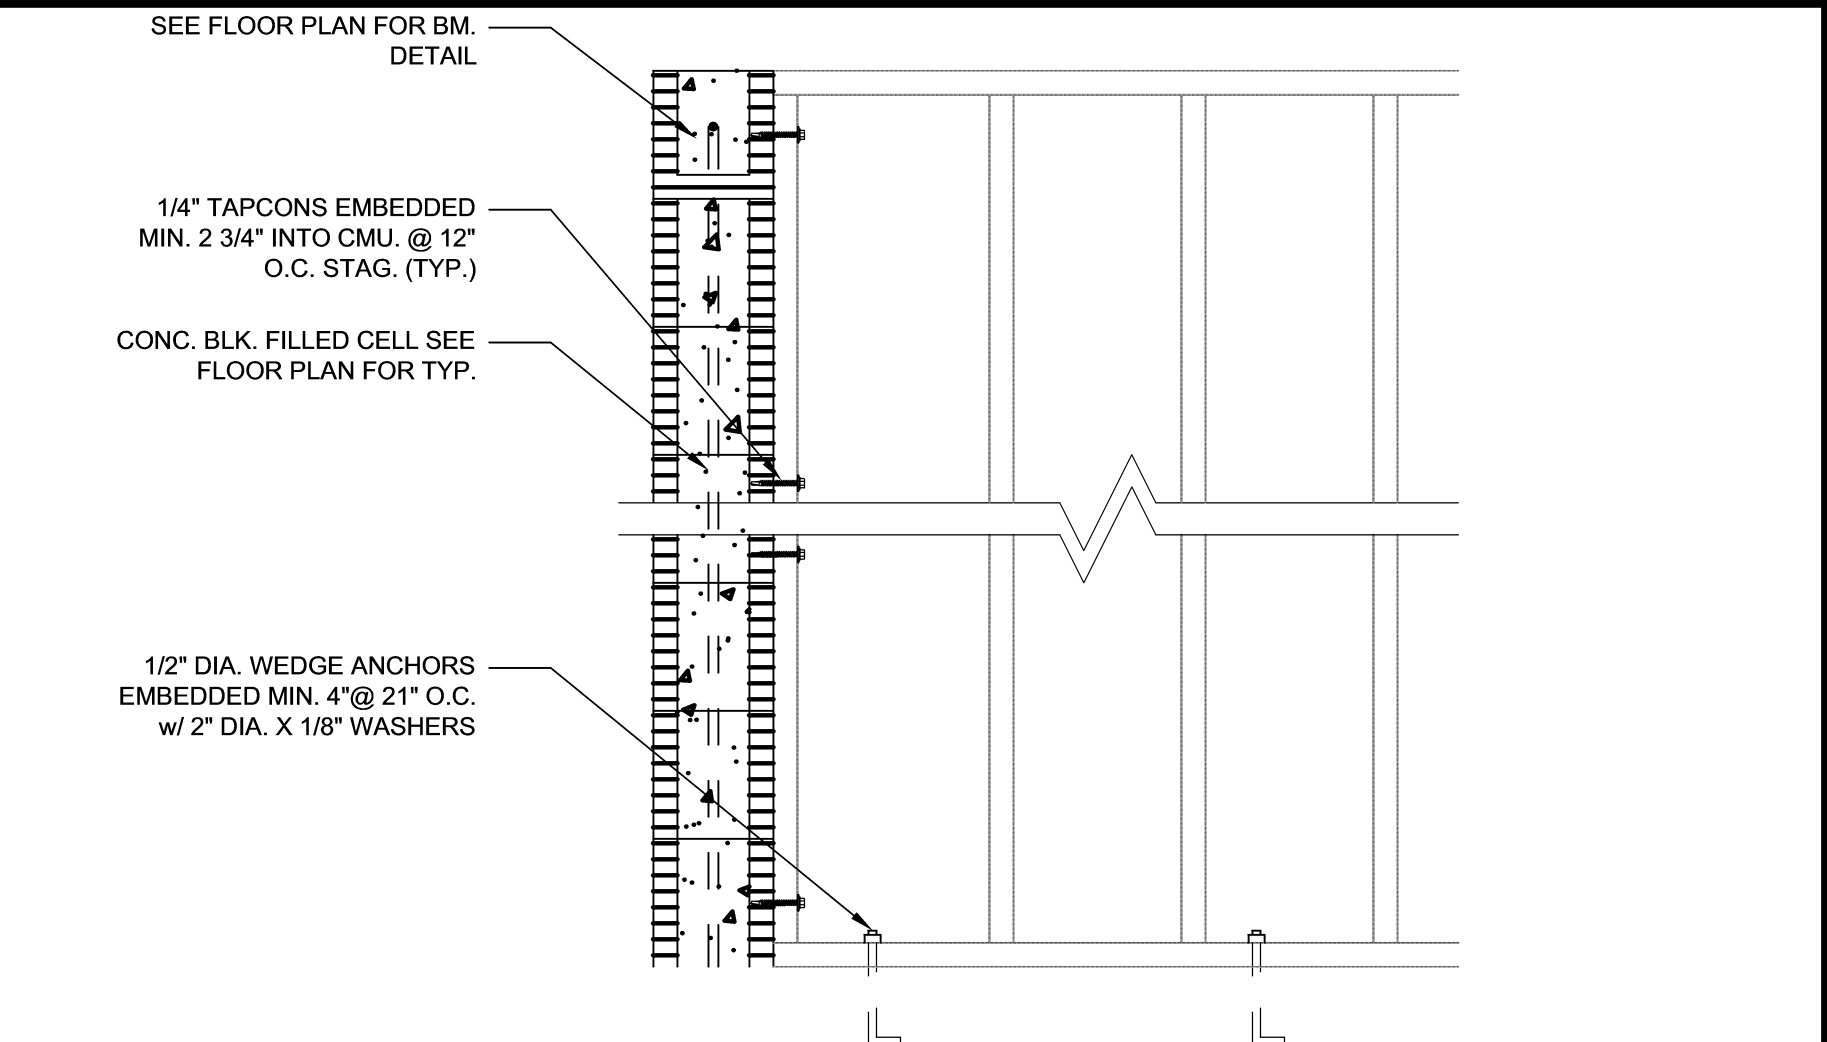
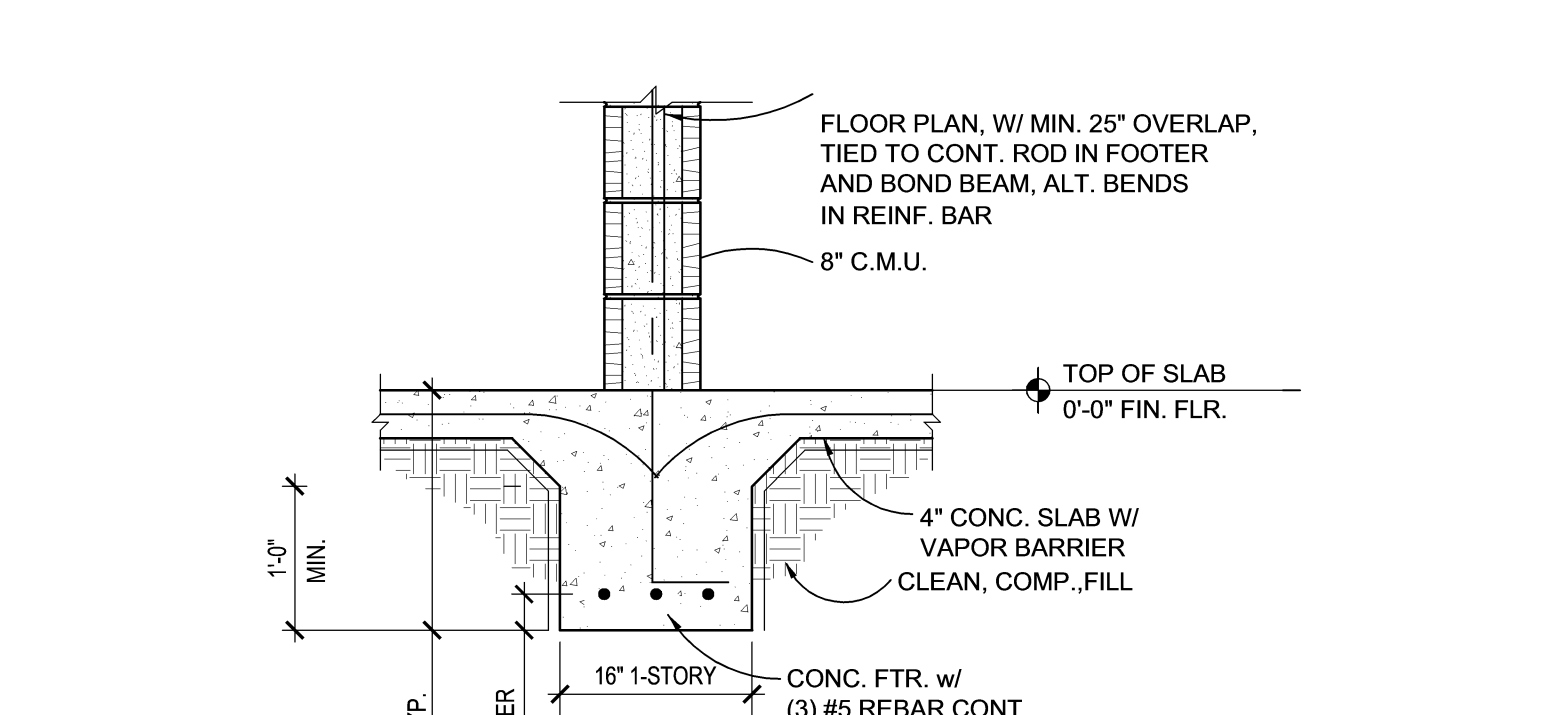
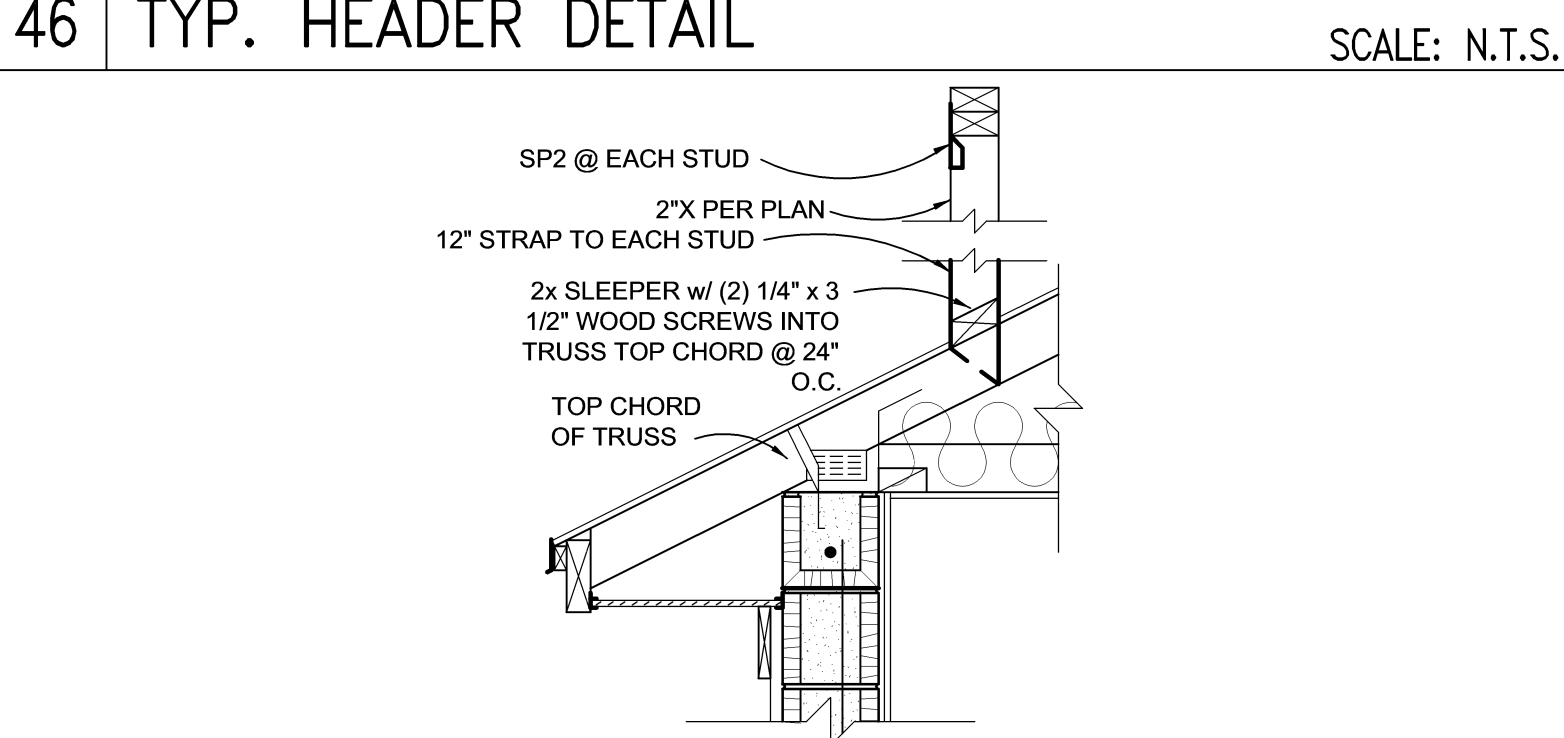
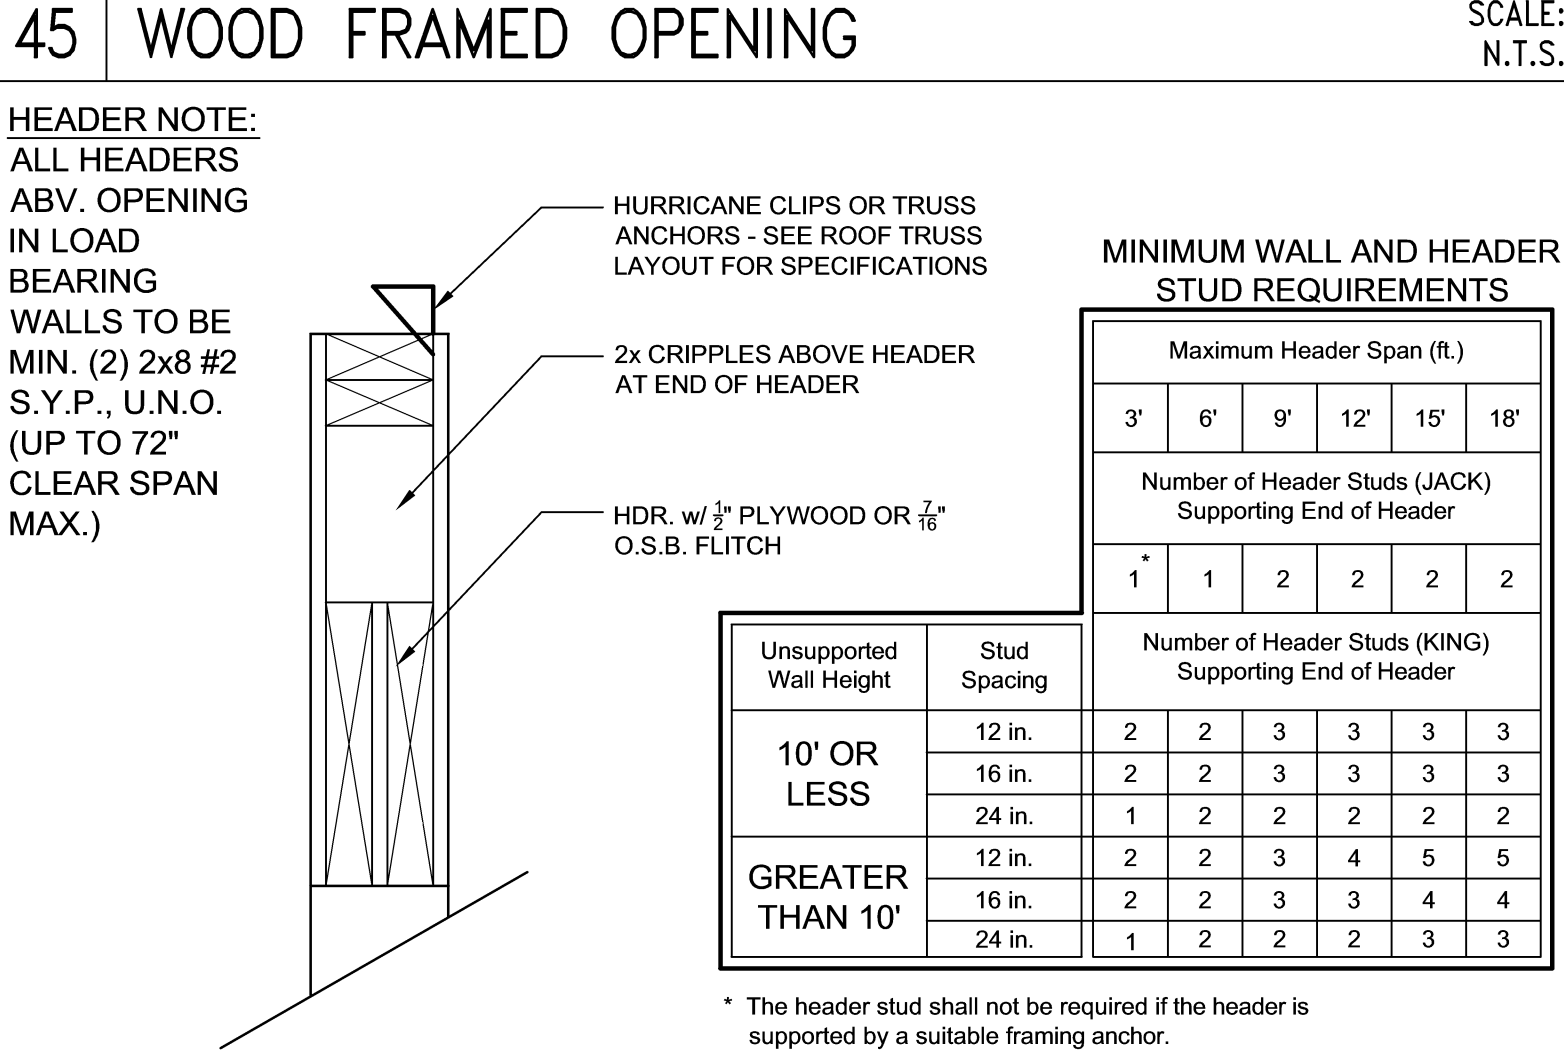
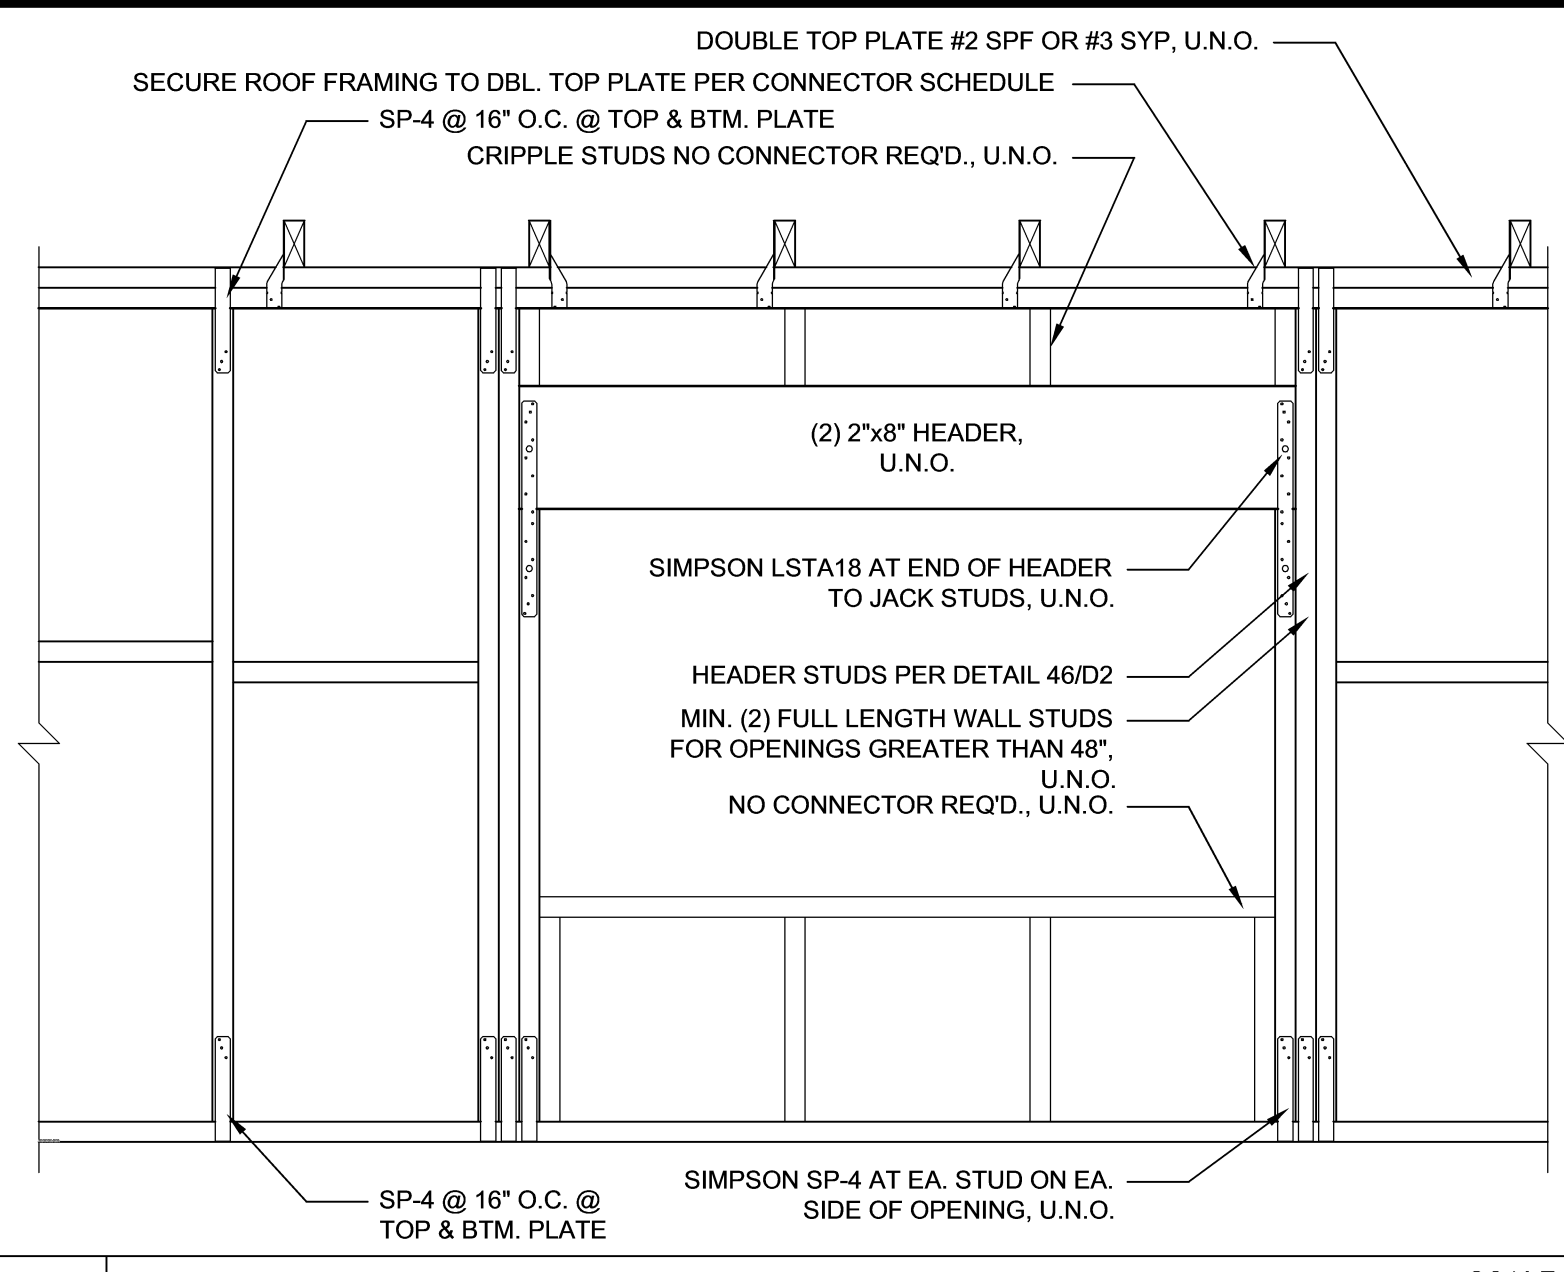
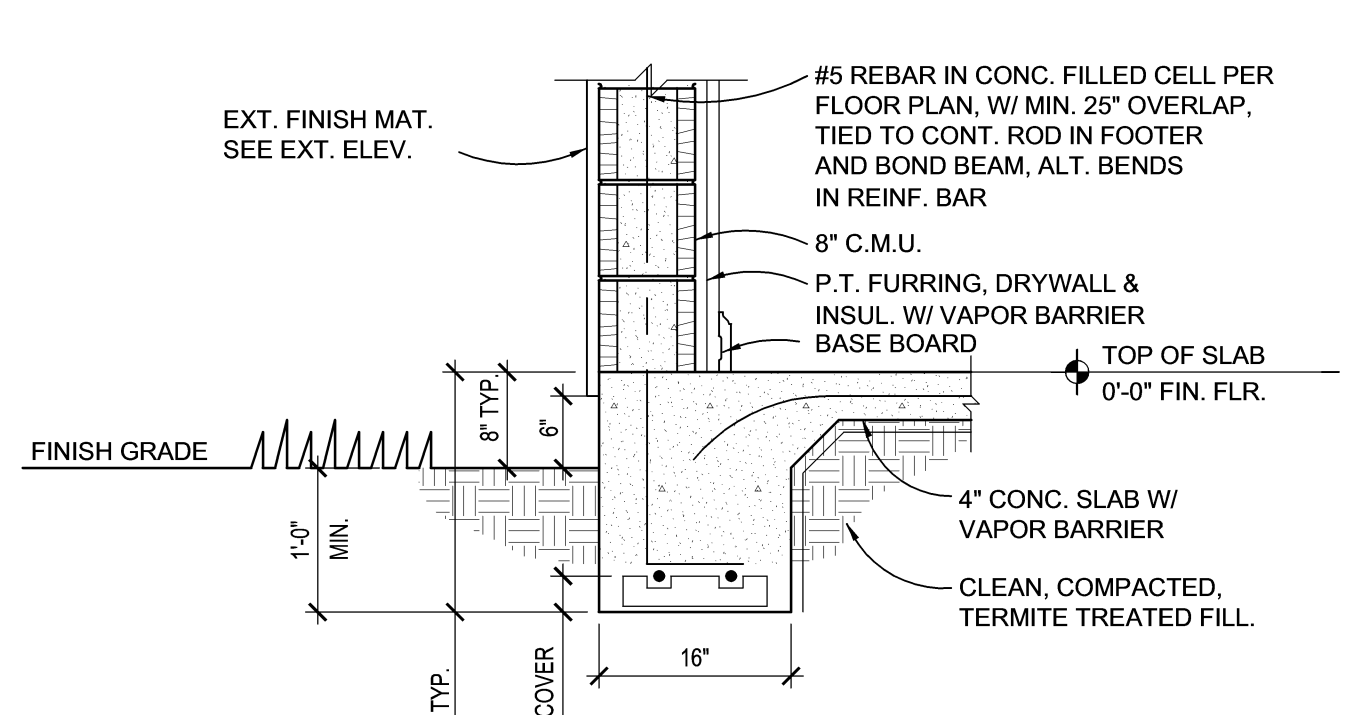
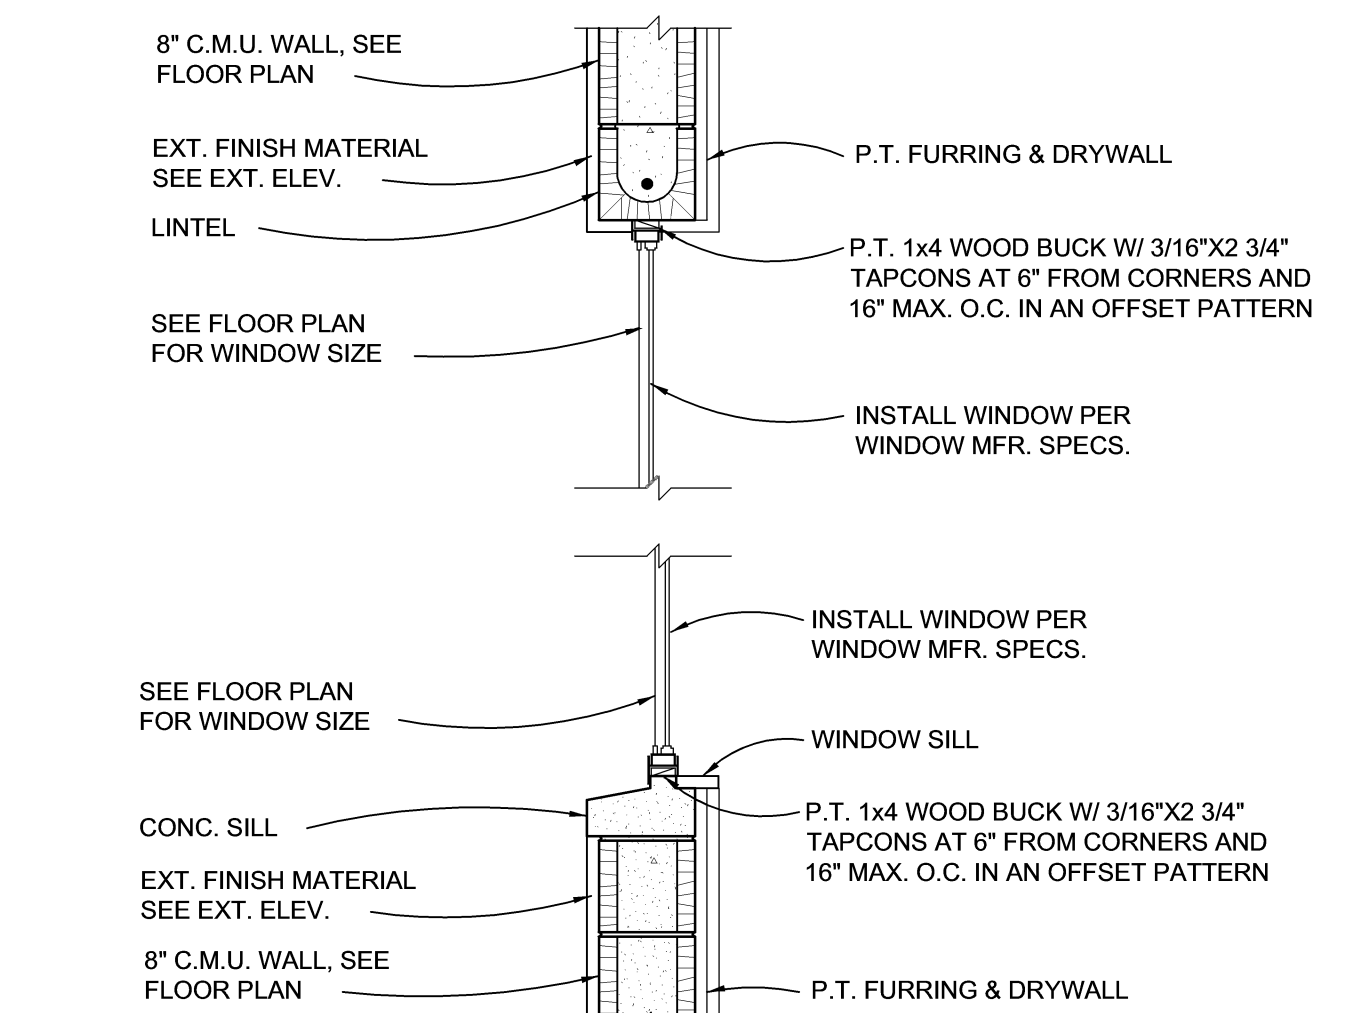
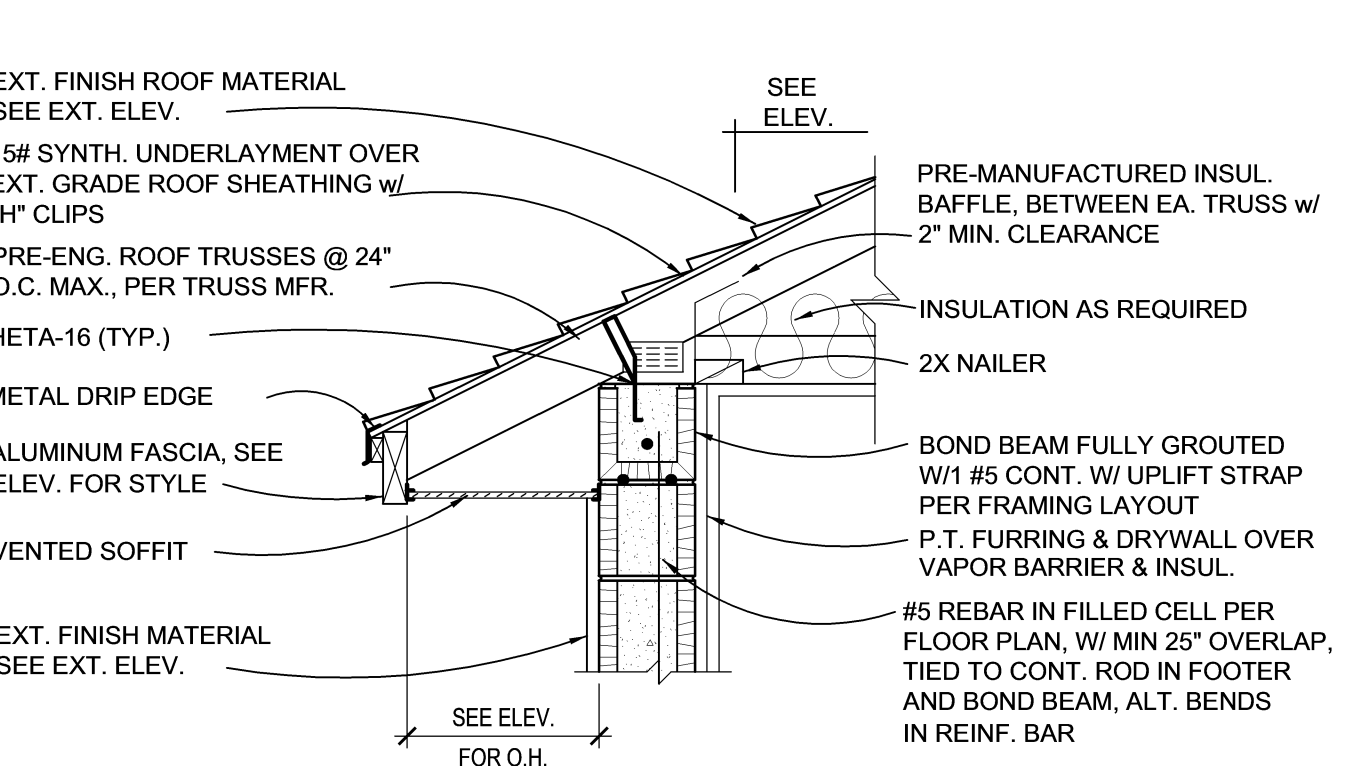
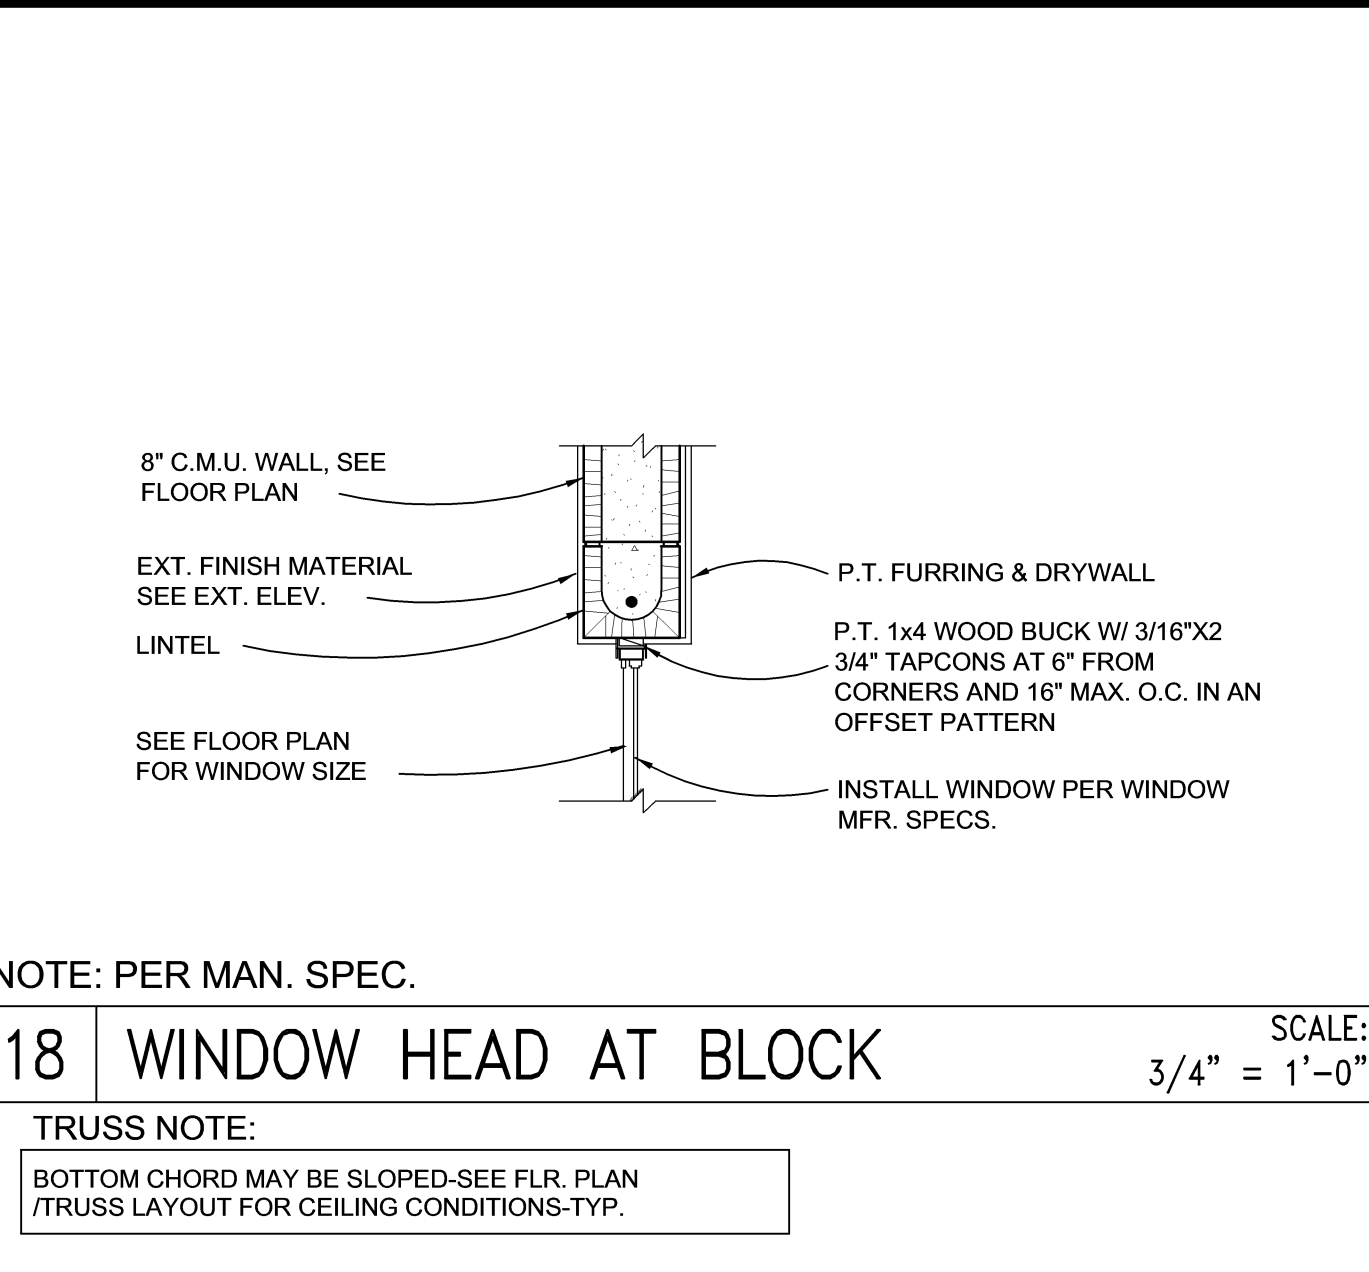
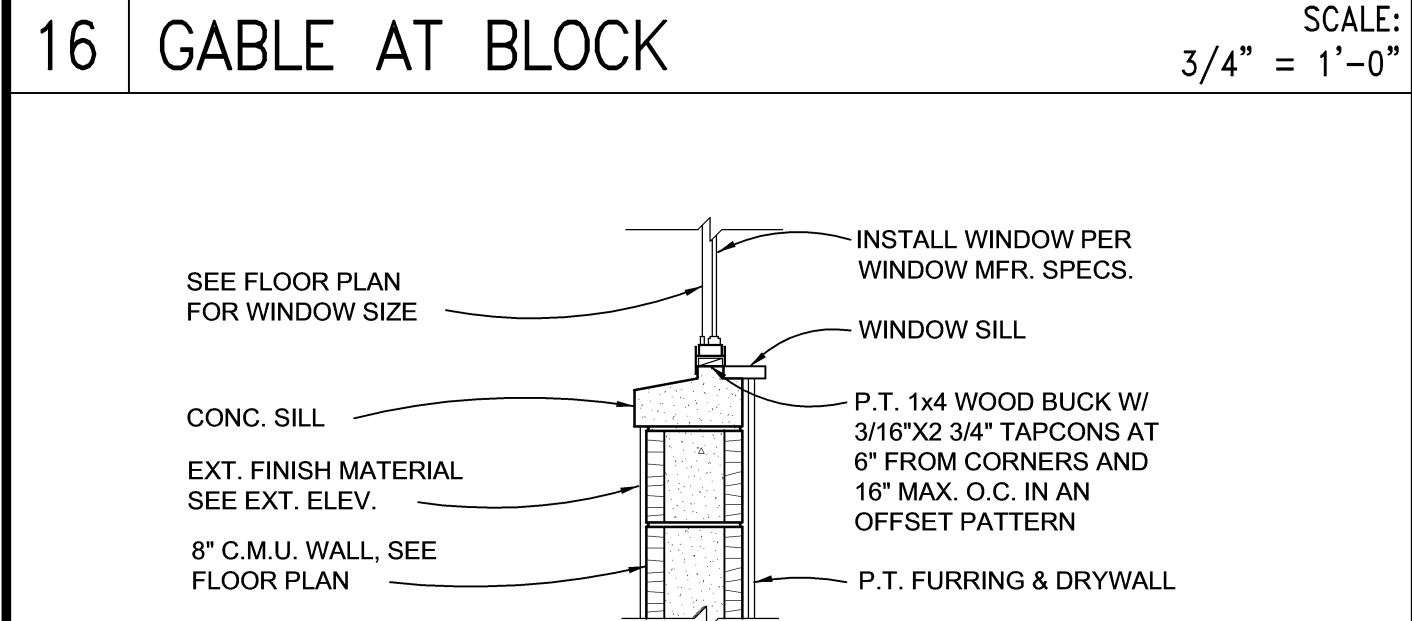
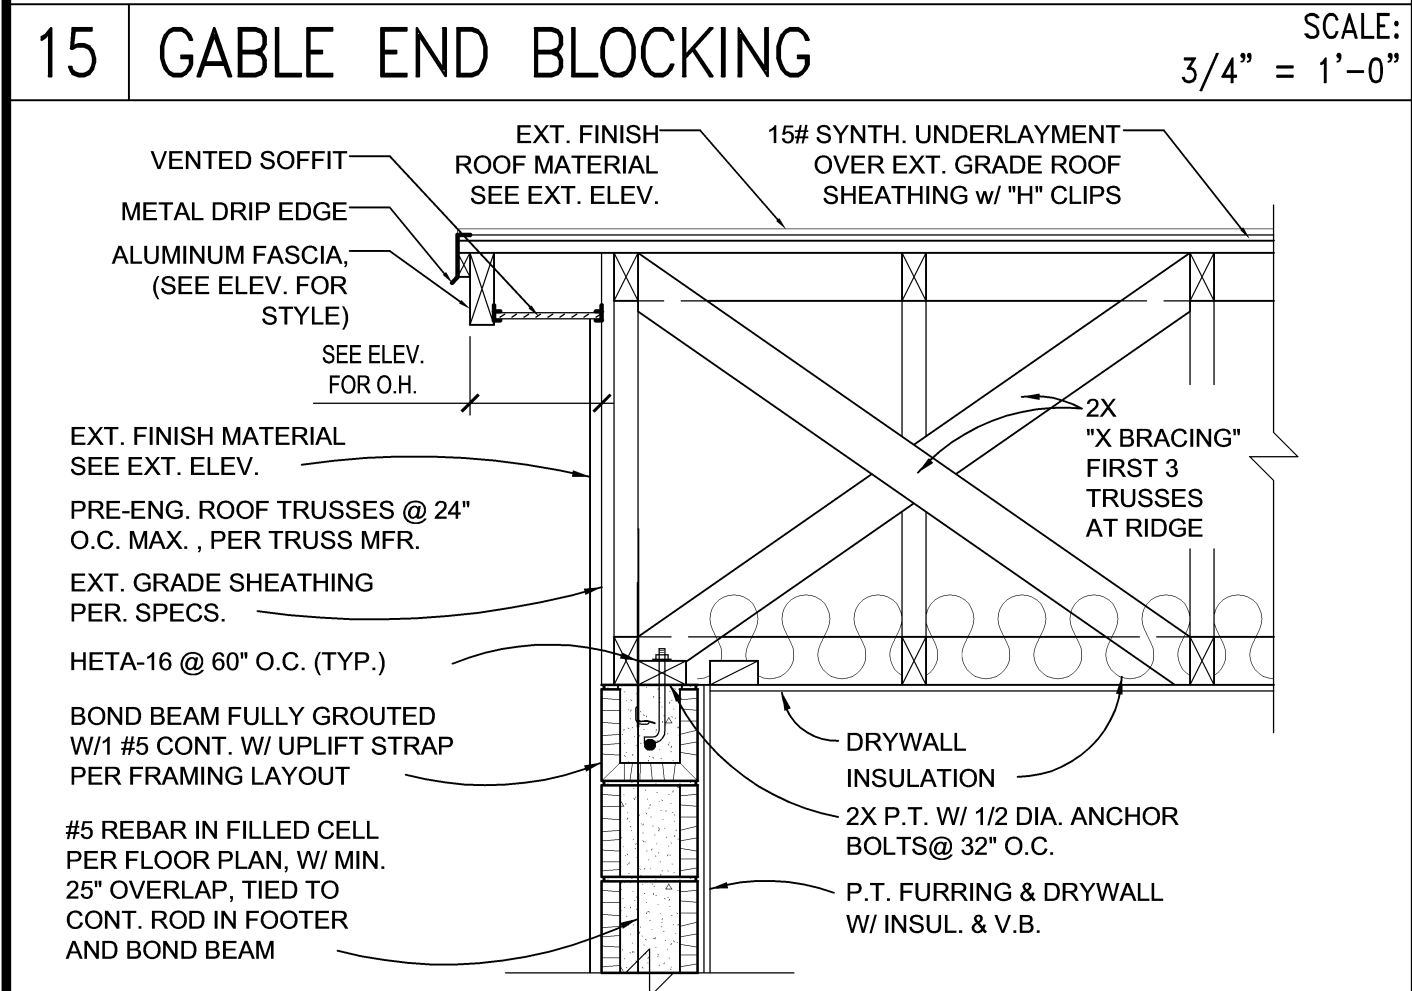
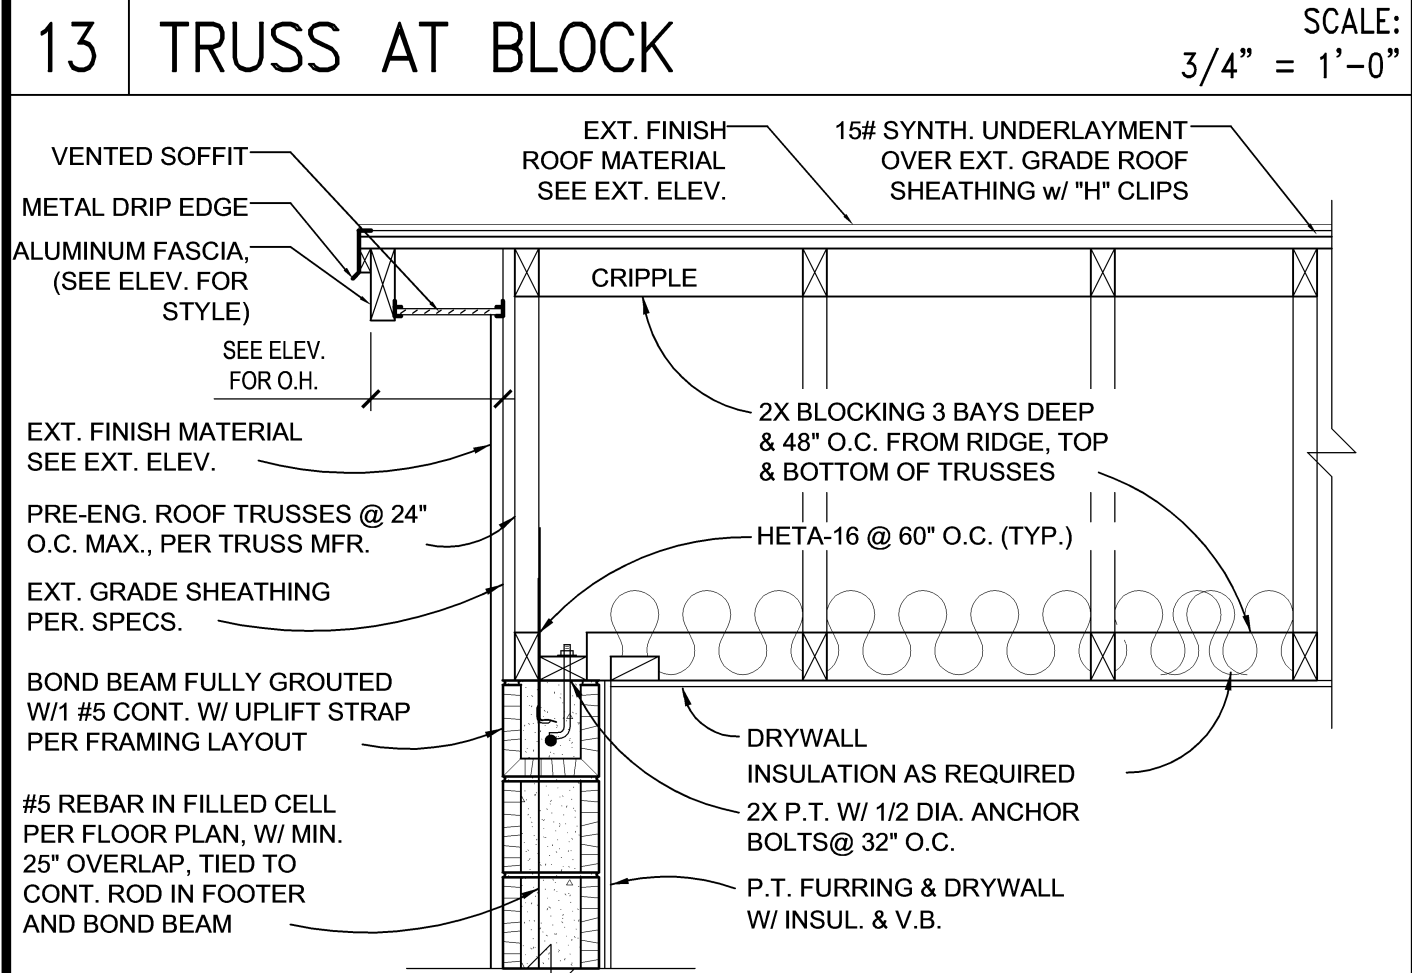
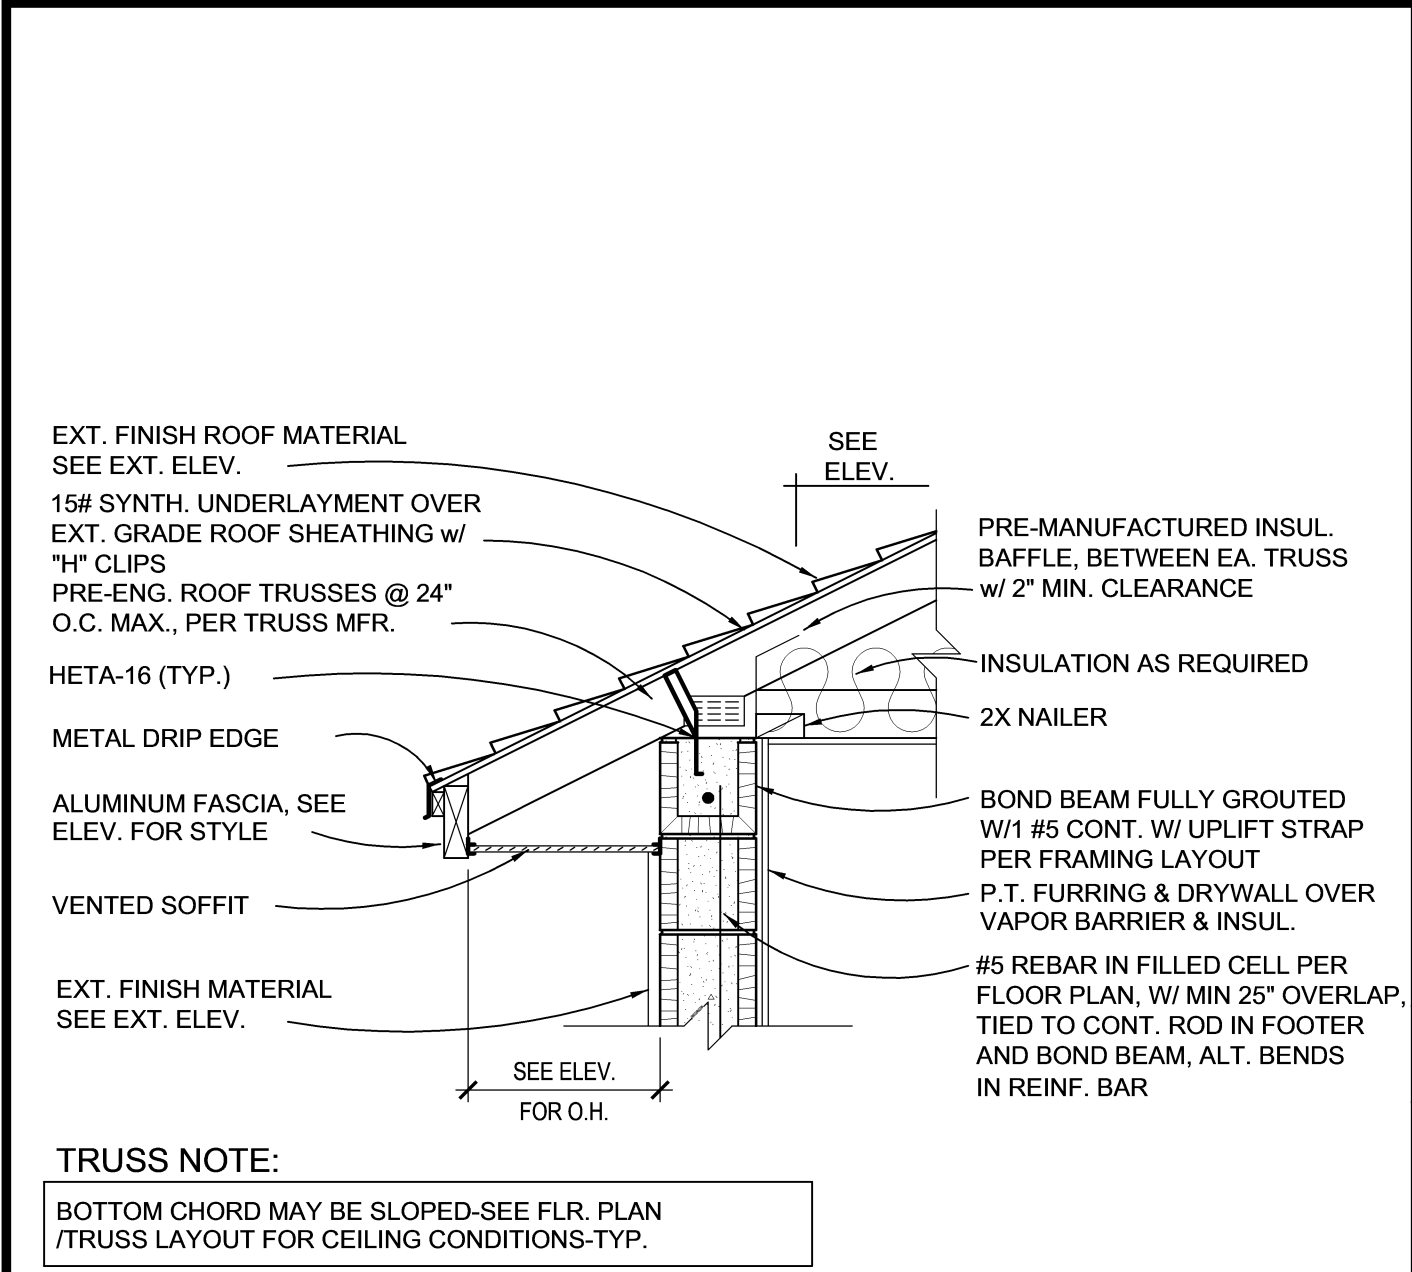
**MJS**  
815 Orienta Ave, Suite# 1040  
Altamonte Springs, FL. 32701  
Ph: (407) 629-6711  
CUSTOM HOME DESIGN  
DESIGNERS - PLANNERS  
www.mjshomedesigns.com  
Fax: (407) 629-6776  
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235 Maitland Avenue S.  
Suite 108-A  
Maitland, FL 32751  
Ph: (407) 227-7416  
www.premier-structural.com  
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May 18, 2019 9:41 pm Carlos Z:\Park Square Homes\MODELS\ORLANDO MODEL\3140 Models (Horizon West)\MODEL\SThe Dorchester (40-3164)\D2 Details.dwg



235 Maitland Avenue S.  
Suite 108-A  
Maitland, FL 32751  
Ph: (407) 227-7416  
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CUSTOM Home design  
DESIGNERS - PLANNERS  
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**MJS**

WRITTEN DIMENSIONS SHALL HAVE PRECEDENCE OVER SCALE DIMENSIONS.  
Corrections shall not be made to dimensions and conditions of the job and M.J.S. shall not be held responsible for any errors or omissions in the drawings, specifications and quantities appearing on these plans.

40-3164  
**DORCHESTER**  
Street Address  
Lot Info  
City, State, Zip


A Division of Park Square  
Enterprises Inc.  
5200 Vineland Rd., Suite #200  
Orlando, FL 32811  
Phone: (407) 525-3000

**Park Square HOMES**

ISSUE DATE	00/00/0000
REVISIONS	
PROJECT:	00-0000
SCALE:	AS NOTED
DRAWN BY:	C.C.
DESIGNED BY:	MJS


DETAILS  
**D2**

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TYP. VALLEY CONNECTION

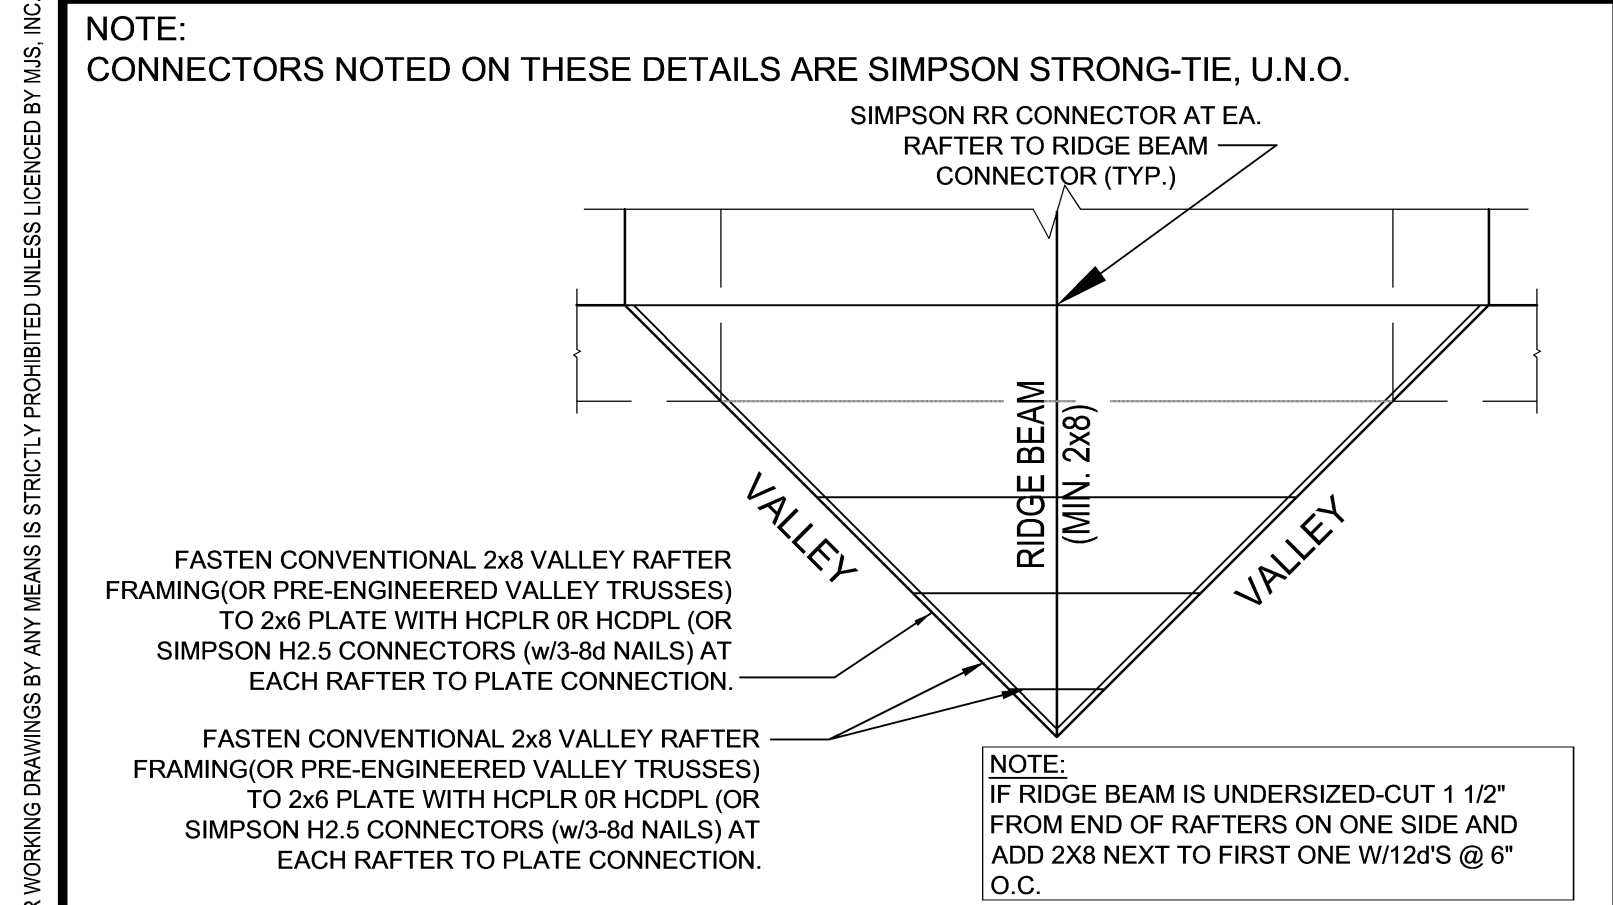SCALE:  
N.T.S.



Roof Nailing Schedule

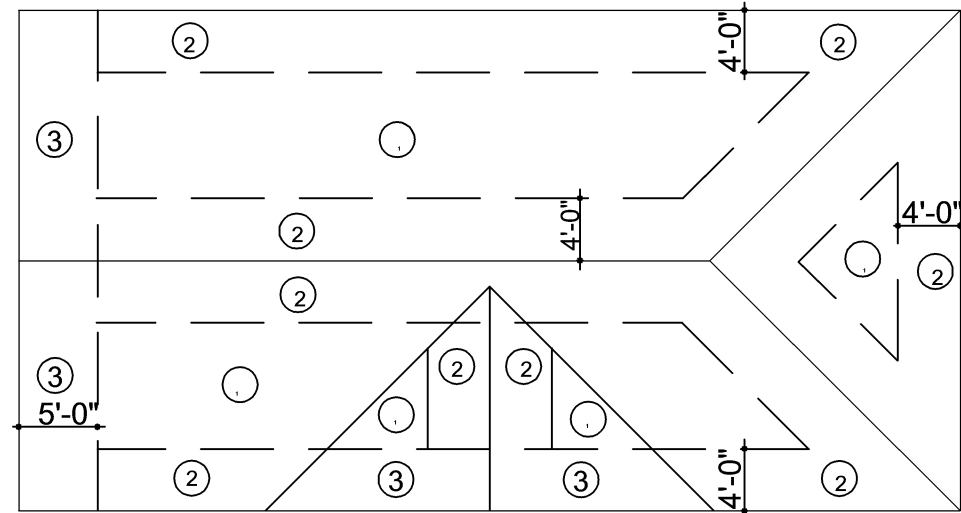ROOF SHEATHING NAILING ZONE NOTES

ROOF SHEATHING NAILING PATTERN


- ZONE 1 : USE 8D RING SHANK NAILS @ 6" O.C. AT EDGES AND 8" O.C. INTERMEDIATE
- ZONE 2 : USE 8D RING SHANK NAILS 6" O.C. (ALL FIELDS)
- ZONE 3 : USE 8D RING SHANK NAILS 4" O.C. (ALL FIELDS)

WALL SHEATHING NAILING PATTERN


- USE 8D RING SHANK NAILS... PANEL EDGES 4" O.C. AT SHEARWALL SEGMENTS; 8" O.C. INTERMEDIATE PANEL EDGES 6" O.C. ELSEWHERE; 12" O.C. INTERMEDIATE 1/2" GYPSUM CEILING : USE 5D NAILS @ 7" ON CENTER SECOND FLOOR NAILING : 8D @ 6" O.C. EDGES (GLUE & NAIL) @ 12" O.C. @ FIELD

BOND BREAK/FLASHING

SCALE:  
3" = 1'-0"

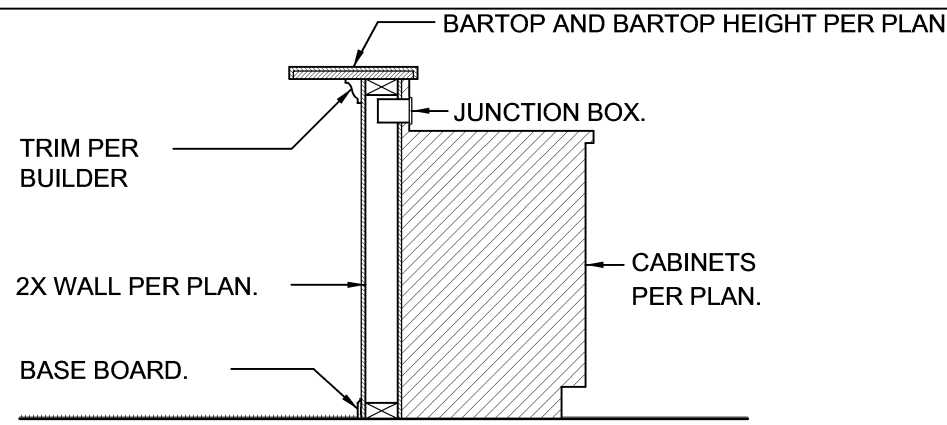


BARTOP DETAIL

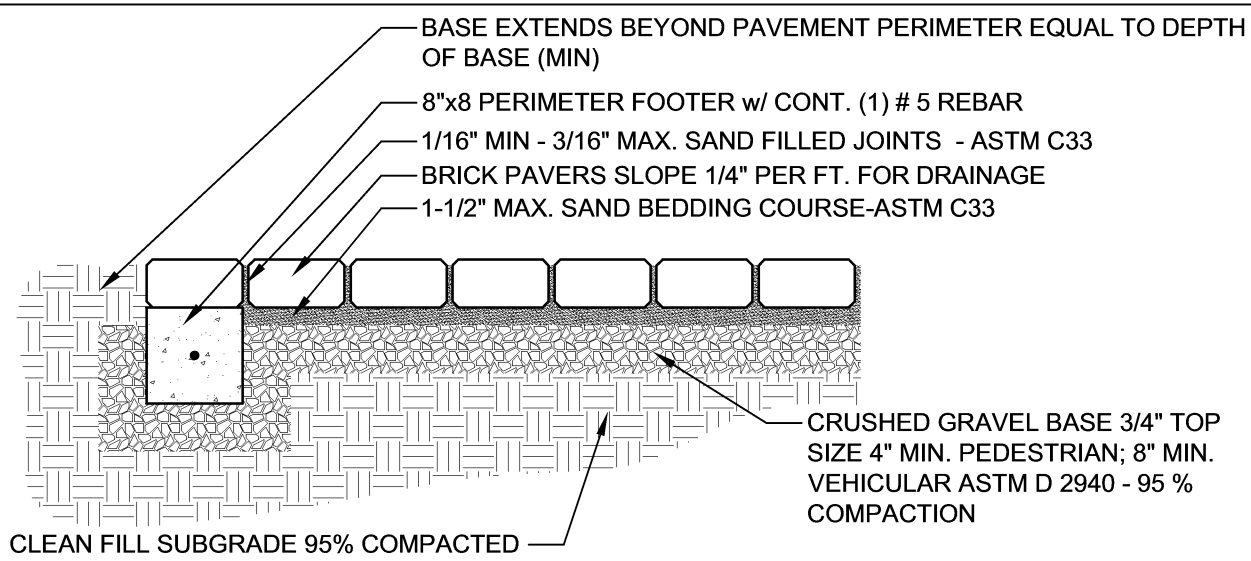

PAVER PATIO/SIDEWALK EDGE DET.


SCALE:  
N.T.S.

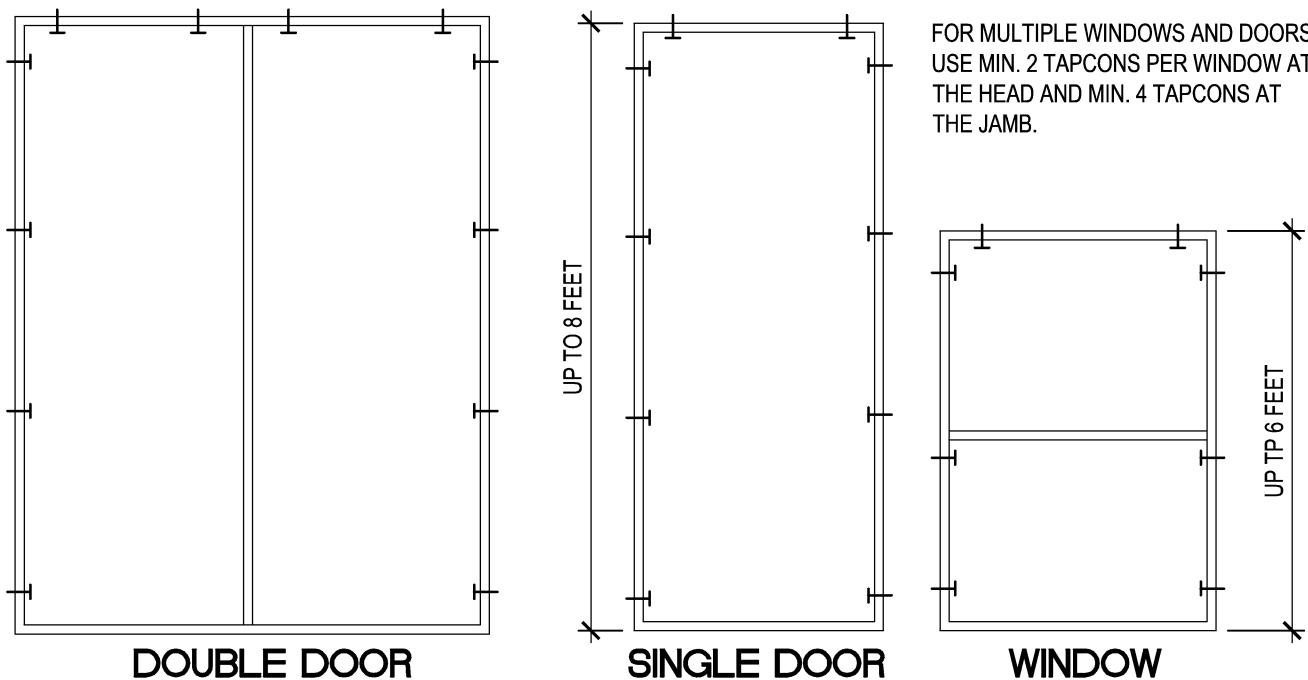


WINDOW / DOOR BUCK ATTACHMENT

FLASHING DETAIL

SCALE:  
N.T.S.

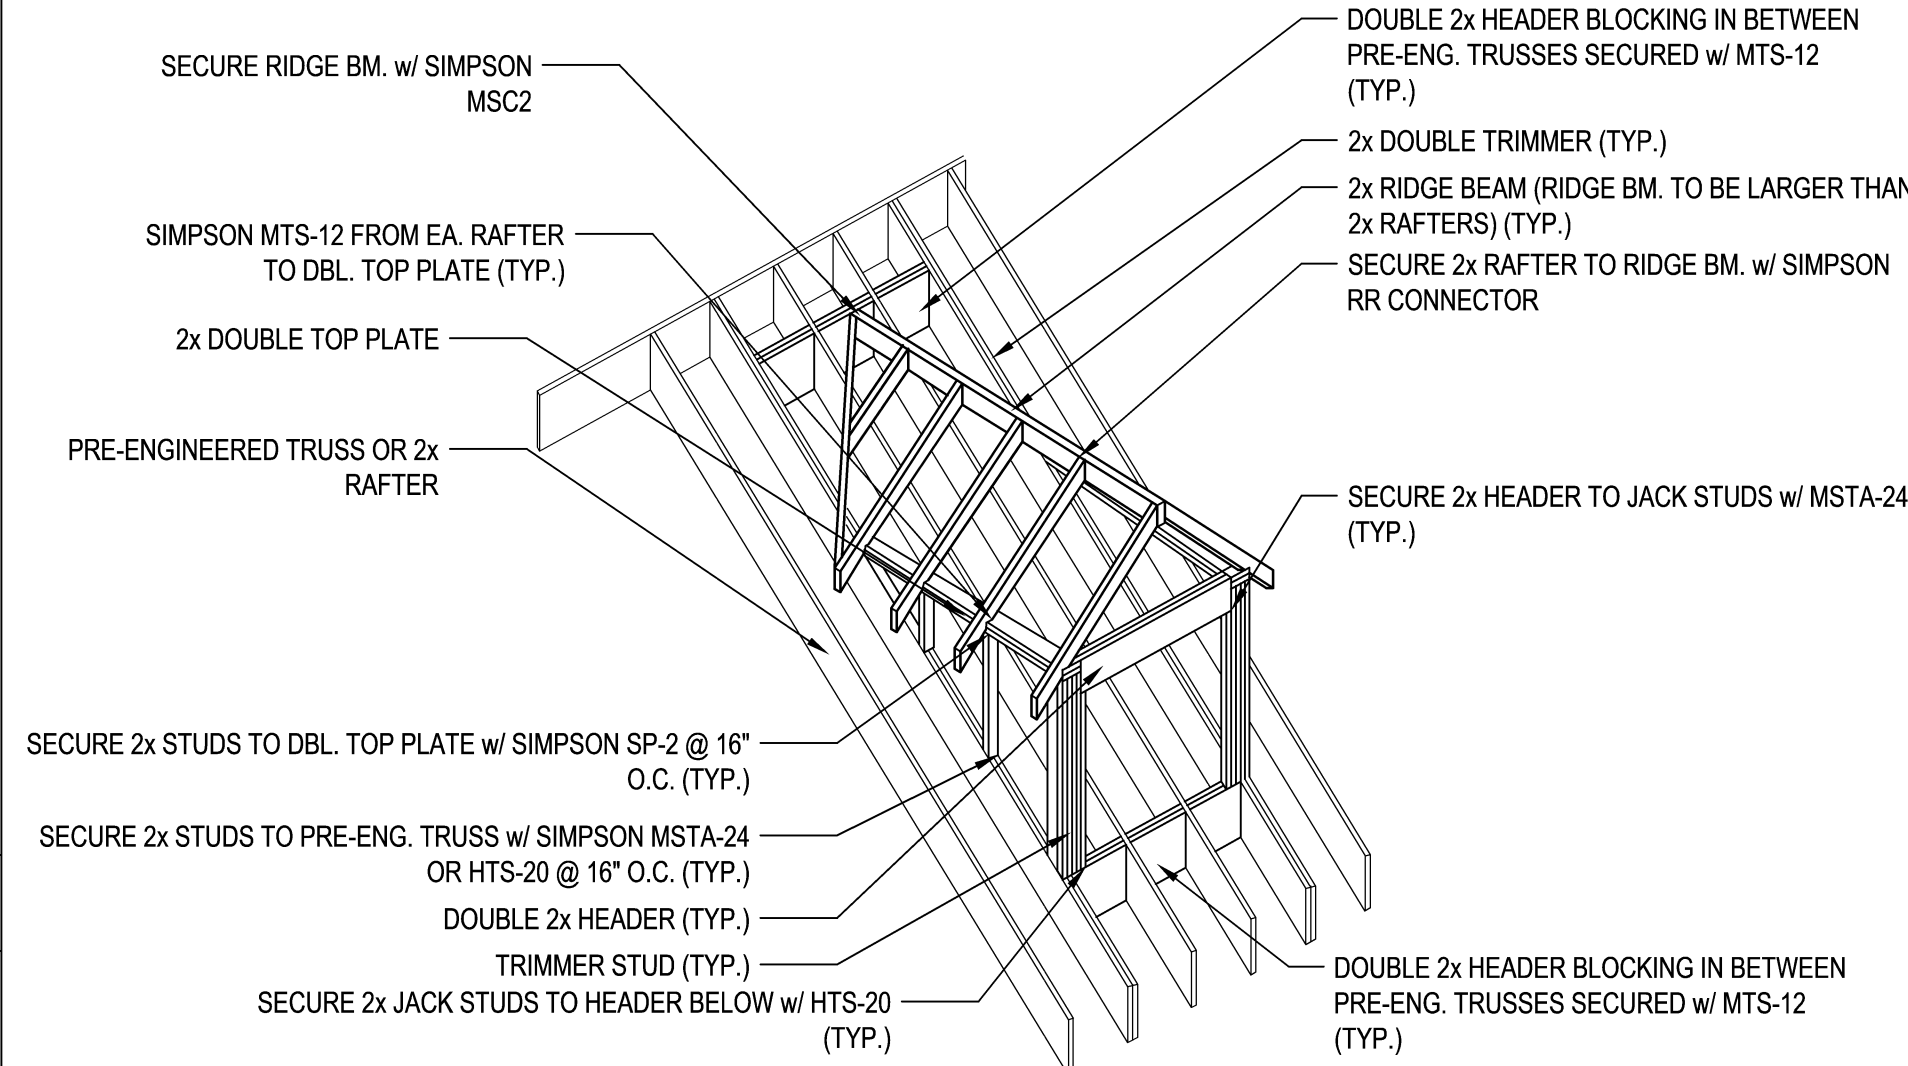


NON-OPERABLE DORMER

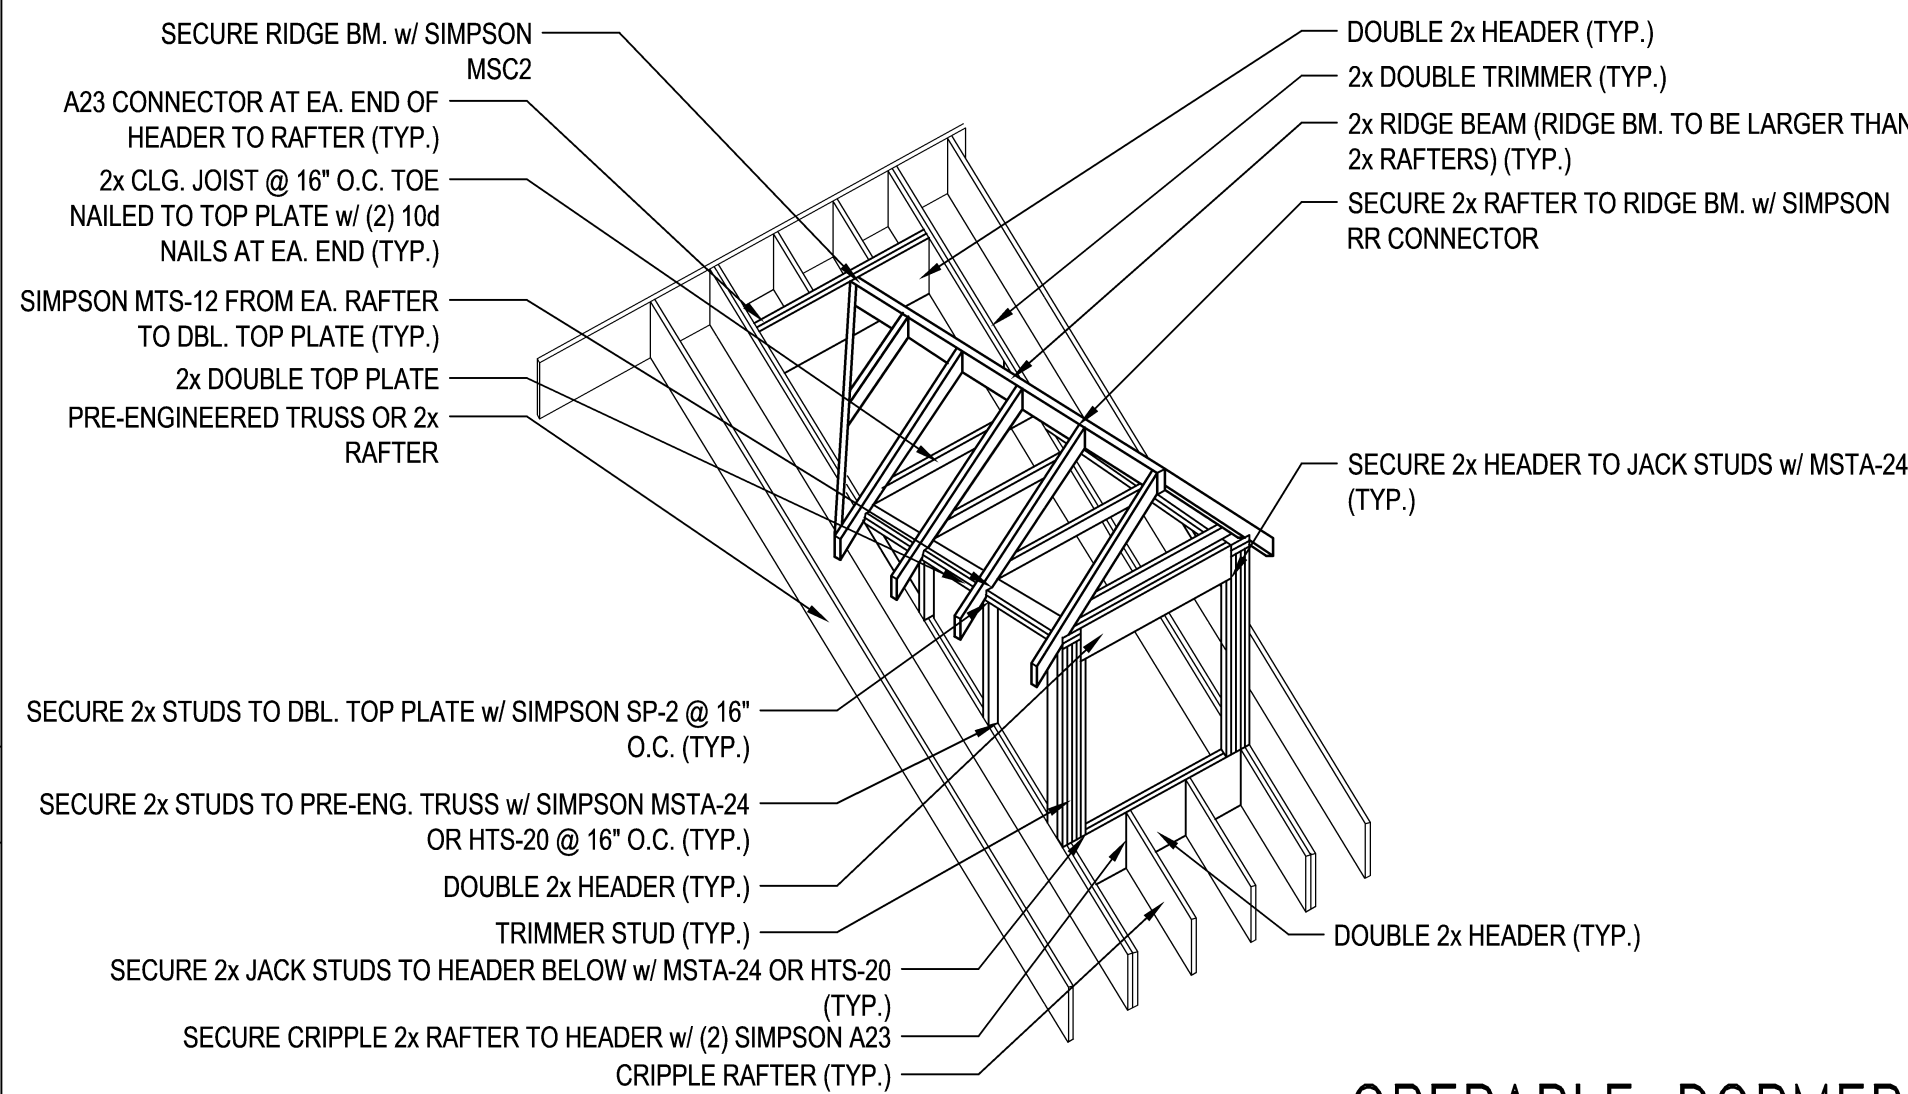

OPERABLE DORMER


TYP. DORMER FRAMING

SCALE:  
N.T.S.

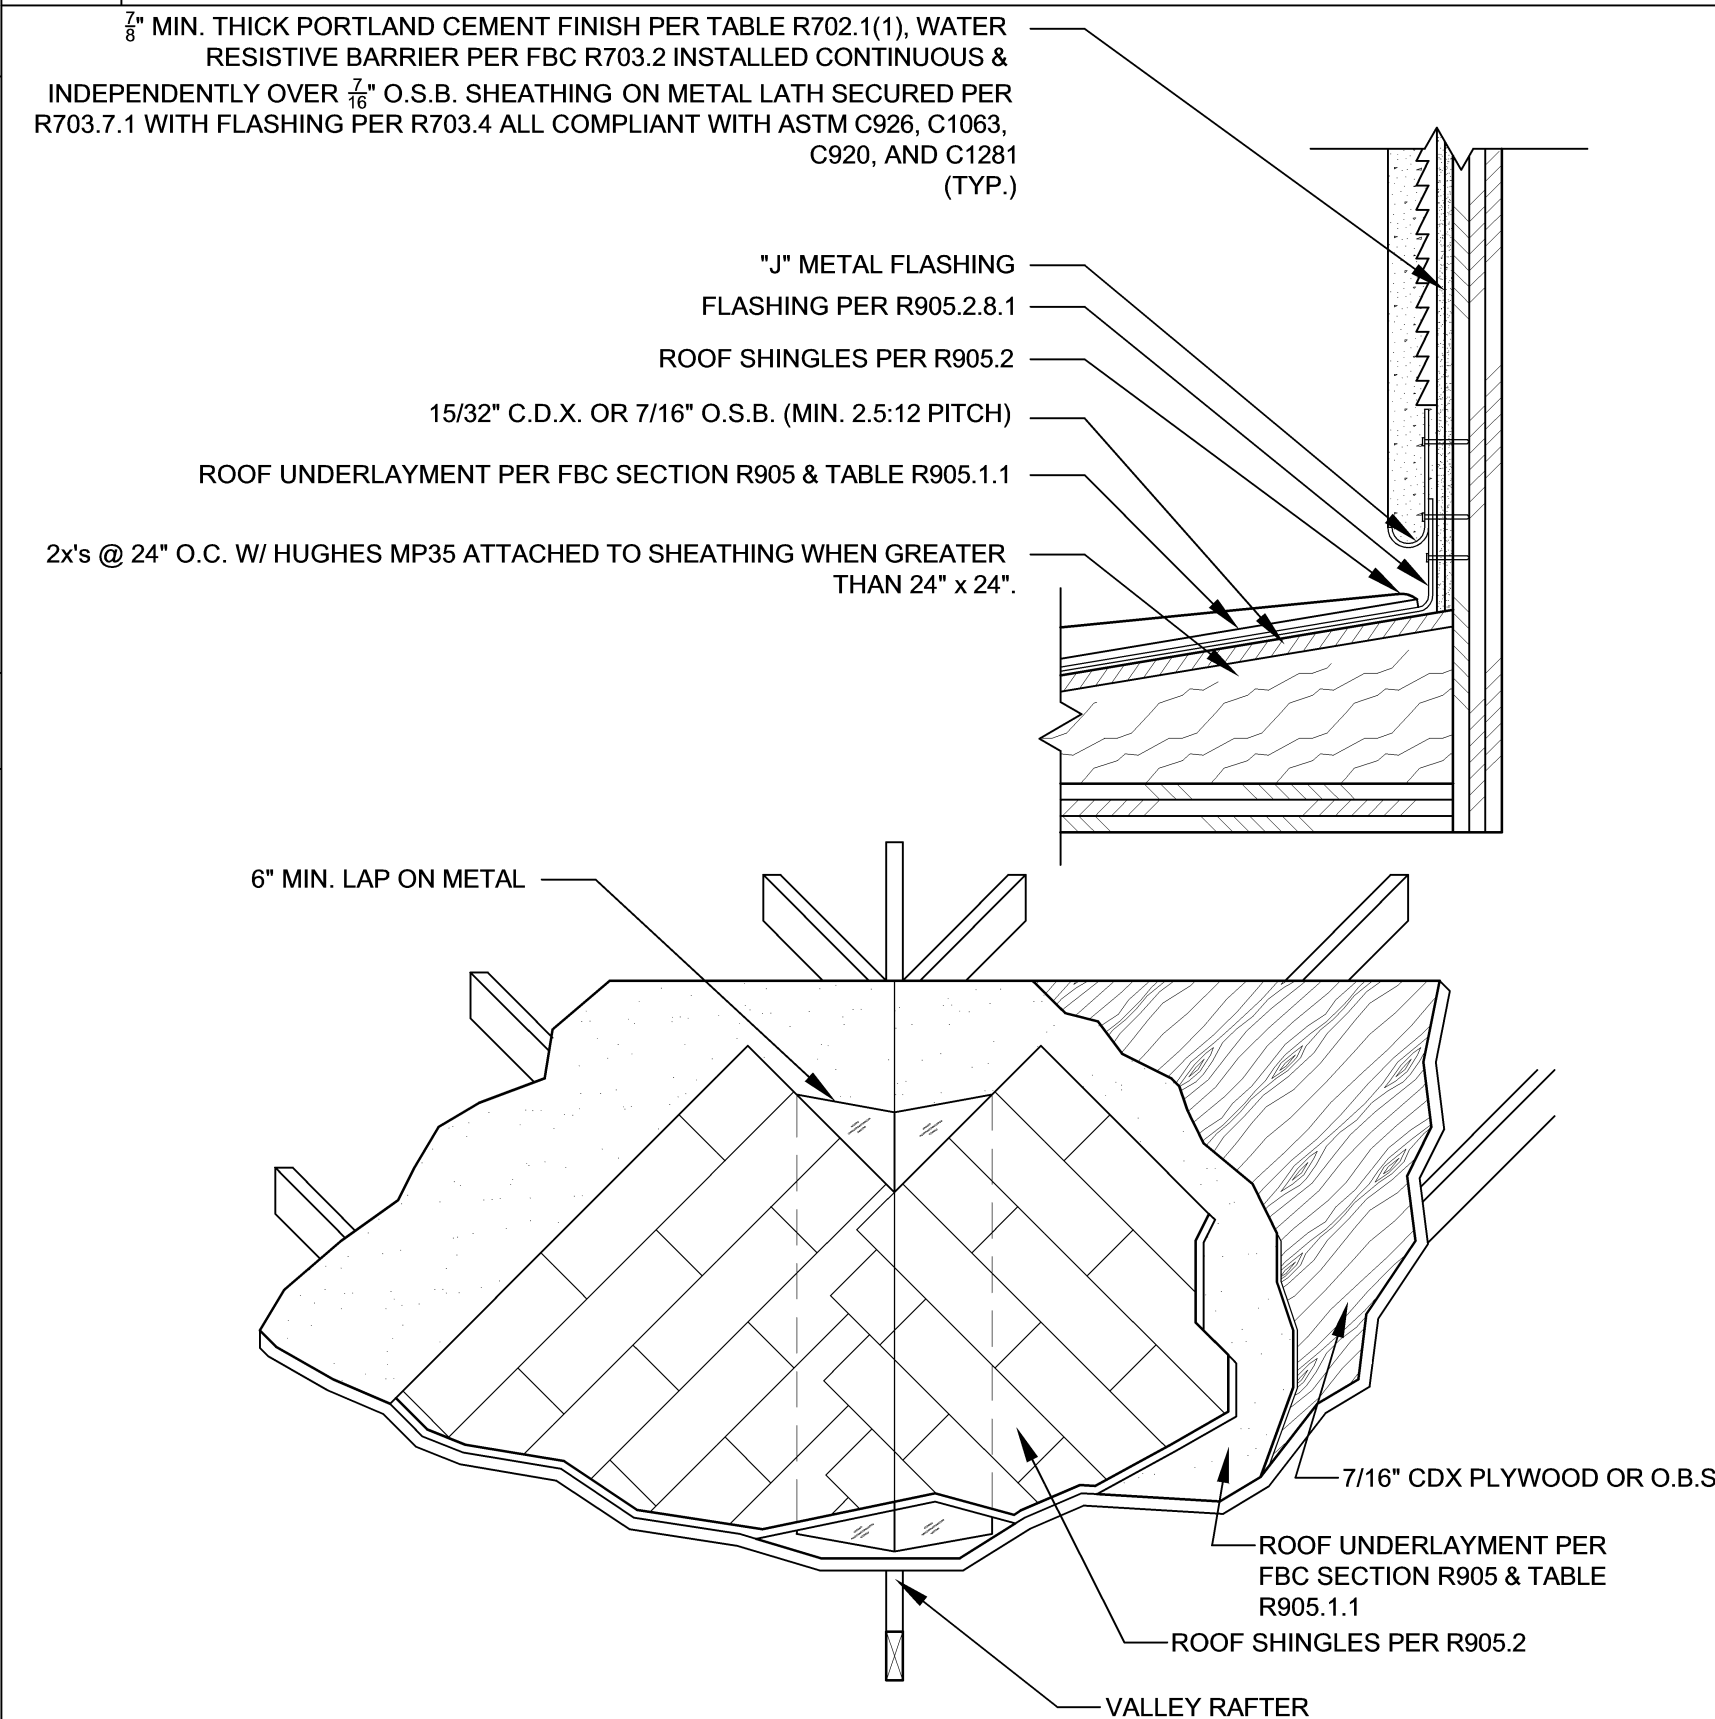


WINDOW INSTALLATION (METHOD A-1) (ASTM E 2112-01)

WEATHER RESISTIVE BARRIER (WRB) APPLIED PRIOR TO THE WINDOW INSTALLATION.  
FLASHING APPLIED OVER THE FACE OF THE MOUNTING FLANGE.

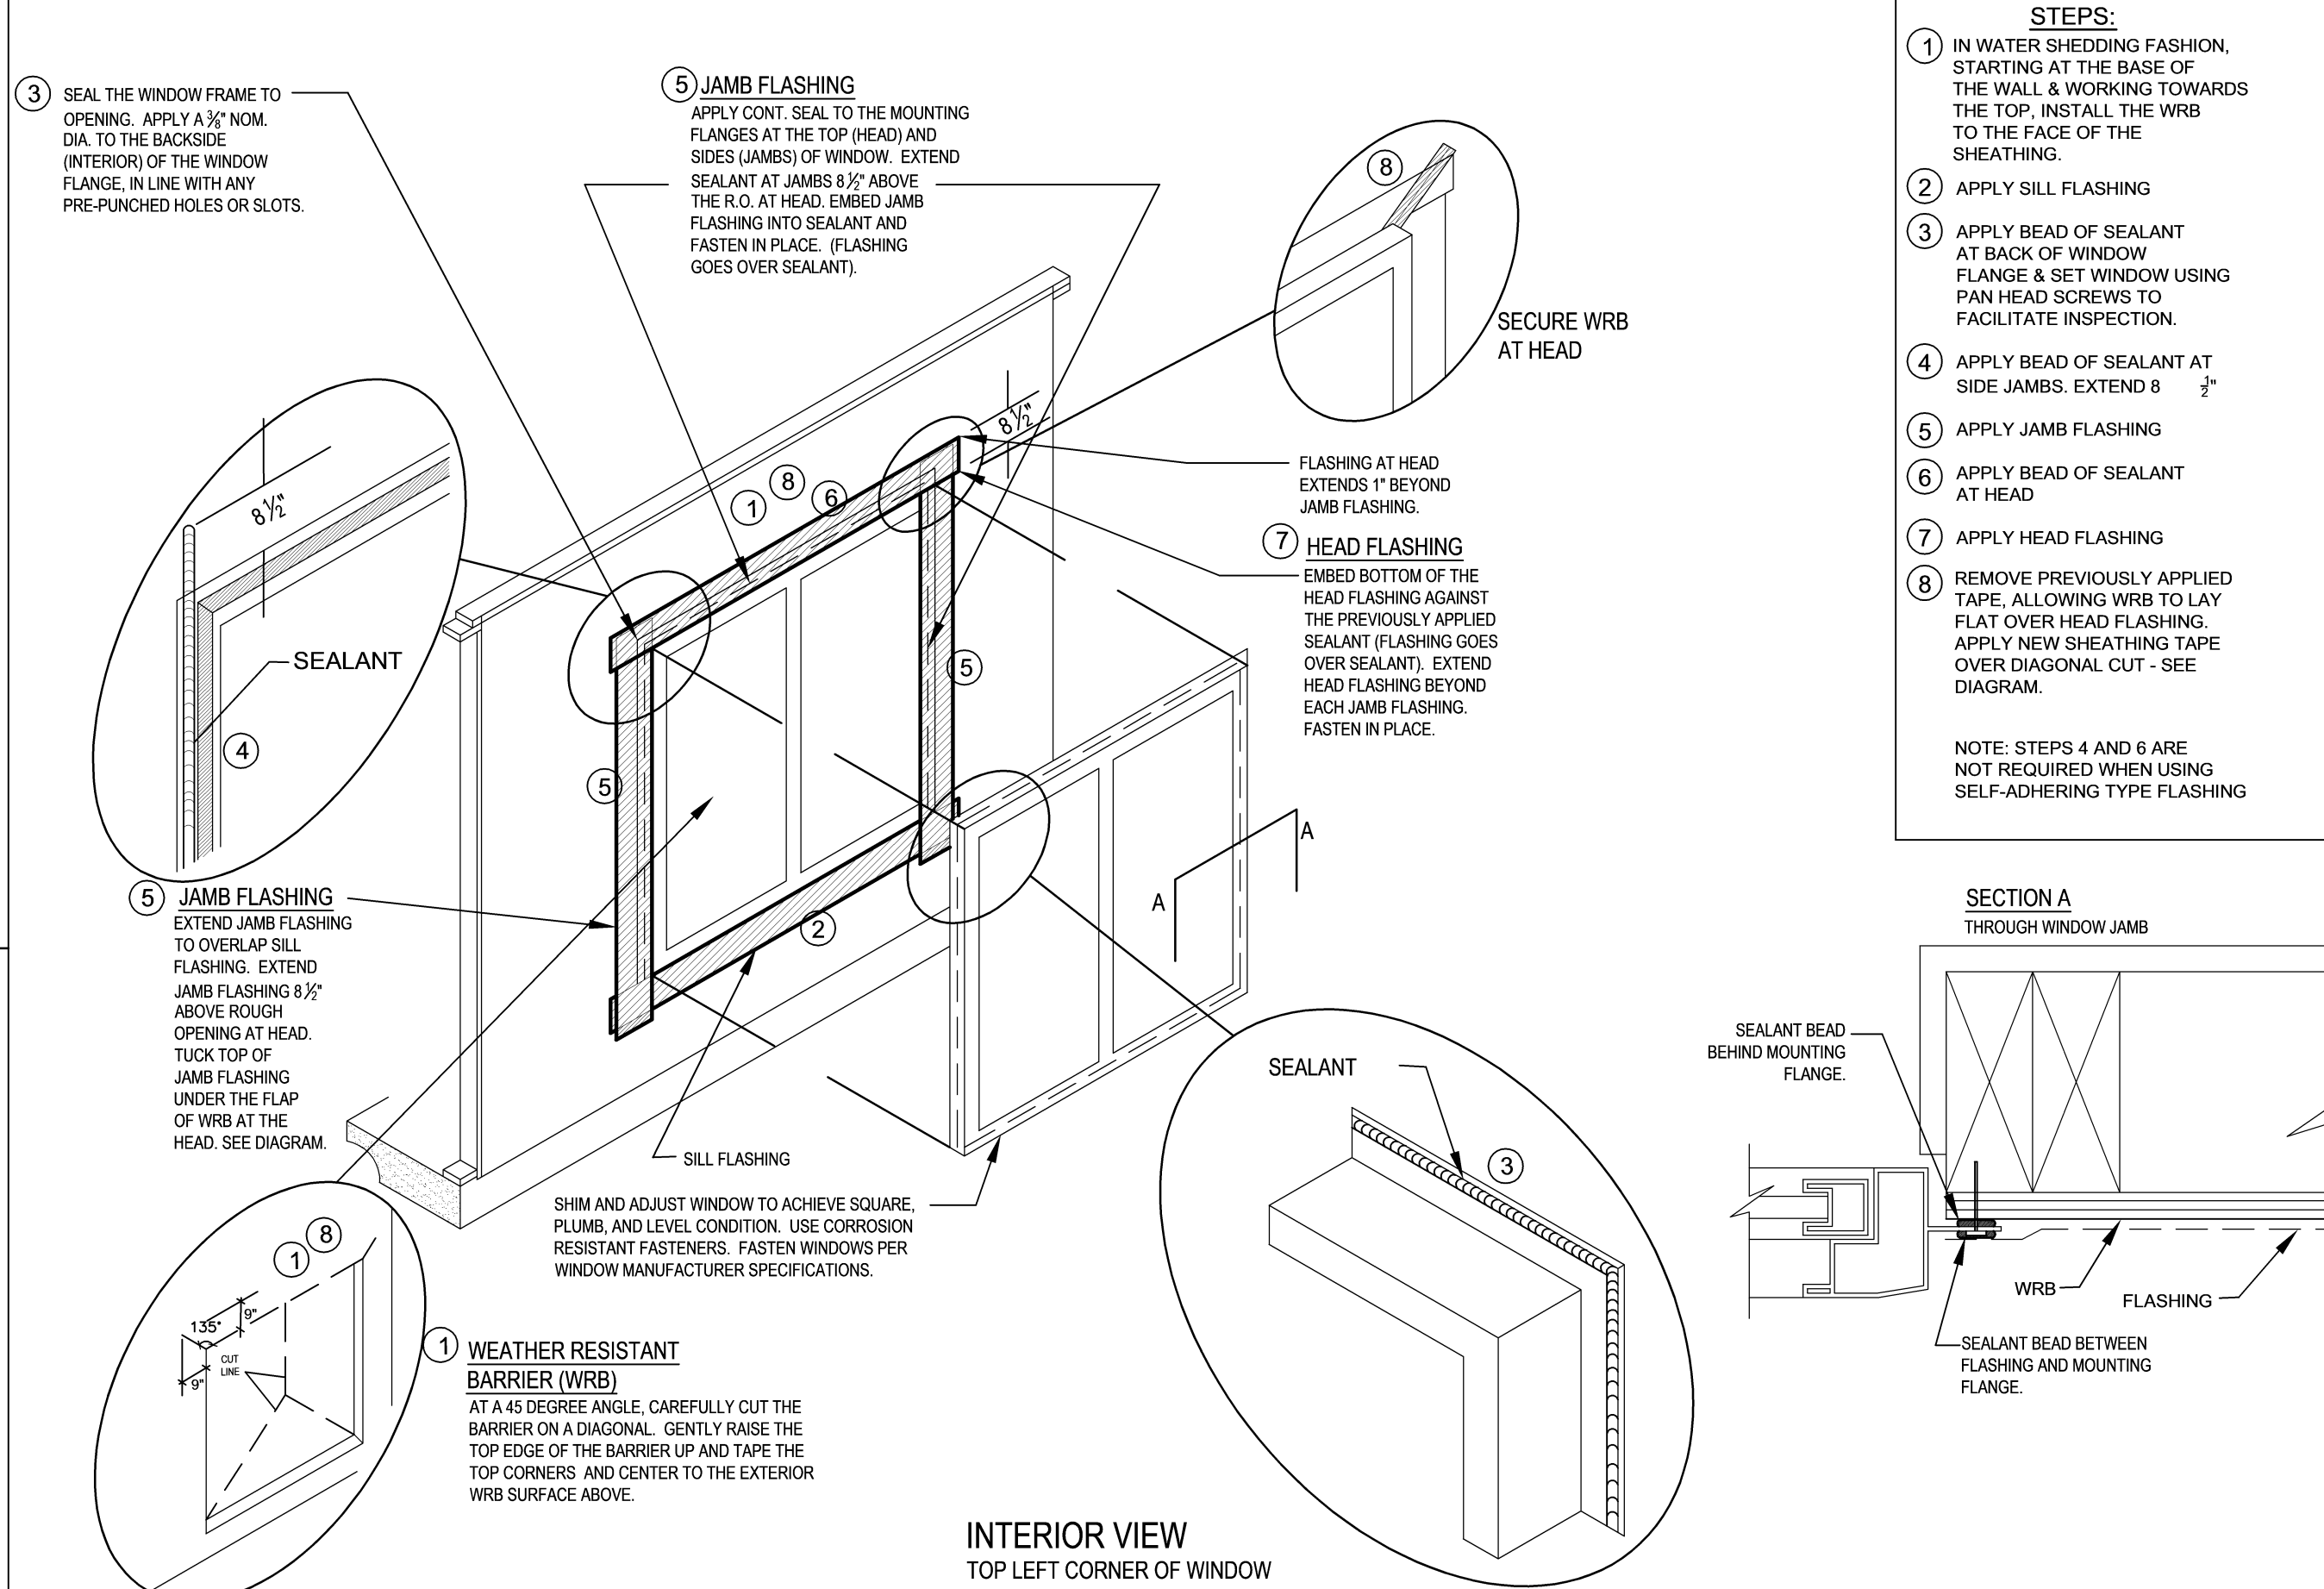


- STEPS:
- 1 IN WATER SHEDDING FASHION, STARTING AT THE BASE OF THE WALL & WORKING TOWARDS THE TOP, INSTALL THE WRB TO THE FACE OF THE SHEATHING.
  - 2 APPLY SILL FLASHING
  - 3 APPLY BEAD OF SEALANT AT BACK OF WINDOW FLANGE & SET WINDOW USING PAN HEAD SCREWS TO FACILITATE INSPECTION.
  - 4 APPLY BEAD OF SEALANT AT SIDE JAMBS. EXTEND 8 1/2"
  - 5 APPLY JAMB FLASHING
  - 6 APPLY BEAD OF SEALANT AT HEAD
  - 7 APPLY HEAD FLASHING
  - 8 REMOVE PREVIOUSLY APPLIED TAPE, ALLOWING WRB TO LAY FLAT OVER HEAD FLASHING. APPLY NEW SHEATHING TAPE OVER DIAGONAL CUT - SEE DIAGRAM.
- NOTE: STEPS 4 AND 6 ARE NOT REQUIRED WHEN USING SELF-ADHERING TYPE FLASHING

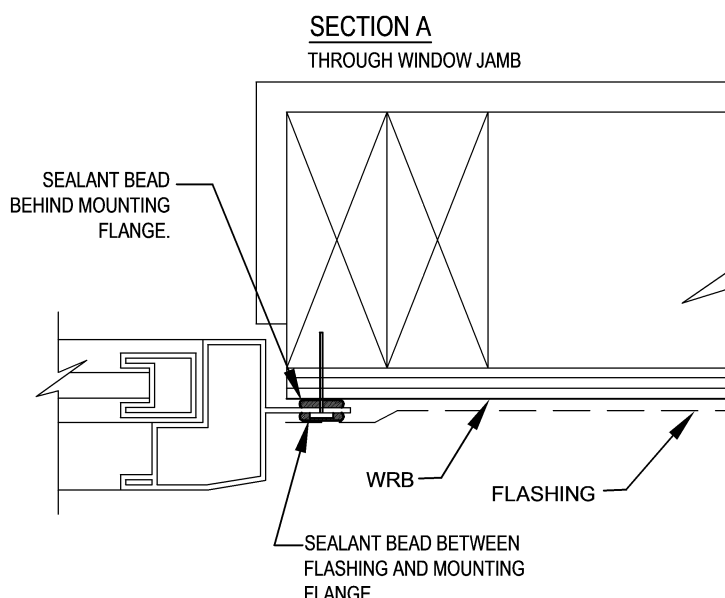

NOTE:  
ALL FLASHING WILL BE SELF-ADHEARING AND ROLLED SMOOTH & FLAT WITH A J-ROLLER.

WINDOW FLASHING "METHOD A-1"

SCALE:  
N.T.S.

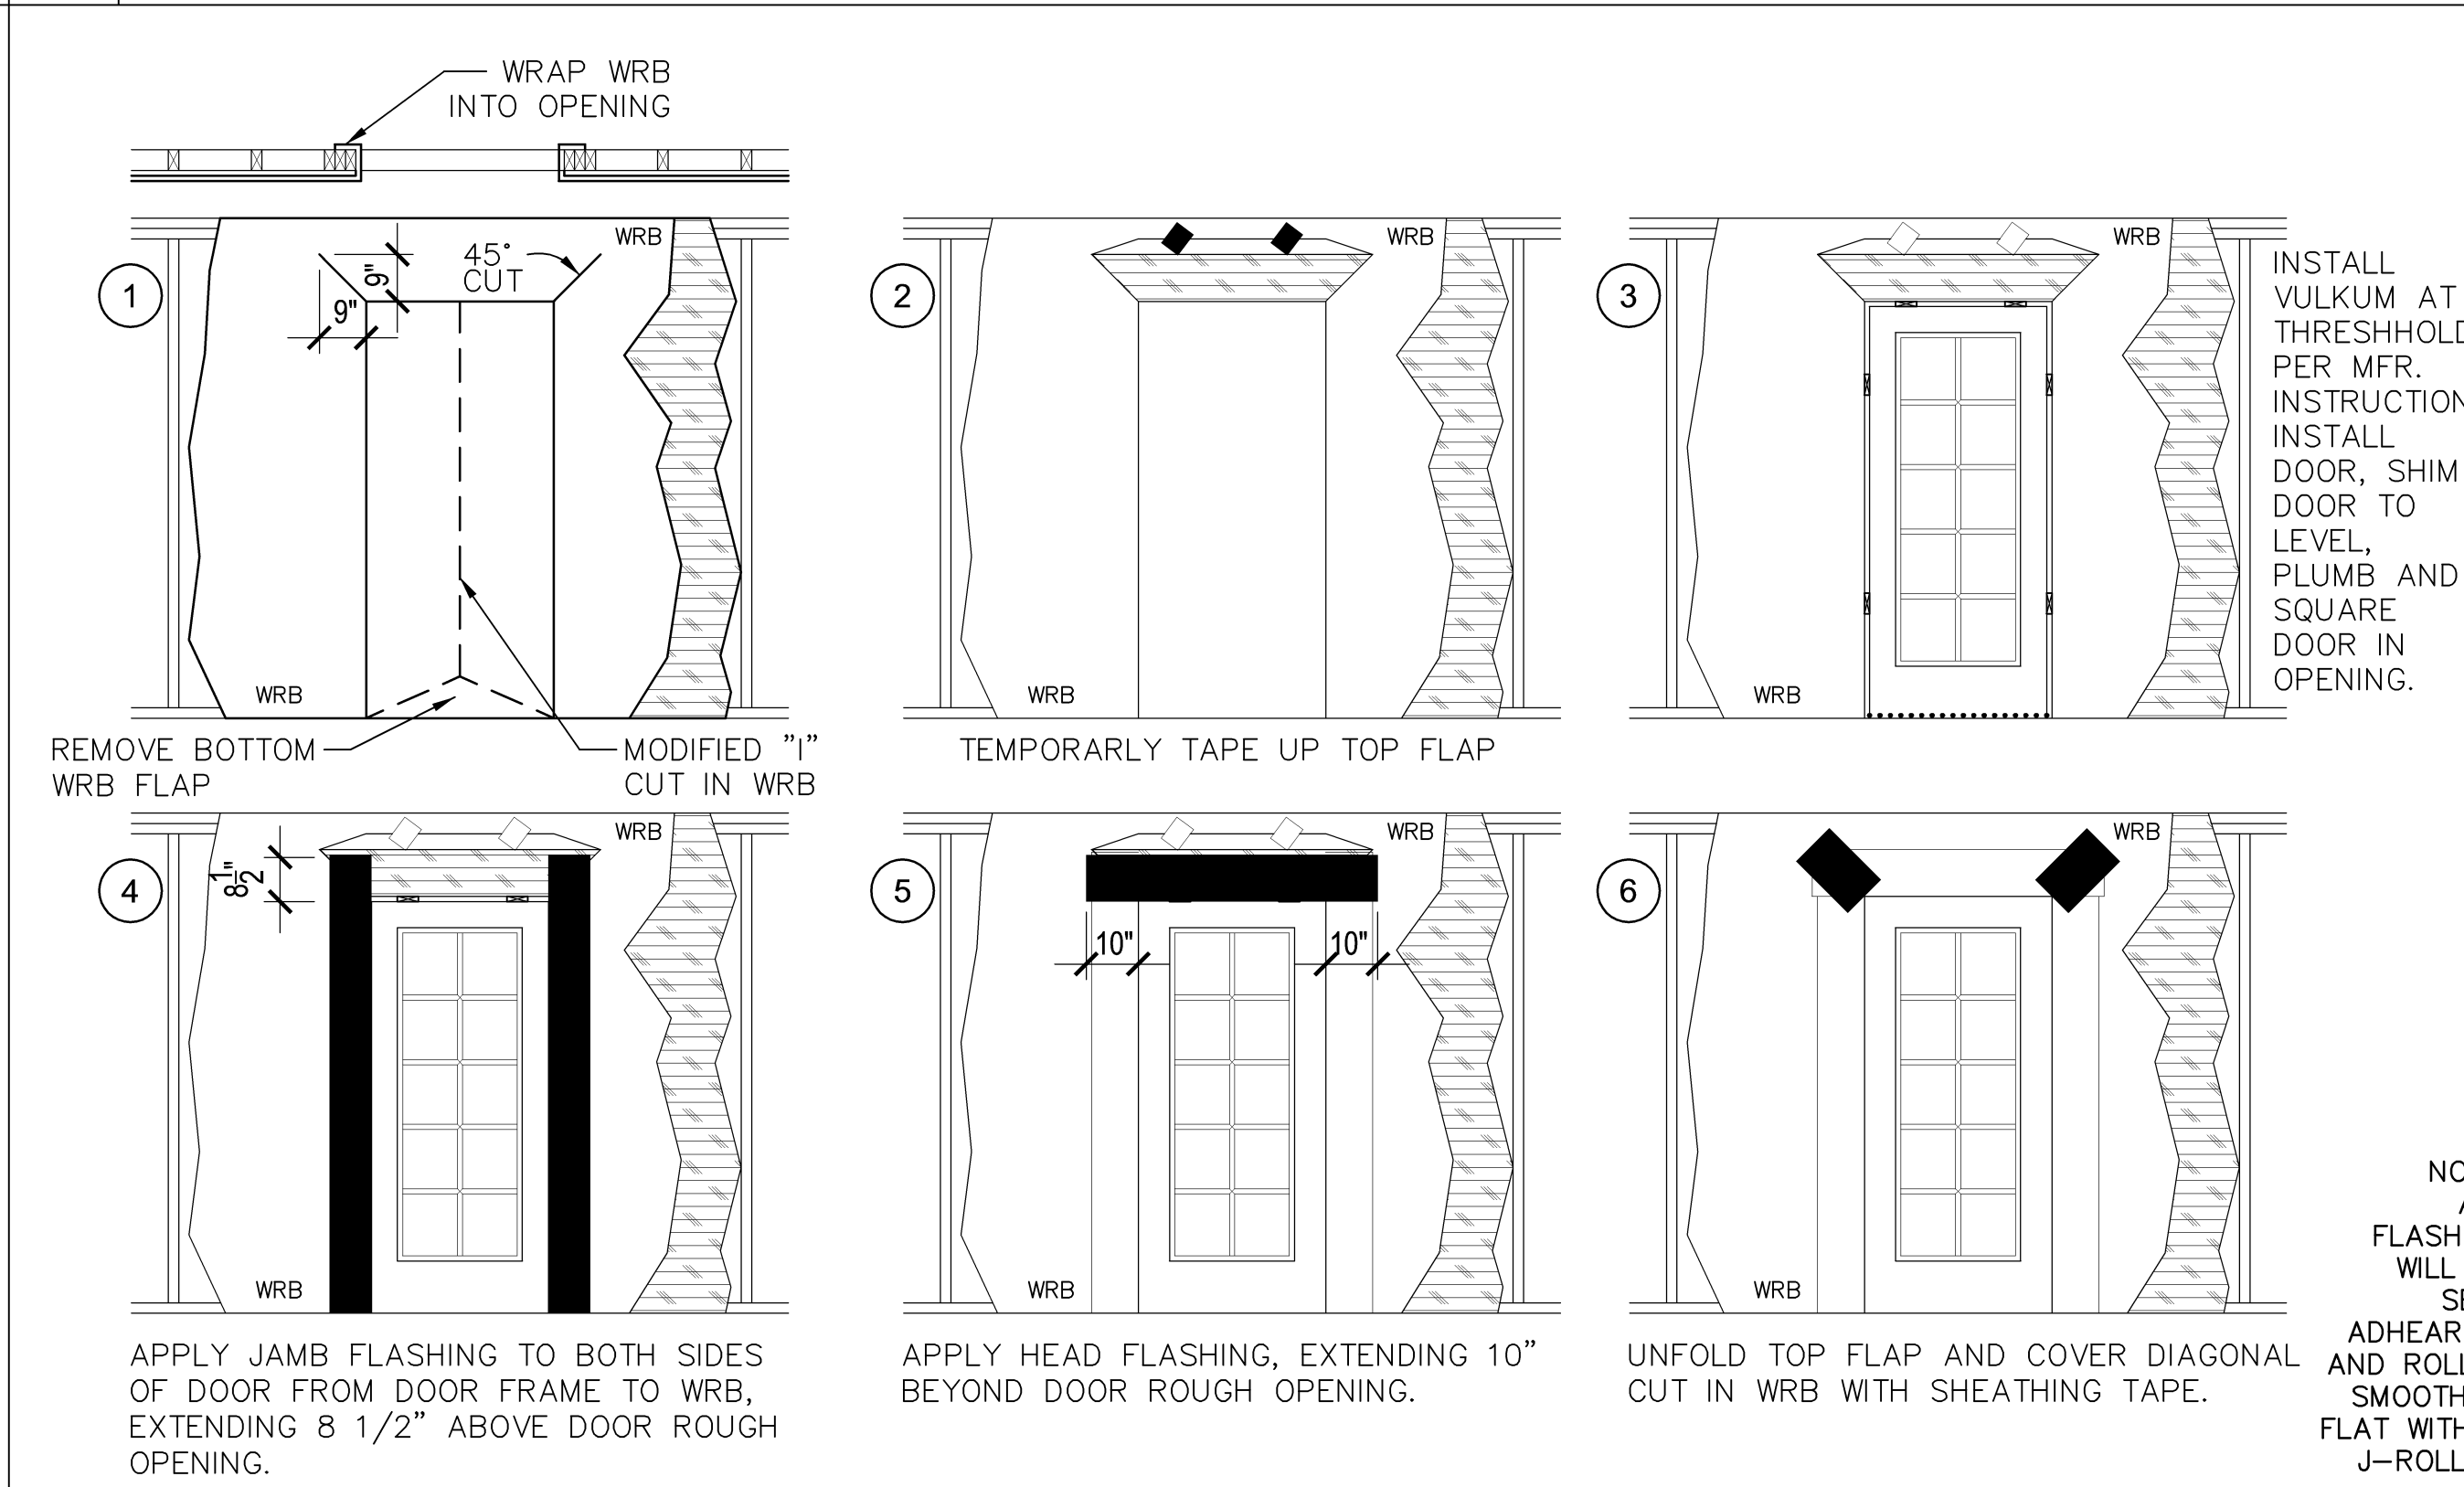

EXTERIOR DOOR FLASHING

SCALE:  
N.T.S.