

## CO COVER AND INDEX SHEET

1.1A	1914 INDIVIDUAL FLOOR PLANS
1.2A	1914 INDIVIDUAL FLOOR PLANS
1.1B	1840 INDIVIDUAL FLOOR PLANS
1.2B	1840 INDIVIDUAL FLOOR PLANS
1.1C	2024 INDIVIDUAL FLOOR PLANS
1.2C	2024 INDIVIDUAL FLOOR PLANS
2.0A	WALL/STAIR SECTIONS
2.0B	WALL/STAIR SECTIONS
2.0C	WALL/STAIR SECTIONS
2.1A	1914 EXTERIOR ELEVATIONS
2.2A	1914 EXTERIOR ELEVATIONS
2.3A	1914 EXTERIOR ELEVATIONS
2.1B	1840 EXTERIOR ELEVATIONS
2.2B	1840 EXTERIOR ELEVATIONS
2.1C	2024 EXTERIOR ELEVATIONS
2.2C	2024 EXTERIOR ELEVATIONS
2.1D	1914 EXTERIOR ELEVATIONS
2.2D	1914 EXTERIOR ELEVATIONS
2.3D	1914 EXTERIOR ELEVATIONS
3.0	4 UNIT / 2-STORY SLAB INTERFACE
3.1	4 UNIT / 2-STORY 1ST FLOOR
3.2	4 UNIT / 2-STORY 2ND FLOOR
3.3	4 UNIT / 2-STORY ELEVATIONS
3.3.1	4 UNIT / 2-STORY ELEVATIONS
3.3.2	4 UNIT / 2-STORY ELEVATIONS
3.4	4 UNIT / 2-STORY ARCH ROOF PLAN
3.5	4 UNIT / 2-STORY ARCH ROOF PLAN
4.1A	1914 ELECTRICAL PLANS
4.2A	1914 ELECTRICAL PLANS
4.1B	1840 ELECTRICAL PLANS
4.2B	1840 ELECTRICAL PLANS
4.1C	2024 ELECTRICAL PLANS
4.2C	2024 ELECTRICAL PLANS
5.1	4 UNIT / 2-STORY FIRE SEPARATION
5.2	4 UNIT / 2-STORY FIRE SEPARATION
6.1	4 UNIT / 2-STORY FIRE SEPARATION
6.2	2-STORY FIRE SEPARATION DETAIL
6.3	2-STORY FIRE SEPARATION DETAIL
6.2	ALTERNATE 2-STORY FIRE SEPARATION
6.3	ALTERNATE 2-STORY FIRE SEPARATION
DT1	FLASHING DETAILS
DT1.1	FLASHING DETAILS
DT3.1	TUB ENCLOSURE DETAILS
DT4	TRIM DETAILS, HB, METER, HVAC, E
DT5	TRIM DETAILS, HB, METER, HVAC, E

S0	NOTES & SCHEDULES
S1.1	FOUNDATION PLAN
S1.2	FOUNDATION PLAN
S2.1	LOW ROOF & FLOOR FRAMING PLAN
S2.2	LOW ROOF & FLOOR FRAMING PLAN
S3	ROOF FRAMING PLAN
L1	LINTEL PLAN
L2	LINTEL CHART & NOTES
SN	NOTES & SCHEDULES
D1	DETAILS
D2	DETAILS
D3	DETAILS
D4	DETAILS
FP	FIRE PROTECTION DETAILS

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1. PENETRATION. PROTECTIVE SLEEVES AROUND PIPING PENETRATING CONCRETE SLAB-ON-GRADE FLOORS SHALL NOT BE OF CELLULOSE CONTAINING MATERIALS. IF SOIL TREATMENT IS USED FOR SUBTERRANEAN TERMITE PROTECTION, THE TREATMENT SHALL BE APPLIED TO THE EXTERIOR OF THE PIPING AND BE SEALED WITHIN THE SLAB USING A NON-CORROSIVE CLAMPING DEVICE TO ELIMINATE THE ANNULAR SPACE BETWEEN THE PIPE AND THE SLEEVE. NO TERMITICIDES SHALL BE APPLIED INSIDE THE SLEEVE.
2. PROTECTION AGAINST DECAY AND TERMITES. - CONDENSATE LINES, IRRIGATION SPRINKLER SYSTEM RISERS FOR SPRAY HEADS, AND ROOF DOWNSPOUTS SHALL BE PROTECTED BY A MINIMUM 150mm (6 INCH) AWAY FROM THE STRUCTURE SIDEWALL, AND BY UNDERGROUND PIPING ALL TENSIONS. ALL SPLASH BASINS, GUTTERS WITH DOWNSPOUTS ARE REQUIRED ON ALL BUILDINGS WITH EAVES OF LESS THAN 6 INCHES (152 mm) HORIZONTAL PROJECTION EXCEPT FOR GABLE END RAKES OR ON A ROOF ABOVE ANOTHER ROOF.

2' OVERHANG U.N.O. / PLUMB CUT FASCIA / ROOF PITCH PER ELEVATION / SHINGLES U.N.O.

ROOF PITCH VARIES PER SUBDIVISIONS IT IS THE CONTRACTORS RESPONSIBILITY TO VERIFY ROOF SLOPE REQUIREMENTS WITH TRUSS MANUFACTURER.

FLASHING SHALL BE INSTALLED AT WALL AND ROOF INTERSECTIONS, AT GUTTERS, AT ALL CHANGES IN ROOF SLOPE OR DIRECTION, AND AT ALL ROOF OPENINGS.

STEP FLASHING SHALL BE USED ON ALL ROOF TO WALL INTERSECTIONS ON RAISED ROOF.

ATTENTION CONTRACTORS: ALL PENETRATIONS THROUGH ROOF ARE TO BE LOCATED ON REAR OR IF NECESSARY ON THE SIDE OF THE ROOF BEHIND THE FRONT FACADE ZONE.

1. WIND RESISTANCE AND ASPHALT SHINGLES - ASPHALT SHINGLES SHALL BE INSTALLED IN ACCORDANCE WITH SECTION 05200 (FLOORHATCH) SECTION 9505.2.6 AND 9505.2.6.1.

2. ASPHALT SHINGLES SHALL ONLY BE USED ON ROOF SLOPES OF 12:12 OR GREATER. THE MINIMUM ROOF SLOPE SHALL BE 12:12 FOR ROOF SLOPES FROM TWO UNITS VERTICAL IN 12 UNITS HORIZONTAL (4:12) AND LESS THAN FOUR UNITS VERTICAL IN 12 UNITS HORIZONTAL (2:12). TWO LAYERS OF UNDERLAYMENT COMPLYING WITH ASTM D226 TYPE II SHALL BE REQUIRED FOR ROOF SLOPES OF 12:12 OR GREATER. TWO LAYERS OF UNDERLAYMENT COMPLYING WITH ASTM D226 TYPE II SHALL BE REQUIRED IN ACCORDANCE WITH SECTION 9505.1.1.

3. FOR ROOF SLOPES FROM FOUR UNITS VERTICAL IN 12 UNITS HORIZONTAL (4:12) TO 12:12, ONE LAYER OF UNDERLAYMENT COMPLYING WITH ASTM D226 TYPE II, ASTM D4876, TYPE III OR IV OR ASTM D6757 IS REQUIRED IN ACCORDANCE WITH SECTION 9505.1.1.

4. HAS AN ALTERNATE METHOD, THE ENGINEER'S ROOF DESIGN SHALL BE DESIGNED WITH AN APPROVED SHINGLE OR APPROVED MODIFIED BITUMEN UNDERLAYMENT COMPLYING WITH ASTM D1979 OR AN APPROVED SELF-ADHERING SYNTHETIC UNDERLAYMENT COMPLYING WITH ASTM D1979. THE MANUFACTURER'S INSTALLATION INSTRUCTIONS REFER TO 9505.1.1.

PER FCBR 2020 7TH EDITION R905.3, THE INSTALLATION OF CLAY AND CONCRETE TILE AND REQUIRED UNDERLAYMENT SHALL BE IN ACCORDANCE WITH THE INSTRUCTIONS, RECOMMENDATIONS OF FRASATI FLORIDA HIGH WIND CONCRETE AND CLAY ROOF TILE INSTALLATION MANUAL, SIXTH EDITION WHERE THE VASD IS DETERMINED IN ACCORDANCE WITH SECTION R301.2.1.3 OR THE RECOMMENDATIONS OF RAS 118, 119 OR 120. PER FCBR 2020 7TH EDITION R905.3.3, THE REQUIRED UNDERLAYMENT SHALL COMPLY WITH THE MANUFACTURERS RECOMMENDATIONS IN ACCORDANCE WITH THE FRASATI FLORIDA HIGH WIND CONCRETE AND CLAY ROOF TILE INSTALLATION MANUAL, SIXTH EDITION WHERE THE VASD IS DETERMINED IN ACCORDANCE WITH SECTION R301.2.1.3 OR THE RECOMMENDATIONS OF RAS 118, 119 OR 120.

LATH AND LATH ATTACHMENTS SHALL BE OF CORROSION-RESISTANT MATERIALS. EXPANDED METAL OR WOVEN WIRE LATH SHALL BE ATTACHED WITH 1 1/2-INCH-LONG (38 MM), 11 GAGE NAILS HAVING A 7/16-INCH (11.1 MM) HEAD, OR 1 1/2-INCH-LONG (22.2 MM), 16 GAGE STAPLES, SPACED AT IN ACCORDANCE WITH ASTM C1063 OR C1787, OR AS OTHERWISE APPROVED.

PLASTERING WITH CEMENT PLASTER SHALL BE NOT LESS THAN THREE COATS WHERE APPLIED OVER ANY TYPE OF CODE-APPROVED LATH AND SHALL BE NOT LESS THAN TWO COATS WHERE DIRECTLY APPLIED OVER MASONRY, CONCRETE, CLAY, BRICK, STONE OR TILE. IF THE PLASTER SURFACE IS COMPLETELY COVERED BY VENEER OR OTHER FACING MATERIAL OR IS COMPLETELY CONCEALED, PLASTER APPLICATION NEED BE ONLY TWO COATS, PROVIDED THE TOTAL THICKNESS IS AS SET FORTH IN TABLE R702.1(1).

SYSTEM, EXTERIOR PLASTER SHALL BE APPLIED TO COVER, BUT NOT EXTEND BELOW, LATH, PAPER AND SCREED. CEMENT PLASTER SHALL BE IN ACCORDANCE WITH ASTM C926. CEMENT MATERIALS SHALL BE IN ACCORDANCE WITH ONE OF THE FOLLOWING:

5. PLASTER (STUCCO) CEMENT CONFORMING TO ASTM C1328  
THE PROPORTION OF AGGREGATE TO CEMENTITIOUS MATERIALS SHALL  
BE AS SET FORTH IN TABLE R702.1(3).

A MINIMUM 0.019-INCH (0.5 MM) (NO. 26 GALVANIZED SHEET GAGE), CORROSION-RESISTANT WEEP SCREED OR PLASTIC WEEP SCREED, WITH A MINIMUM VERTICAL ATTACHMENT FLANGE OF 3 1/2 INCHES (89 MM) SHALL BE PROVIDED AT OR BELOW THE FOUNDATION PLATE LINE ON EXTERIOR STUD WALLS IN ACCORDANCE WITH ASTM C266. THE WEEP SCREED SHALL BE PLACED NOT LESS THAN 4 INCHES (102 MM) ABOVE THE EARTH OR 2 INCHES (51 MM) ABOVE PAVED AREAS AND SHALL BE OF A TYPE THAT WILL ALLOW TRAPPED WATER TO DRAIN TO THE EXTERIOR OF THE BUILDING. THE WEATHER-RESISTANT BARRIER SHALL LAP THE ATTACHMENT FLANGE. THE EXTERIOR LATH SHALL COVER AND TERMINATE ON THE ATTACHMENT FLANGE OF THE WEEP SCREED.

WATER-RESISTIVE BARRIERS SHALL BE INSTALLED AS REQUIRED IN SECTION R703.2 AND, WHERE APPLIED OVER WOOD-BASED SHEATHING, SHALL INCLUDE A WATER-RESISTIVE VAPOR-PERMEABLE BARRIER WITH A PERFORMANCE AT LEAST EQUIVALENT TO TWO LAYERS OF GRADE D PAPER. THE INDIVIDUAL LAYERS SHALL BE INSTALLED INDEPENDENTLY SUCH THAT EACH LAYER PROVIDES A SEPARATE CONTINUOUS PLANE AND ANY FLASHING (INSTALLED IN ACCORDANCE WITH SECTION R703.4) INTENDED TO DRAIN TO THE WATER-RESISTIVE BARRIER IS DIRECTED BETWEEN THE LAYERS.

## REVISION LOG

[illegible]

1. MISCELLANEOUS:

- a. PLANS ARE TO SCALE AS NOTED, UNLESS SPECIFIED N.T.S.
- b. DO NOT SCALE PLANS.
- c. ALL DIMENSIONS AND SITUATIONS PERTAINING TO THE BUILDING ARE TO BE VERIFIED PRIOR TO BEGINNING OF CONSTRUCTION. NOTIFY B & A DESIGN STUDIO, INC. OF ANY DISCREPANCIES.
- d. ALL WALL THICKNESS DIMENSIONS AS SHOWN ARE NOMINAL. ACTUAL WALL THICKNESS DIMENSIONS MAY BE +/- OR -.

2. EXTERIOR WALLS:

- a. ASSUME ALL EXTERIOR WALLS TO BE LOAD BEARING.
- b. SEE FOUNDATION PLAN FOR CMU WALL REINFORCEMENT LOCATIONS.
- c. INTERIOR SURFACE OF CMU WALL TO HAVE 1/2" GPBD APPLIED TO 1x P.T. VERTICAL FURRING BATTS SPACED @ 16" O.C. ATTACH FURRING TO CONCRETE WALLS AS REQUIRED.
- d. SECOND FLOOR EXTERIOR WALLS TO BE WOOD STUDS.

3. INTERIOR WALLS:

- a. WOOD FRAMING:
  - i. ALL PLATES AND SLEEPERS ON CONCRETE SLAB, WHICH ARE IN DIRECT CONTACT WITH THE EARTH, SHALL BE PRESSURE TREATED.
  - ii. ALL INTERIOR WALL PLATES, OTHER THAN SHEAR WALLS, ON CONCRETE SLAB TO BE ATTACHED WITH POWER ACTUATED FASTENERS, SPACED @ 48" O.C. MAX.
  - iii. ALL WOOD BRG. INTERIOR PARTITIONS SHALL BE 2x4 STUDS SPACED @ 16" O.C. WITH DOUBLE TOP PLATE.

4. TOWNHOMES

- a. FLOORING: DRAFTSTOPPING TO BE PROVIDED IN THE FLOOR/CEILING ASSEMBLIES ABOVE AND IN LINE WITH THE TENANT SEPARATION, WHEN TENANT SEPARATION WALLS DO NOT EXTEND TO THE FLOOR SHEATHING ABOVE AND IN OTHER LOCATIONS PER SECTION R602.8 / R302.11 OF THE 2020 FBCR 7TH EDITION.

4. WOOD:

- a. WOOD CONSTRUCTION SHALL CONFORM TO THE AMERICAN FOREST & PAPER ASSOCIATION (AF&PA) "NATURAL SPECIFICATION FOR WOOD CONSTRUCTION" LATEST EDITION.
- b. ALL WOOD IN CONTACT WITH CONCRETE OR CONCRETE BLOCK IS TO BE PRESSURE TREATED.
- c. SEE STRUCTURAL GENERAL NOTES.

h. 2020 FBCR 7TH EDITION TABLE R302.6: 5/8" TYPE "X" GYPSUM BOARD OR EQUIVALENT IS REQUIRED IN GARAGE CEILING WITH HABITABLE ROOMS ABOVE. 1/2" MINIMUM GYPSUM BOARD IS REQUIRED ON GARAGE SIDE OF INTERIOR WALLS.

6. CABINETS:

a. CABINET MANUFACTURER'S SHOP DRAWINGS TAKE PRECEDENCE OVER THE INTERIOR CABINET ELEVATIONS SHOWN ON THESE DRAWINGS.

b. SEE SUPPLIER / MFR'S DRAWINGS FOR KITCHEN, CABINETRY/MILLWORK, AND RESTROOM LAYOUTS

8. WINDOW & DOORS:

- ii. CONTRACTOR AND SUPPLIER TO VERIFY WINDOW LOCATION, TYPE (FIN vs. FLANGE), HEADER HEIGHTS AND ROUGH OPENINGS PRIOR TO DELIVERY.
- iii. WINDOW ROUGH OPENING INCLUDES 1x P.T. FRAME ATTACHED TO CMU's.

vii. ALL WINDOWS IN WIND BORN DEBRIS AREAS SHALL BE PROTECTED FROM WIND BORN DEBRIS. PROVIDE SHUTTERS CERTIFIED TO

TO INCLUDE A 10 SECOND GUST AT 1.5 TIMES THE DESIGN PRESSURE AND BEAR A PERMANENT DESIGN LABEL

ii. ALL WINDOW HEADS SHALL BE SET ABOVE FINISH FLOOR AS FOLLOWS:

1. FIRST FLOOR AT 8'-0".
2. SECOND FLOOR PER PLAN.

ii. INTERIOR FACE OF WINDOW, FASTEN BUCK TO MASONRY W/  $\frac{1}{4}$ "x 3" TAPCONS, 6" FROM EDGES AND 16" O.C. MAX. 2x P.T. BUCKS/NAILERS SHALL EXTEND BEYOND.

iii. BUCKS LESS THAN 2x TO BE FASTENED W/ CUT NAILS OR EQUIVALENT. STRUCTURAL CONNECTION

I. EXTERIOR WINDOWS AND SLIDING DOORS SHALL BE TESTED AND COMPLY WITH AAMA/WDMA/CSA 101/I.S.2/A440 OR TAS 202 (HVHZ SHALL COMPLY WITH TAS 202 AND ASTM E1300). EXTERIOR SIDE HINGED DOORS SHALL COMPLY WITH AAMA/WDMA/CSA 101/I.S.2/A440 OR ANSI/WMA100 OR

9. INSULATION:

- a. INSULATE ALL EXTERIOR FRAME WALLS WITH R-13 BATT FIBERGLASS INSULATION.
- b. INSULATE CONDITIONED ATTIC SPACE WITH R-38 BLOWN FIBERGLASS. INACCESSIBLE ATTIC SPACE

- i. WINDOW FRAMES
- ii. EXTERIOR DOOR FRAMES
- iii. GAPS AROUND PIPES, VENTS, OUTLETS, ETC.

4. HYDRAULIC CEMENT CONFORMING TO ASTM C150 OR MH.

**R703.7.2.1 WEEP SCREEDS.**  
A MINIMUM 0.019-INCH (0.5 MM) (NO. 26 GALVANIZED SHEET GAGE),  
CORROSION-RESISTANT WEEP SCREED OR PLASTIC WEEP SCREED.

ABOVE THE EARTH OR 2 INCHES (51 MM) ABOVE PAVED AREAS AND SHALL BE OF A TYPE THAT WILL ALLOW TRAPPED WATER TO DRAIN TO THE EXTERIOR OF THE BUILDING. THE WEATHER-RESISTANT BARRIER SHALL LAP THE ATTACHMENT FLANGE. THE EXTERIOR LATH SHALL COVER AND TERMINATE ON THE ATTACHMENT FLANGE OF THE WEEP SCREED.

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FDS JOB NO.:

PARK SQUARE  
HORIZONS WEST  
BABCOCK RANCH BLDG 6 (LOTS 6092-6089) 4 UNIT

title:  
**COVER**  
**4-UNIT TOWNHOME**


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checked:  
drawn: BA  
date: 04-12-23  
scale: AS SHOWN

CO

The structural design of this building is in accordance with the FLORIDA BUILDING CODE 7TH EDITION (2020) RESIDENTIAL and is certified as such.


NOTE: DRAWINGS ON 11"x17" SHEET WILL BE ONE HALF THE SCALE NOTED

UNIT 6092	1914 ADAMS REVERSED
UNIT 6089	1914 ADAMS

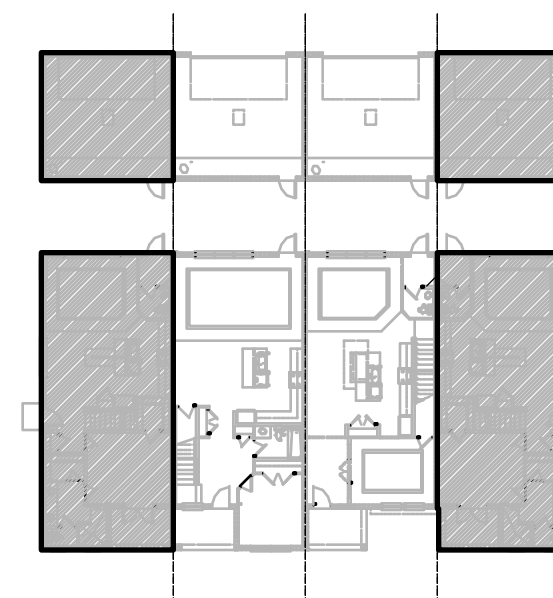


## 1ST FLOOR - KEY PLAN

1/32" = 1'-0"

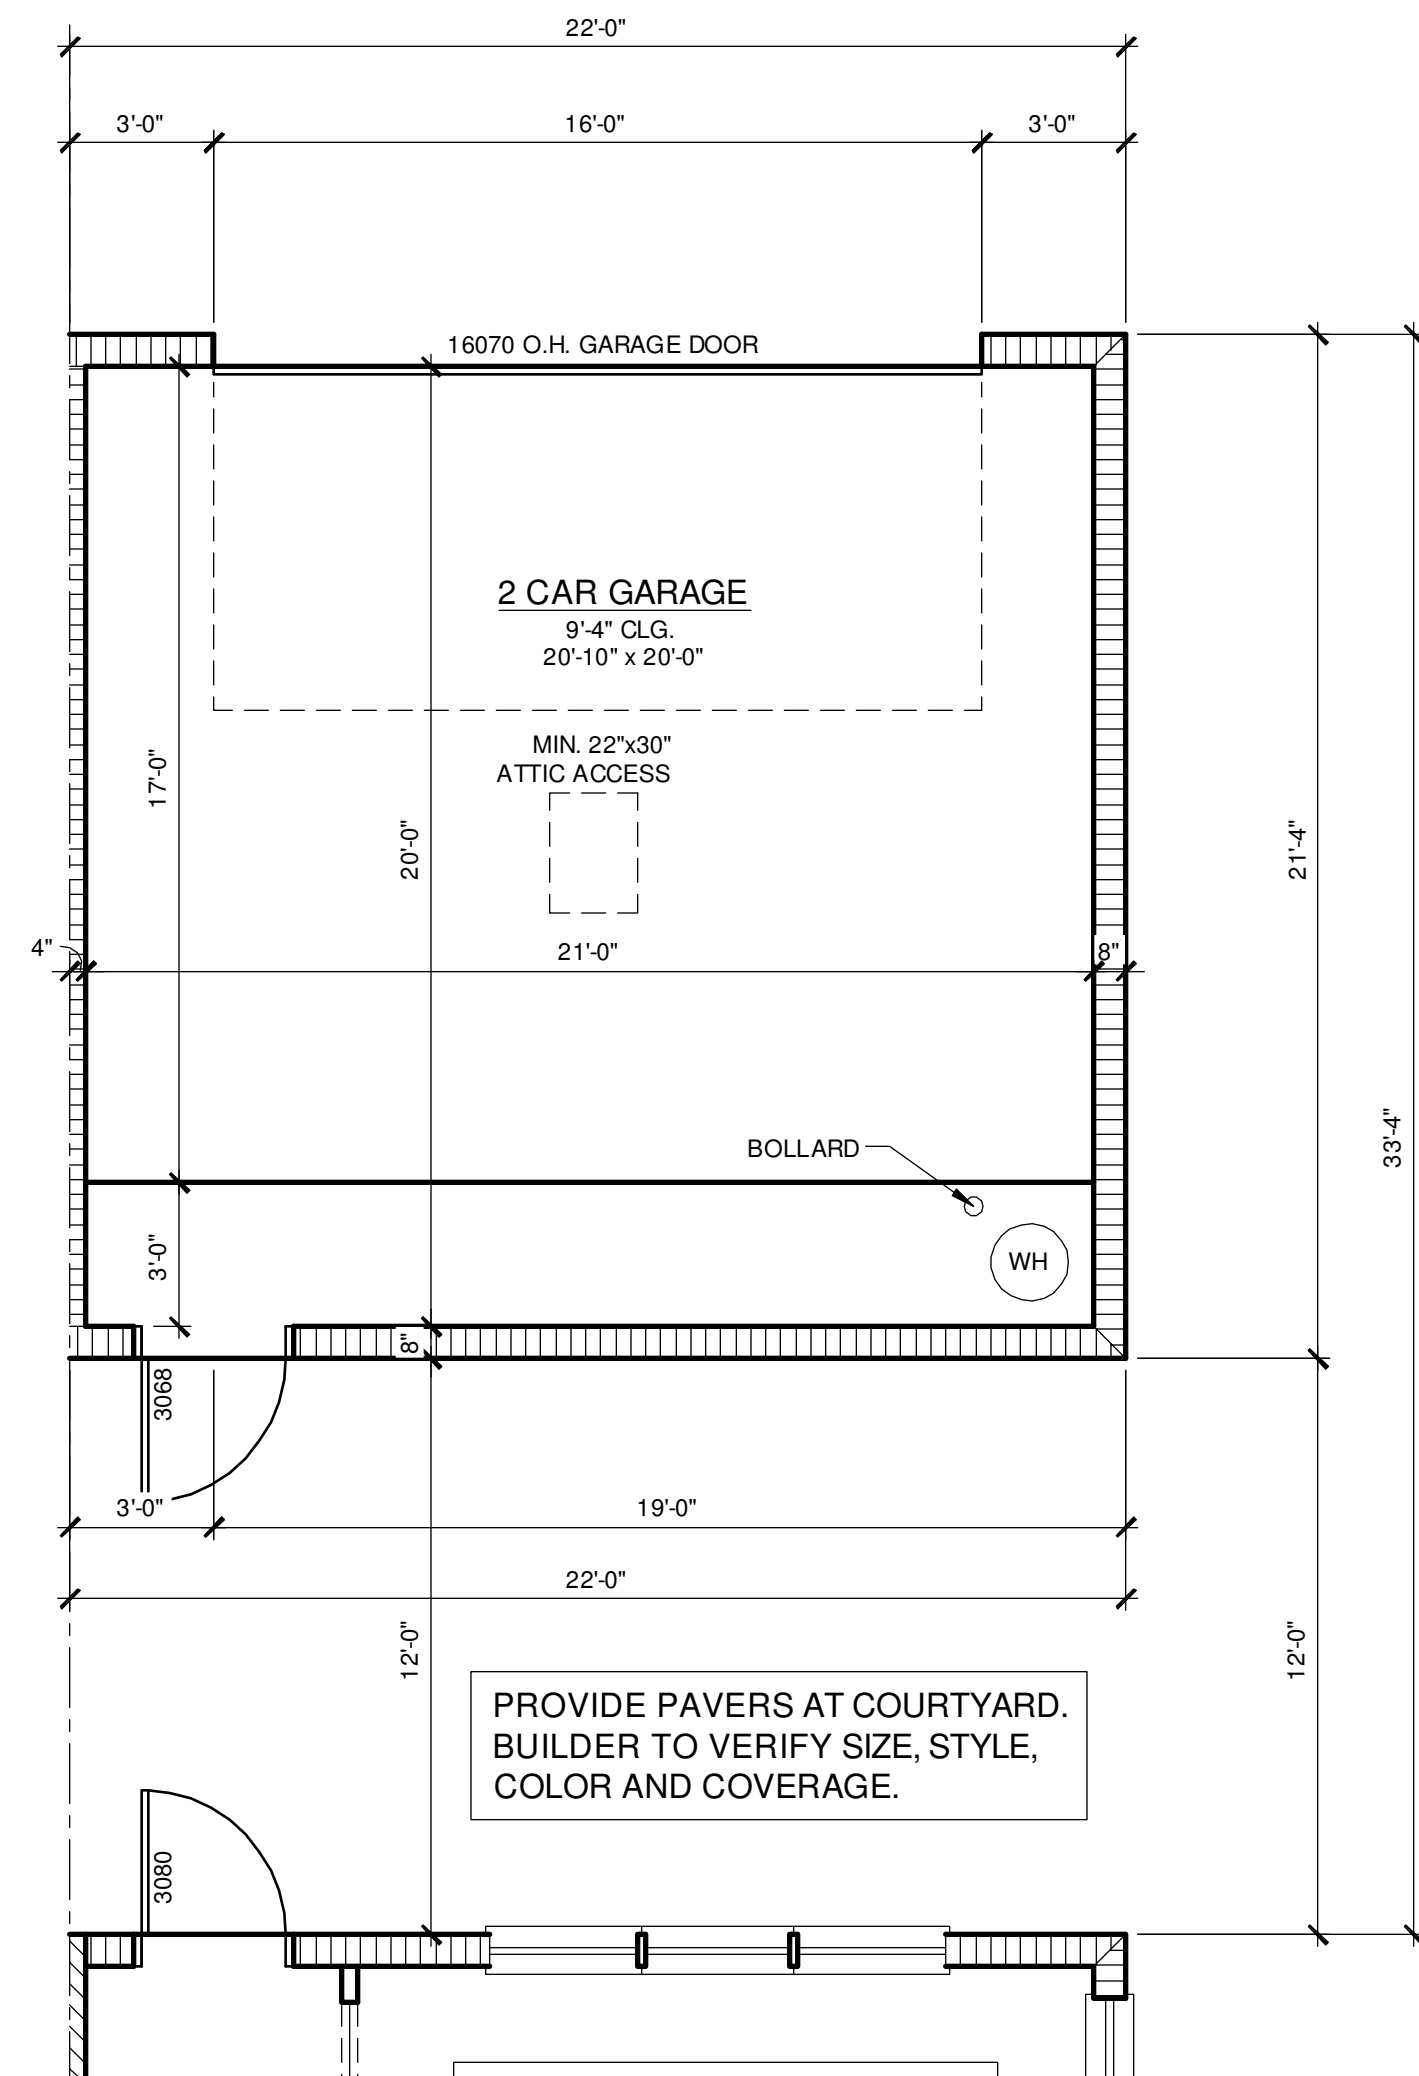


## 1914 - ADAMS 1ST FLOOR PLAN - GARAGE

1/4" = 1'-0"

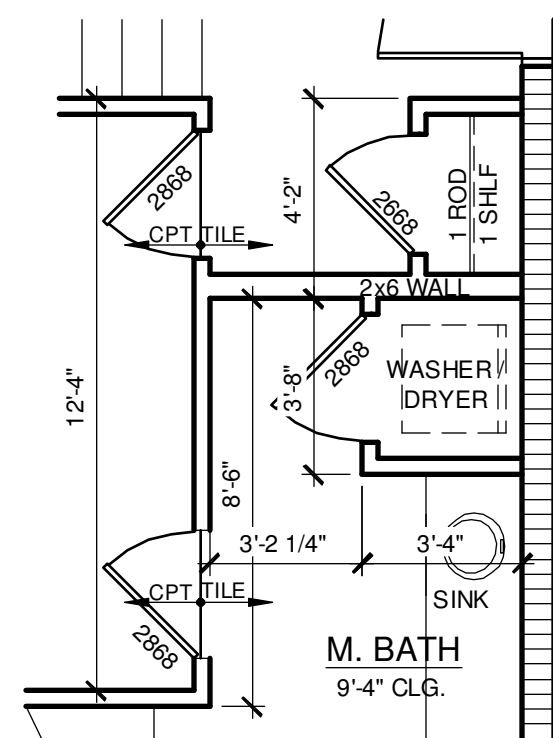

## OPT WASHER/DRYER


1/4" = 1'-0"

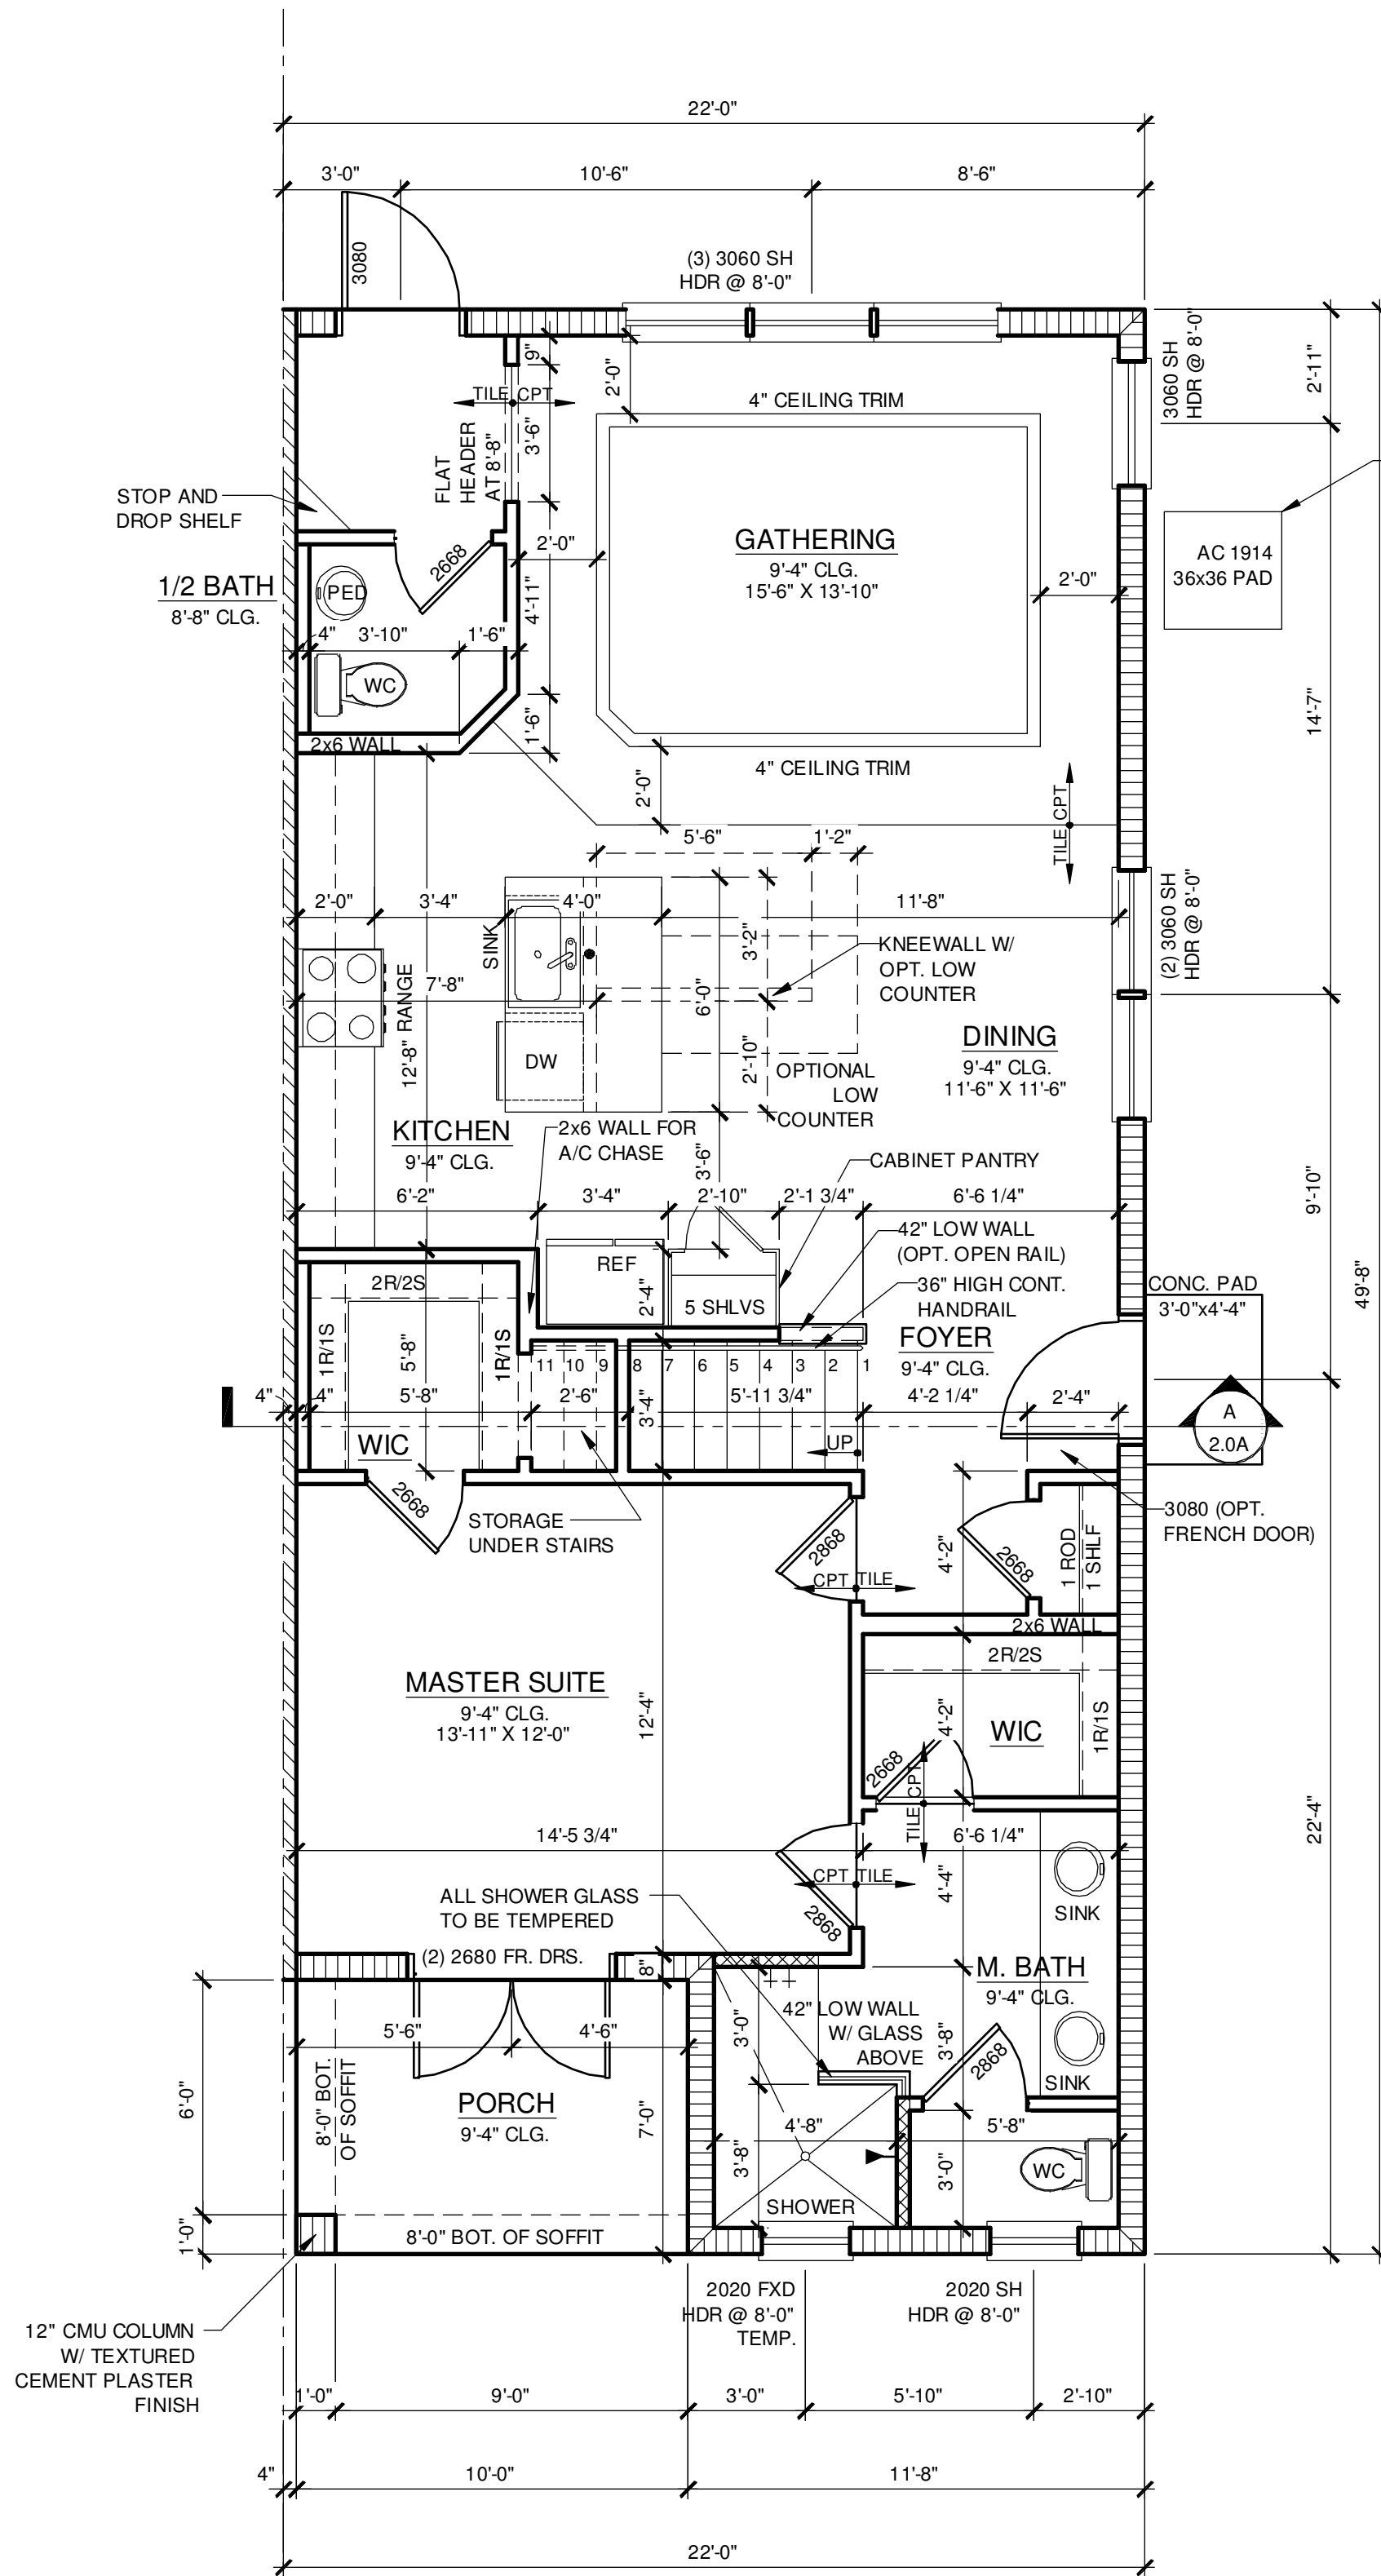

## 1914 - ADAMS 1ST FLOOR PLAN ELEVATION "A"

1/4" = 1'-0"

RIGHT END UNIT

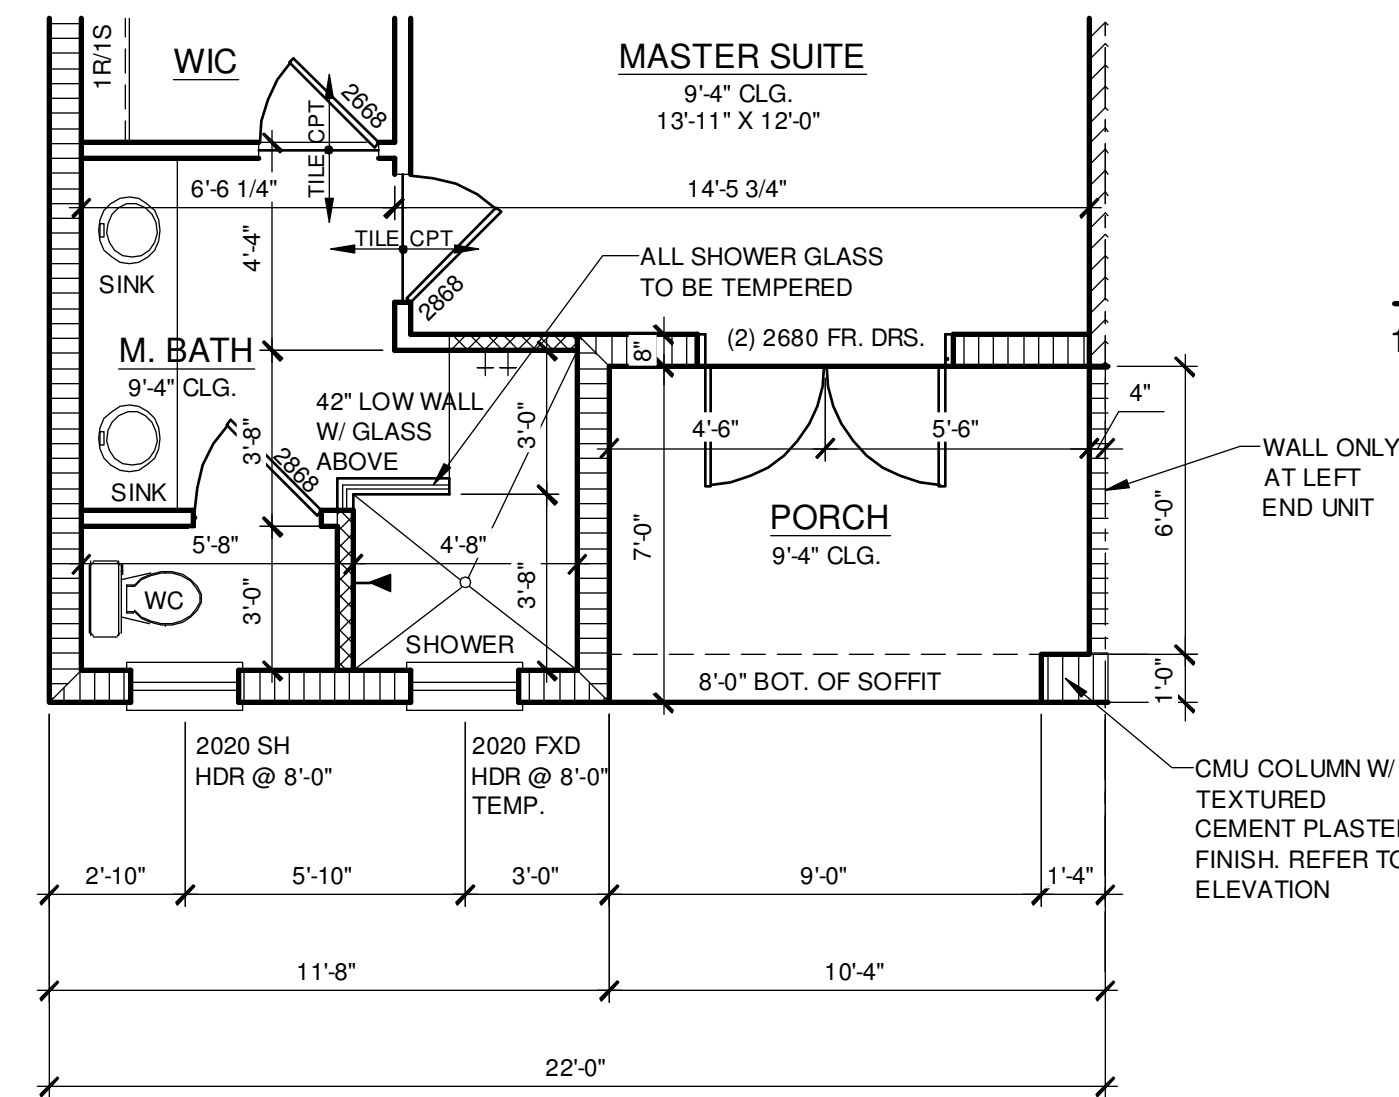

## 1914 - ADAMS REVERSED 1ST FLOOR PLAN ELEVATION "A"

1/4" = 1'-0"

LEFT END UNIT

SEE LEFT END UNIT FOR ALL  
OTHER INFORMATION

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BUILDING DESIGN

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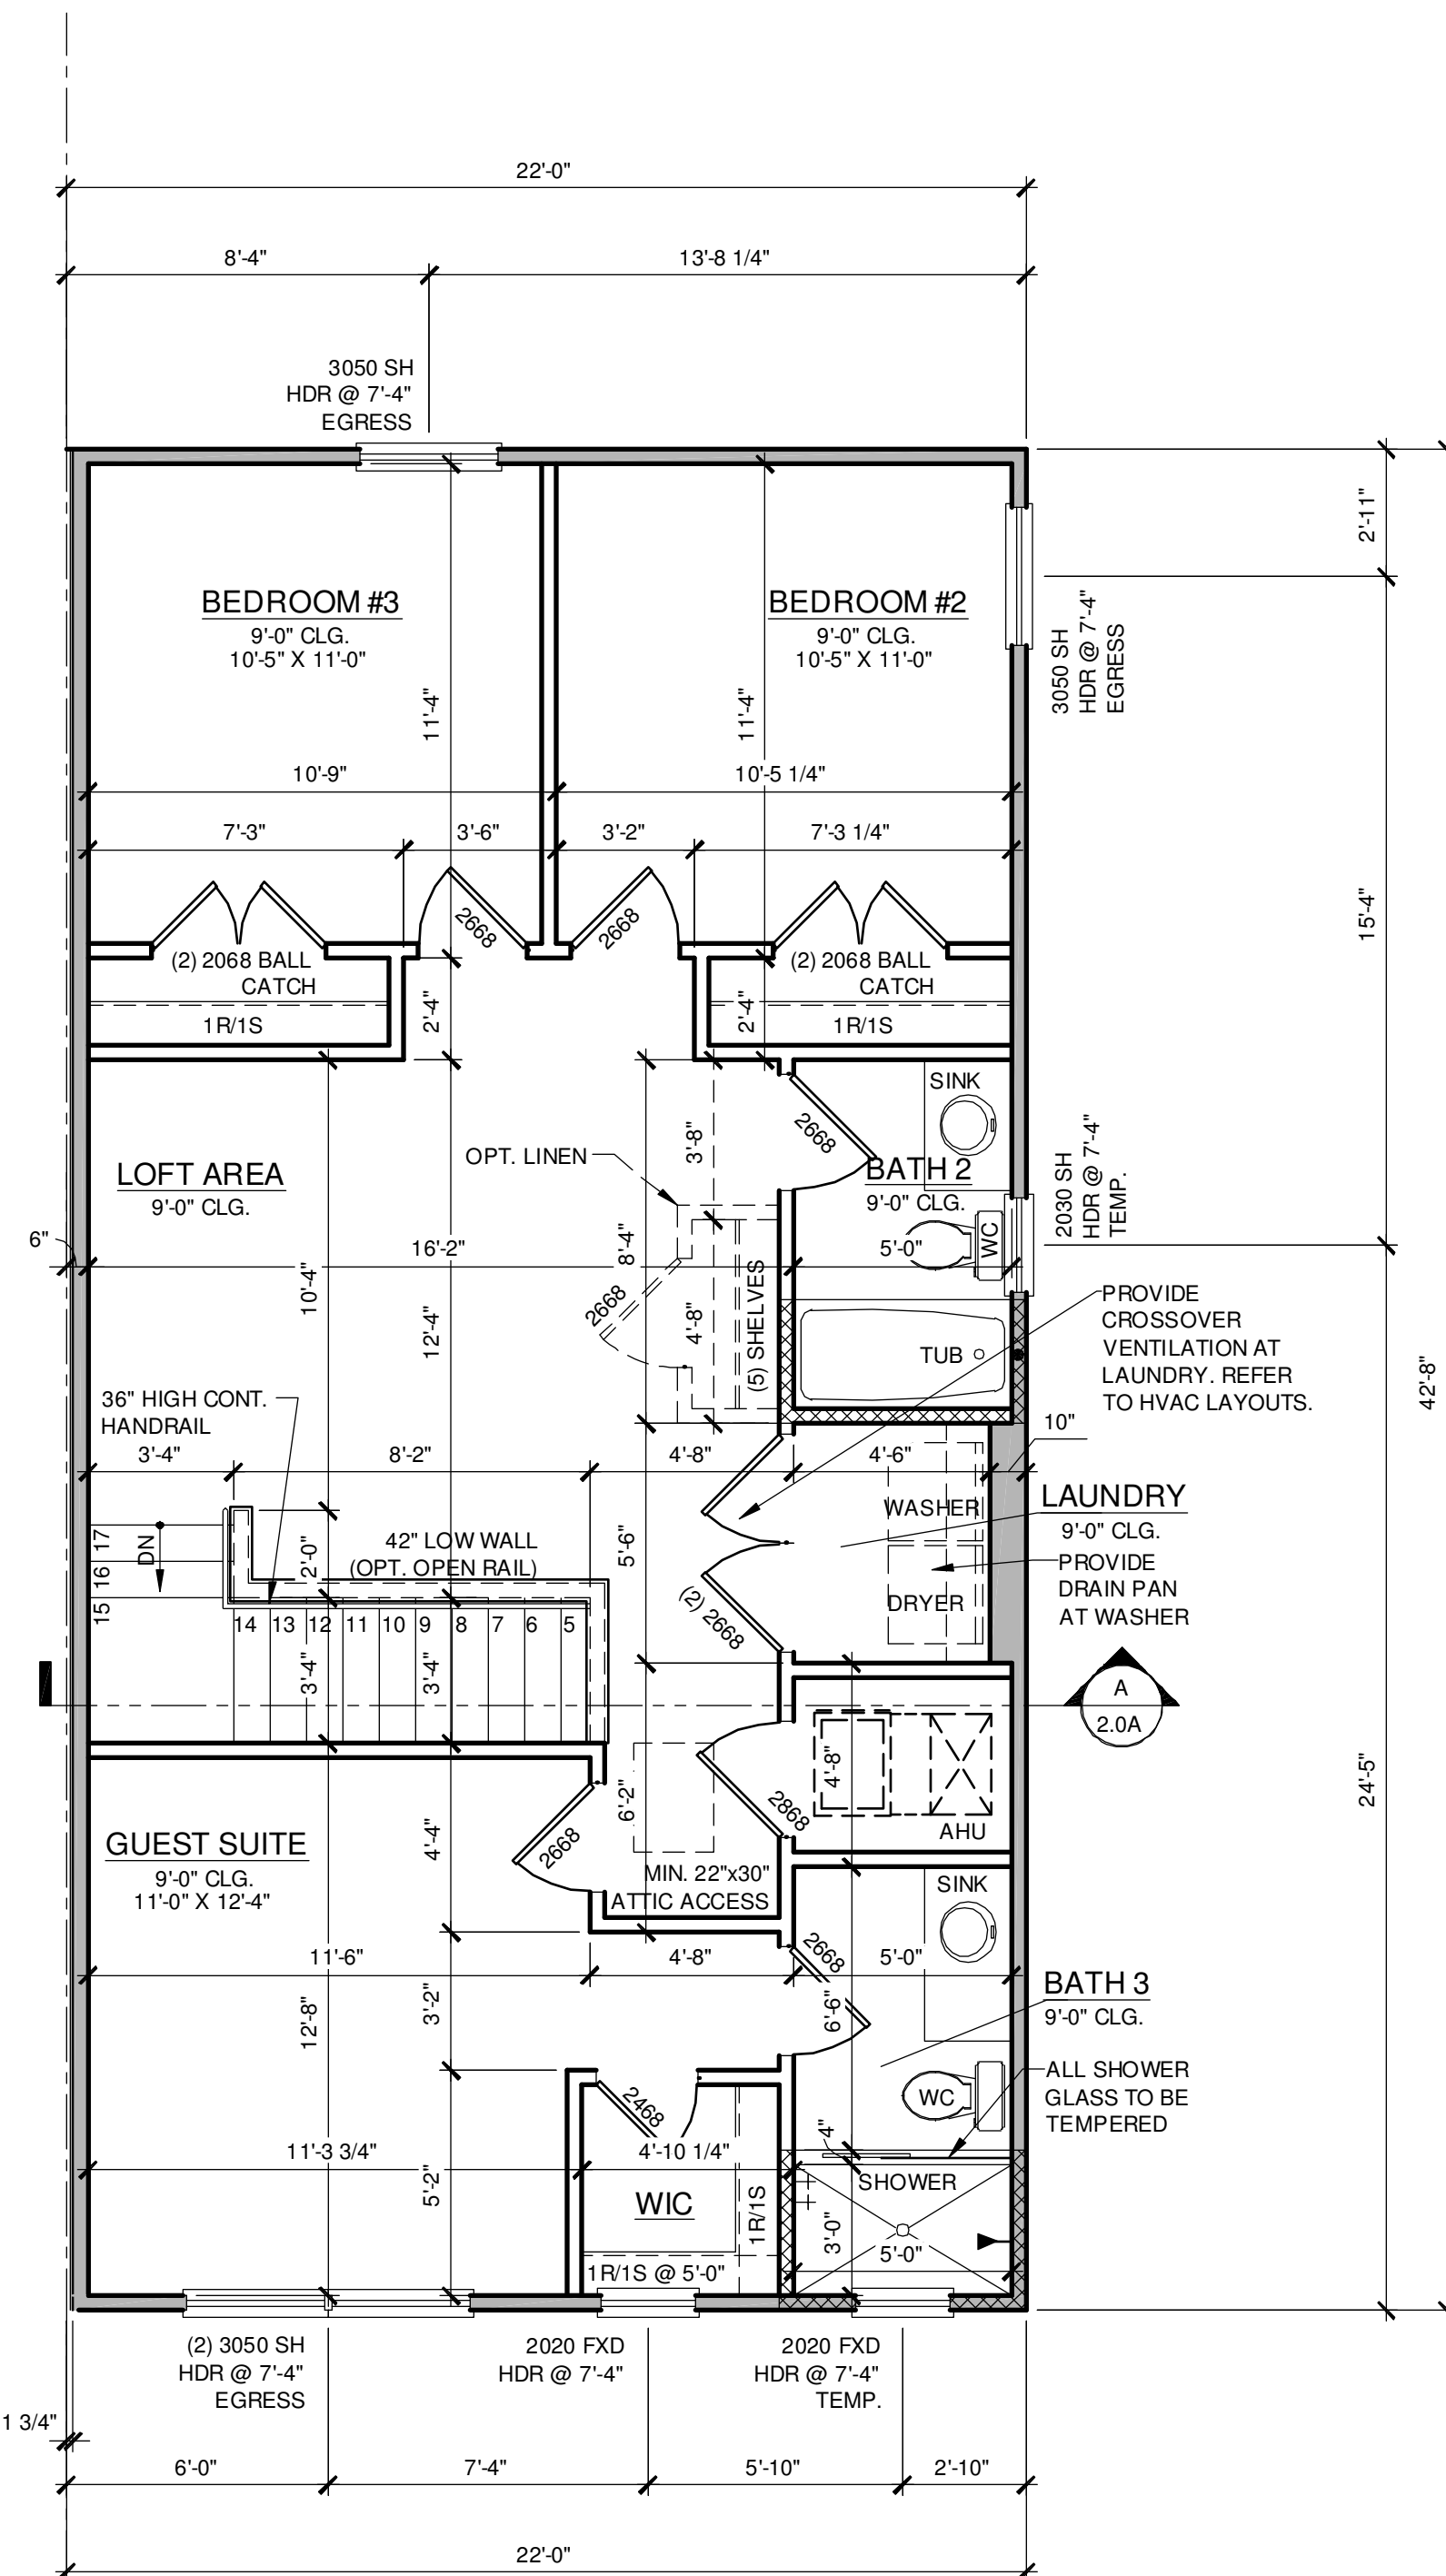
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1914 - ADAMS  
2ND FLOOR PLAN ELEVATION "A"

1/4" = 1'-0"

LAYOUT REVERSED FOR  
RIGHT END UNIT

UNIT 6092	1914 ADAMS REVERSED
UNIT 6089	1914 ADAMS



2ND FLOOR - KEY PLAN


1/32" = 1'-0"

1914 - ADAMS  
AREA CALCULATIONS

1st FLR. LIVING	1,021 SQ. FT.
2ND FLR. LIVING	893 SQ. FT.
TOTAL LIVING	1,914 SQ. FT.
GARAGE	470 SQ. FT.
FRONT PORCH	70 SQ. FT.
TOTAL UR	2,454 SQ. FT.

WALL LEGEND

- INDICATES 8x8x16 (NOM.) C.M.U. (EXTERIOR LOAD BEARING ), 9'-4" TOP OF CMU
- INDICATES 8x8x16 (NOM.) C.M.U. (EXTERIOR LOAD BEARING ), 10'-8" TOP OF CMU
- INDICATES 8x8x16 (NOM.) C.M.U. (EXTERIOR LOAD BEARING ), 10'-8" TOP OF CMU
- INDICATES WALLS TO BE UTILIZED FOR TRUSS BEARING 2x4 WOOD STUDS @ 16" O.C. U.N.O.
- INDICATES 2X WOOD PARTITIONS. (NON LOAD BEARING INTERIOR PARTITIONS ONLY.) (U.N.O.)
- INDICATES WET WALLS, 2X WOOD STUDS @ 12" O.C.
- INDICATES INSULATED WALLS

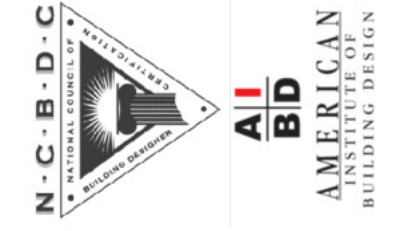

FDS JOB NO.:


PARK SQUARE  
HORIZONS WEST  
BABCOCK RANCH BLDG 6 (LOTS 6092-6089) 4 UNIT

Title:  
1914 - ADAMS  
FLOOR PLAN

project no. 2023083  
checked: BF  
drawn: BA  
date: 04-12-23  
scale: AS SHOWN

1.2A  
ELEV. A

NOTE: DRAWINGS ON 11"x17" SHEET WILL BE ONE HALF THE SCALE NOTED


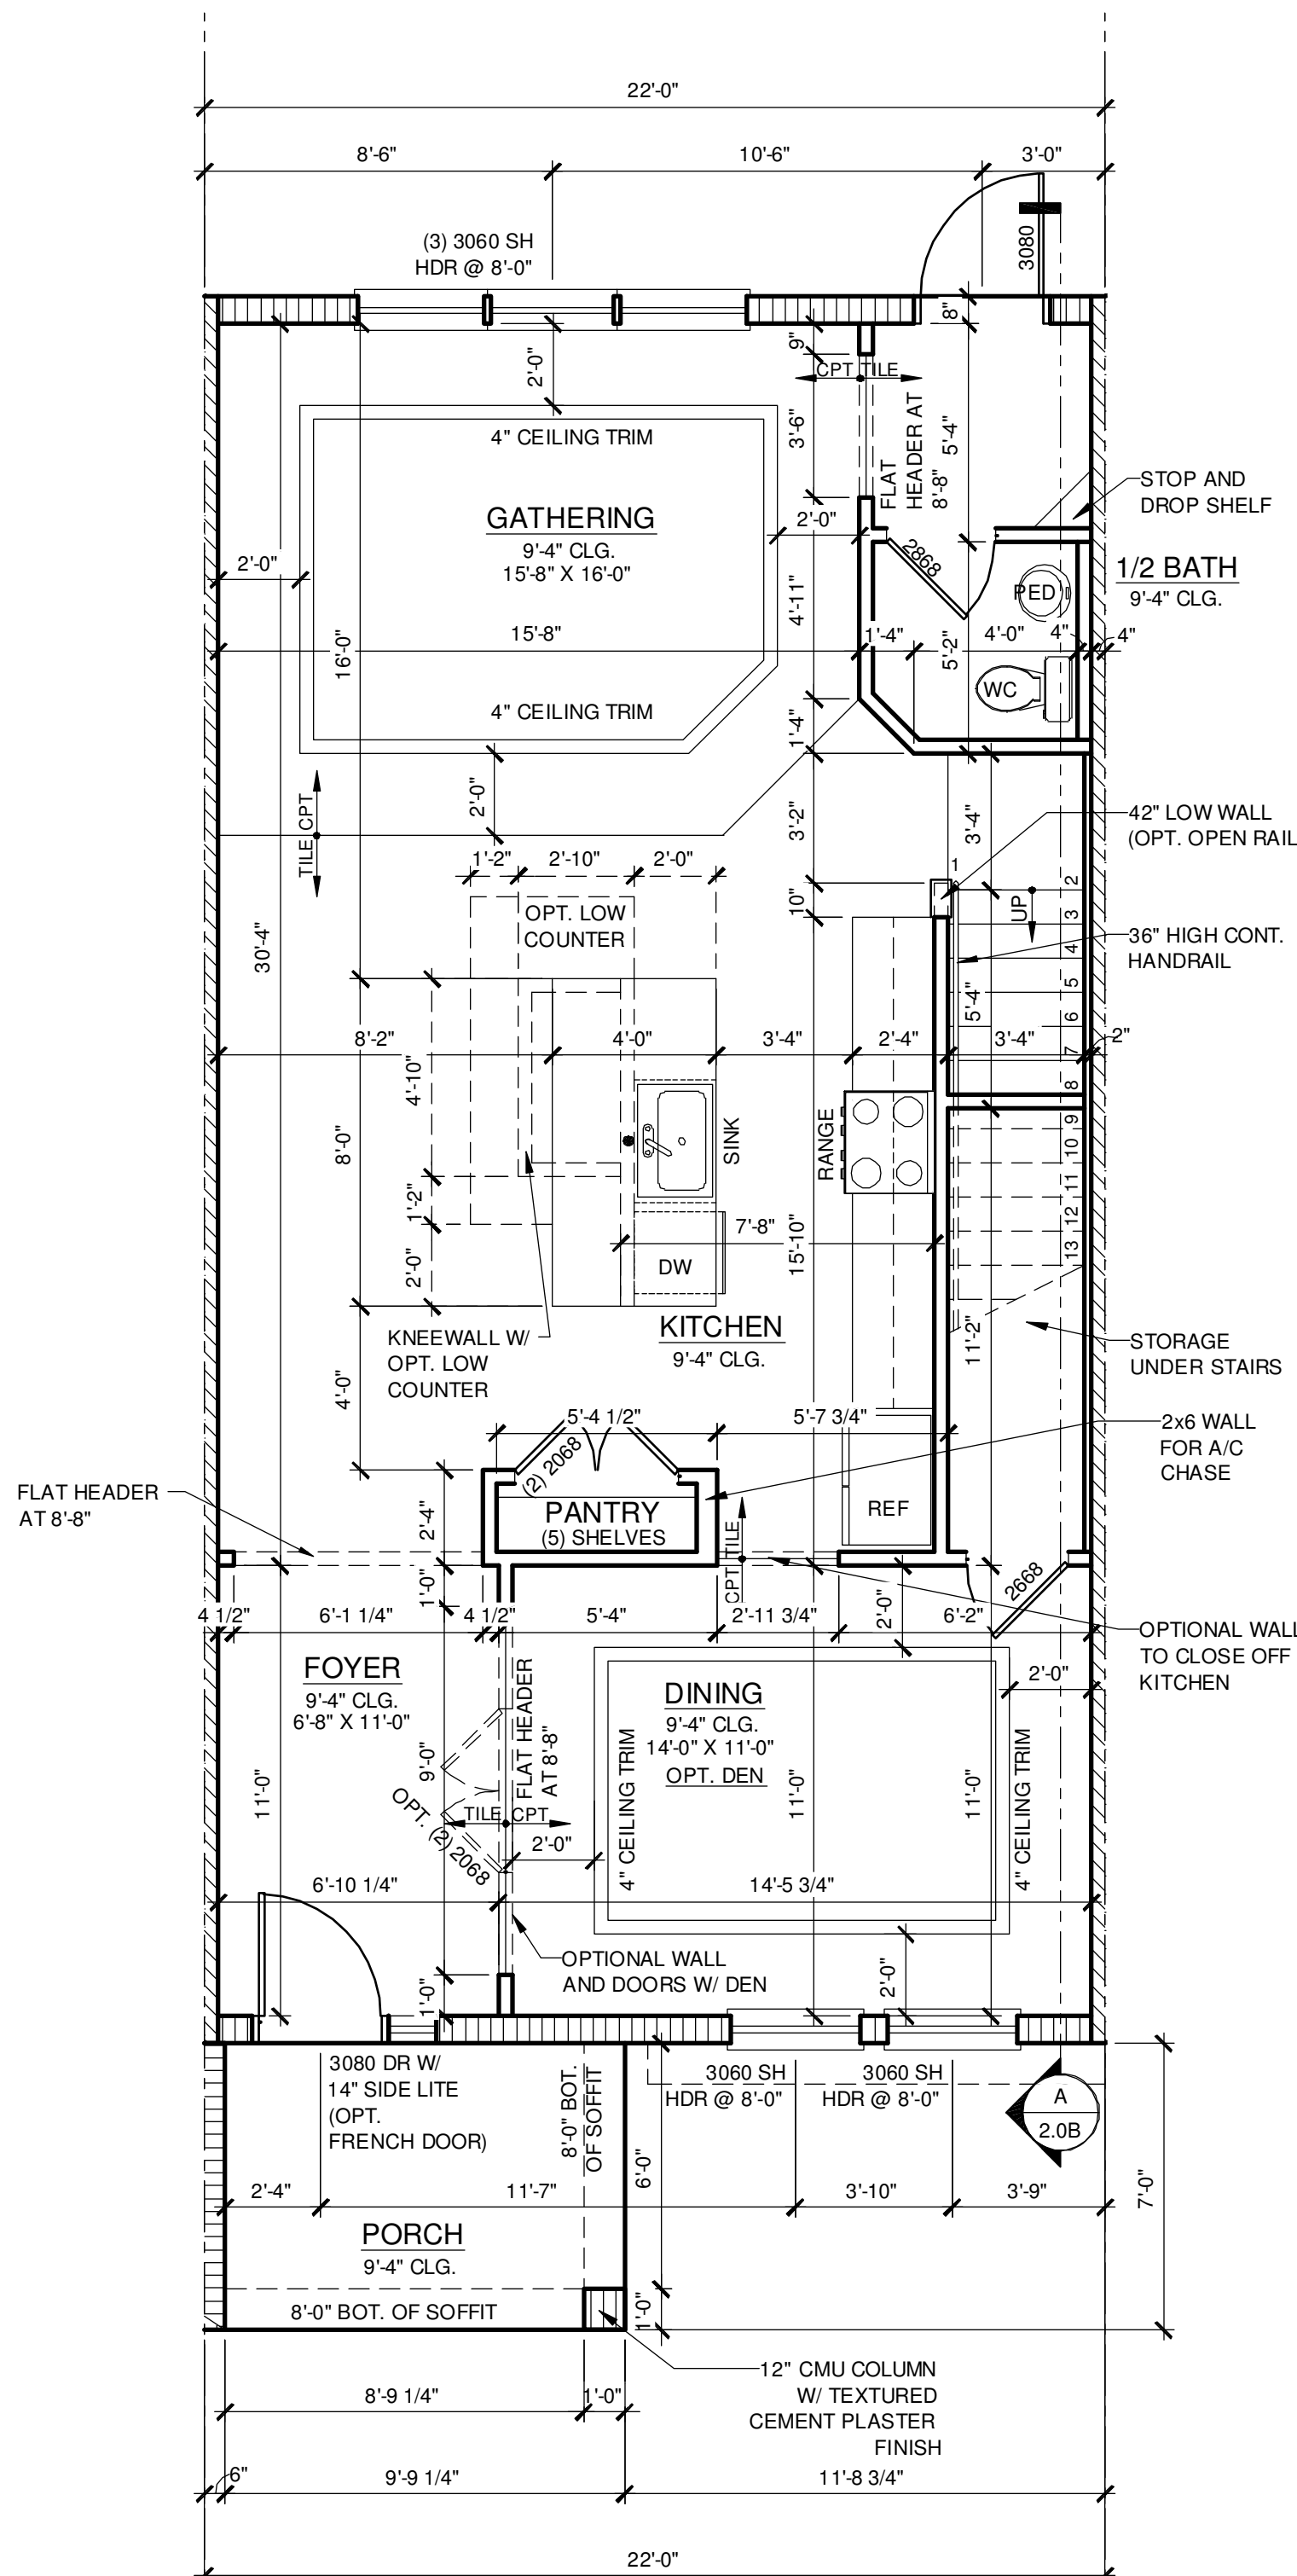


1840 - JEFFERSON  
1ST FLOOR PLAN ELEVATION "A"

1/4" = 1'-0"


DISCLAIMER

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1840 - JEFFERSON  
1ST FLOOR PLAN - GARAGE

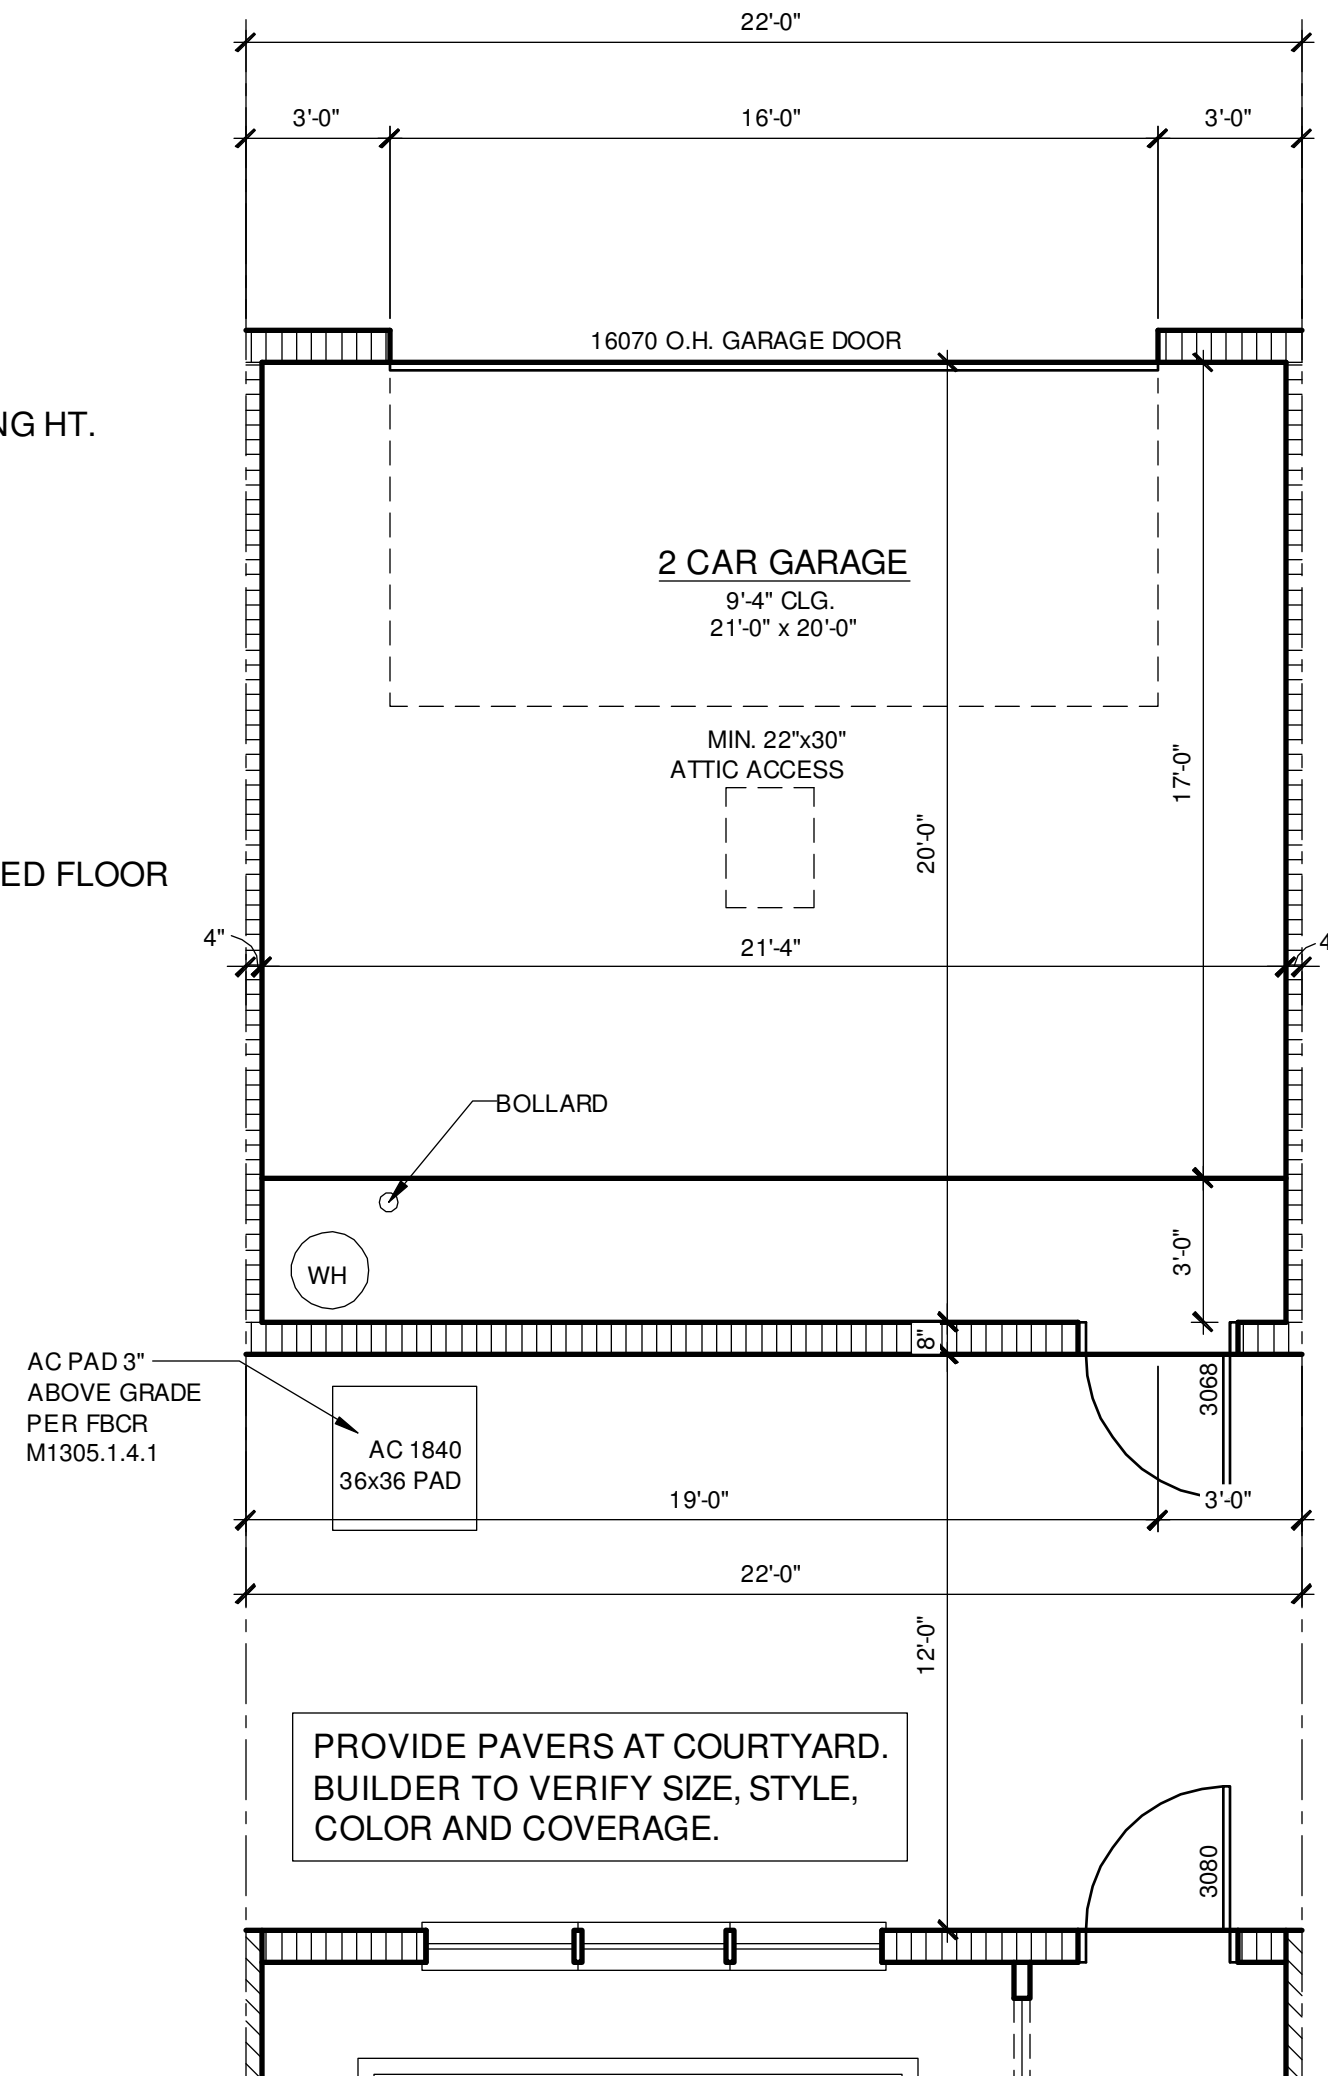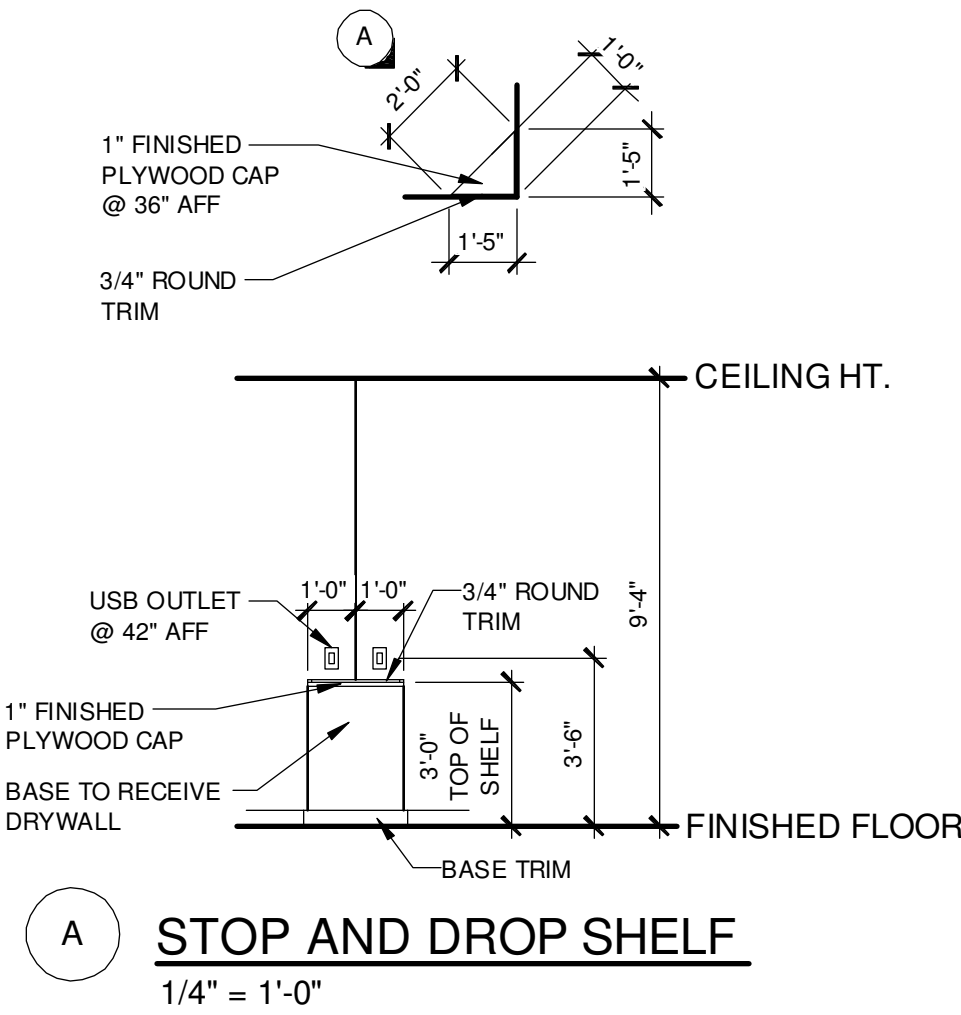1/4" = 1'-0"



1ST FLOOR - KEY PLAN

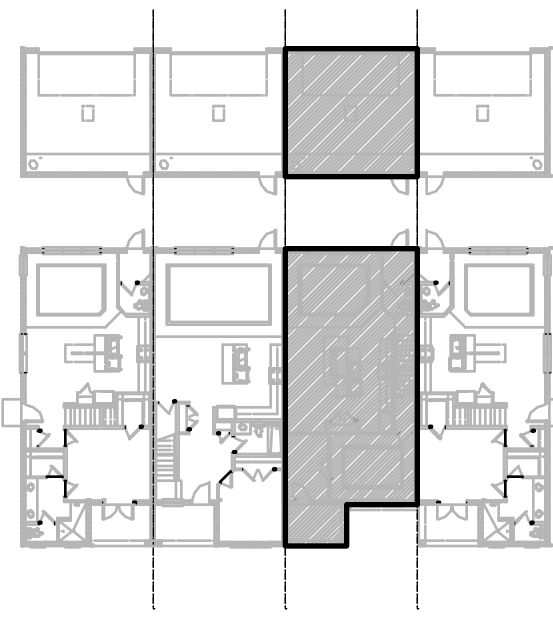1/32" = 1'-0"

1840 - JEFFERSON  
AREA CALCULATIONS

1st FLR. LIVING	940 SQ. FT.
2ND FLR. LIVING	900 SQ. FT.
TOTAL LIVING	1,840 SQ. FT.
GARAGE	470 SQ. FT.
FRONT PORCH	70 SQ. FT.
TOTAL UR	2,380 SQ. FT.

WALL LEGEND

INDICATES 8x8x16 (NOM.) C.M.U. (EXTERIOR LOAD BEARING ), 9'-4" TOP OF CMU

INDICATES 8x8x16 (NOM.) C.M.U. (EXTERIOR LOAD BEARING ), 10'-8" TOP OF CMU



INDICATES 8x8x16 (NOM.) C.M.U. (EXTERIOR LOAD BEARING ), 10'-8" TOP OF CMU

INDICATES WALLS TO BE UTILIZED FOR TRUSS BEARING 2x4 WOOD STUDS @ 16" O.C. U.N.O.

INDICATES 2X WOOD PARTITIONS. (NON LOAD BEARING INTERIOR PARTITIONS ONLY.) (U.N.O.)

INDICATES WET WALLS, 2X WOOD STUDS @ 12" O.C.

INDICATES INSULATED WALLS

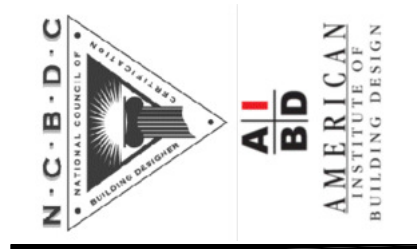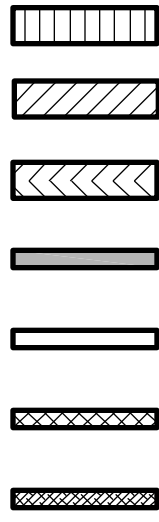

FDS JOB NO.:

PARK SQUARE  
HORIZONS WEST  
BABCOCK RANCH BLDG 6 (LOTS 6092-6099) 4 UNIT

Title:  
1840 - JEFFERSON  
FLOOR PLAN


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checked: BF  
drawn: BA  
date: 04-12-23  
scale: AS SHOWN

1.1B  
ELEV. A

NOTE: DRAWINGS ON 11"x17" SHEET WILL BE ONE HALF THE SCALE NOTED

DISCLAIMER


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1840 - JEFFERSON  
2ND FLOOR PLAN ELEVATION "A"

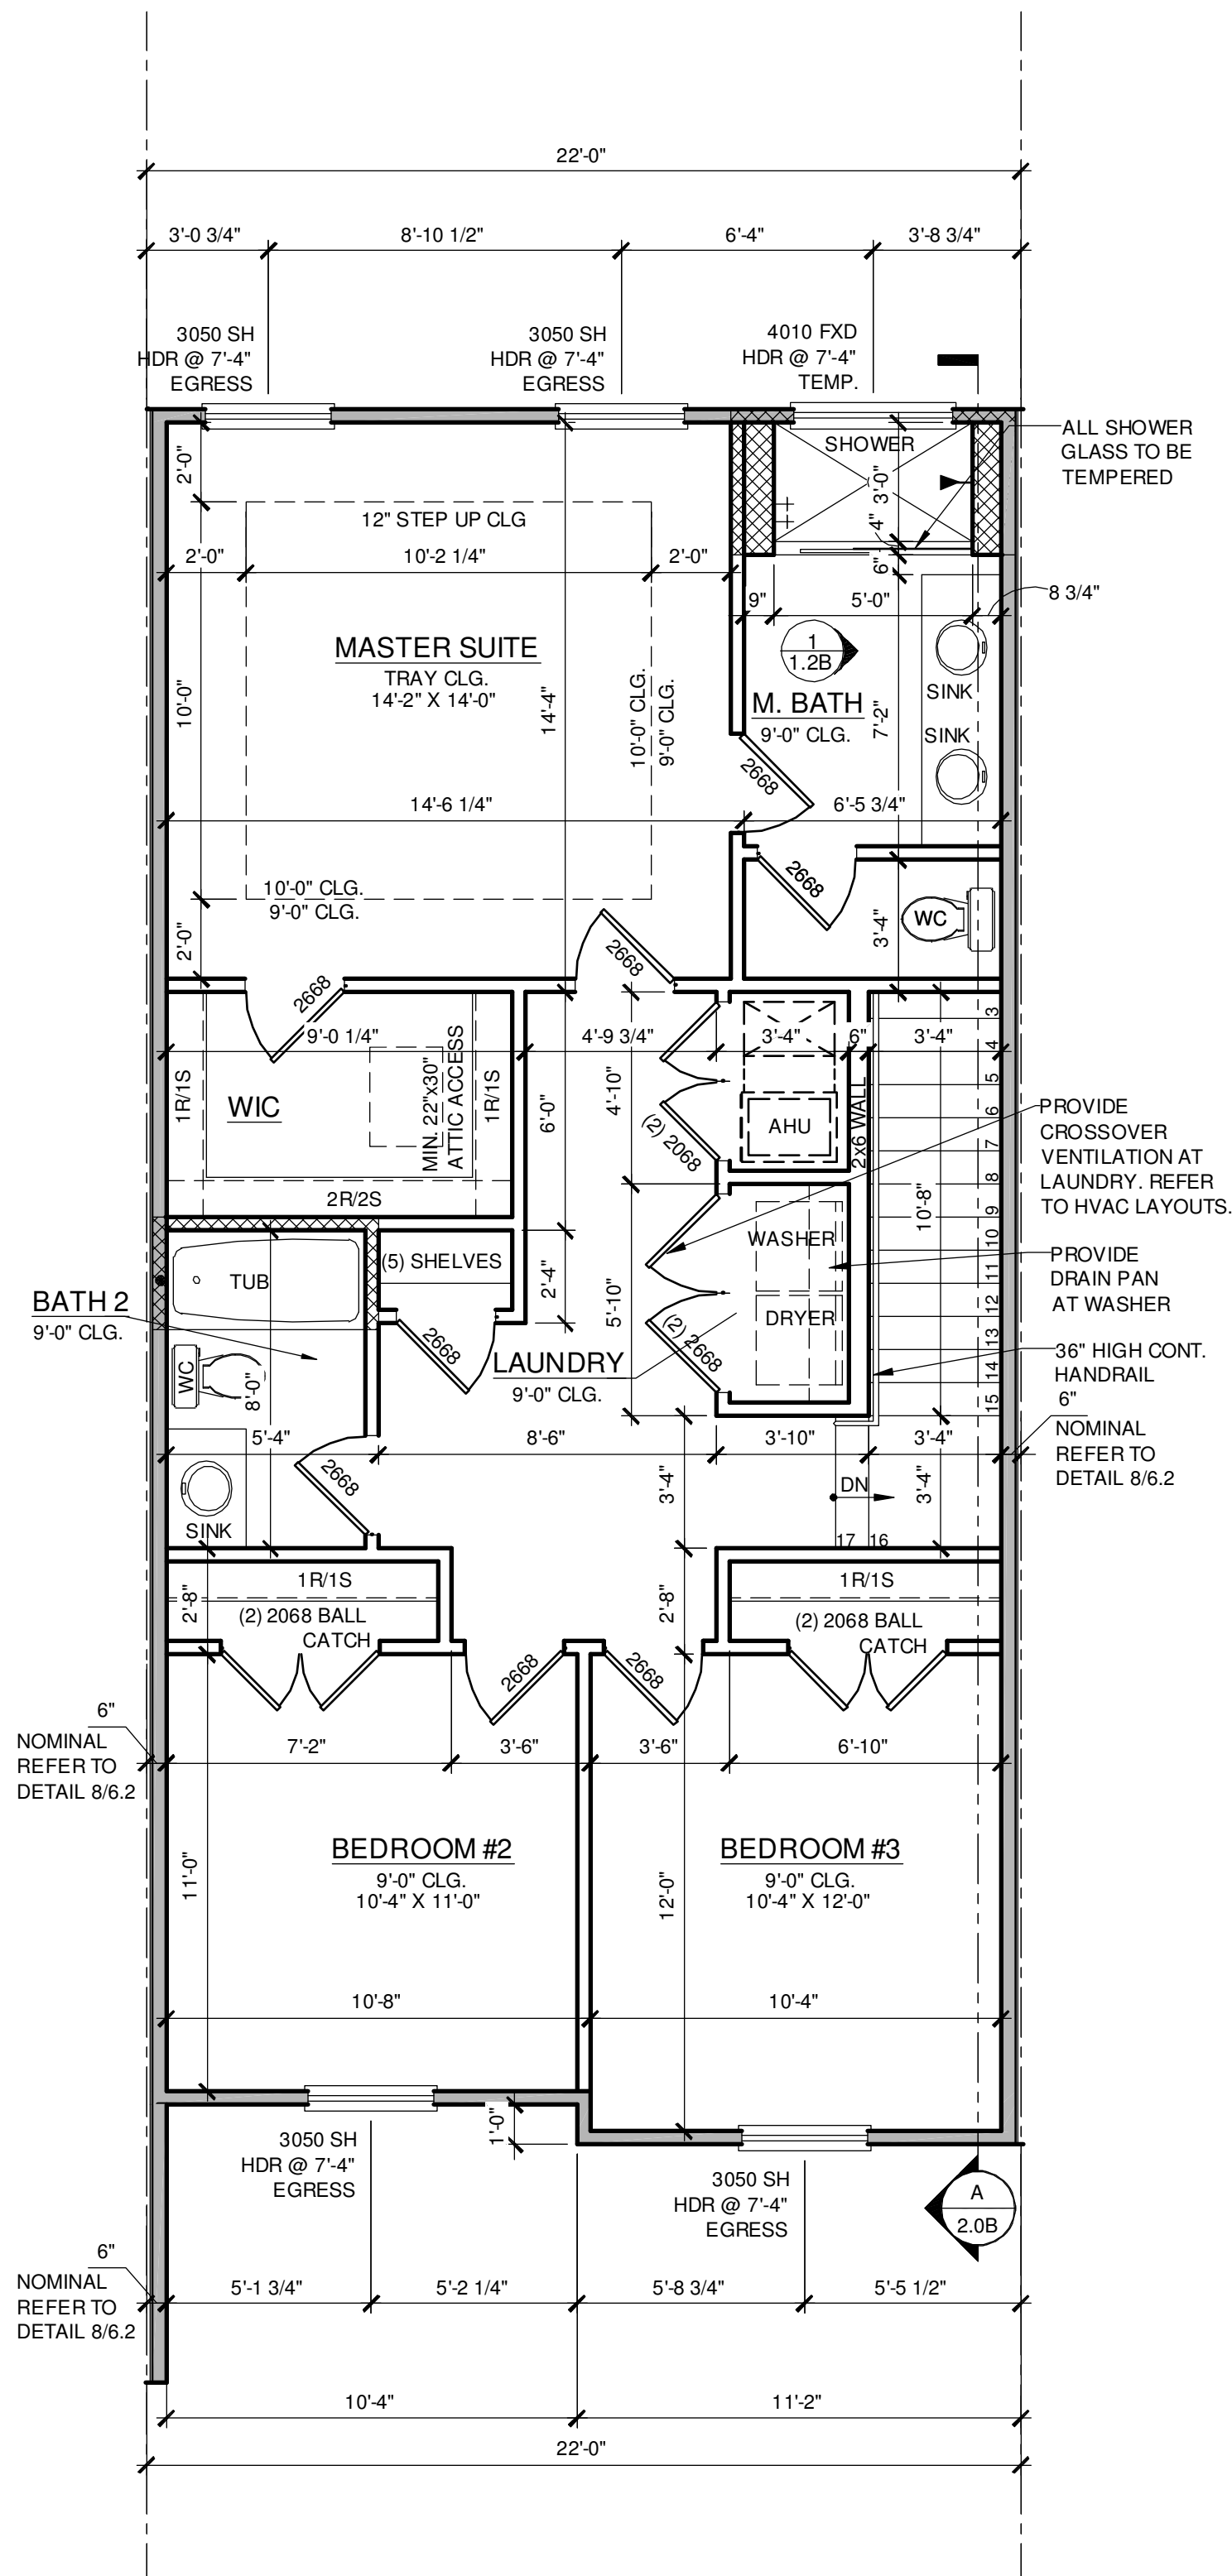1/4" = 1'-0"

UNIT 6090 1840 JEFFERSON



1.2B MASTER BATH  
SCALE: 1/4"=1'-0"

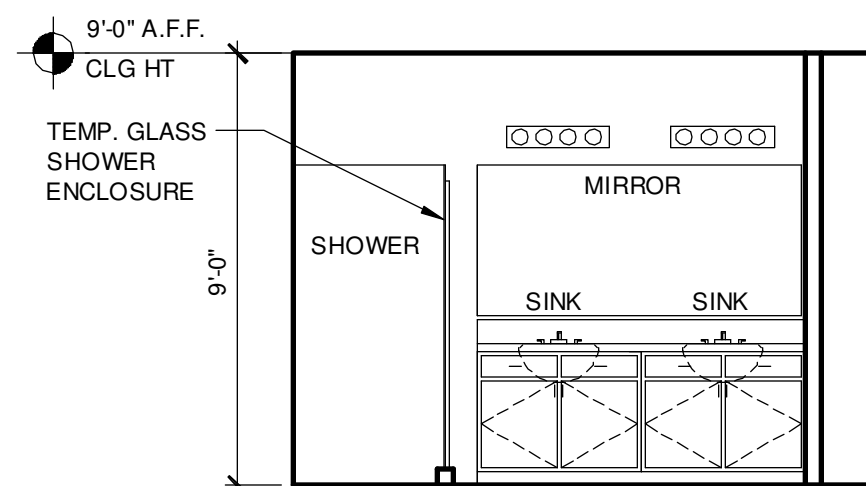

2ND FLOOR - KEY PLAN

1/32" = 1'-0"


1840 - JEFFERSON  
AREA CALCULATIONS

1st FLR. LIVING	940 SQ. FT.
2ND FLR. LIVING	900 SQ. FT.
TOTAL LIVING	1,840 SQ. FT.
GARAGE	470 SQ. FT.
FRONT PORCH	70 SQ. FT.
TOTAL UR	2,380 SQ. FT.

WALL LEGEND

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- INDICATES INSULATED WALLS

**B&A Design Studio, Inc.**  
4017 W. 1st Street  
Sanford, FL 32771  
ph 407 829 8800  
fax 407 829 2040  
www.badesignstudies.com

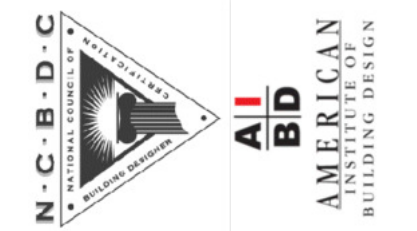

**FDS**  
ENGINEERING ASSOCIATES  
288 Southall Lane, Suite 200, Millbrook, N.C. 27511  
P.O. Box 10000, Raleigh, N.C. 27602  
SCOTT LEWIS, PE, FL #12028  
CARLA A. BROWN, PE, FL #12028  
DATE: April 14, 2023  
TO THE BEST OF MY KNOWLEDGE AND BELIEF, THE INFORMATION CONTAINED HEREIN IS TRUE AND CORRECT AND I AM NOT PROVIDING ANY GUARANTEE FOR THE SAME.

FDS JOB NO.:

PARK SQUARE  
HORIZONS WEST  
BABCOCK RANCH BLDG 6 (LOTS 6092-6099) 4 UNIT

Title:  
1840 - JEFFERSON  
FLOOR PLAN



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checked: BF  
drawn: BA  
date: 04-12-23  
scale: AS SHOWN

1.2B  
ELEV. A


NOTE: DRAWINGS ON 11"x17" SHEET WILL BE ONE HALF THE SCALE NOTED

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UNIT 6091 2024 MADISON

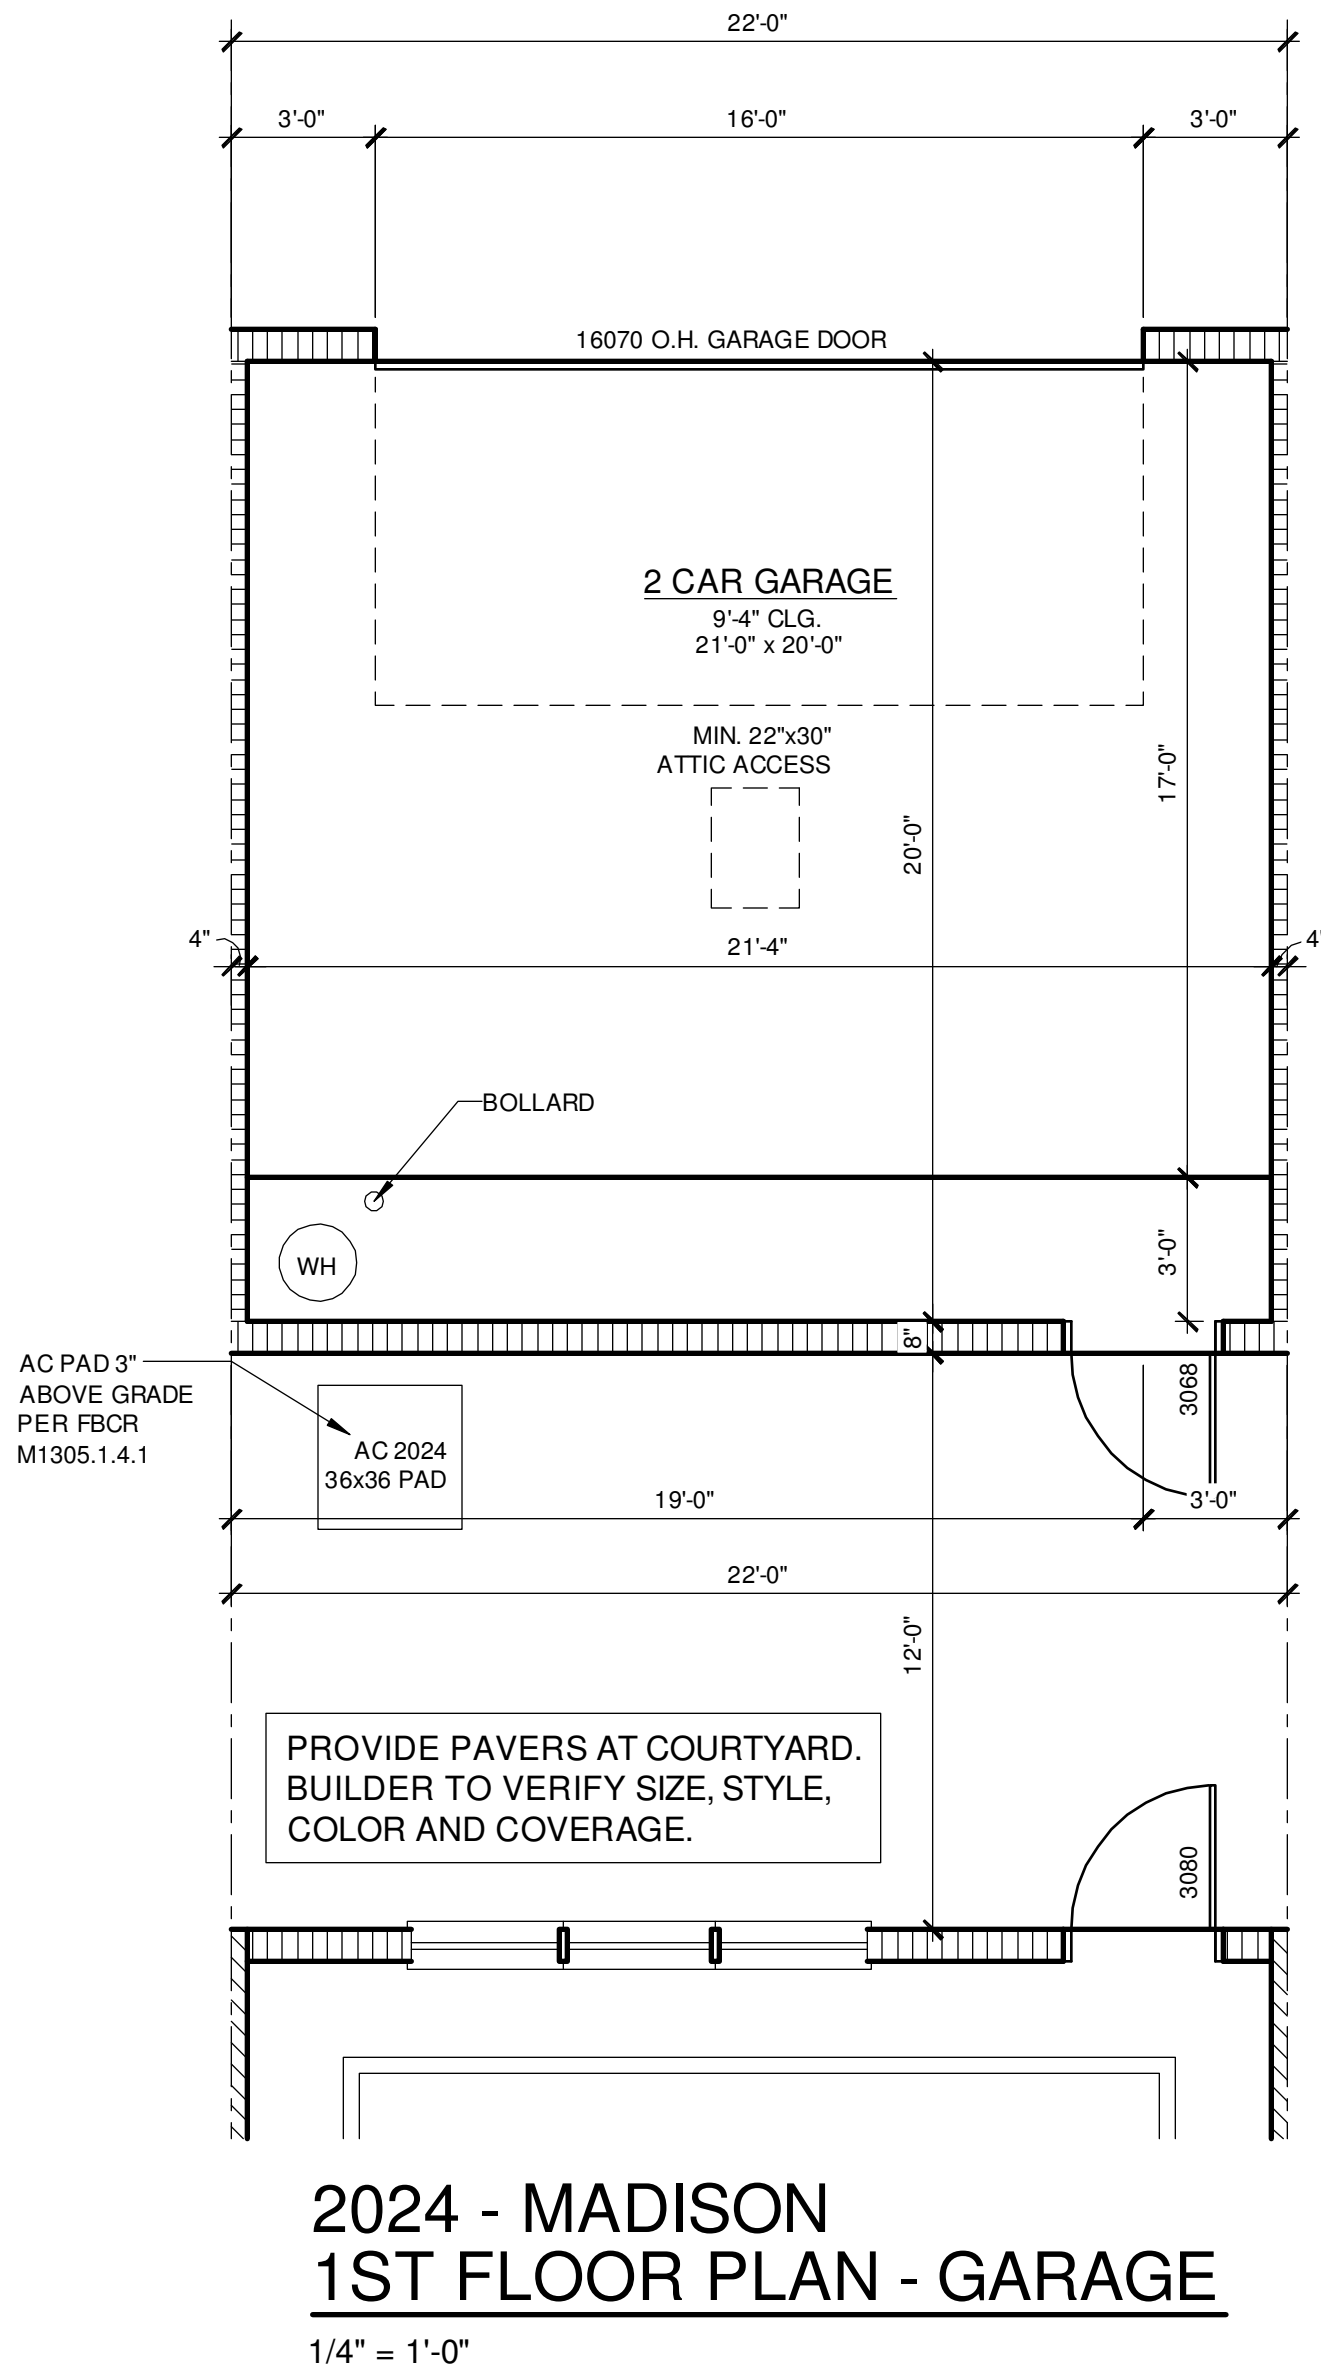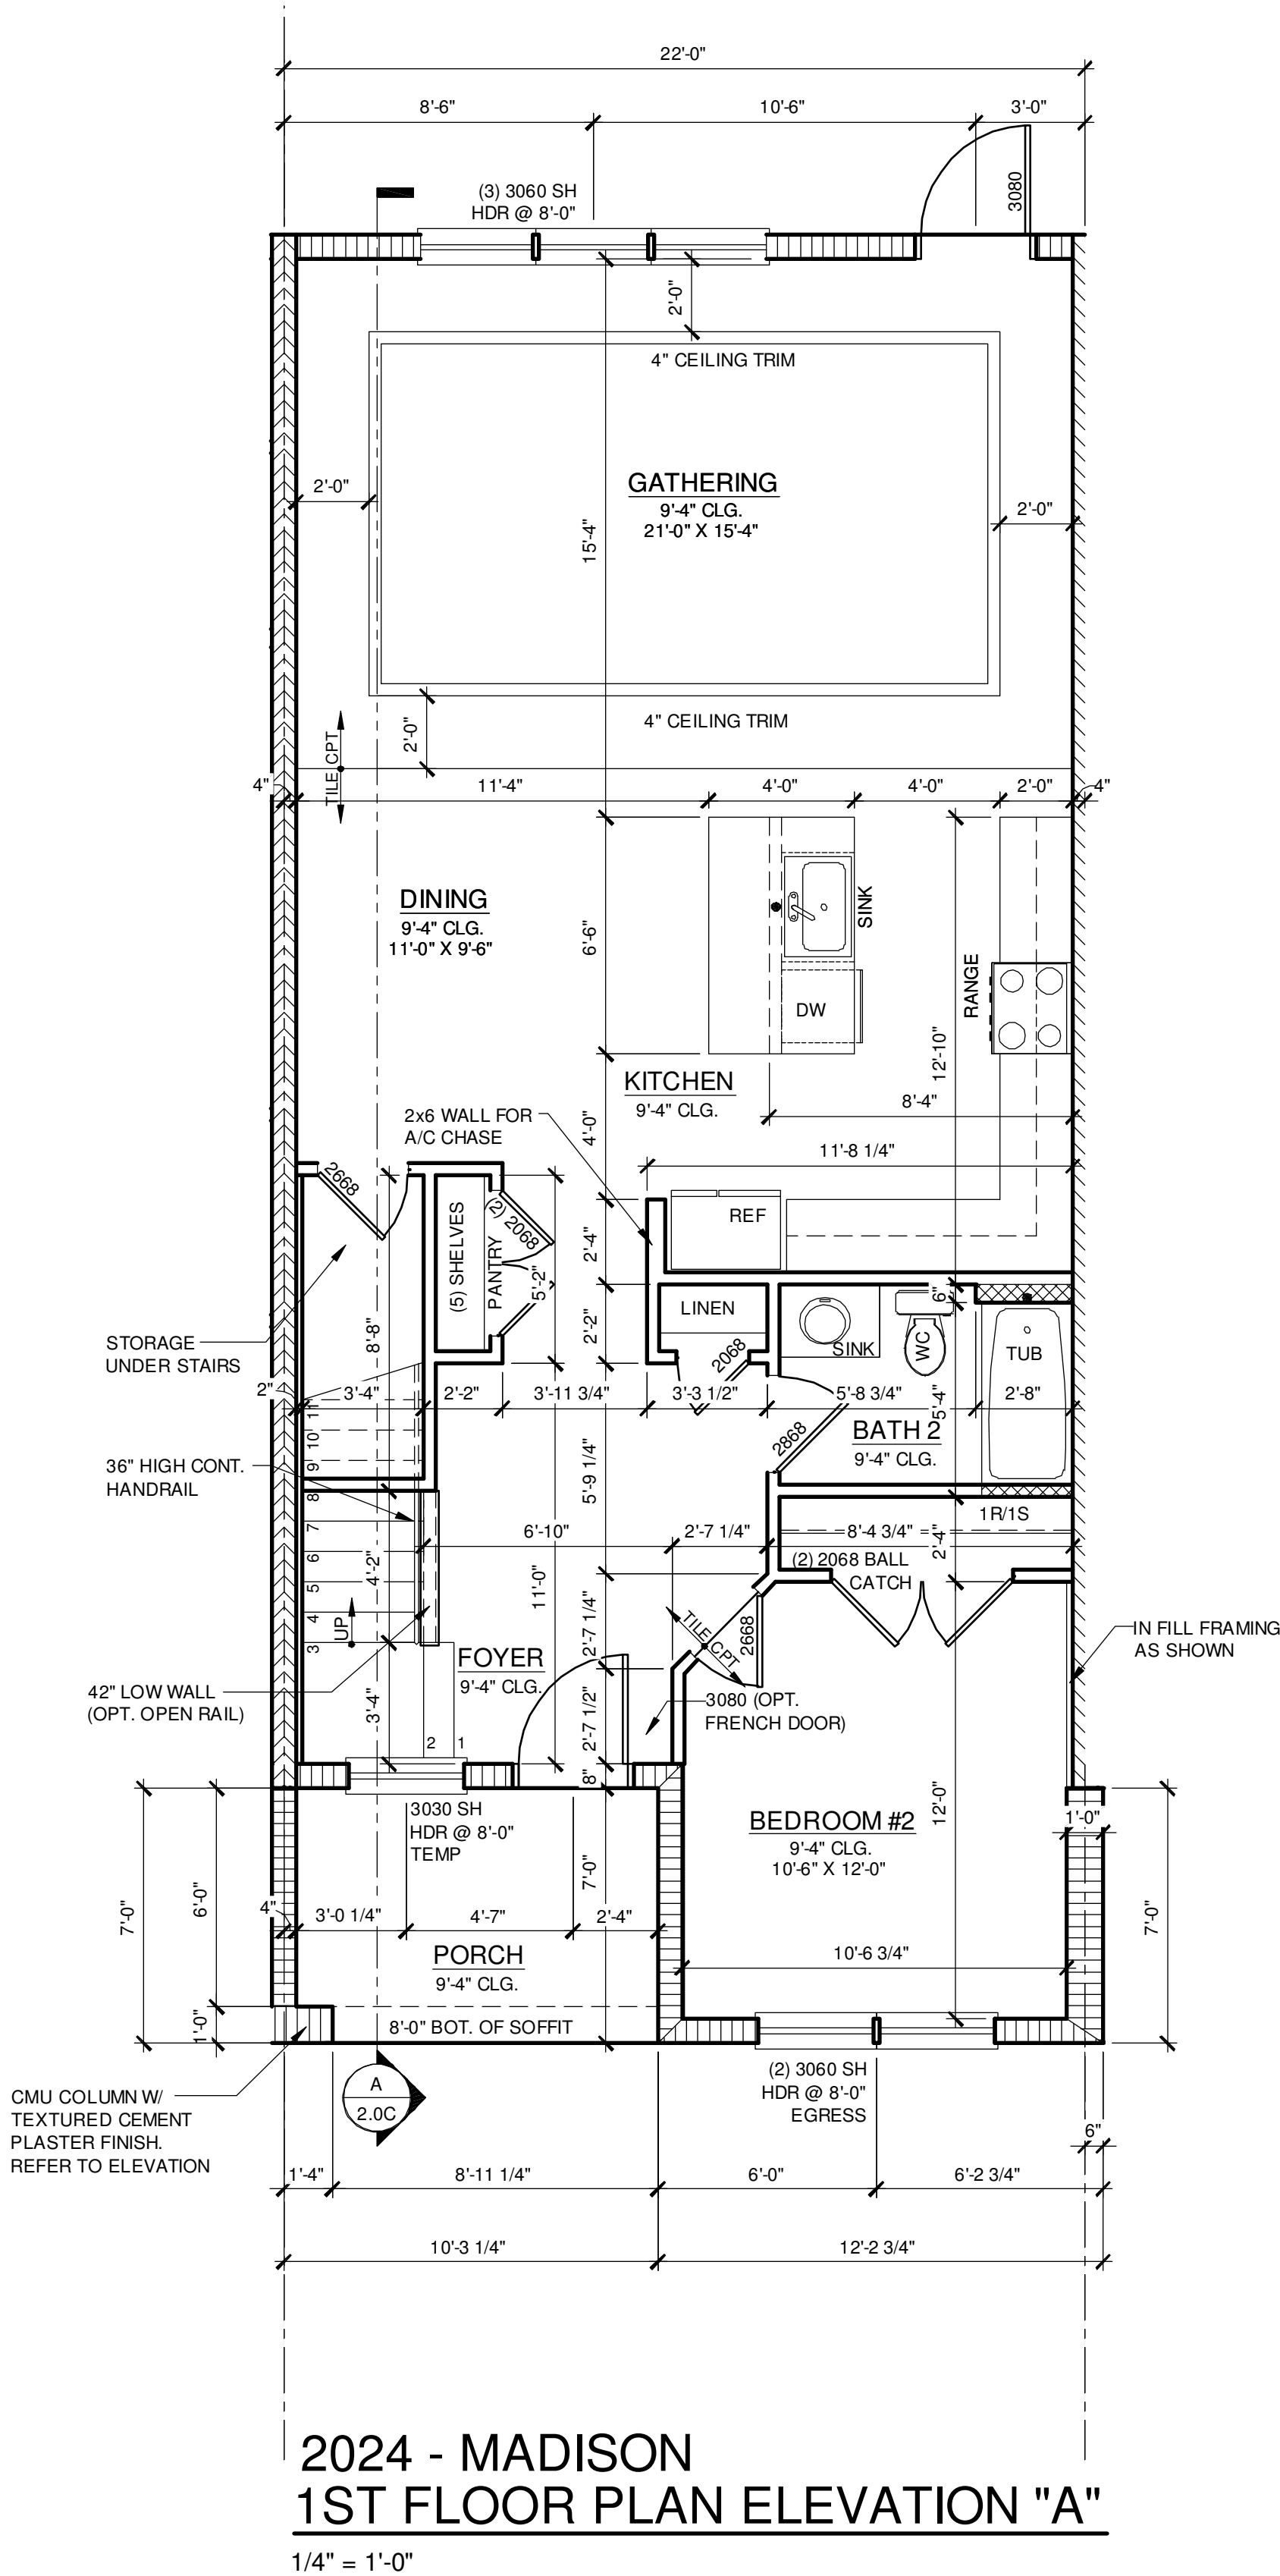

1ST FLOOR - KEY PLAN

1/32" = 1'-0"
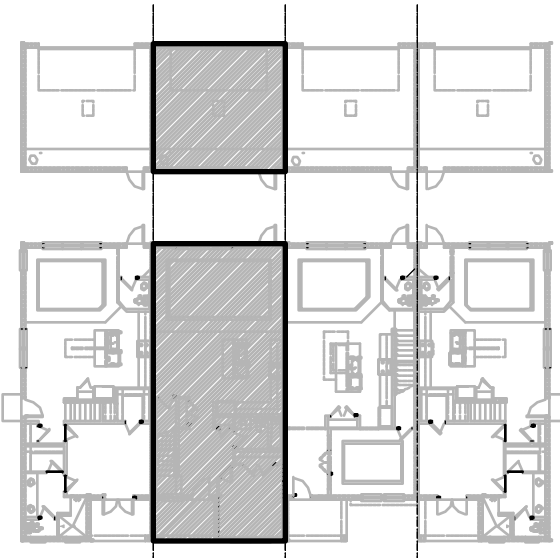
### 2024 - MADISON AREA CALCULATIONS


1st FLR. LIVING	1,023 SQ. FT.
2ND FLR. LIVING	1,001 SQ. FT.
TOTAL LIVING	2,024 SQ. FT.
GARAGE	470 SQ. FT.
FRONT PORCH	71 SQ. FT.
TOTAL UR	2,565 SQ. FT.

### WALL LEGEND

- INDICATES 8x8x16 (NOM.) C.M.U. (EXTERIOR LOAD BEARING) ; 9'-4" TOP OF CMU
- INDICATES 8x8x16 (NOM.) C.M.U. (EXTERIOR LOAD BEARING) ; 10'-8" TOP OF CMU
- INDICATES 8x8x16 (NOM.) C.M.U. (EXTERIOR LOAD BEARING) ; 10'-8" TOP OF CMU
- INDICATES WALLS TO BE UTILIZED FOR TRUSS BEARING 2x4 WOOD STUDS @ 16" O.C. U.N.O.
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- INDICATES WET WALLS, 2X WOOD STUDS @ 12" O.C.
- INDICATES INSULATED WALLS

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4017 W. 1st Street  
Sanford, FL 32771  
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**FDS**

ENGINEERING ASSOCIATES  
288 Southall Lane, Suite 200, Maitland, FL 32751  
P.O. Box 10000, Maitland, FL 32751  
Certificate of Authorization No. 9191  
SCOTT BROWN, PE, FL #58128  
SCOTT LEWIS, PE, FL #78750  
DATE: April 14, 2023  
TO THE BEST OF MY KNOWLEDGE AND BELIEF, THE INFORMATION CONTAINED HEREIN IS TRUE AND CORRECT FOR THE PURPOSES FOR WHICH IT WAS PREPARED.

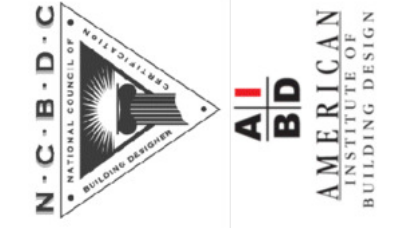FDS JOB NO.:

PARK SQUARE  
HORIZONS WEST  
BABCOCK RANCH BLDG 6 (LOTS 6092-6099) 4 UNIT


Title:  
**2024 - MADISON  
FLOOR PLAN**

project no. 2023083  
checked: BF  
drawn: BA  
date: 04-12-23  
scale: AS SHOWN

**1.1C  
ELEV. A**


NOTE: DRAWINGS ON 11"x17" SHEET WILL BE ONE HALF THE SCALE NOTED

UNIT 6091    2024 MADISON

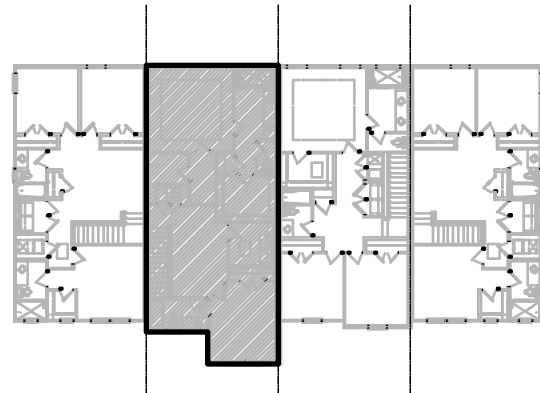

## 2ND FLOOR - KEY PLAN

1/32" = 1'-0"

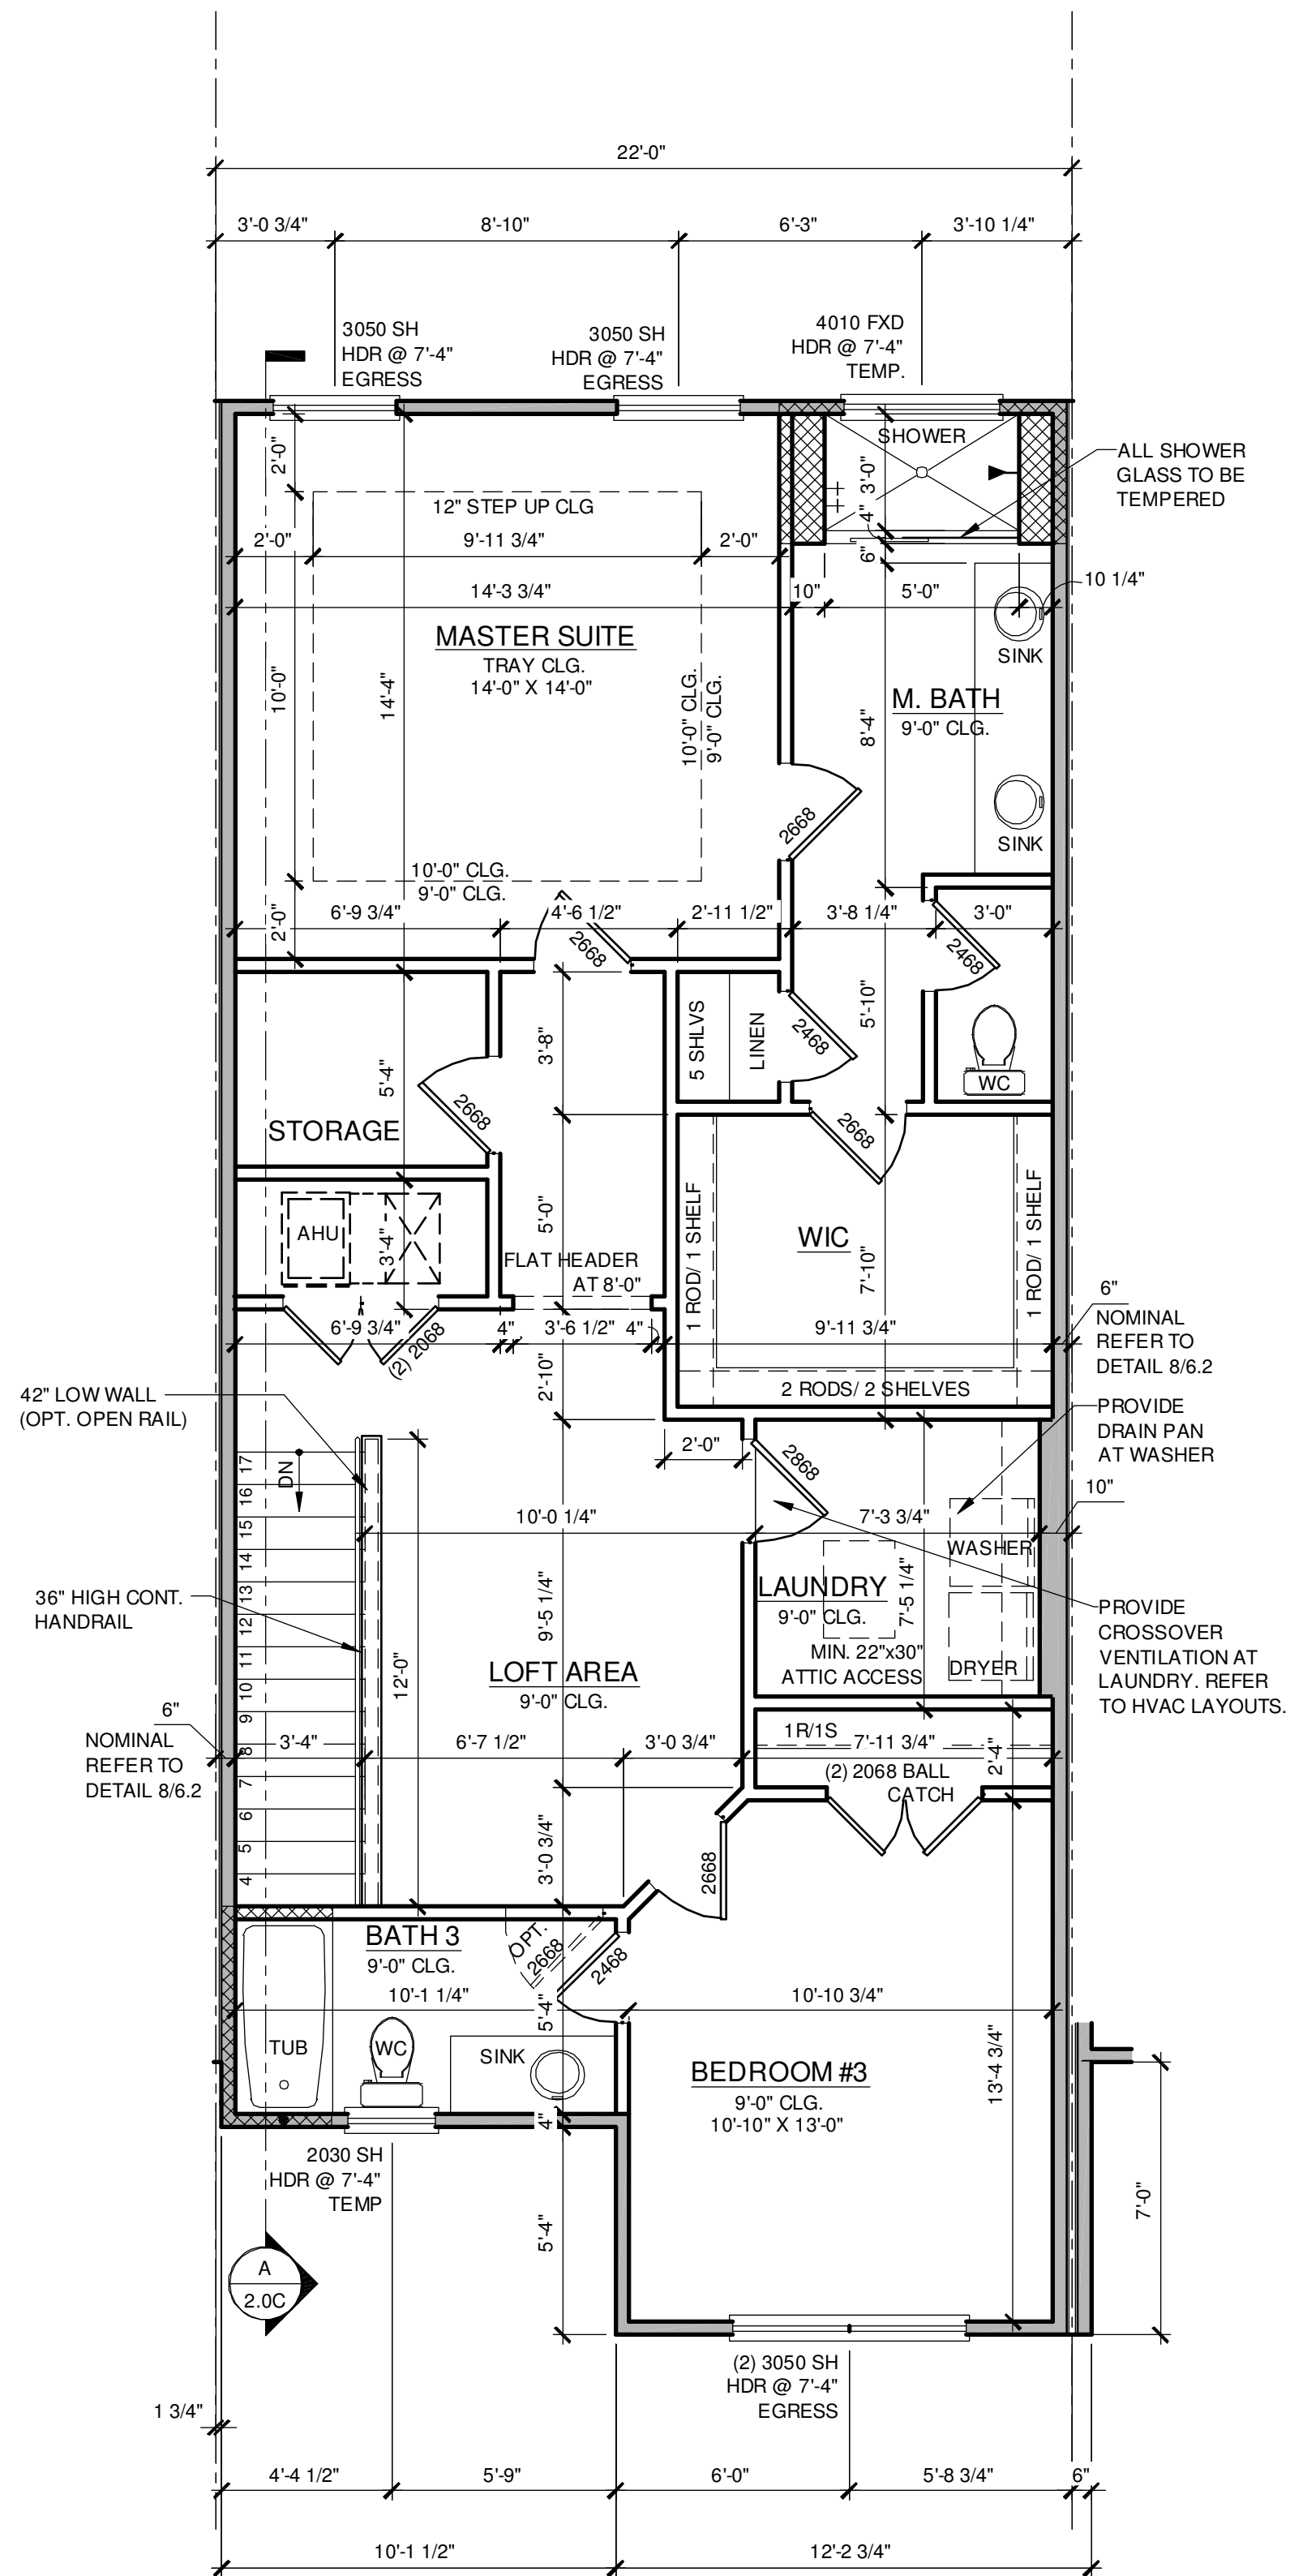

## 2024 - MADISON 2ND FLOOR PLAN ELEVATION "A"

1/4" = 1'-0"

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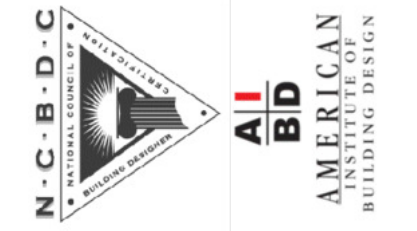
## 2024 - MADISON AREA CALCULATIONS

1st FLR. LIVING	1,023 SQ. FT.
2ND FLR. LIVING	1,001 SQ. FT.
TOTAL LIVING	2,024 SQ. FT.
GARAGE	470 SQ. FT.
FRONT PORCH	71 SQ. FT.
TOTAL UR	2,565 SQ. FT.

## WALL LEGEND

- INDICATES 8x8x16 (NOM.) C.M.U. (EXTERIOR LOAD BEARING ), 9'-4" TOP OF CMU
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FDS JOB NO.:


**PARK SQUARE  
HORIZONS WEST  
BABCOCK RANCH BLDG 6 (LOTS 6092-6099) 4 UNIT**

Title:  
**2024 - MADISON  
FLOOR PLAN**

project no. 2023083  
checked: BF  
drawn: BA  
date: 04-12-23  
scale: AS SHOWN

**1.2C  
ELEV. A**

NOTE: DRAWINGS ON 11"x17" SHEET WILL BE ONE HALF THE SCALE NOTED

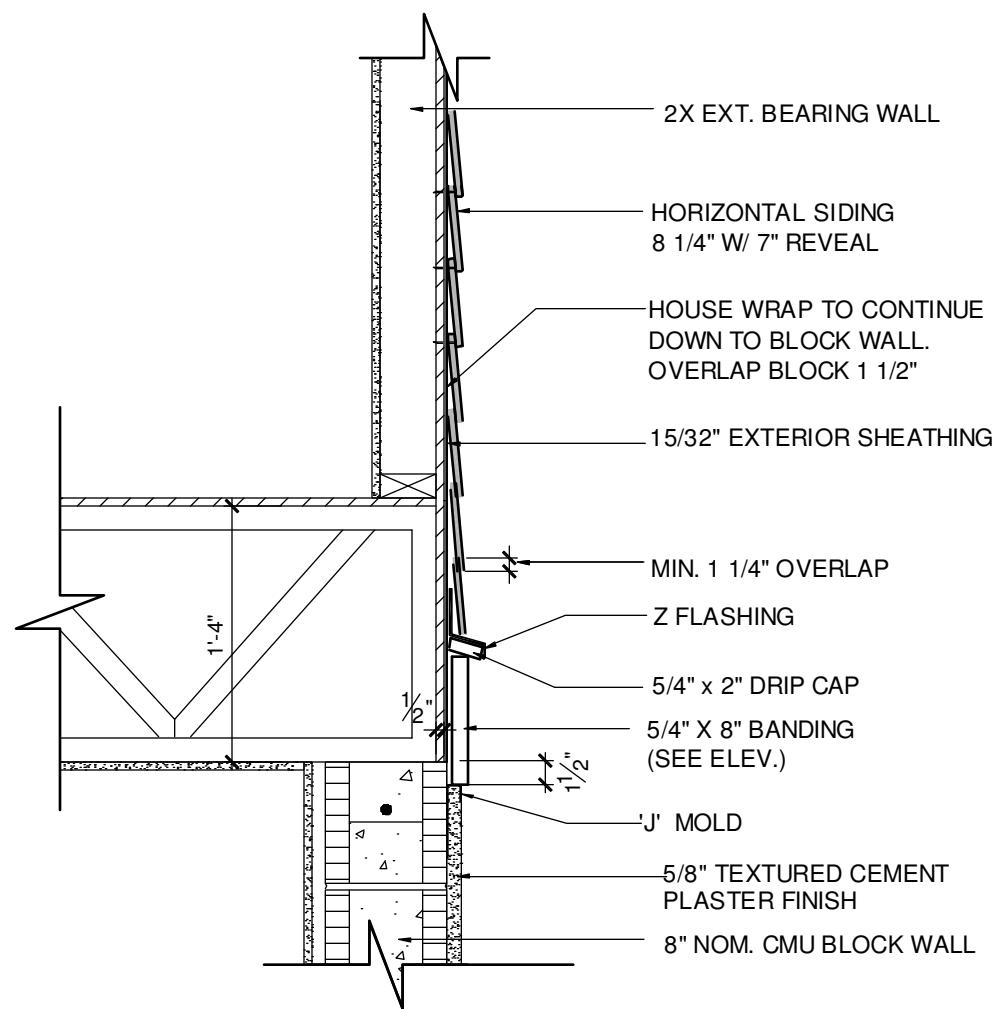

### BELLY BAND TRIM DETAIL AT T.O.M.

ABV. SMOOTH  
SAND FINISH  
SCALE: 1" = 1'-0"

UNIT 6092	1914 ADAMS REVERSED
UNIT 6089	1914 ADAMS

ALL GUARDRAILS AND  
HANDRAILS TO COMPLY  
WITH R301 AND TABLE  
R301.5 PER FBCR 2020,  
7TH EDITION

#### 2020 FBCR :

##### R312.1 Guards.

Guards shall be provided in accordance with Sections R312.1.1 through R312.1.4.

##### R312.1.1 Where required.

Guards shall be provided for those portions of open-sided walking surfaces, including stairs, ramps and landings, that are located more than 30 inches (762 mm) measured vertically to the floor or grade below at any point within 24 inches (914 mm) horizontally to the edge of the open side. Insect screening shall not be considered as a guard.

##### R312.1.2 Height.

Required guards at open-sided walking surfaces, including stairs, porches, balconies or landings, shall be not less than 36 inches (914 mm) in height as measured vertically above the adjacent walking surface or the line connecting the leading edges of the treads.

##### Exceptions:

- Guards on the open sides of stairs shall have a height not less than 34 inches (864 mm) measured vertically from a line connecting the leading edges of the treads.
- Where the top of the guard serves as a handrail on the open sides of stairs, the top of the guard shall not be less than 34 inches (864 mm) and not more than 38 inches (965 mm) as measured vertically from a line connecting the leading edges of the treads.

##### R312.1.3 Opening limitations.


Required guards shall not have openings from the walking surface to the required guard height which allow passage of a sphere 4 inches (102 mm) in diameter.

##### Exceptions:

- The triangular openings at the open side of stair, formed by the riser, tread and bottom rail of a guard, shall not allow passage of a sphere 6 inches (153 mm) in diameter.
- Guards on the open side of stairs shall not have openings which allow passage of a sphere 4 3/8 inches (111 mm) in diameter.

##### R312.1.4 Exterior plastic composite guards.

Plastic composite exterior guards shall comply with the requirements of Section R317.4.

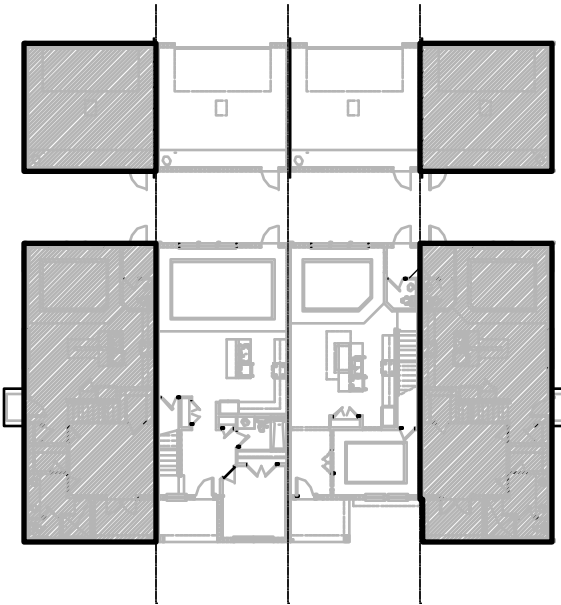

### SECTION - KEY PLAN

1/32" = 1'-0"

#### 2020 FBCR:

##### R311.7.5.1 Risers.

The riser height shall be not more than 7 3/4 inches (196 mm). The riser shall be measured vertically between leading edges of the adjacent treads. The greatest riser height within any flight of stairs shall not exceed the smallest by more than 3/8 inch (9.5 mm). Risers shall be vertical or sloped from the underside of the nosing of the tread above at an angle not more than 30 degrees (0.51 rad) from the vertical. Open risers are permitted provided that the opening located more than 30 inches (762mm), as measured vertically, to the floor or grade below do not permit the passage of a 4 inch diameter (102mm) sphere.

##### R311.7.5.2 Treads.

The tread depth shall be not less than 10 inches (254 mm). The tread depth shall be measured horizontally between the vertical planes of the foremost projection of adjacent treads and at a right angle to the tread's leading edge. The greatest tread depth within any flight of stairs shall not exceed the smallest by more than 3/8 inch (9.5 mm).

##### R311.7.5.2.1 Winder treads.

Winder treads shall have a tread depth of not less than 10 inches (254 mm) measured between the vertical planes of the foremost projection of adjacent treads at the intersections with the walkline. Winder treads shall have a tread depth of not less than 6 inches (152 mm) at any point within the clear width of the stair. Within any flight of stairs, the largest winder tread depth at the walkline shall not exceed the smallest winder tread by more than 3/8 inch (9.5 mm). Consistently shaped winders at the walkline shall be allowed within the same flight of stairs as rectangular treads and do not have to be within 3/8 inch (9.5 mm) of the rectangular tread depth.

##### R311.7.5.3 Nosings.

Nosings at treads, landings and floors of stairways shall have a radius of curvature at the nosing not greater than 9/16 inch (14mm) or a bevel not exceeding 1/2 inch (12.7mm). A nosing projection not less than 3/4 inch (19mm) and not more than 1 1/4 inch (32mm) shall be provided on stairways. The greatest nosing projection shall not exceed the smallest nosing projection by more than 3/8 inch (9.5mm) within a stairway.

##### R311.7.8 Handrails.

Handrails shall be provided on not less than one side of each flight with four or more risers.

##### R311.7.8.1 Height.

Handrail height, measured vertically from the sloped plane adjoining the tread nosing, or finish surface of ramp slope, shall be not less than 34 inches (864 mm) and not more than 38 inches (965 mm).



##### R311.7.8.2 Continuity.

Handrails for stairways shall be continuous for the full length of the flight, from a point directly above the top riser of the flight to a point directly above the lowest riser of the flight. Handrail ends shall be returned or shall terminate in newel posts or safety terminals. Handrails adjacent to a wall shall have a space of not less than 1 1/2 inch (38 mm) between the wall and the handrails.

##### R311.7.8.3 Grip-size.

Required handrails shall be one of the following types or provide equivalent graspability.

- Type I. Handrails with a circular cross section shall have an outside diameter of not less than 1 1/4 inches (32 mm) and not greater than 2 inches (51 mm). If the handrail is not circular, it shall have a perimeter dimension of not less than 4 inches (102 mm) and not greater than 6 1/4 inches (160 mm) with a cross section of dimension of not less than 2 1/4 inches (57 mm). Edges shall have a radius of not less than 0.01 inch (0.25 mm).
- Type II. Handrails with a perimeter greater than 6 1/4 inches (160 mm) shall have a graspable finger recess area on both sides of the profile. The finger recess shall begin within a distance of 3/4 inch (19 mm) measured vertically from the tallest portion of the profile and achieve a depth of no less than 5/16 inch (8 mm) within 7/8 inch (22 mm) below the widest portion of the profile. This required depth shall continue for not less than 3/8 inch (10 mm) to a level that is not less than 1 3/4 inches (45 mm) below the tallest portion of the profile. The width of the handrail above the recess shall be not less than 1 1/4 inches (32 mm) and not more than 2 3/4 inches (70 mm). Edges shall have a radius of not less than 0.01 inch (0.25 mm).

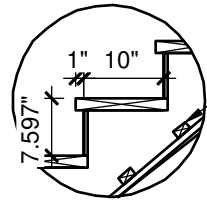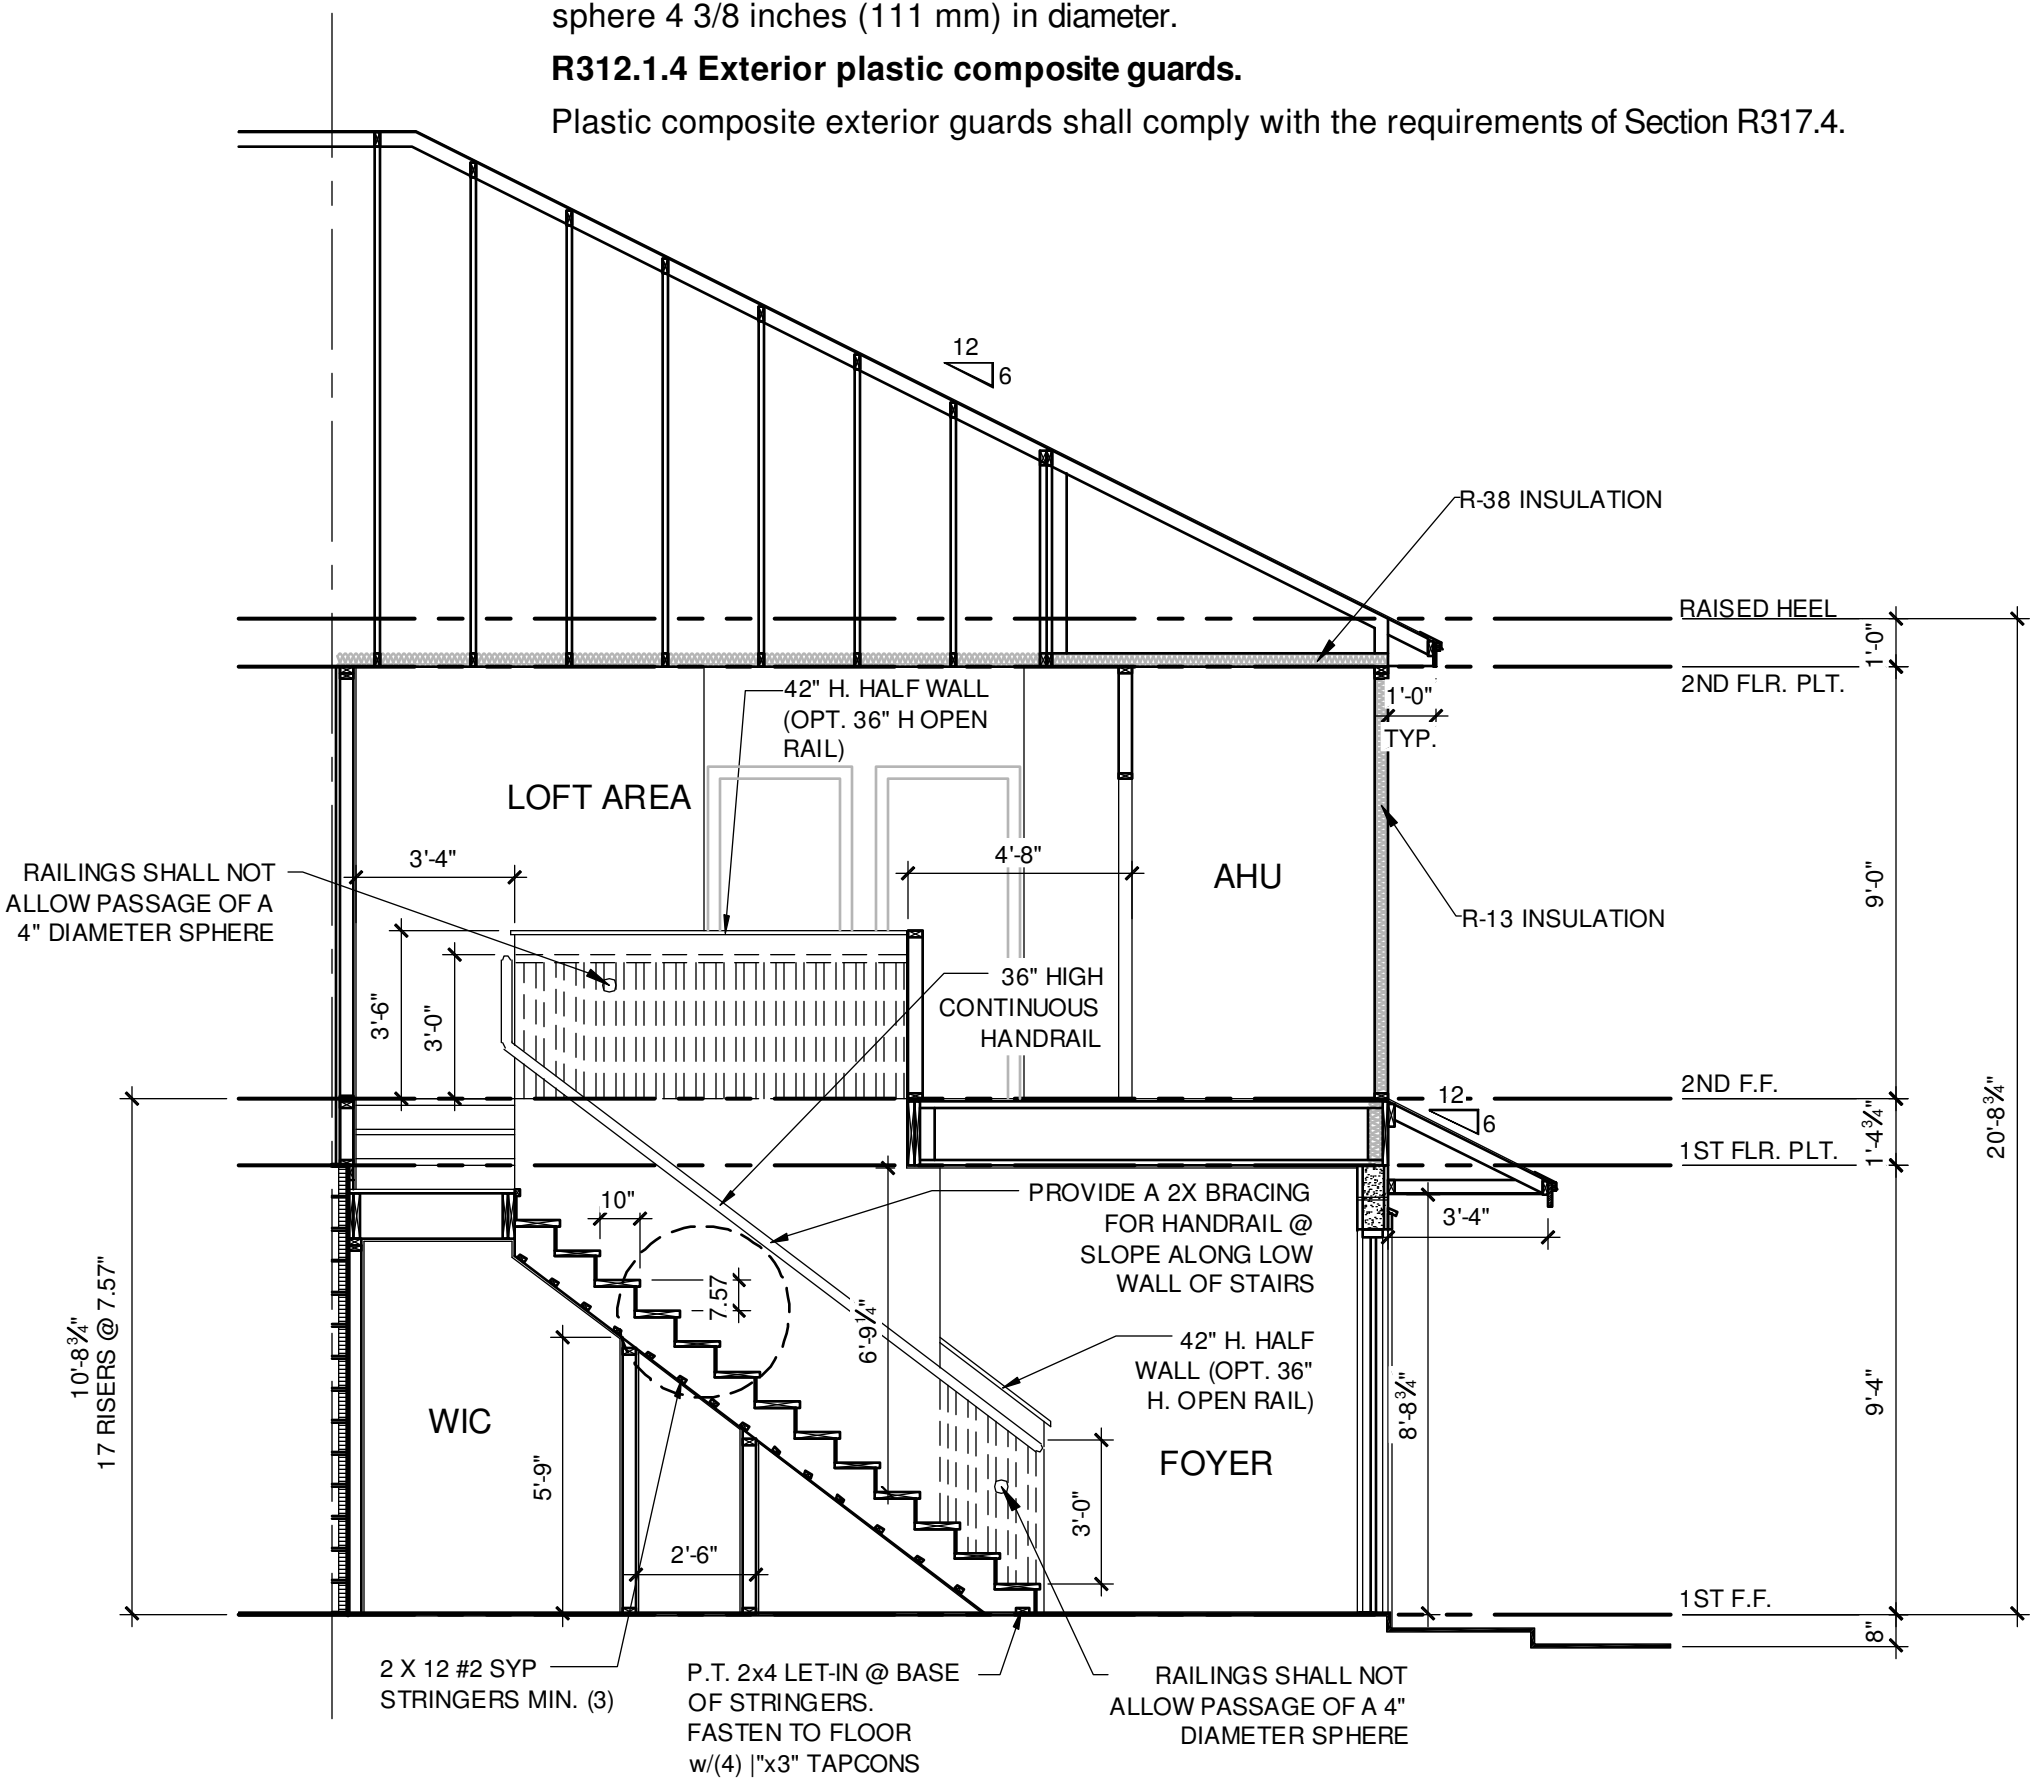


FIRESTOPPING BETWEEN STAIR  
STRINGERS AT LEAST ONCE IN THE  
MIDDLE OF EACH RUN, AT THE TOP &  
BOTTOM & BETWEEN STUDS ALONG &  
IN LINE W/ ADJACENT RUN OF STAIRS

### 2-STORY STAIR SECTION - 1914

1/4" = 1'-0"

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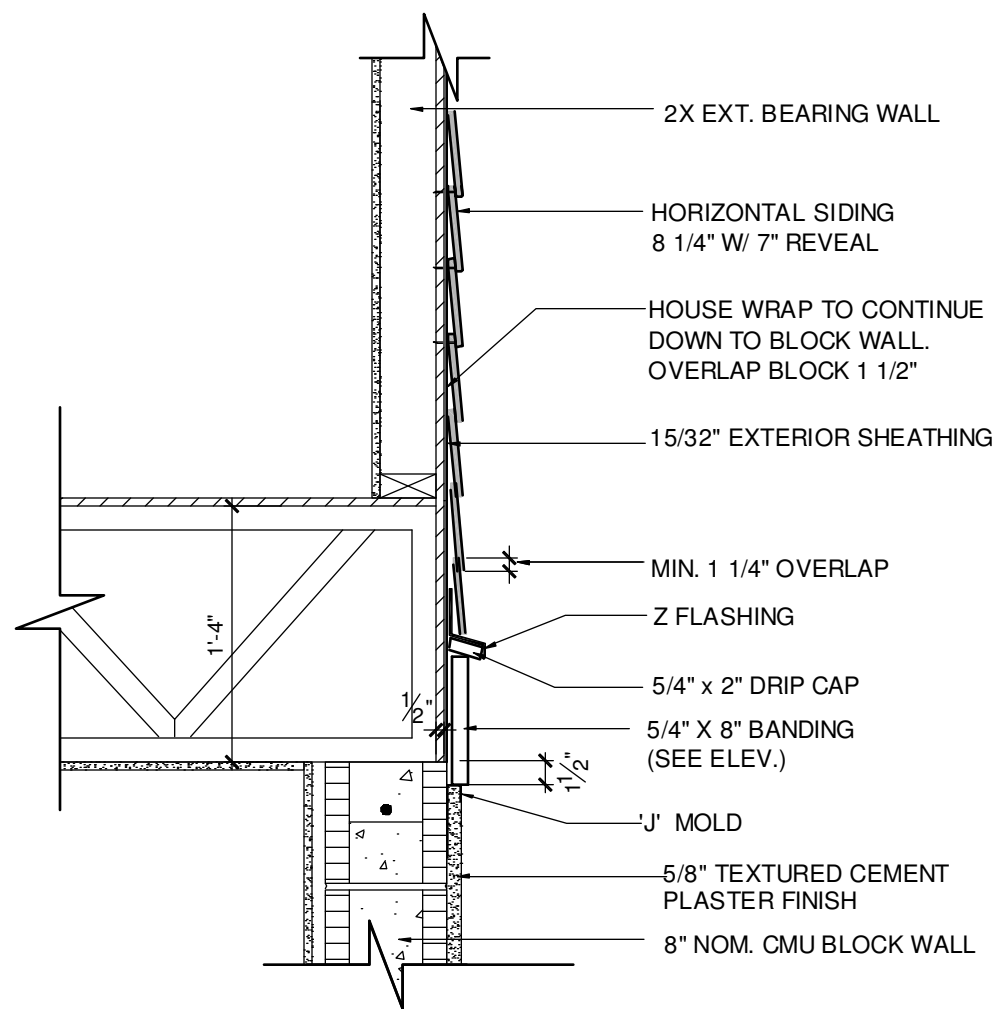


PARK SQUARE  
HORIZONS WEST  
BABCOCK RANCH BLDG 6 (LOTS 6092-6099) 4 UNIT

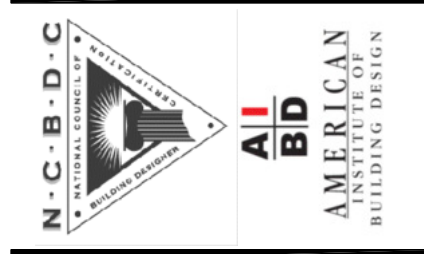1914 - ADAMS  
STAIR SECTION

project no. 2023083  
checked: BF  
drawn: BA  
date: 04-12-23  
scale: AS SHOWN

2.0A  
ELEV. A



### BELLY BAND TRIM DETAIL AT T.O.M.

ABV. SMOOTH  
SAND FINISH  
SCALE: 1" = 1'-0"

## UNIT 6090 1840 JEFFERSON

ALL GUARDRAILS AND  
HANDRAILS TO COMPLY  
WITH R301 AND TABLE  
R301.5 PER FBCR 2020,  
7TH EDITION

#### 2020 FBCR :

##### R312.1 Guards.

Guards shall be provided in accordance with Sections R312.1.1 through R312.1.4.

##### R312.1.1 Where required.

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1. Guards on the open sides of stairs shall have a height not less than 34 inches (864 mm) measured vertically from a line connecting the leading edges of the treads.

2. Where the top of the guard serves as a handrail on the open sides of stairs, the top of the guard shall not be less than 34 inches (864 mm) and not more than 38 inches (965 mm) as measured vertically from a line connecting the leading edges of the treads.

##### R312.1.3 Opening limitations.

Required guards shall not have openings from the walking surface to the required guard height which allow passage of a sphere 4 inches (102 mm) in diameter.


##### Exceptions:

1. The triangular openings at the open side of stair, formed by the riser, tread and bottom rail of a guard, shall not allow passage of a sphere 6 inches (153 mm) in diameter.

2. Guards on the open side of stairs shall not have openings which allow passage of a sphere 4 3/8 inches (111 mm) in diameter.

##### R312.1.4 Exterior plastic composite guards.

Plastic composite exterior guards shall comply with the requirements of Section R317.4.

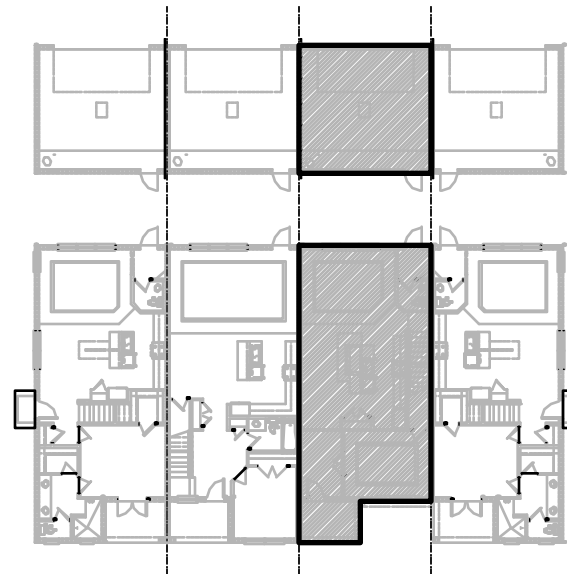

## SECTION - KEY PLAN

1/32" = 1'-0"

#### 2020 FBCR:

##### R311.7.5.1 Risers.

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##### R311.7.5.3 Nosings.

Nosings at treads, landings and floors of stairways shall have a radius of curvature at the nosing not greater than 9/16 inch (14mm) or a bevel not exceeding 1/2 inch (12.7mm). A nosing projection not less than 3/4 inch (19mm) and not more than 1 1/4 inch (32mm) shall be provided on stairways. The greatest nosing projection shall not exceed the smallest nosing projection by more than 3/8 inch (9.5mm) within a stairway.

##### R311.7.8 Handrails.

Handrails shall be provided on not less than one side of each flight with four or more risers.

##### R311.7.8.1 Height.

Handrail height, measured vertically from the sloped plane adjoining the tread nosing, or finish surface of ramp slope, shall be not less than 34 inches (864 mm) and not more than 38 inches (965 mm).

##### R311.7.8.2 Continuity.


Handrails for stairways shall be continuous for the full length of the flight, from a point directly above the top riser of the flight to a point directly above the lowest riser of the flight. Handrail ends shall be returned or shall terminate in newel posts or safety terminals. Handrails adjacent to a wall shall have a space of not less than 1 1/2 inch (38 mm) between the wall and the handrails.

##### R311.7.8.3 Grip-size.

Required handrails shall be one of the following types or provide equivalent graspability.

1. Type I. Handrails with a circular cross section shall have an outside diameter of not less than 1 1/4 inches (32 mm) and not greater than 2 inches (51 mm). If the handrail is not circular, it shall have a perimeter dimension of not less than 4 inches (102 mm) and not greater than 6 1/4 inches (160 mm) with a cross section of dimension of not less than 2 1/4 inches (57 mm). Edges shall have a radius of not less than 0.01 inch (0.25 mm).

2. Type II. Handrails with a perimeter greater than 6 1/4 inches (160 mm) shall have a graspable finger recess area on both sides of the profile. The finger recess shall begin within a distance of 3/4 inch (19 mm) measured vertically from the tallest portion of the profile and achieve a depth of no less than 5/16 inch (8 mm) within 7/8 inch (22 mm) below the widest portion of the profile. This required depth shall continue for not less than 3/8 inch (10 mm) to a level that is not less than 1 3/4 inches (45 mm) below the tallest portion of the profile. The width of the handrail above the recess shall be not less than 1 1/4 inches (32 mm) and not more than 2 3/4 inches (70 mm). Edges shall have a radius of not less than 0.01 inch (0.25 mm).

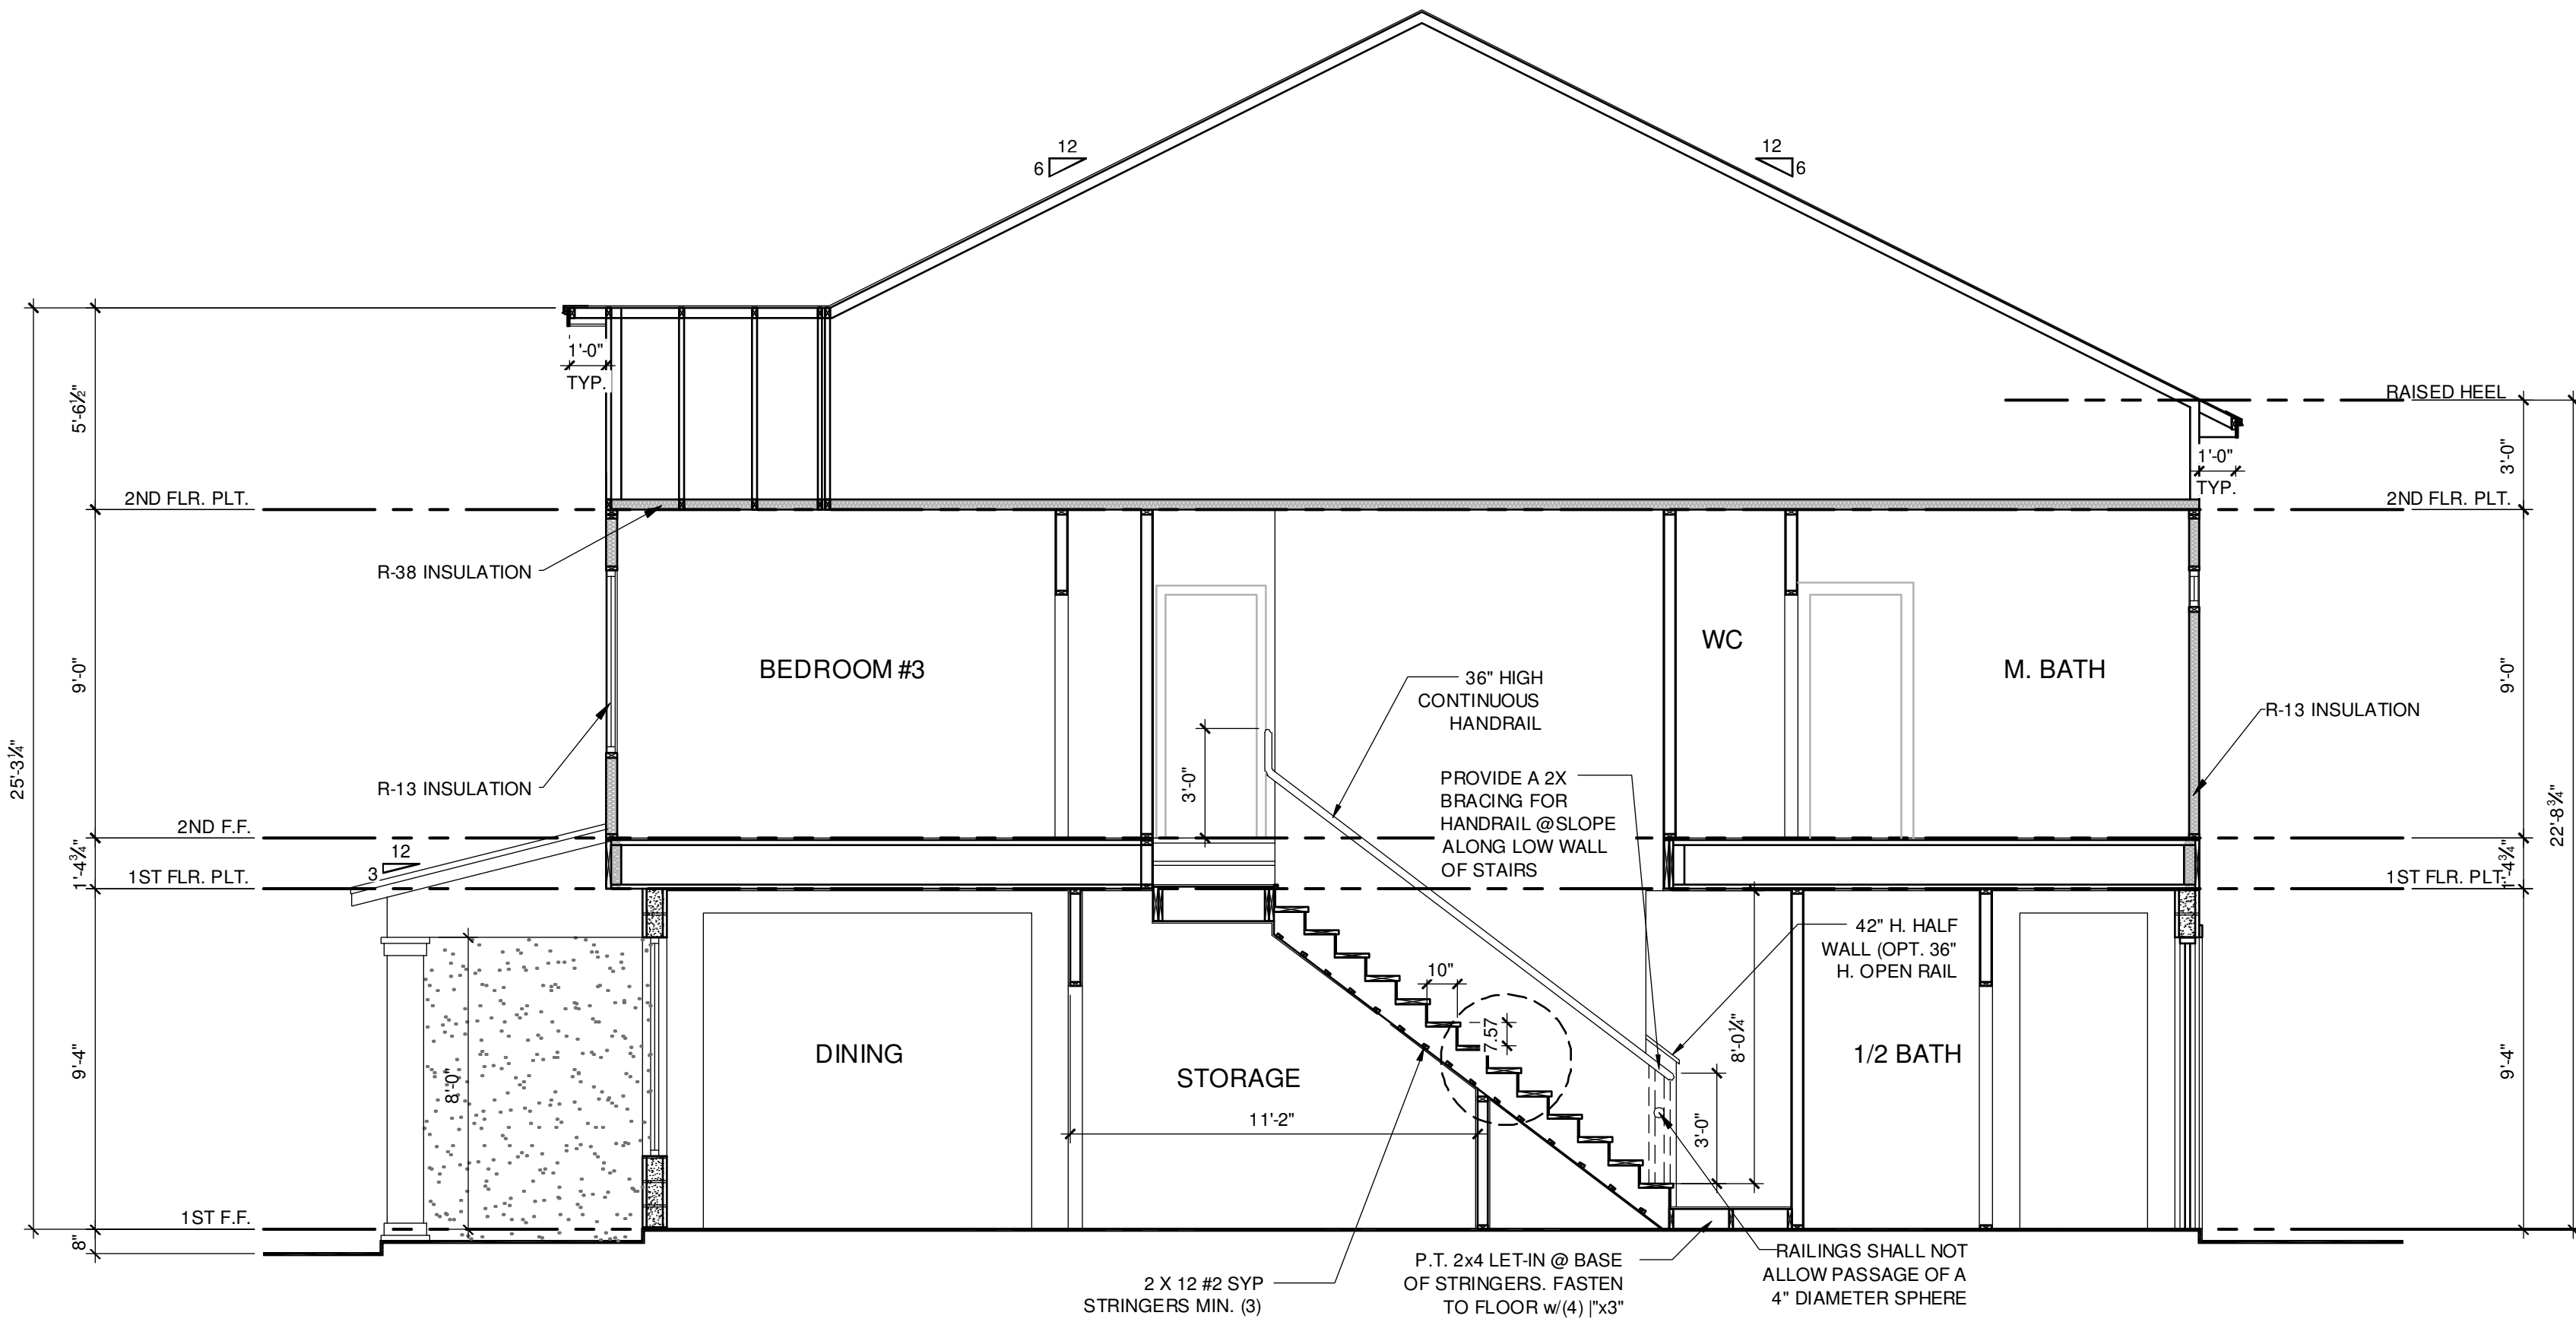

A

## 2-STORY STAIR SECTION - 1840

1/4" = 1'-0"

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title:

1840 - JEFFERSON  
STAIR SECTION

project no. 2023083

checked: BF



drawn: BA

date: 04-12-23

scale: AS SHOWN

2.0B  
ELEV. A


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FDS JOB NO.:

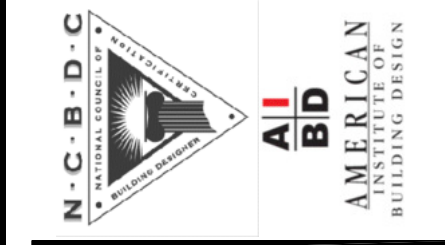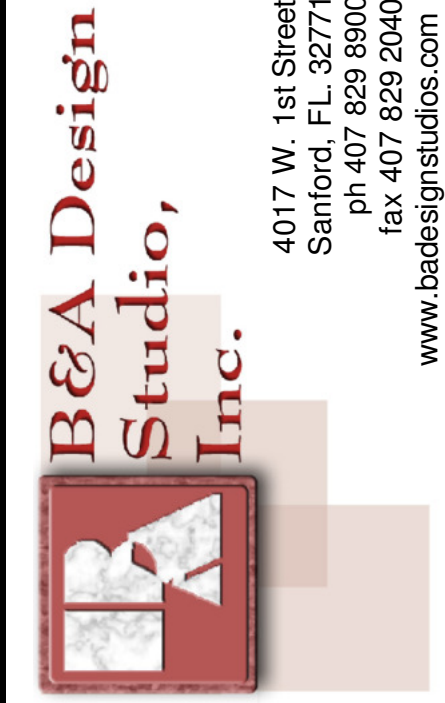PARK SQUARE  
HORIZONS WEST  
BABCOCK RANCH BLDG 6 (LOTS 6092-6099) 4 UNIT

NOTE: DRAWINGS ON 11"x17" SHEET WILL BE ONE HALF THE SCALE NOTED



**B** BELLY BAND TRIM  
DETAIL AT T.O.M.  
ABV. SMOOTH SAND FINISH  
SCALE: 1" = 1'-0"

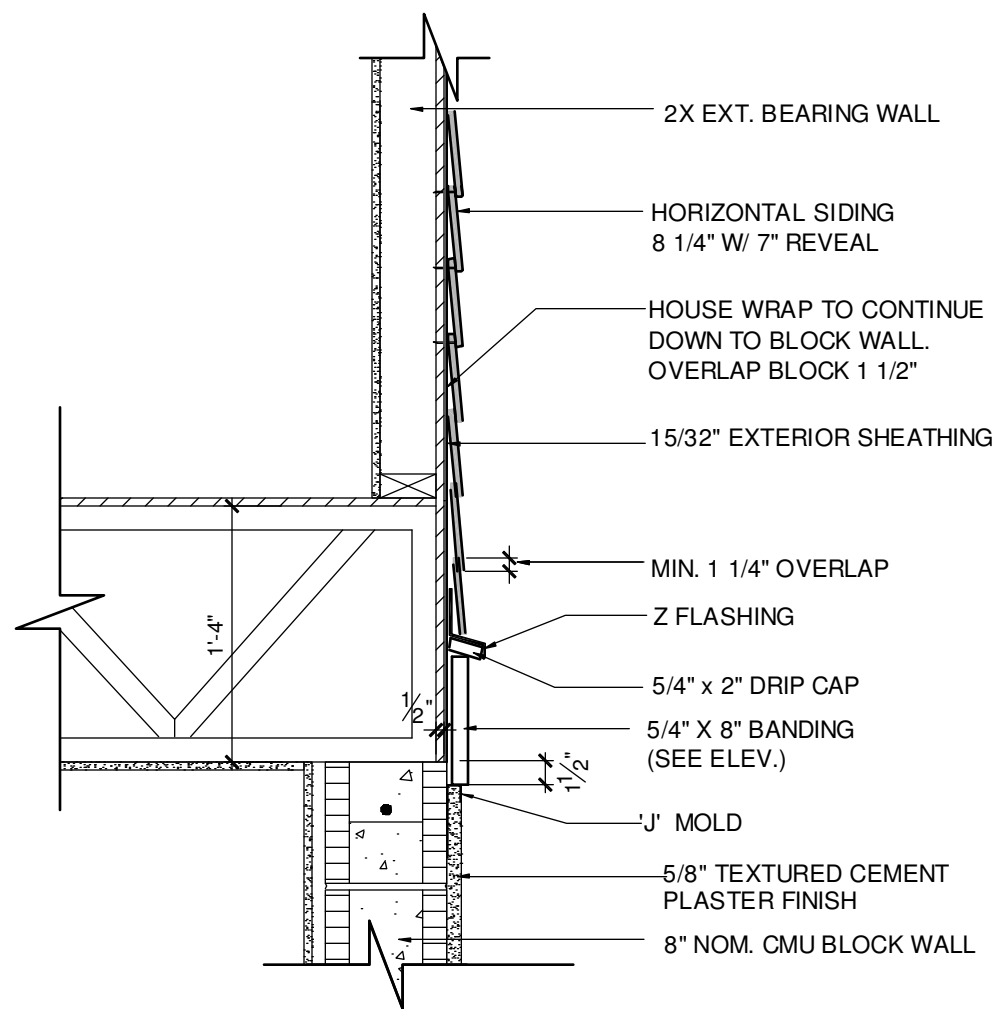UNIT 6091 2024 MADISON

ALL GUARDRAILS AND HANDRAILS TO COMPLY WITH R301 AND TABLE R301.5 PER FBCR 2020, 7TH EDITION

2020 FBCR :

**R312.1 Guards.**  
Guards shall be provided in accordance with Sections R312.1.1 through R312.1.4.

**R312.1.1 Where required.**  
Guards shall be provided for those portions of open-sided walking surfaces, including stairs, ramps and landings, that are located more than 30 inches (762 mm) measured vertically to the floor or grade below at any point within 24 inches (914 mm) horizontally to the edge of the open side. Insect screening shall not be considered as a guard.

**R312.1.2 Height.**  
Required guards at open-sided walking surfaces, including stairs, porches, balconies or landings, shall be not less than 36 inches (914 mm) in height as measured vertically above the adjacent walking surface or the line connecting the leading edges of the treads.

**Exceptions:**

1. Guards on the open sides of stairs shall have a height not less than 34 inches (864 mm) measured vertically from a line connecting the leading edges of the treads.

2. Where the top of the guard serves as a handrail on the open sides of stairs, the top of the guard shall not be less than 34 inches (864 mm) and not more than 38 inches (965 mm) as measured vertically from a line connecting the leading edges of the treads.


**R312.1.3 Opening limitations.**  
Required guards shall not have openings from the walking surface to the required guard height which allow passage of a sphere 4 inches (102 mm) in diameter.

**Exceptions:**

1. The triangular openings at the open side of stair, formed by the riser, tread and bottom rail of a guard, shall not allow passage of a sphere 6 inches (153 mm) in diameter.

2. Guards on the open side of stairs shall not have openings which allow passage of a sphere 4 3/8 inches (111 mm) in diameter.

**R312.1.4 Exterior plastic composite guards.**  
Plastic composite exterior guards shall comply with the requirements of Section R317.4.

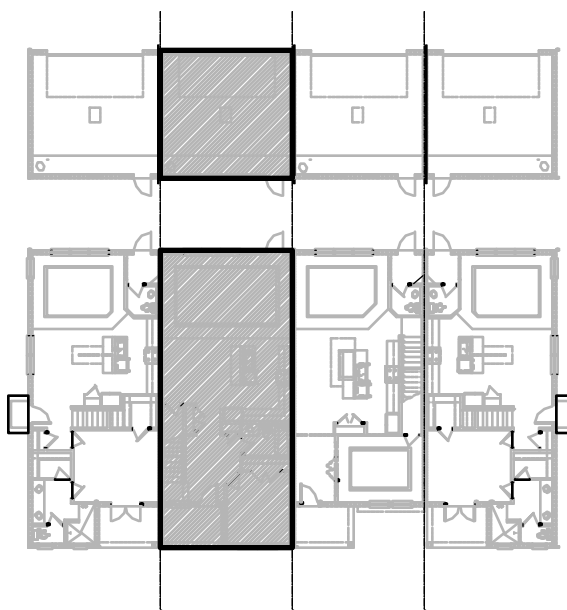

SECTION - KEY PLAN  
1/32" = 1'-0"

2020 FBCR:

**R311.7.5.1 Risers.**  
The riser height shall be not more than 7 3/4 inches (196 mm). The riser shall be measured vertically between leading edges of the adjacent treads. The greatest riser height within any flight of stairs shall not exceed the smallest by more than 3/8 inch (9.5 mm). Risers shall be vertical or sloped from the underside of the nosing of the tread above at an angle not more than 30 degrees (0.51 rad) from the vertical. Open risers are permitted provided that the opening located more than 30 inches (762mm), as measured vertically, to the floor or grade below do not permit the passage of a 4 inch diameter (102mm) sphere.

**R311.7.5.2 Treads.**  
The tread depth shall be not less than 10 inches (254 mm). The tread depth shall be measured horizontally between the vertical planes of the foremost projection of adjacent treads and at a right angle to the tread's leading edge. The greatest tread depth within any flight of stairs shall not exceed the smallest by more than 3/8 inch (9.5 mm).

**R311.7.5.2.1 Winder treads.**  
Winder treads shall have a tread depth of not less than 10 inches (254 mm) measured between the vertical planes of the foremost projection of adjacent treads at the intersections with the walkline. Winder treads shall have a tread depth of not less than 6 inches (152 mm) at any point within the clear width of the stair. Within any flight of stairs, the largest winder tread depth at the walkline shall not exceed the smallest winder tread by more than 3/8 inch (9.5 mm). Consistently shaped winders at the walkline shall be allowed within the same flight of stairs as rectangular treads and do not have to be within 3/8 inch (9.5 mm) of the rectangular tread depth.

**R311.7.5.3 Nosings.**  
Nosings at treads, landings and floors of stairways shall have a radius of curvature at the nosing not greater than 9/16 inch (14mm) or a bevel not exceeding 1/2 inch (12.7mm). A nosing projection not less than 3/4 inch (19mm) and not more than 1 1/4 inch (32mm) shall be provided on stairways. The greatest nosing projection shall not exceed the smallest nosing projection by more than 3/8 inch (9.5mm) within a stairway.

**R311.7.8 Handrails.**  
Handrails shall be provided on not less than one side of each flight with four or more risers.


**R311.7.8.1 Height.**  
Handrail height, measured vertically from the sloped plane adjoining the tread nosing, or finish surface of ramp slope, shall be not less than 34 inches (864 mm) and not more than 38 inches (965 mm).

**R311.7.8.2 Continuity.**  
Handrails for stairways shall be continuous for the full length of the flight, from a point directly above the top riser of the flight to a point directly above the lowest riser of the flight. Handrail ends shall be returned or shall terminate in newel posts or safety terminals. Handrails adjacent to a wall shall have a space of not less than 1 1/2 inch (38 mm) between the wall and the handrails.

**R311.7.8.3 Grip-size.**  
Required handrails shall be one of the following types or provide equivalent graspability.

1. Type I. Handrails with a circular cross section shall have an outside diameter of not less than 1 1/4 inches (32 mm) and not greater than 2 inches (51 mm). If the handrail is not circular, it shall have a perimeter dimension of not less than 4 inches (102 mm) and not greater than 6 1/4 inches (160 mm) with a cross section of dimension of not less than 2 1/4 inches (57 mm). Edges shall have a radius of not less than 0.01 inch (0.25 mm).


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**A** 2-STORY STAIR SECTION - 2024  
1/4" = 1'-0"
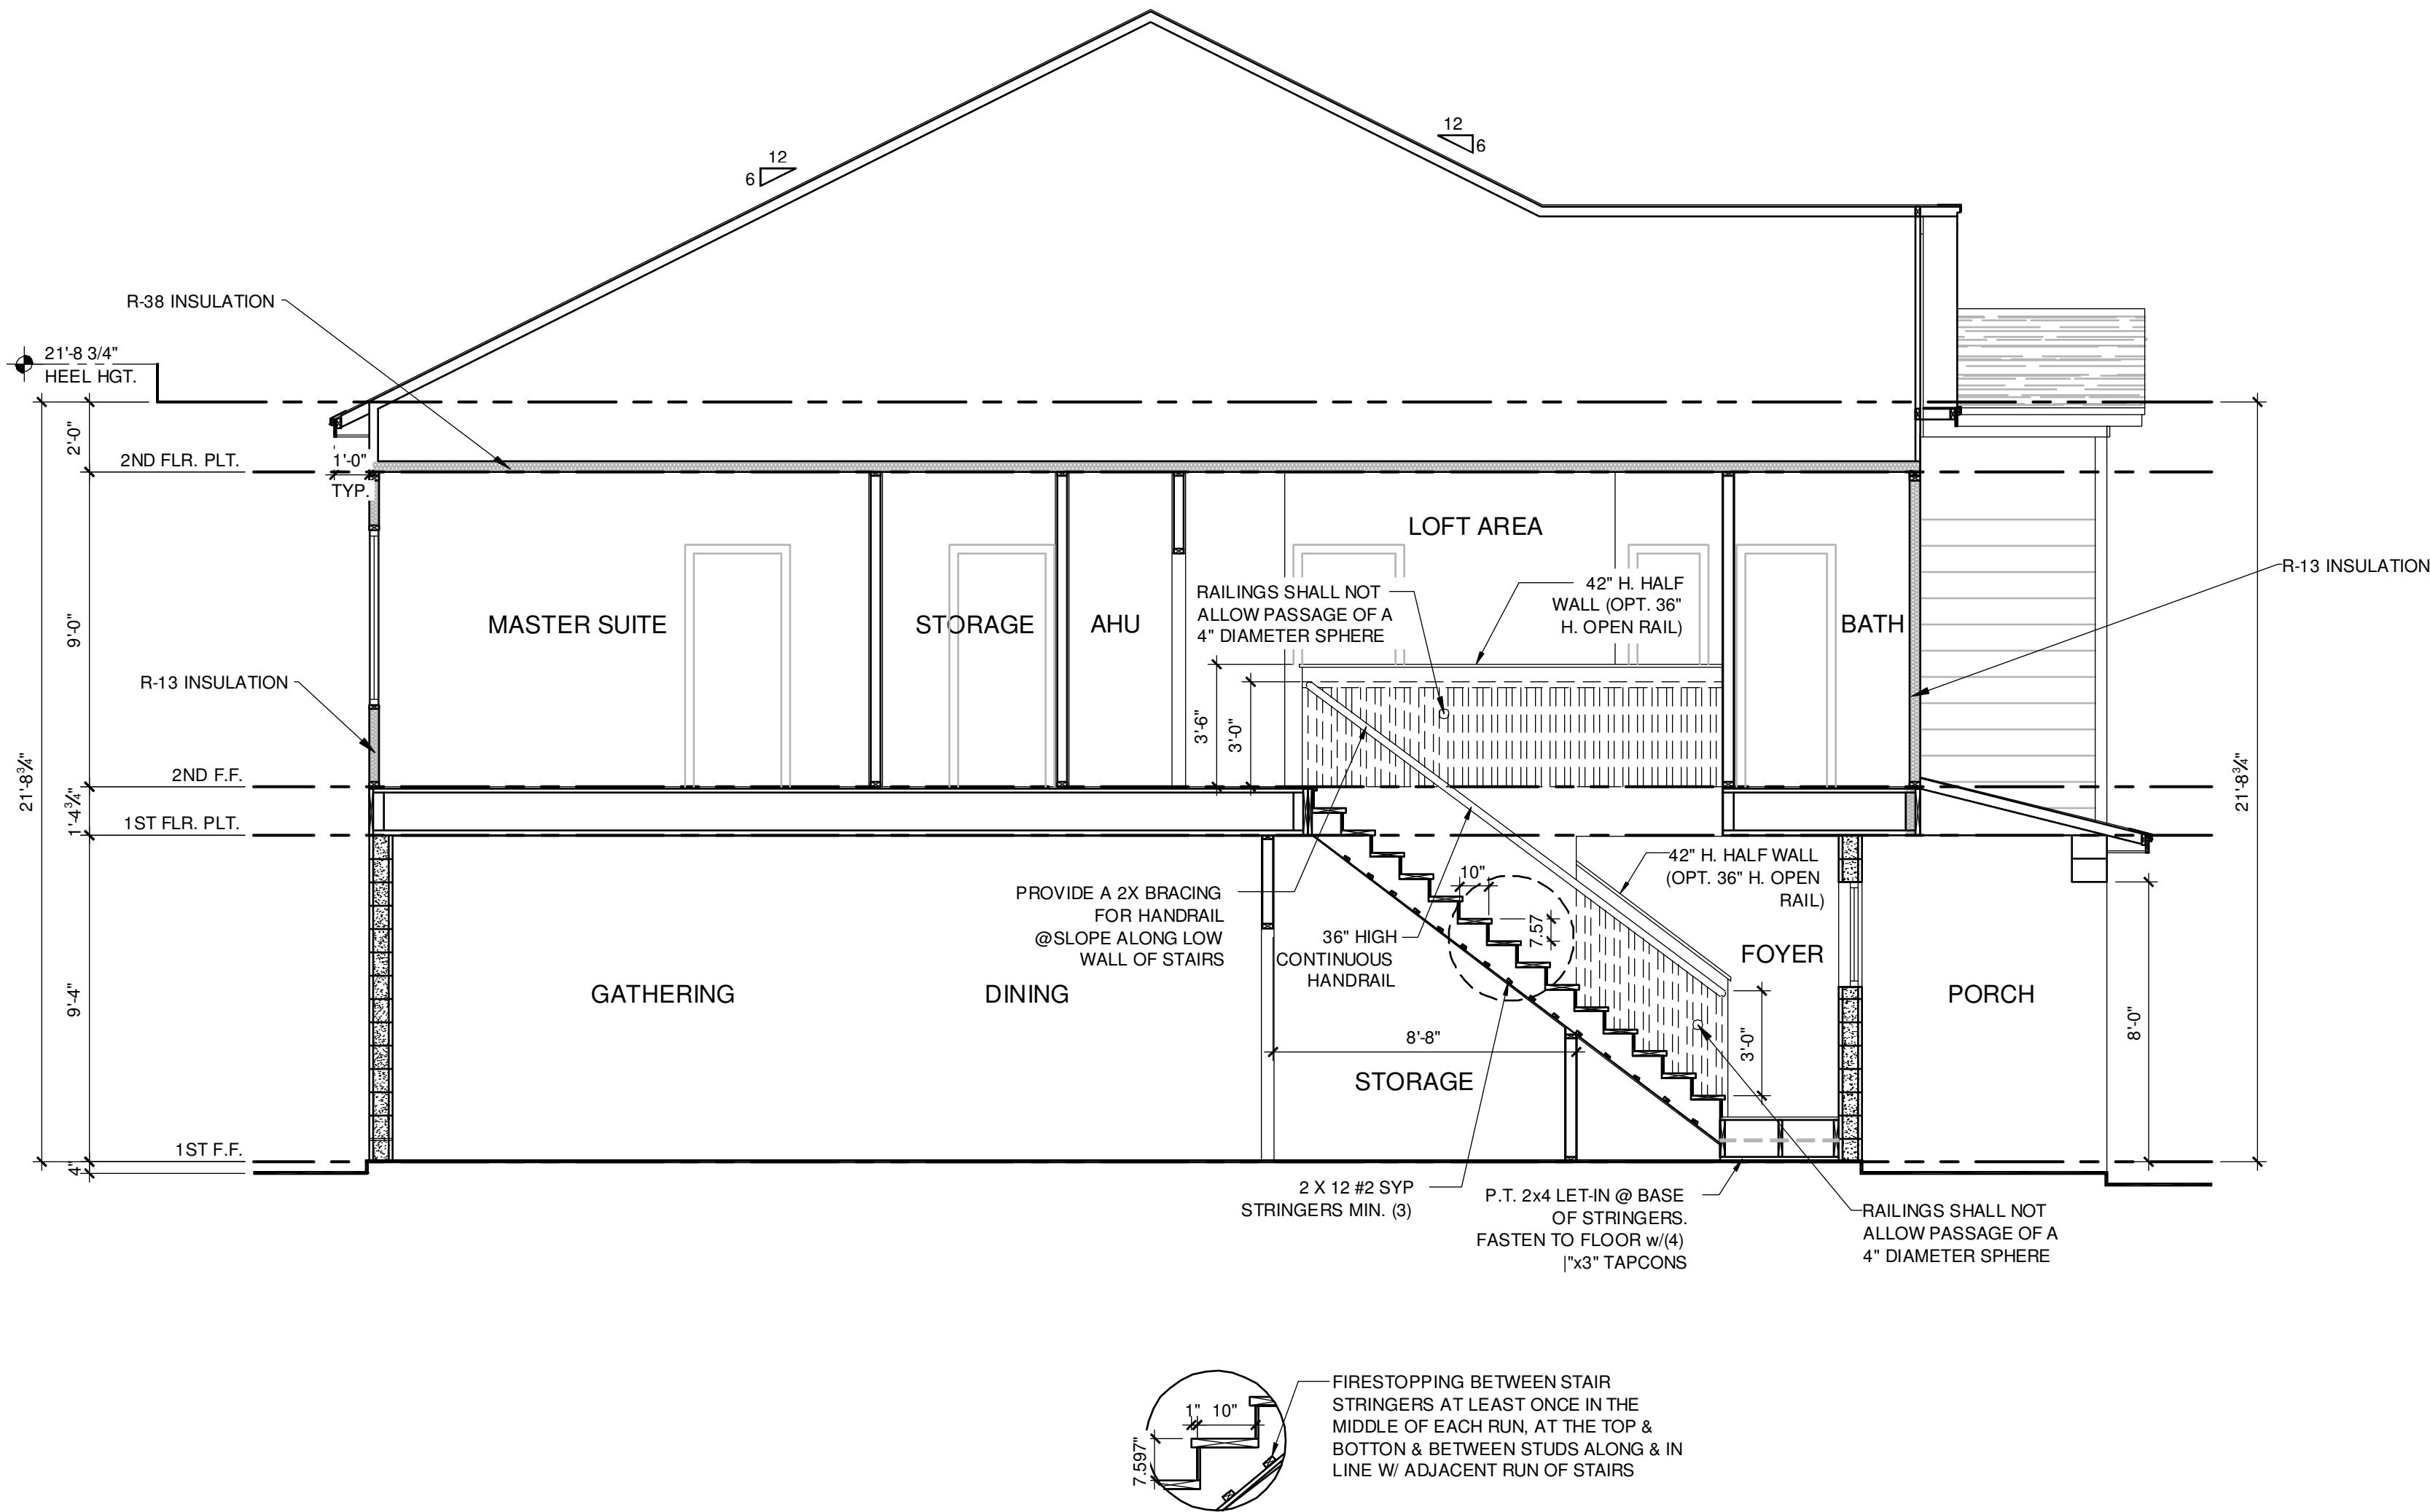
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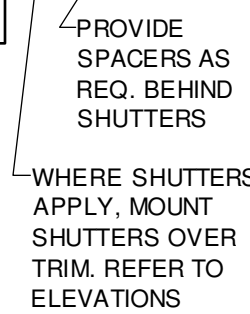
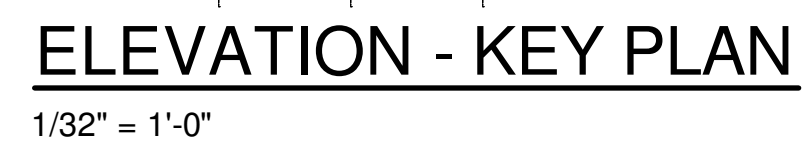


**FDS** ENGINEERING & ARCHITECTURE  
228 Southall Lane, Suite 200, Madison, FL 32751  
Phone: 407-829-8900  
Fax: 407-829-2040  
Email: info@fdseng.com  
www.fdseng.com  
DATE: April 14, 2023  
BY: Scott Lenowski, PE, License #78790  
FOR THE ARCHITECT'S REVIEW AND APPROVAL

**PARK SQUARE  
HORIZONS WEST  
BABCOCK RANCH BLDG 6 (LOTS 6092-6099) 4 UNIT**

project no. 2023083  
checked: BF  
drawn: BA  
date: 04-12-23  
scale: AS SHOWN  
**2.0C  
ELEV. A**

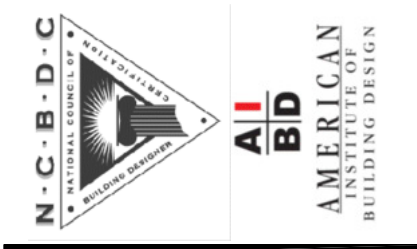
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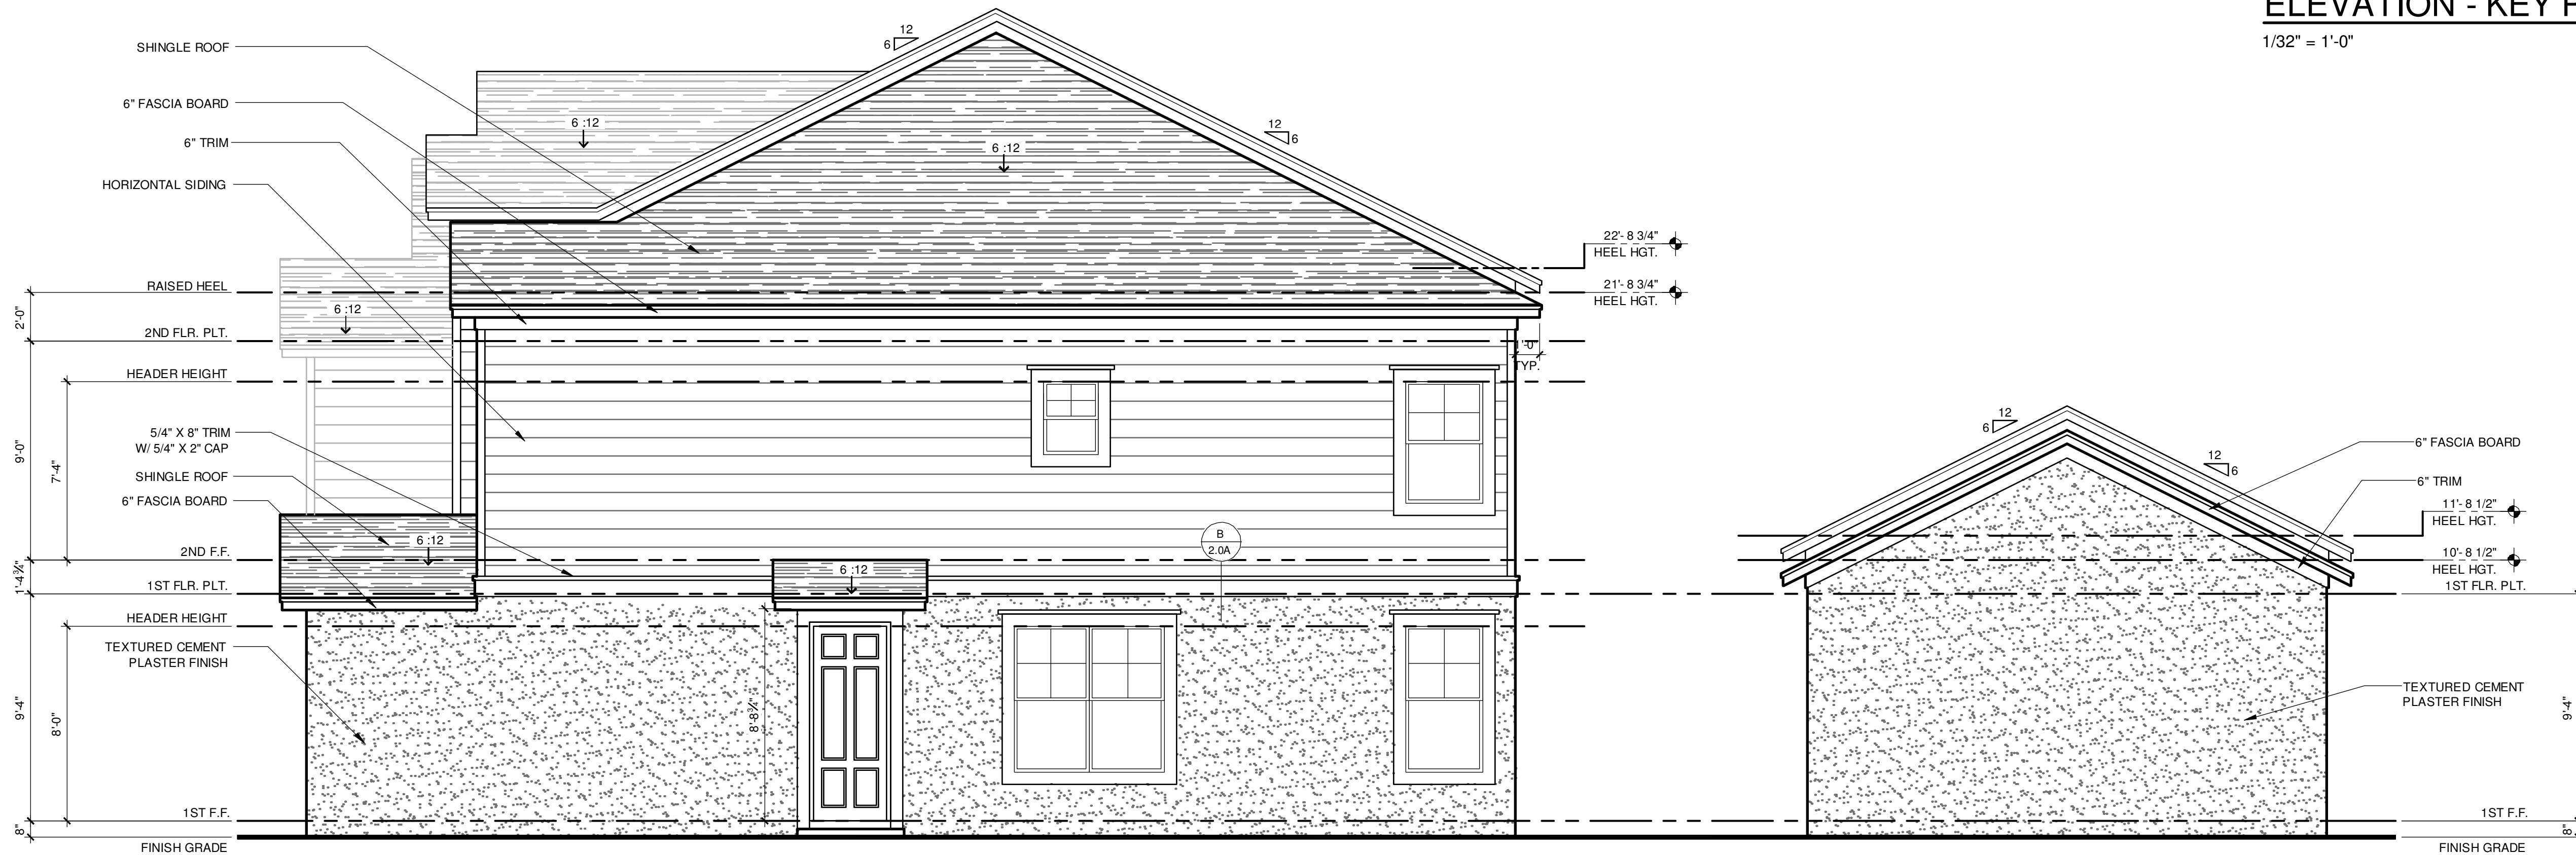
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UNIT 6089 1914 ADAMS





ELEVATION - KEY PLAN

1/32" = 1'-0"

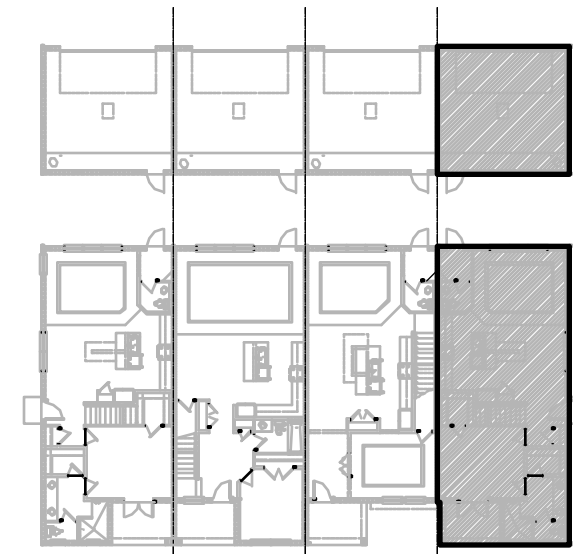

1914 - ADAMS  
RIGHT ELEVATION "A"

1/4" = 1'-0"

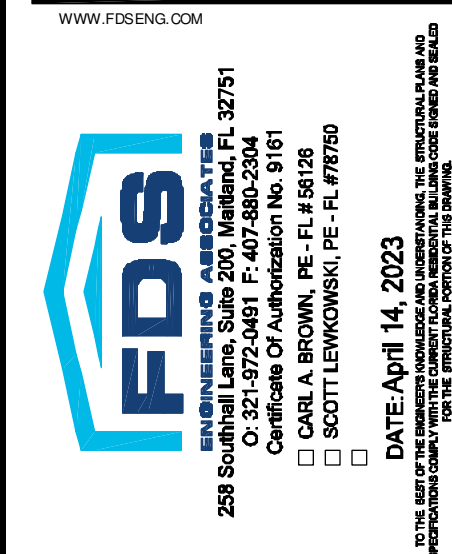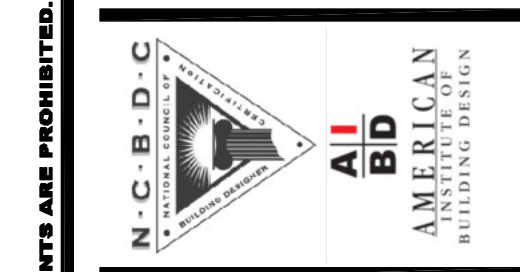

PARK SQUARE  
HORIZONS WEST  
BABCOCK RANCH BLDG 6 (LOTS 6082-6089) 4 UNIT

1914 - ADAMS  
EXT. ELEVATIONS

project no. 2023083  
checked: BF  
drawn: BA  
date: 04-12-23  
scale: AS SHOWN


2.2A  
ELEV. A

NOTE: DRAWINGS ON 11"x17" SHEET WILL BE ONE HALF THE SCALE NOTED

DISCLAIMER


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UNIT 6089 1914 ADAMS

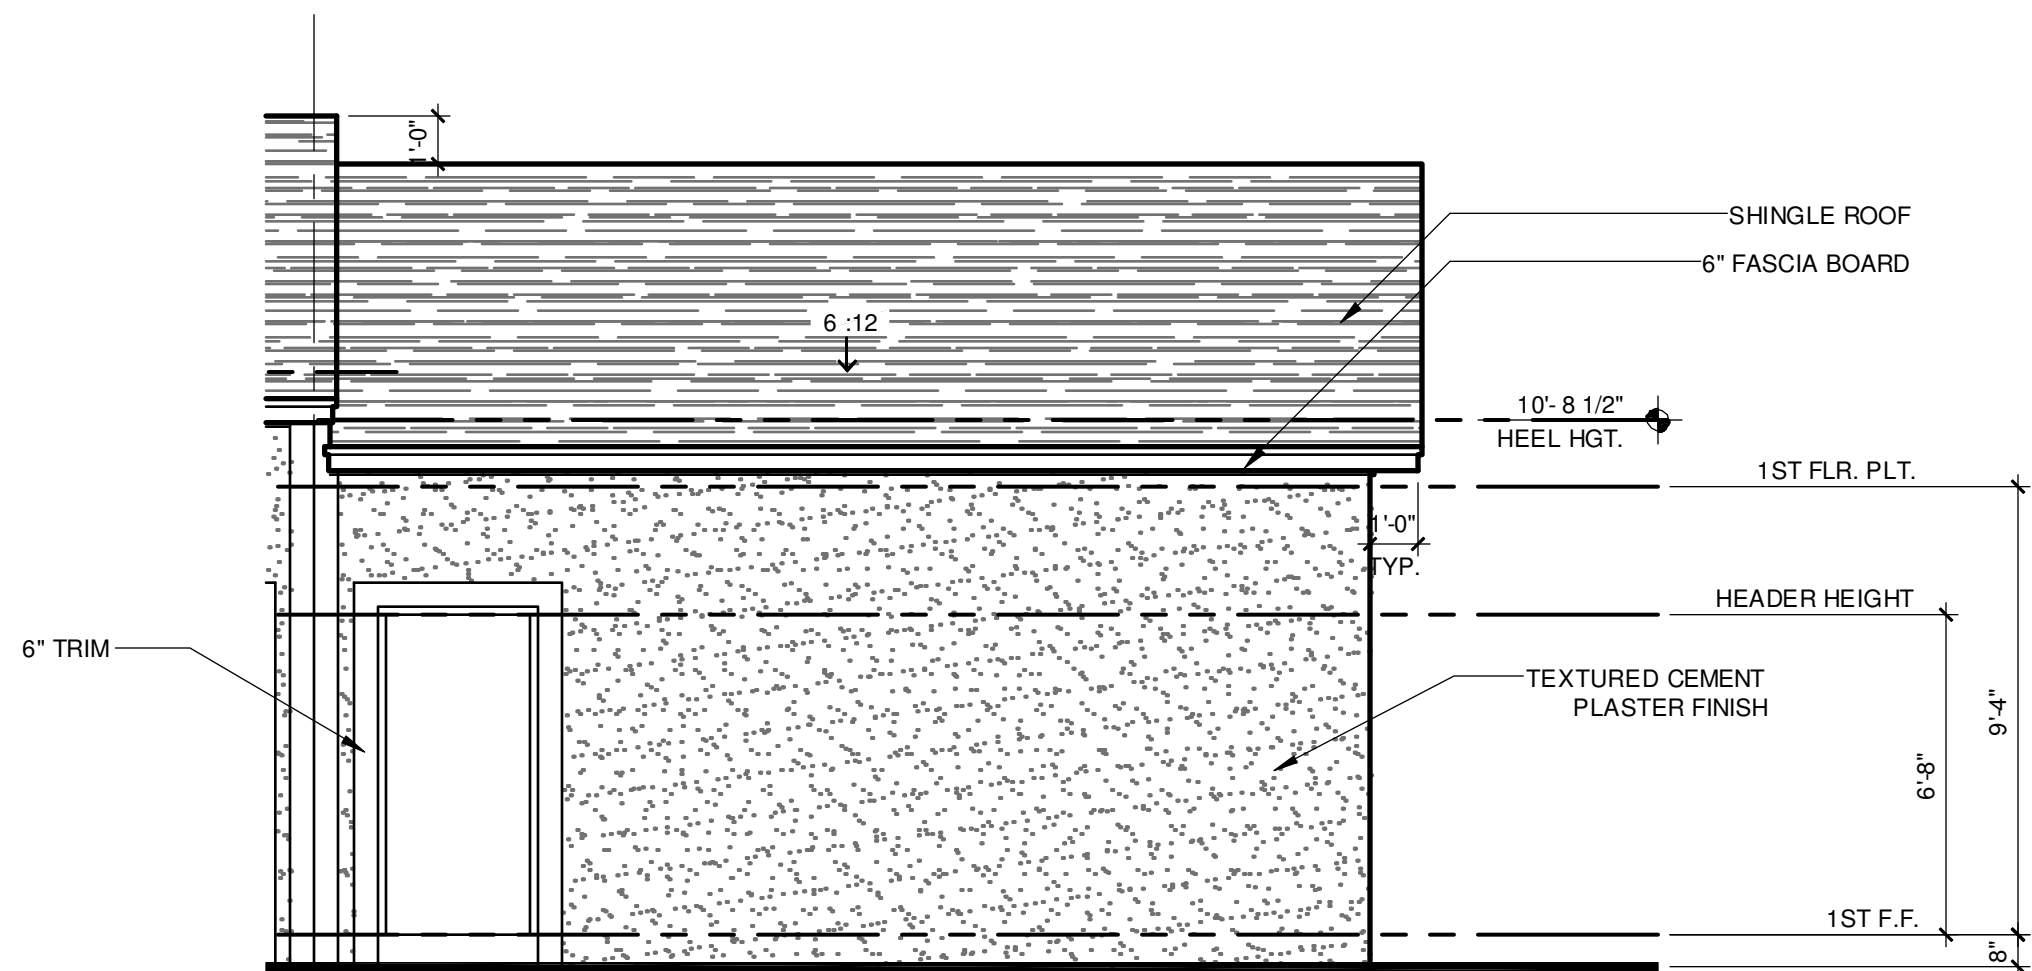


FRONT ELEVATION "A" - GARAGE

1/4" = 1'-0"

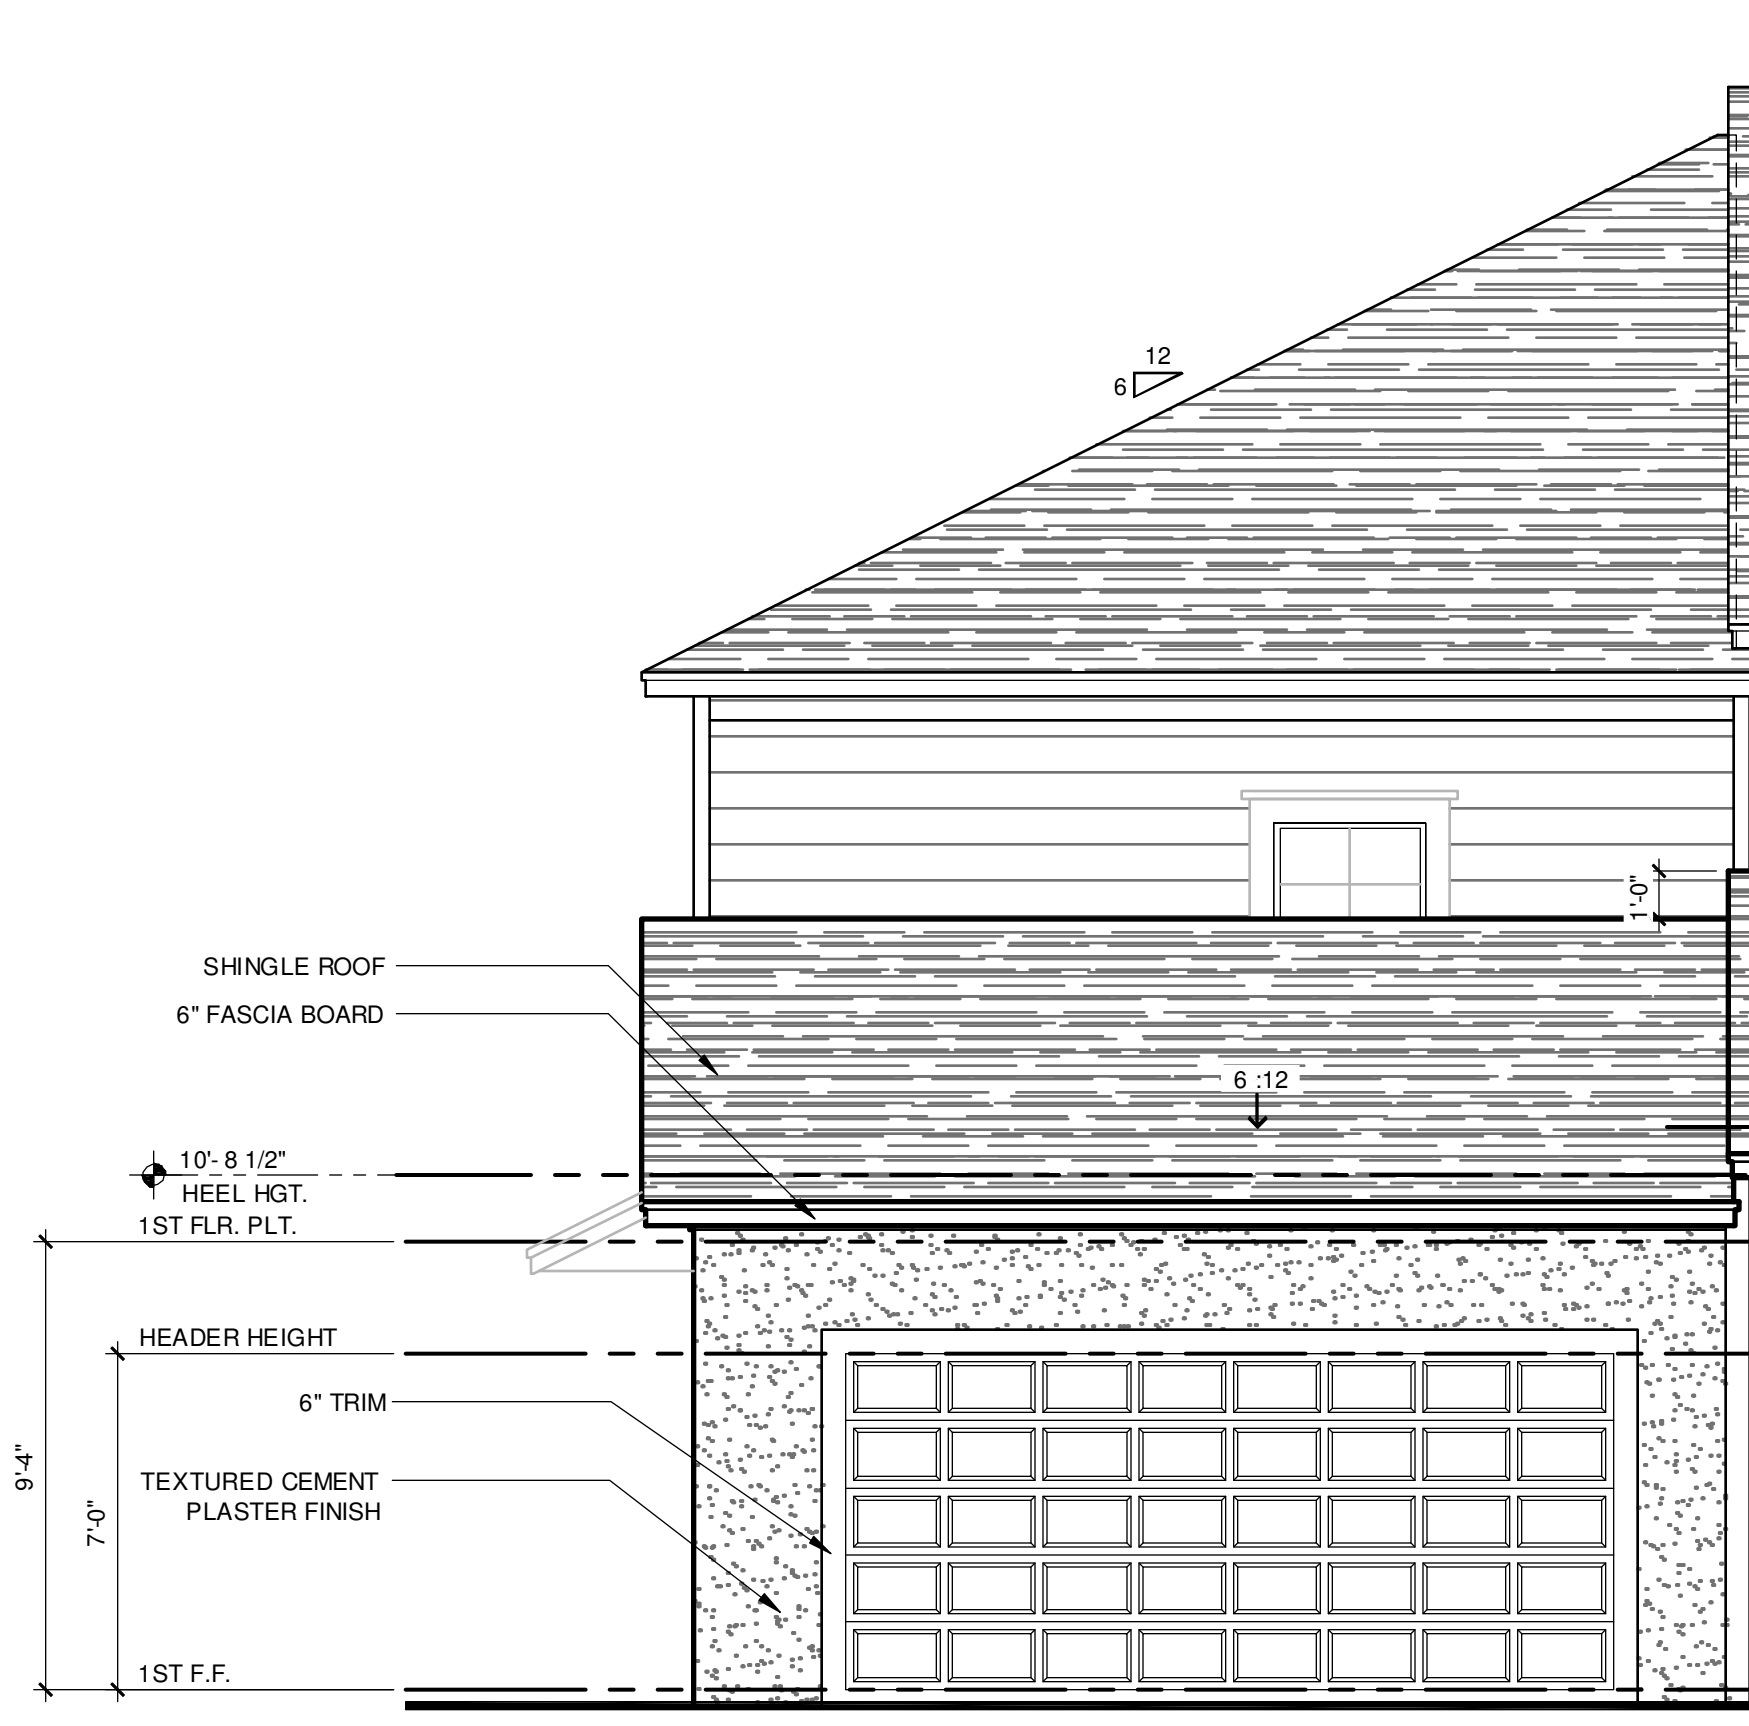

REAR ELEVATION "A" - GARAGE

1/4" = 1'-0"

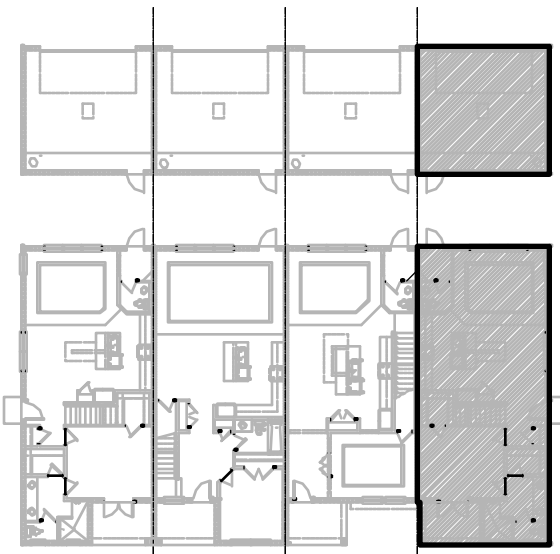

ELEVATION - KEY PLAN

1/32" = 1'-0"



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Office: 407.829.8900  
Cell: 407.829.8900  
Fax: 407.829.8900  
DATE: April 14, 2023

FDS JOB NO.:

PARK SQUARE  
HORIZONS WEST  
BABCOCK RANCH BLDG 6 (LOTS 6082-6089) 4 UNIT

title:  
1914 - ADAMS  
EXT. ELEVATIONS



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drawn: BA  
date: 04-12-23  
scale: AS SHOWN

2.3A  
ELEV. A


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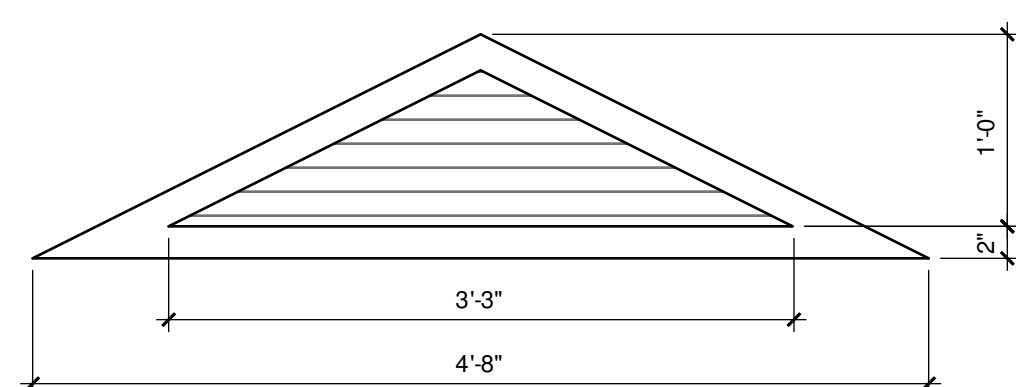
G.C. TO VERIFY  
FASCIA CALLOUT


$$1/32'' = 1'-0''$$


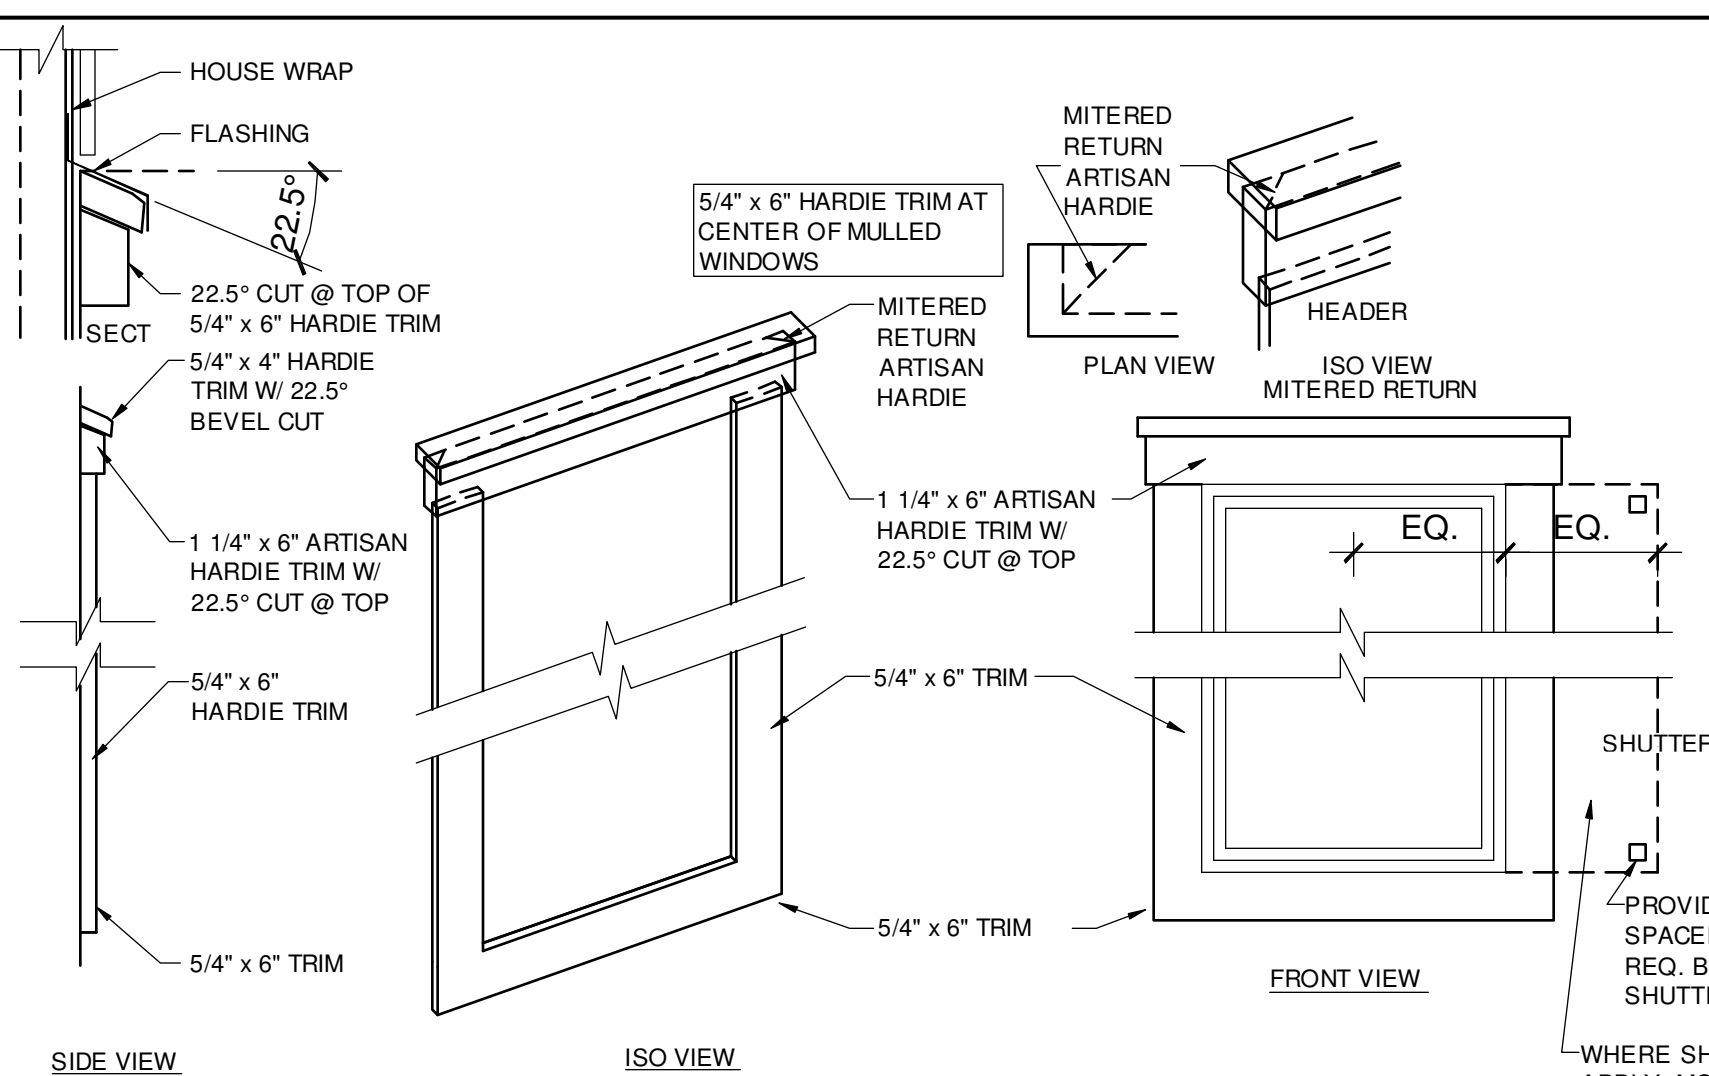
1840 - JEFFERSON  
FRONT ELEVATION "A"

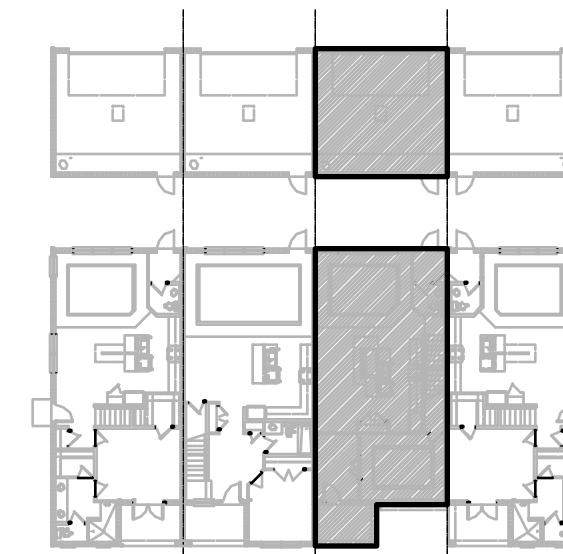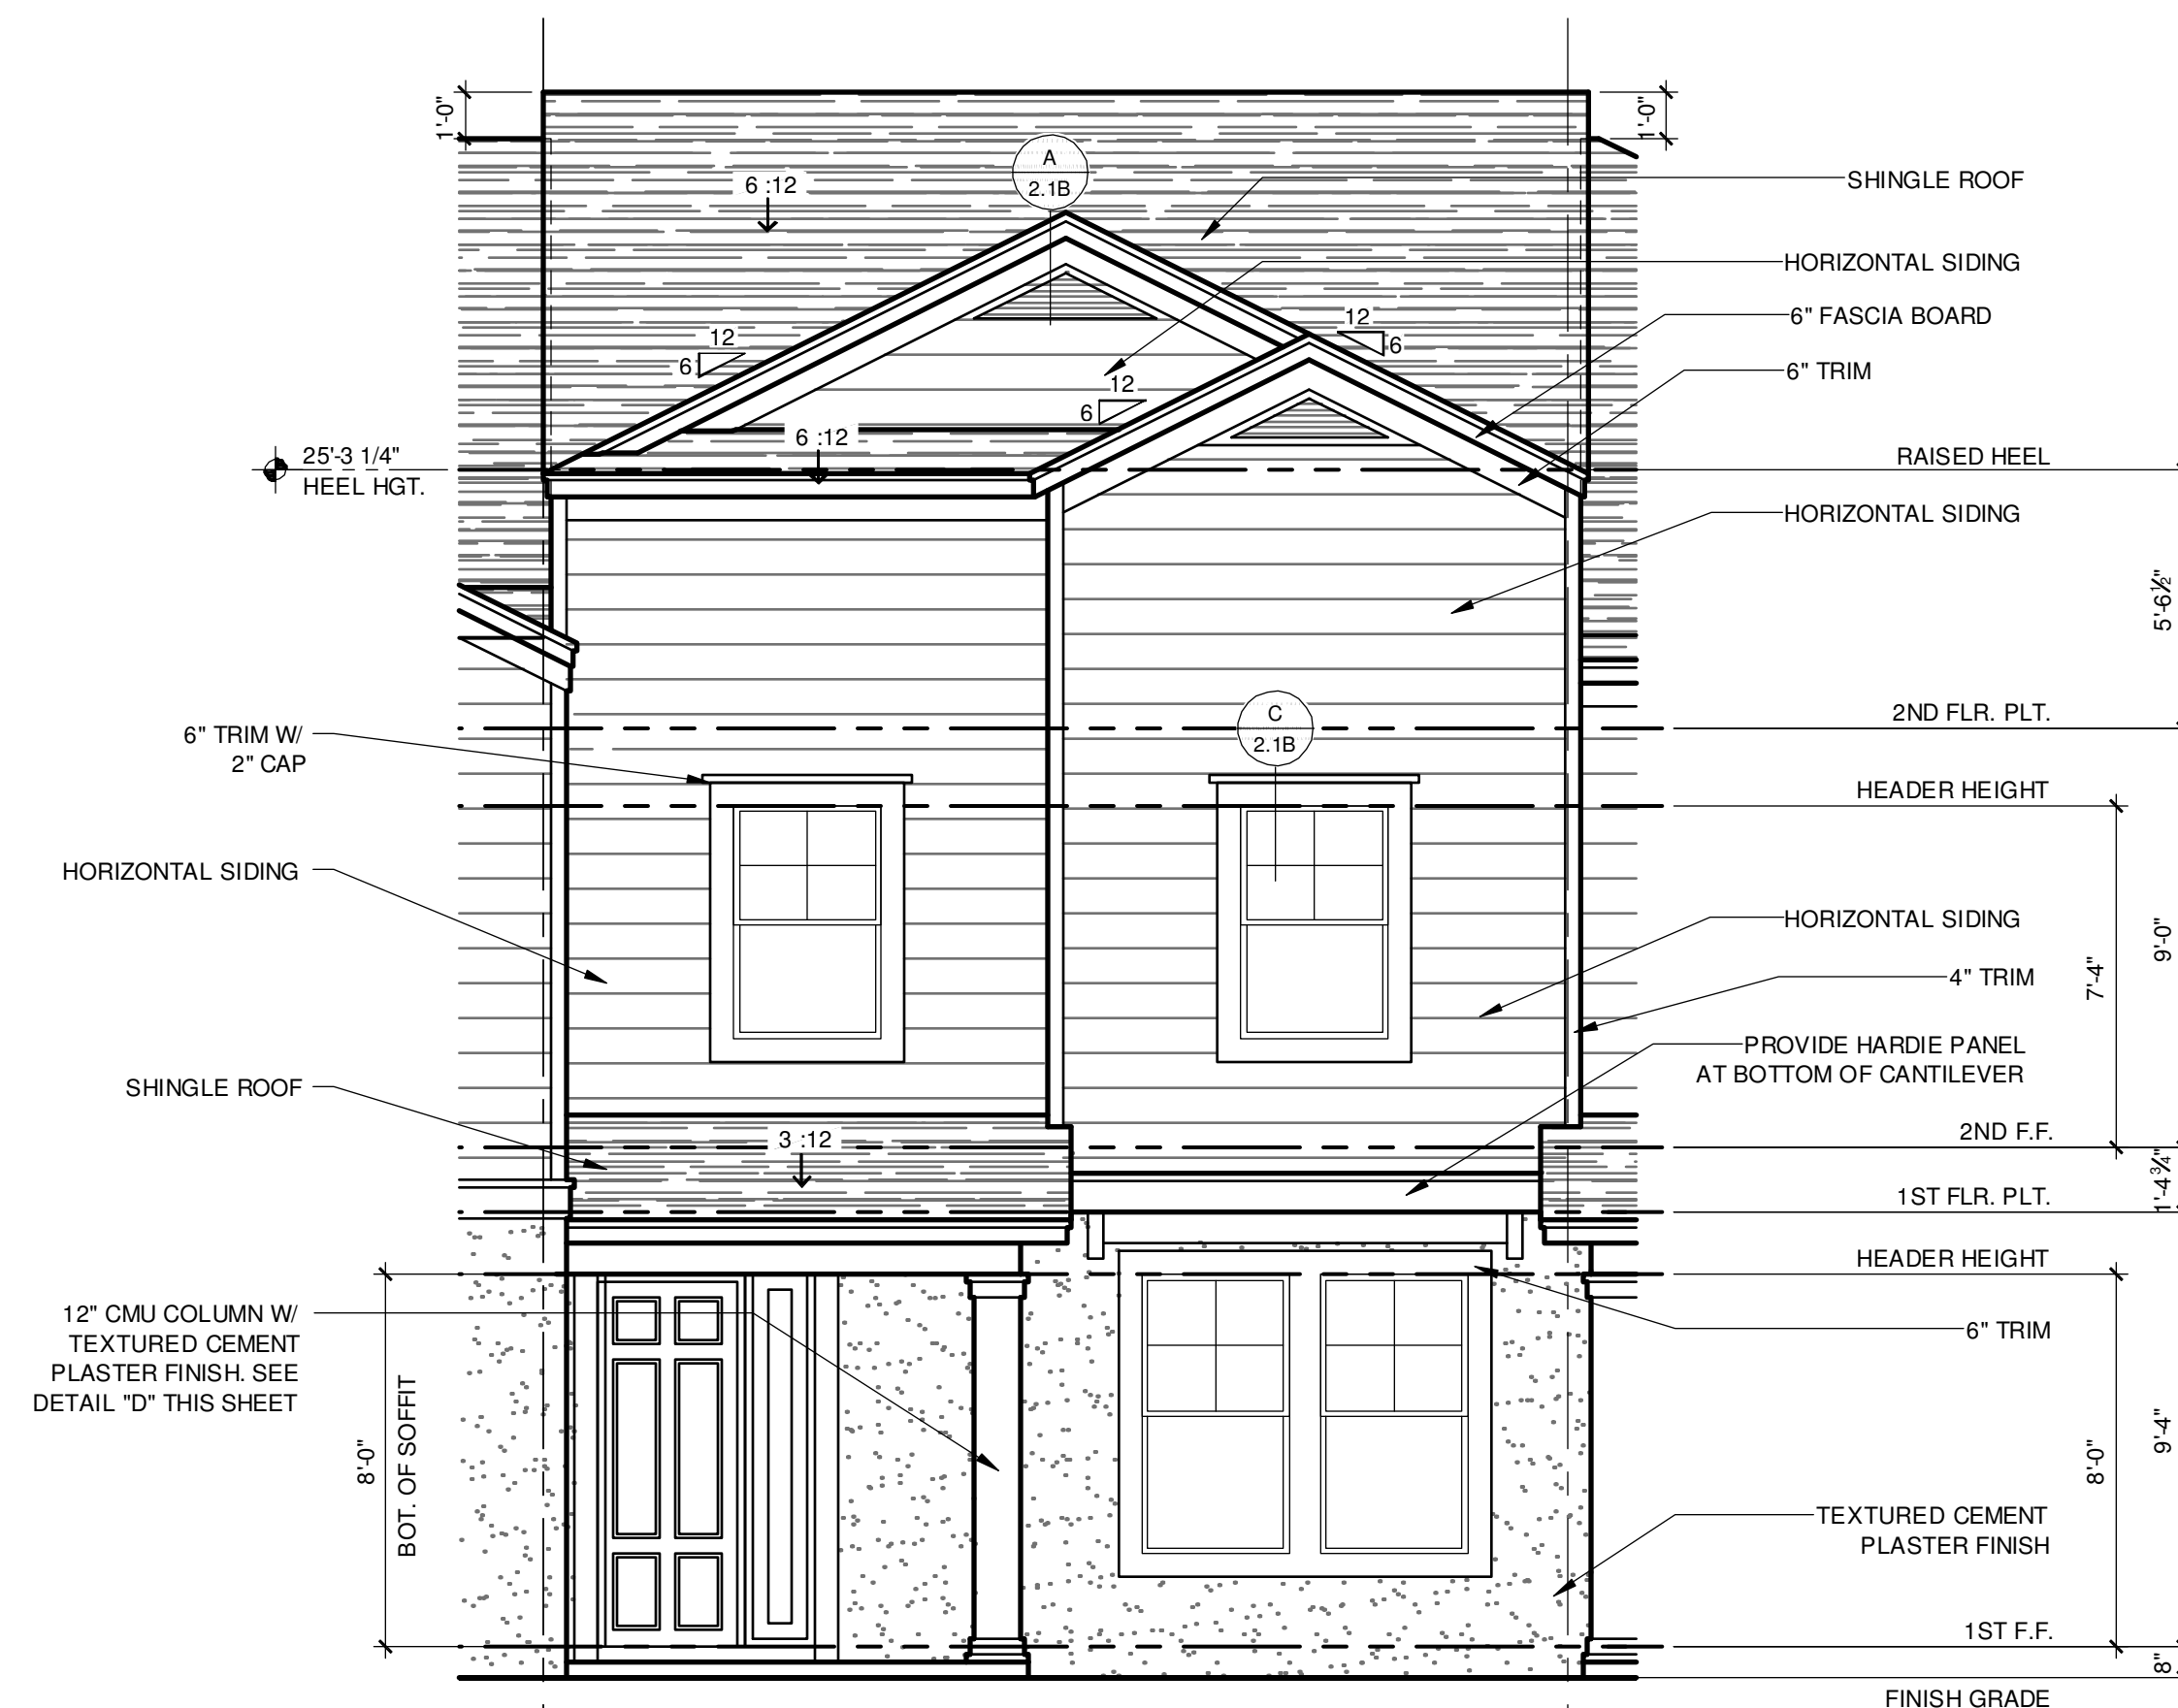


1840 - JEFFERSON  
REAR ELEVATION "A"

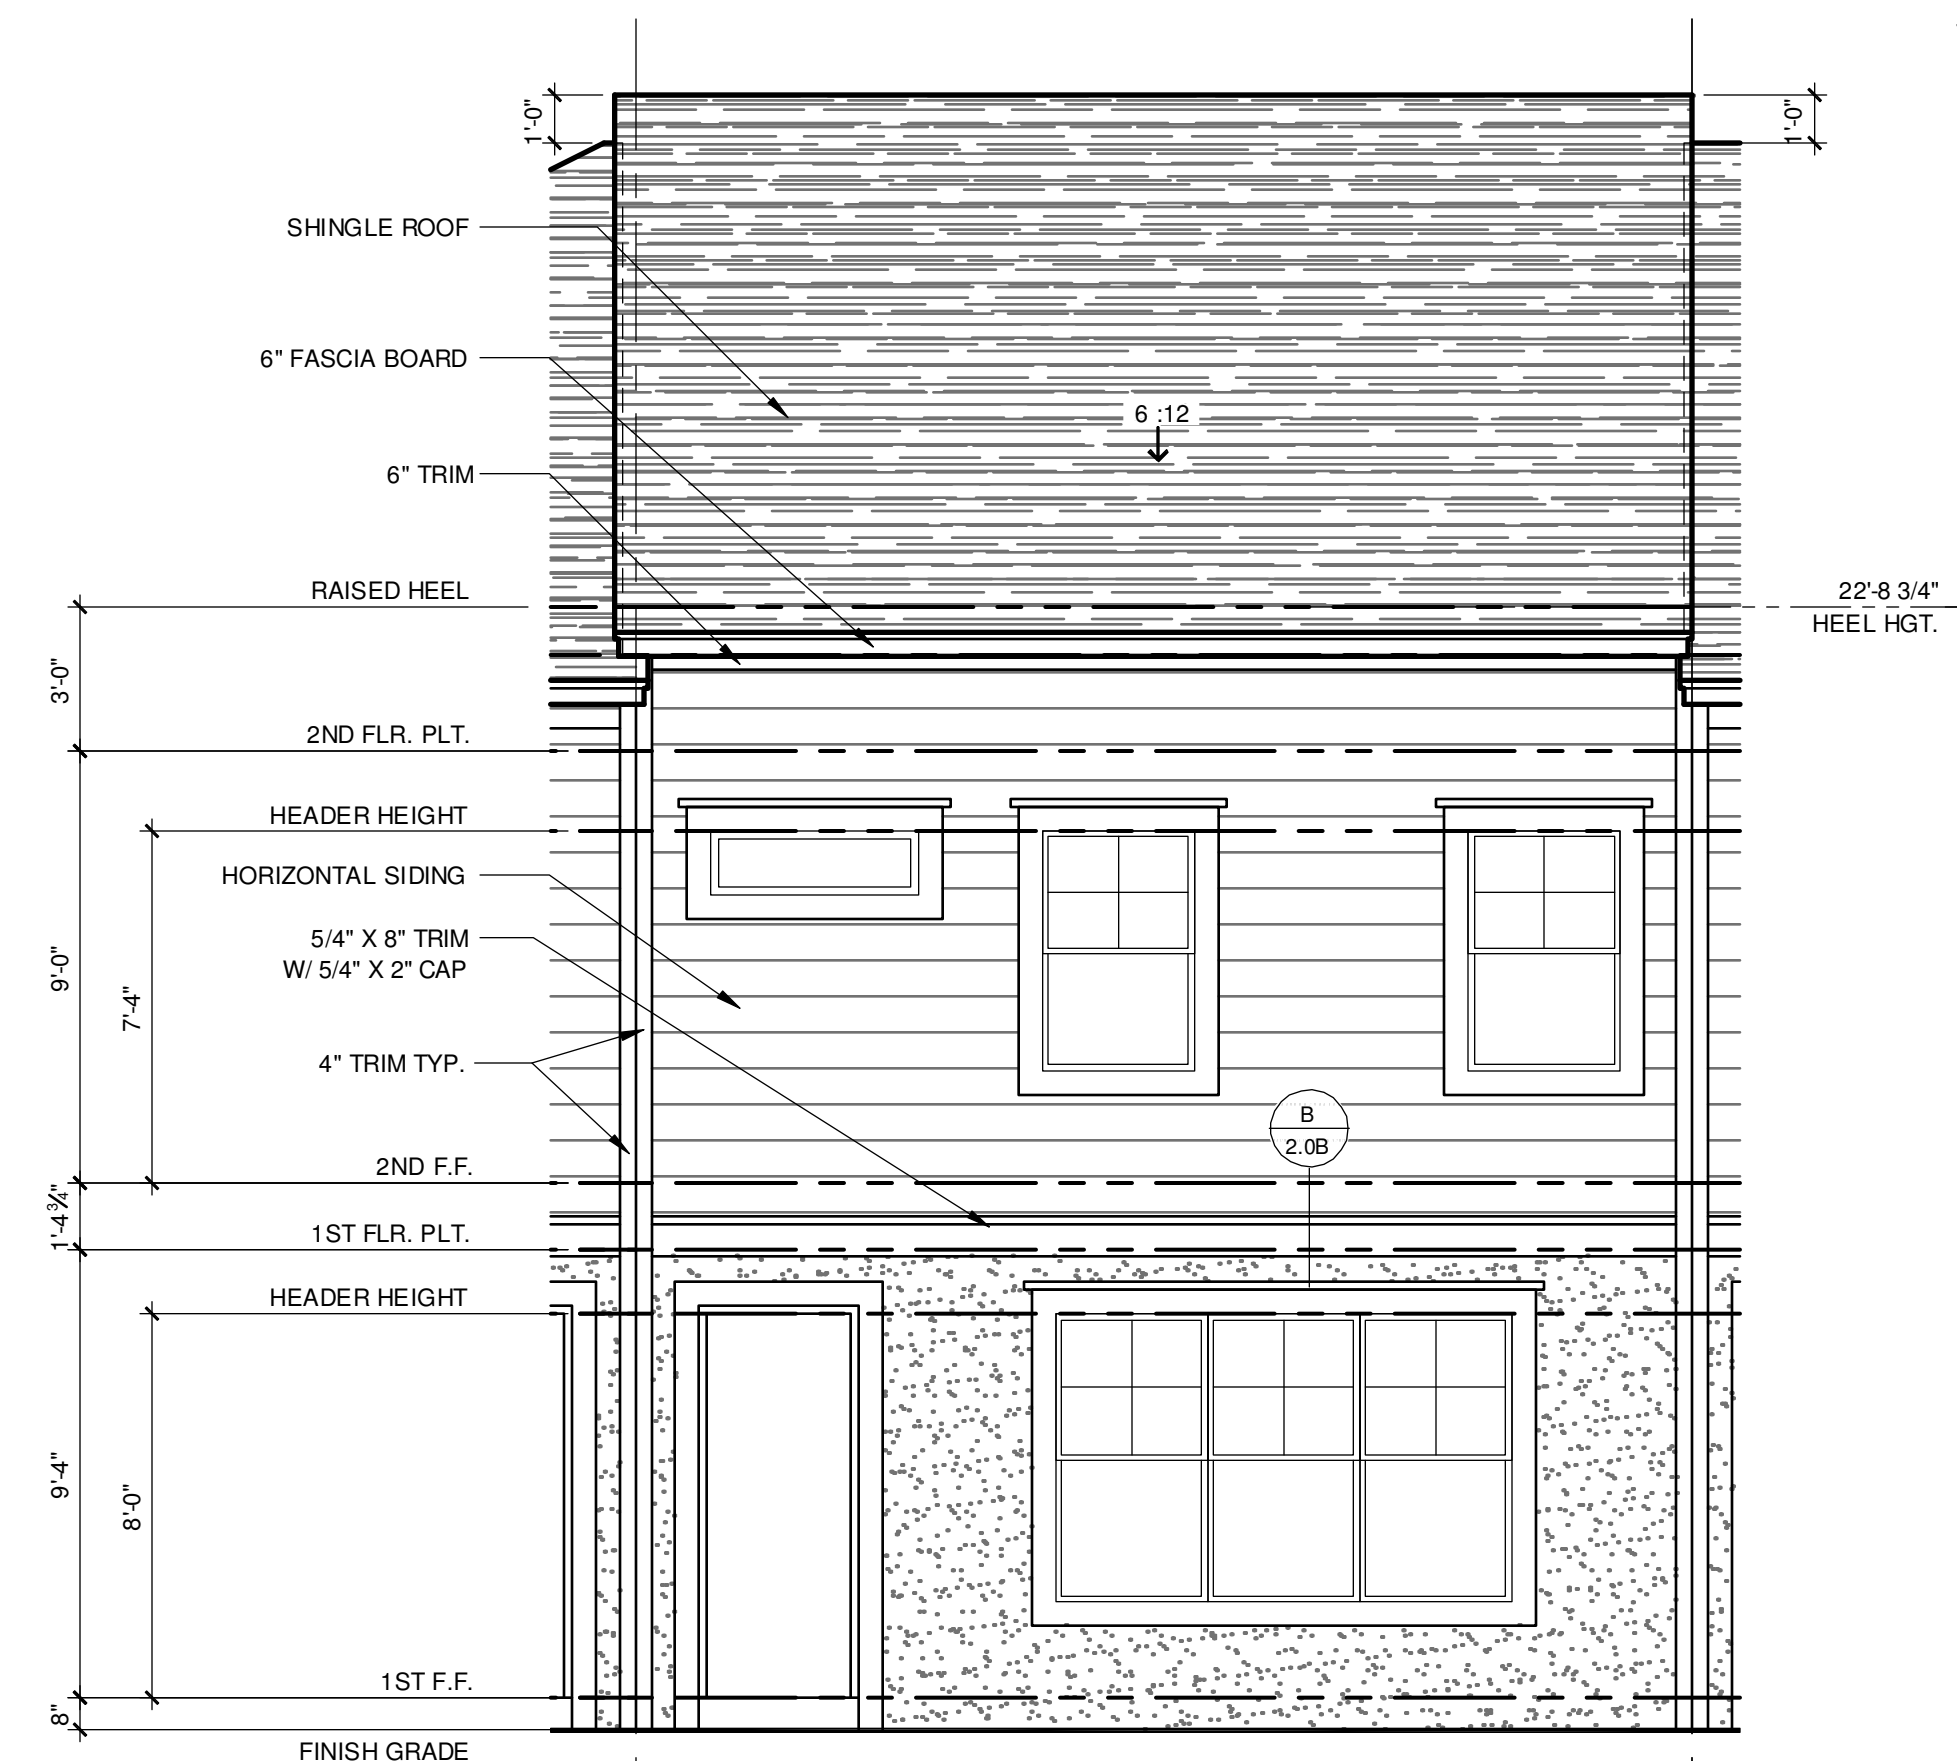

**A** DECORATIVE GABLE LOUVER  
1" = 1'-0"



C 6" TRIM BOARD WINDOW TRIM  
1/2" = 1'-0"

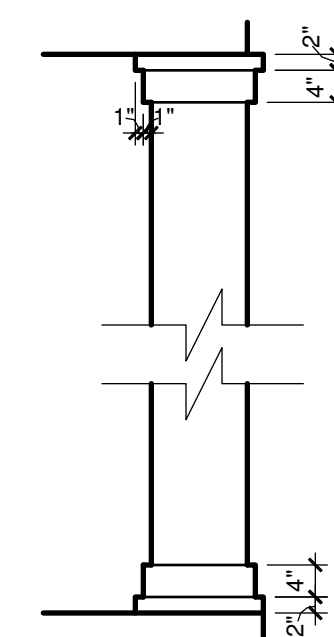

**D** COLUMN AT FRONT PORCH  
1/2" = 1'-0"

**NTS ARE PROHIBITED.**

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**FDS**

**ENVIRONMENTAL AEROSOL TESTS**

258 Southhall Lane, Suite 200, Mattituck, FL 32751  
O: 321-972-2491 F: 407-880-2304  
Certificate of Authorization No. 9161

☐ CAROL A. BROWN, PE - FL # 58128  
☐ CROTTI LEWOWSKI, PE - FL #77950  
☐

**DATE: April 14, 2023**

TO: THE STATE OF THE ENVIRONMENT HAZARDOUS AND NONHAZARDOUS TESTS, SPECIALTIES, PLASMA AND  
OTHER TESTING CAPABILITIES  
FOR THE STRUCTURAL INTEGRITY OF THE BUILDING

FDS JOB NO.:

PARK SQUARE  
HORIZONS WEST  
BABCOCK RANCH BLDG 6 (LOTS 6092-6099), 4 UNIT

title:  
**1840 - JEFFERSON  
EXT. ELEVATIONS**

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project no. 2023083  
checked: BF  
drawn: BA  
date: 04-12-23  
scale: AS SHOWN




**2.1B**  
**ELEV. A**

NOTE: DRAWINGS ON 11"x17" SHEET WILL BE ONE HALF THE SCALE NOTED

The structural design of this building is in accordance with the FLORIDA BUILDING CODE 7TH EDITION (2020) RESIDENTIAL and is certified as such.

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ELEVATION - KEY PLAN

1/32" = 1'-0"
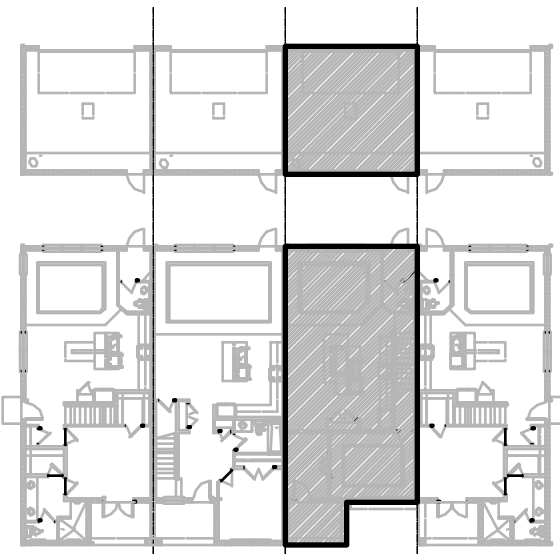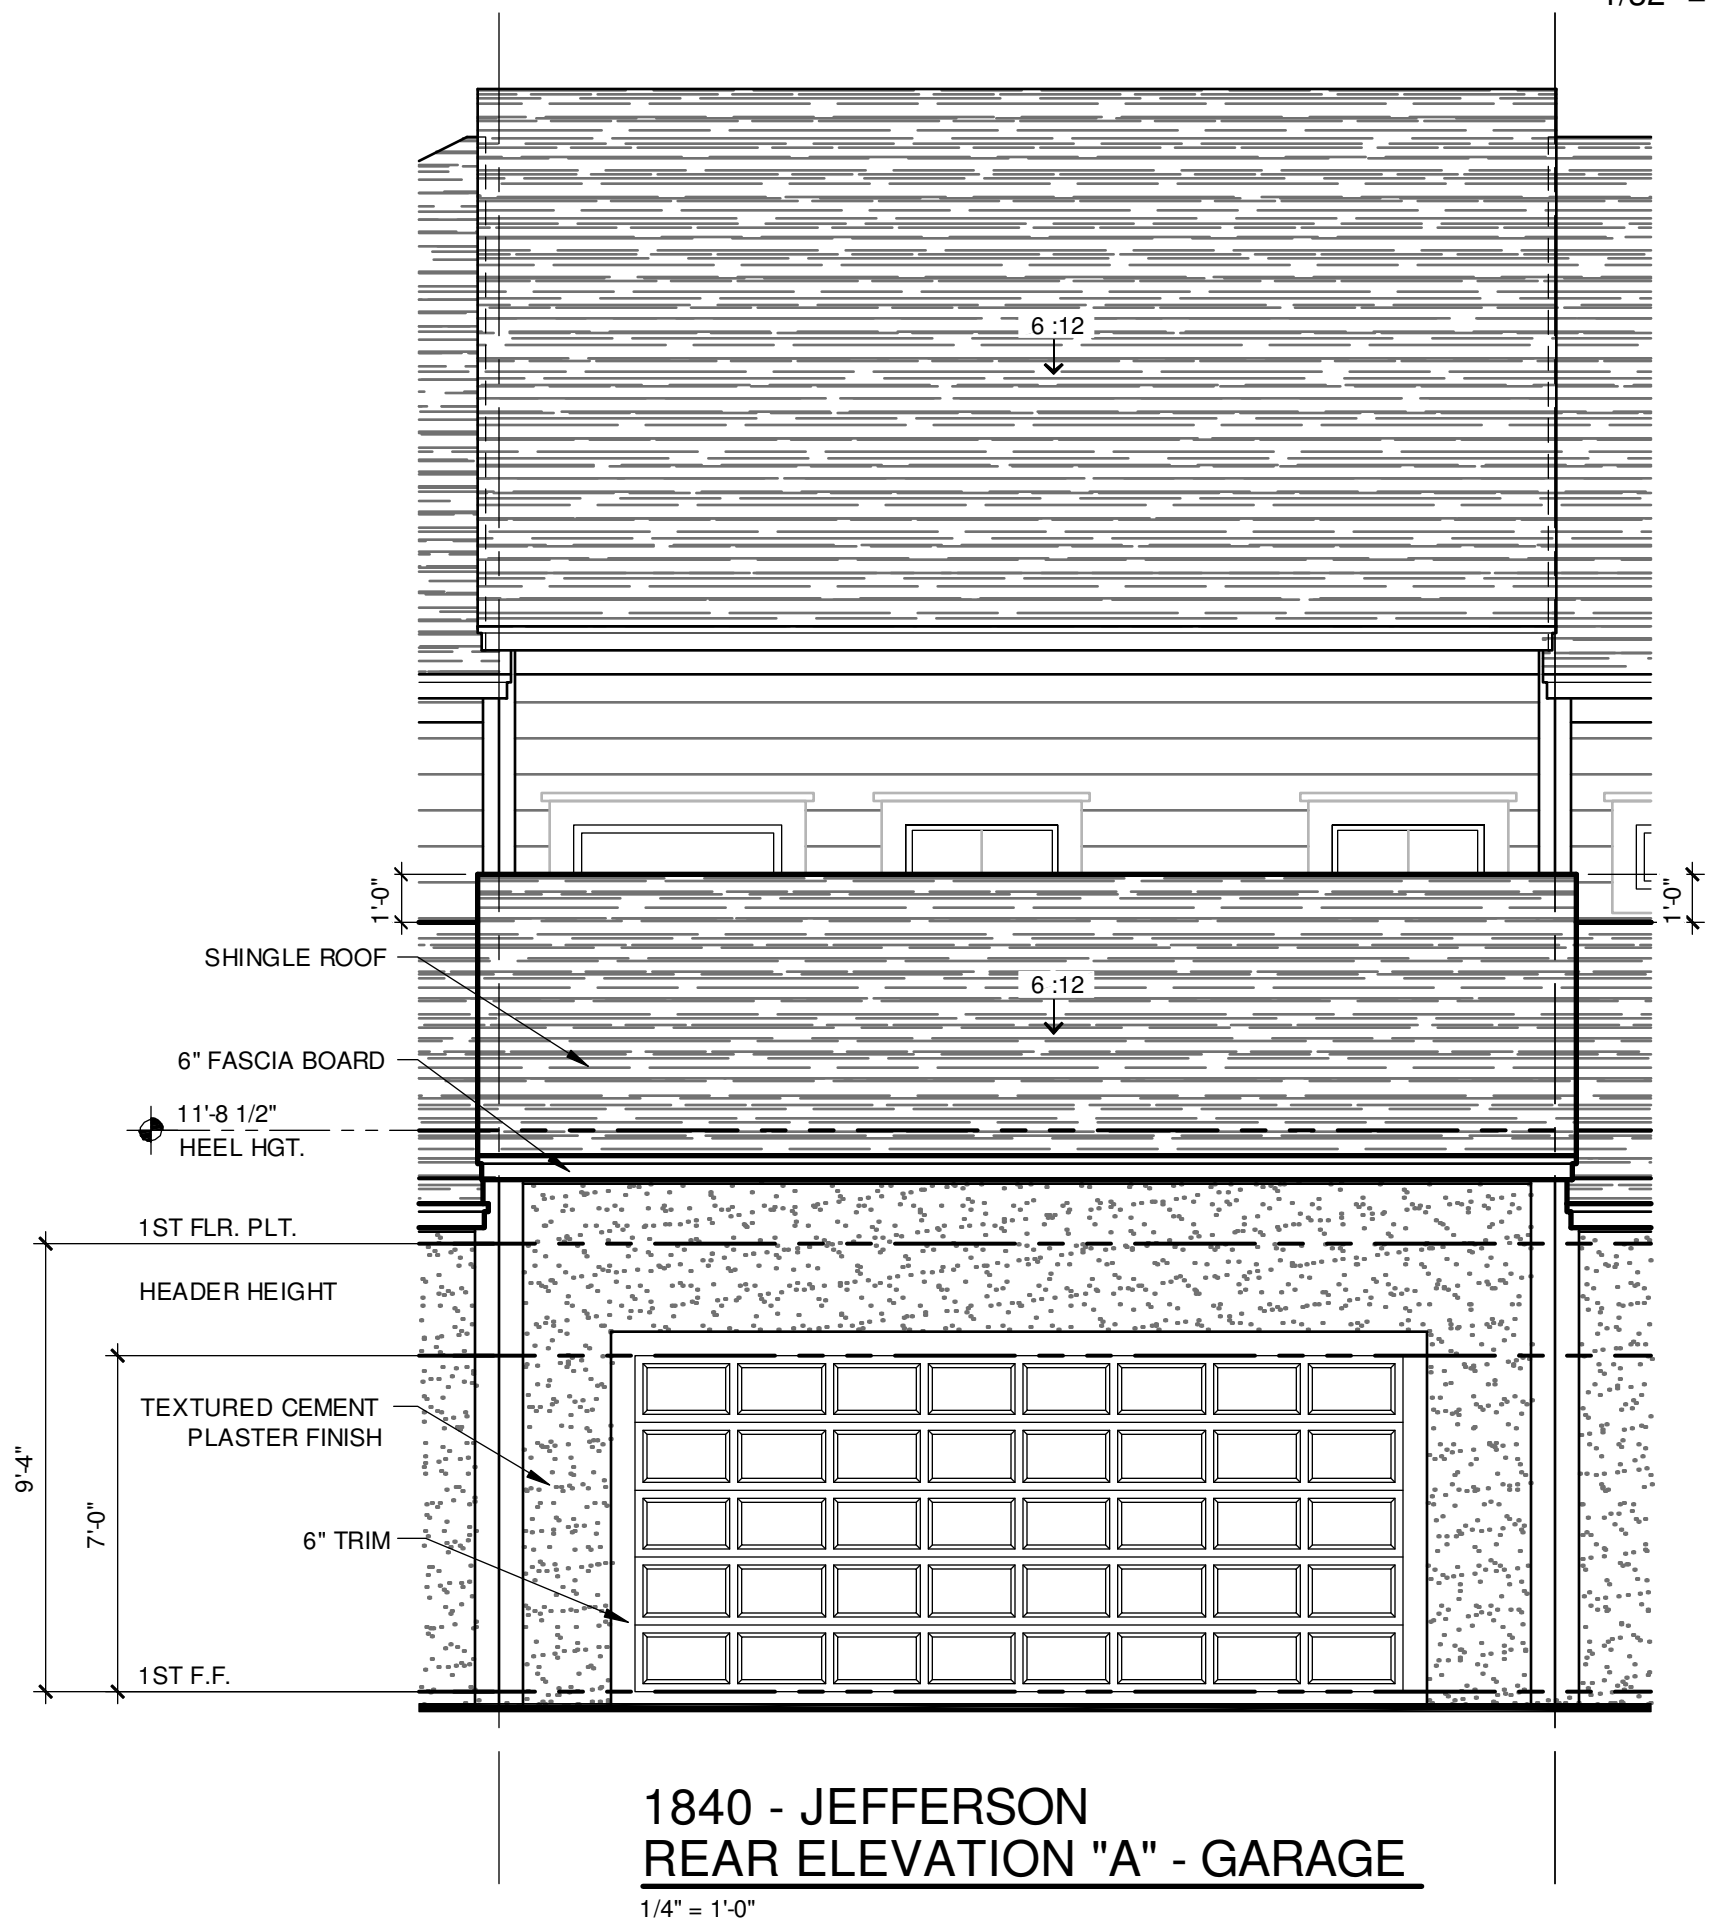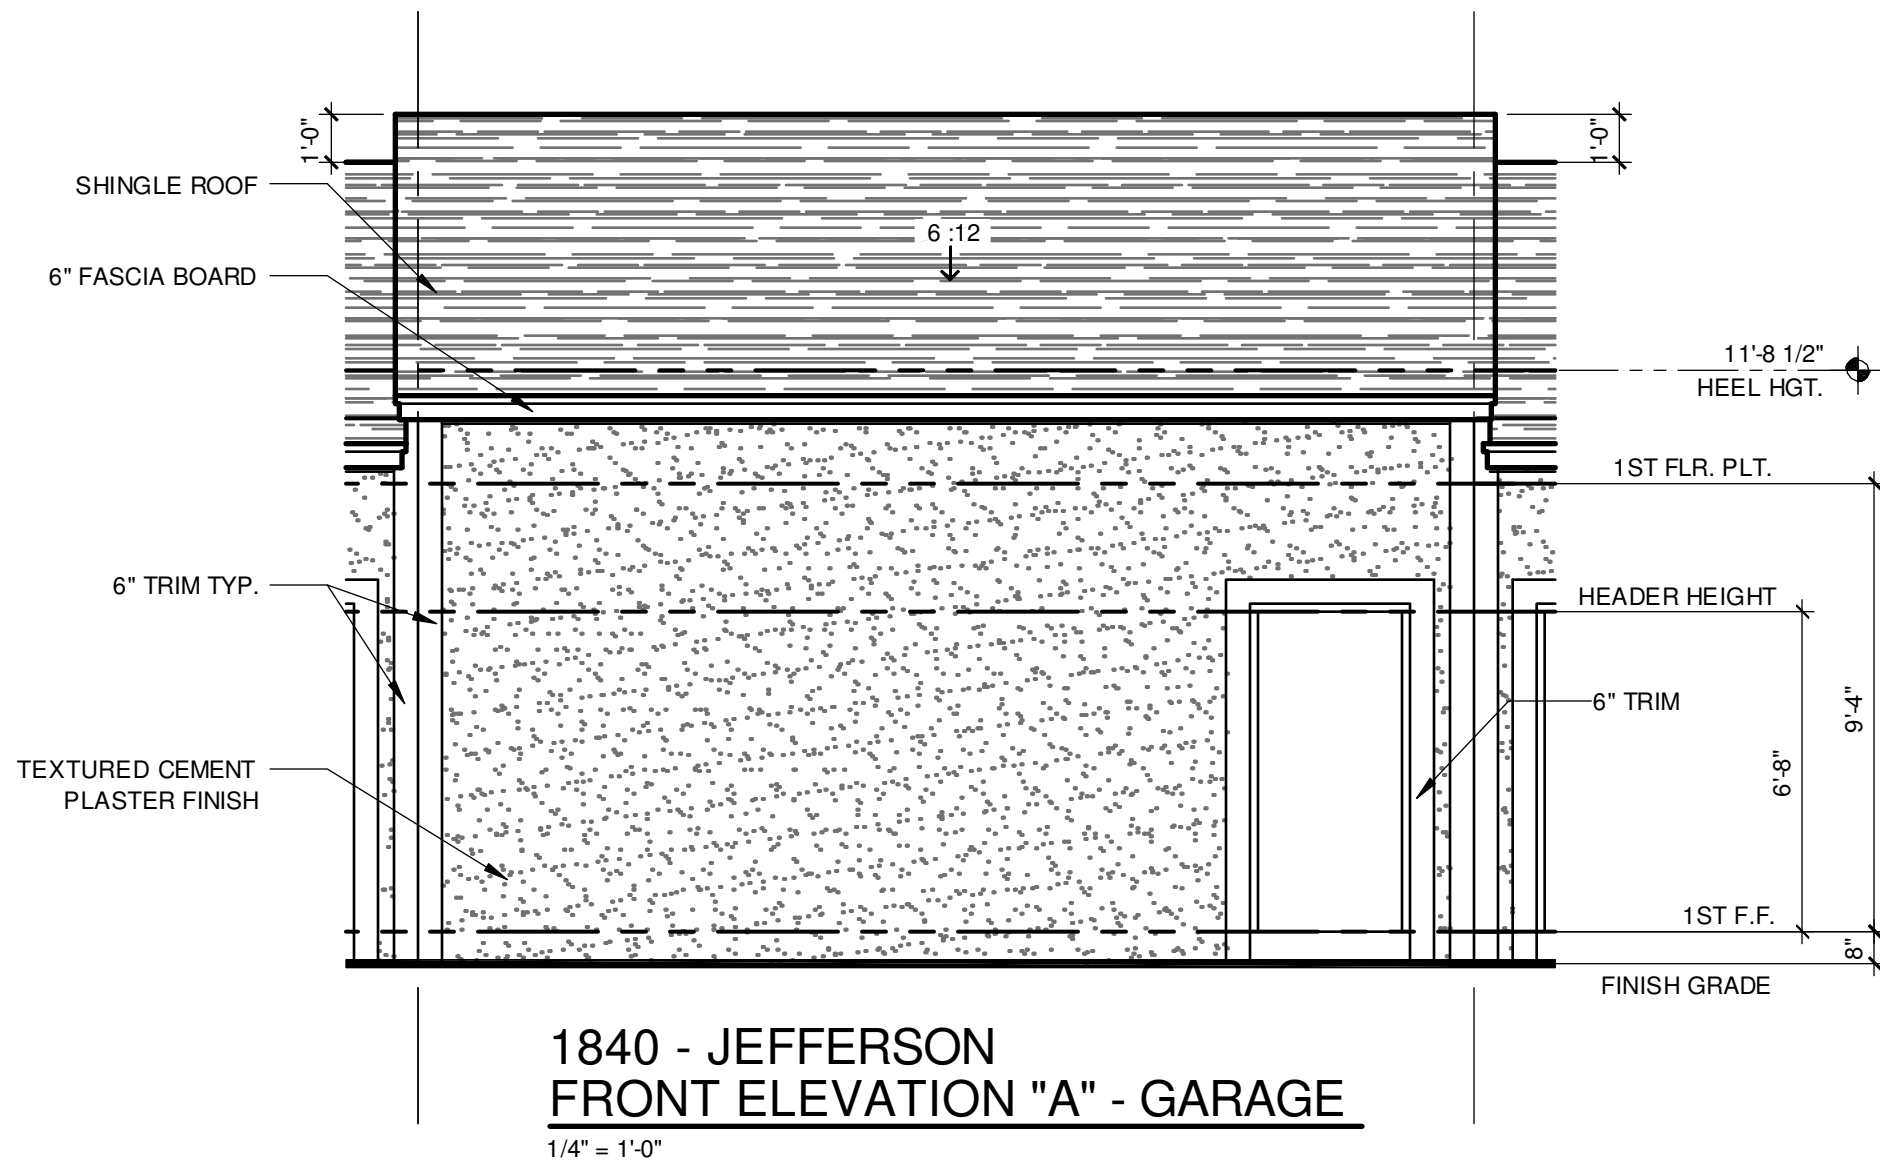
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Website: www.fdseng.com  
Professional Engineer: CARL A. BROWN, P.E. - FL #51028  
Professional Engineer: SCOTT LEWIS, P.E. - FL #78790  
DATE: April 14, 2023  
BY: [Signature]

FDS JOB NO.:

PARK SQUARE  
HORIZONS WEST  
BABCOCK RANCH BLDG 6 (LOTS 6092-6099) 4 UNIT

Title:  
**1840 - JEFFERSON  
EXT. ELEVATIONS**

project no. 2023083  
checked: BF  
drawn: BA  
date: 04-12-23  
scale: AS SHOWN

**2.2B  
ELEV. A**


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UNIT 6091


2024 MADISON

G.C. TO VERIFY  
FASCIA CALLOUT




ELEVATION - KEY PLAN

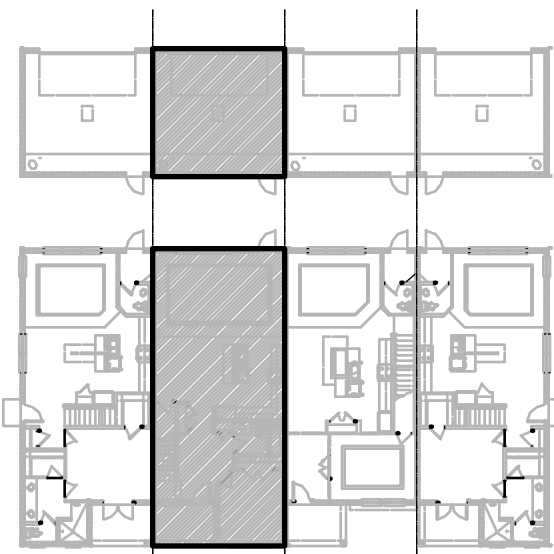1/32" = 1'-0"

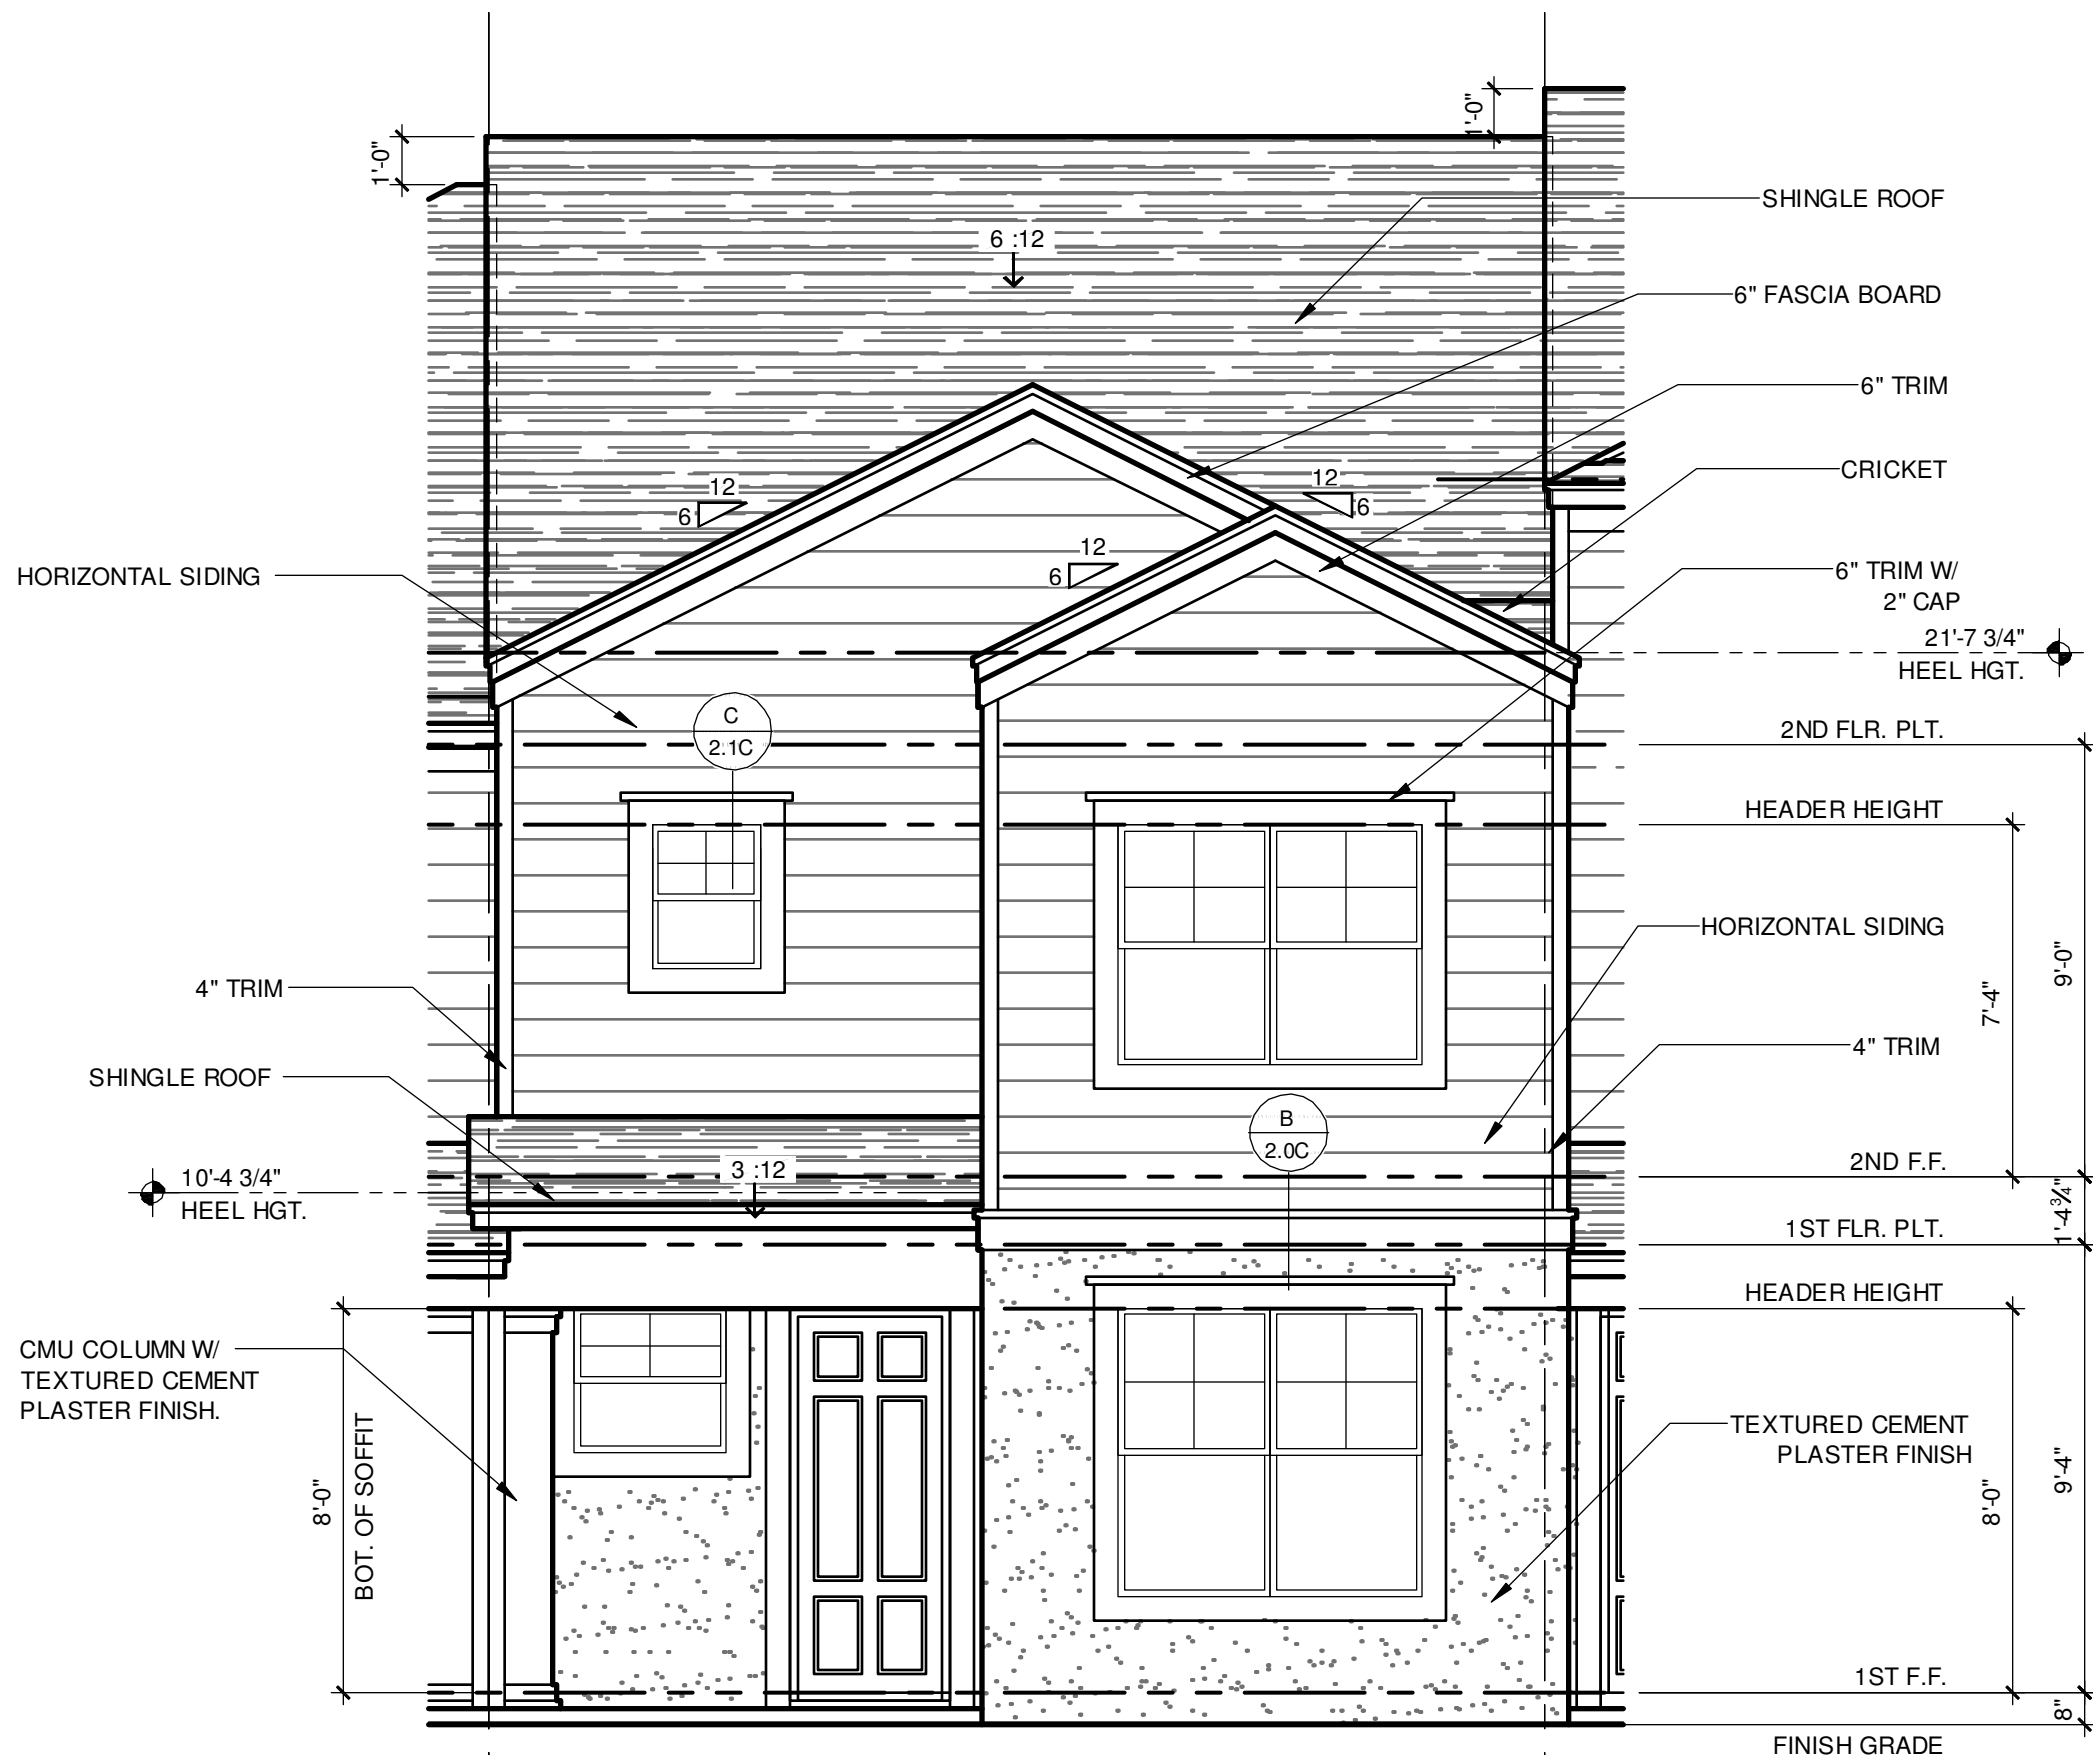


2024 - MADISON  
FRONT ELEVATION "A"

1/4" = 1'-0"

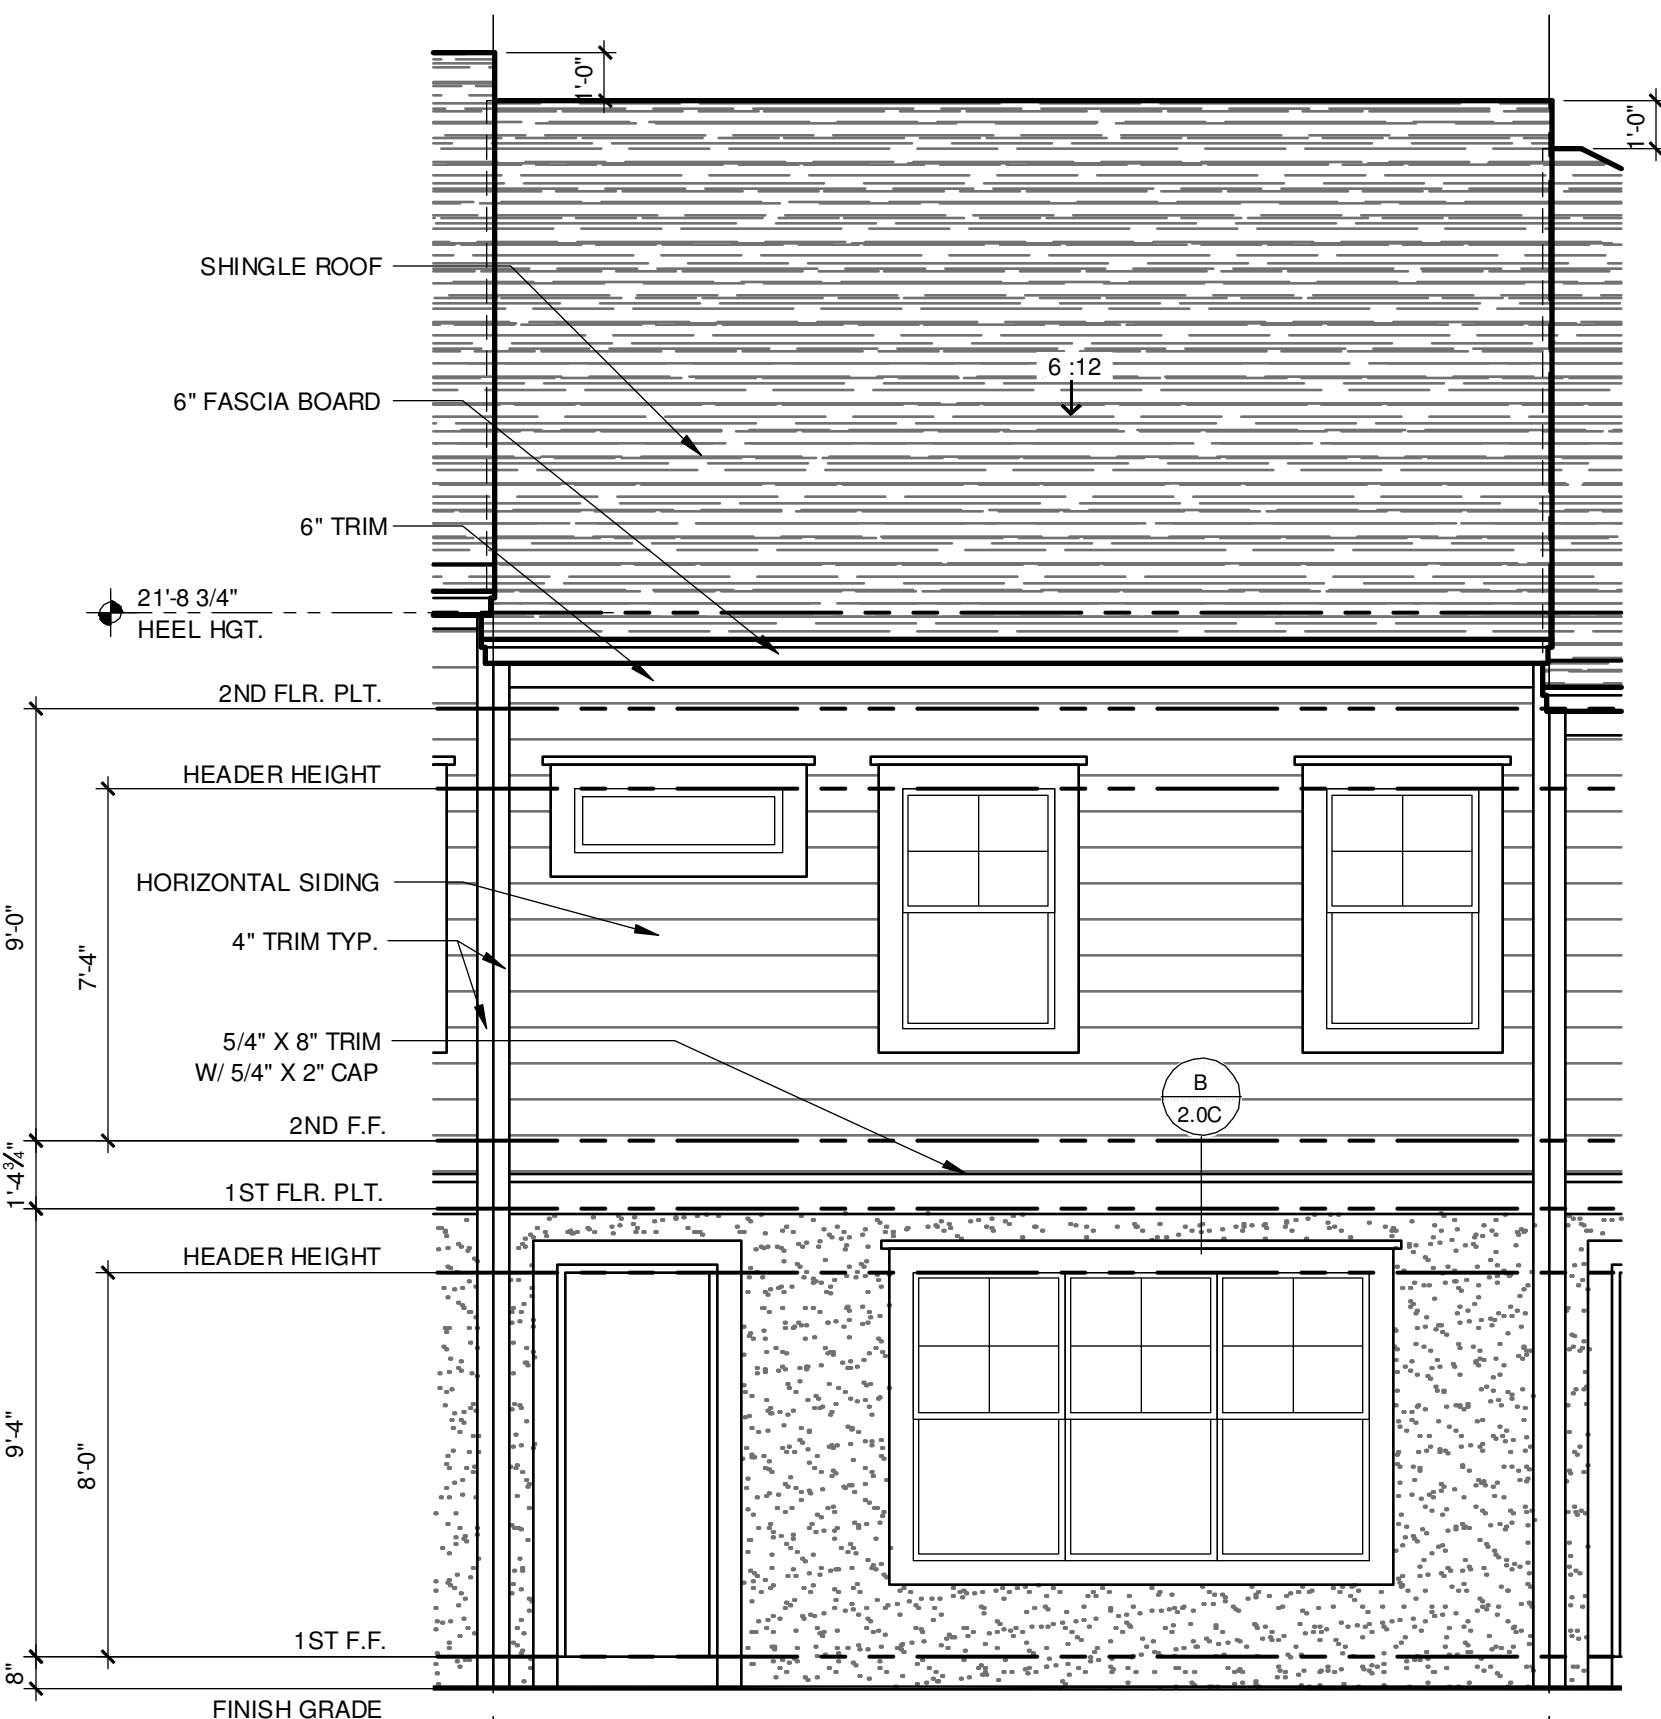

2024 - MADISON  
REAR ELEVATION "A"

1/4" = 1'-0"

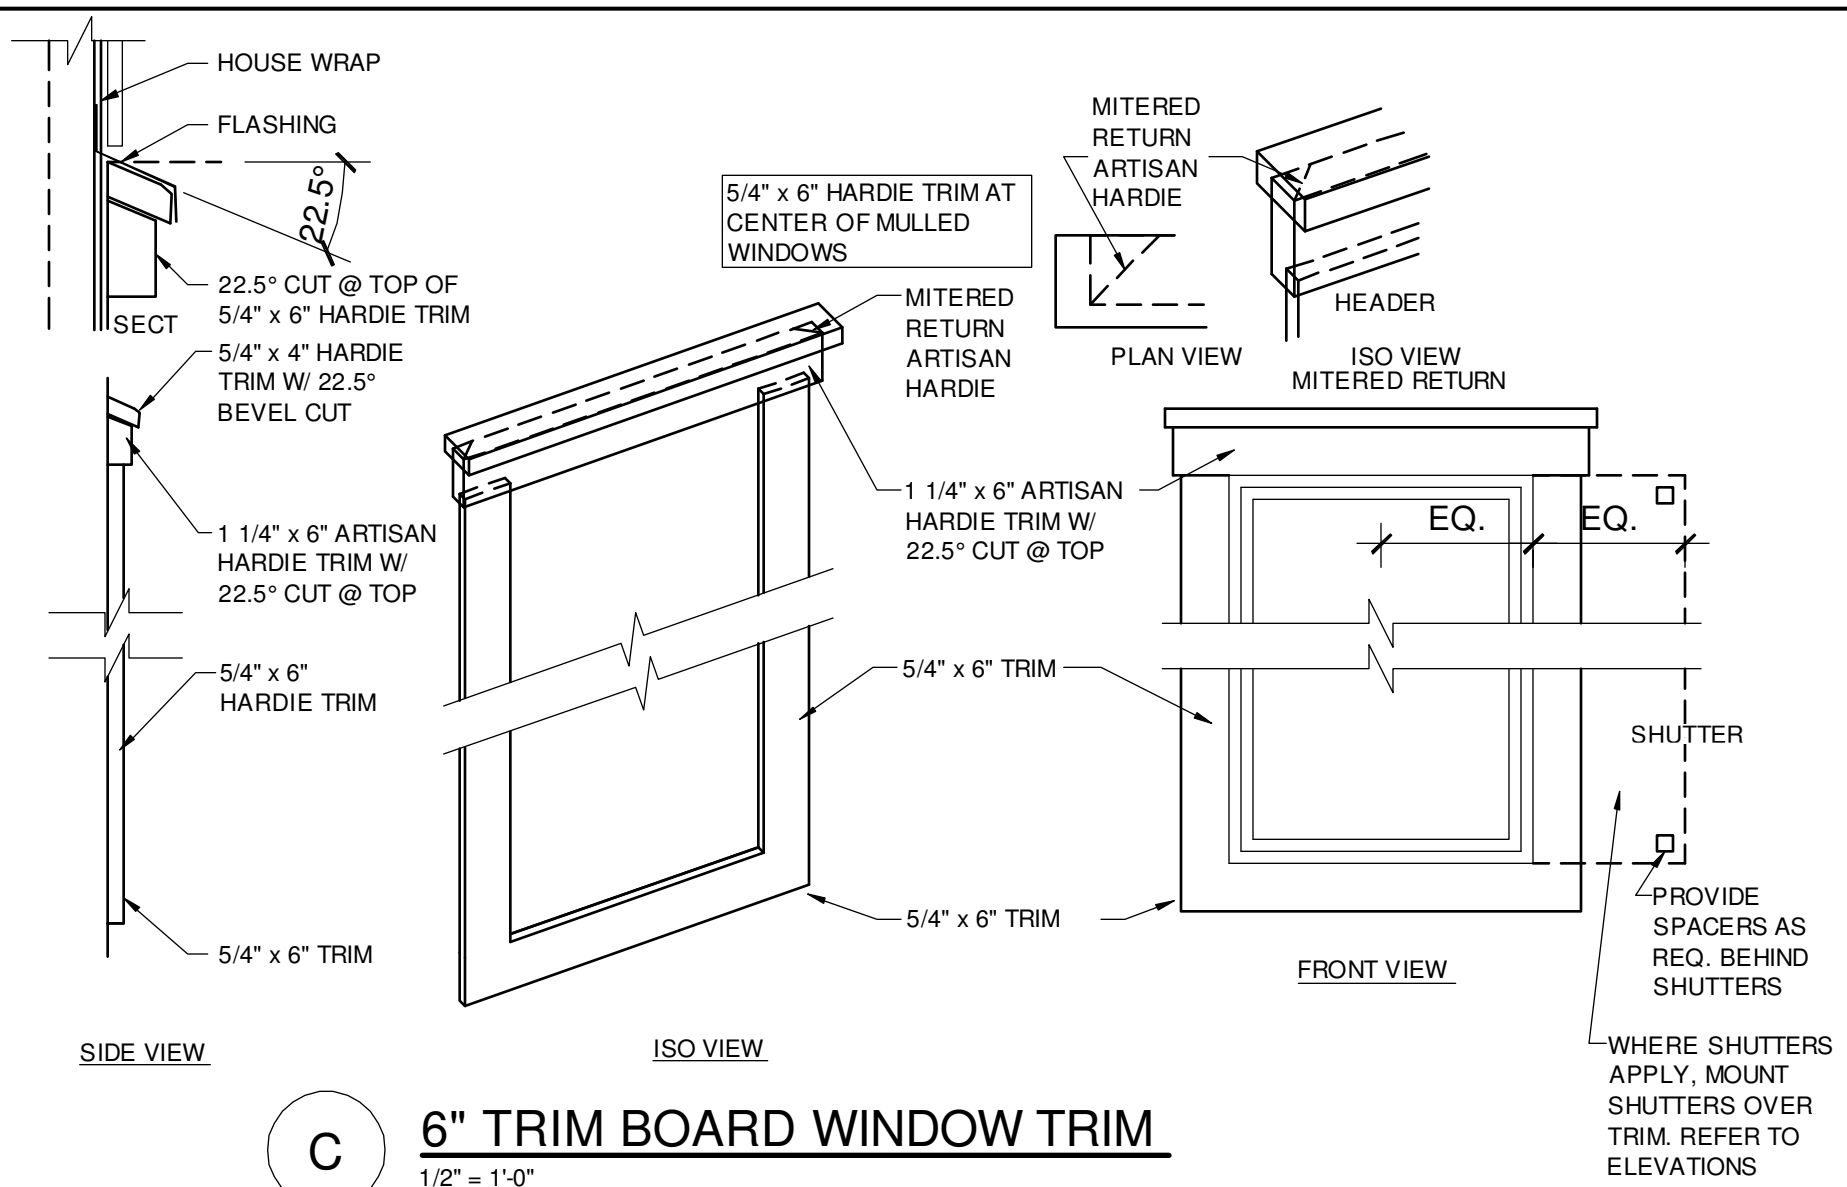

6" TRIM BOARD WINDOW TRIM

1/2" = 1'-0"

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Professional Engineer  
Certificate of Authorization No. 9191  
CARL A. BROWN, P.E. - FL #5128  
SCOTT LEWOWSKI, P.E. - FL #78780

DATE: April 14, 2023

NOTE: THE SEAL OF THE ENGINEER OR ARCHITECT IS REQUIRED FOR ALL DRAWINGS. THE ENGINEER OR ARCHITECT IS RESPONSIBLE FOR THE DESIGN AND THE QUALITY OF THE WORK.

FDS JOB NO.:

PARK SQUARE  
HORIZONS WEST  
BABCOCK RANCH BLDG 6 (LOTS 6092-6099) 4 UNIT

title:  
2024 - MADISON  
EXT. ELEVATIONS

project no. 2023083  
checked: BF  
drawn: BA  
date: 04-12-23  
scale: AS SHOWN


2.1C  
ELEV. A

NOTE: DRAWINGS ON 11"x17" SHEET WILL BE ONE HALF THE SCALE NOTED

DISCLAIMER



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UNIT 6091 2024 MADISON

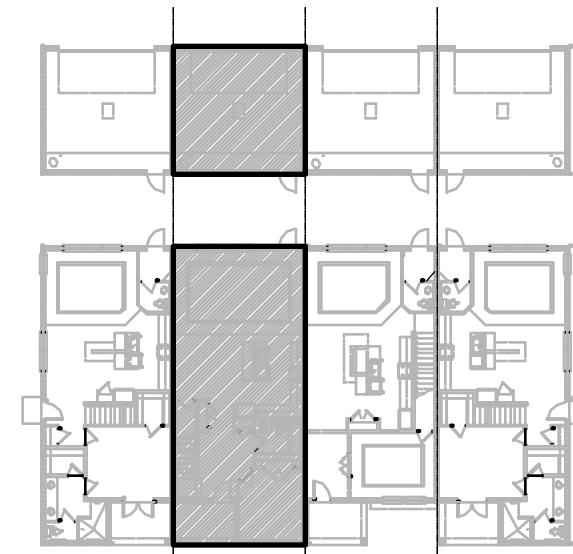

ELEVATION - KEY PLAN

1/32" = 1'-0"

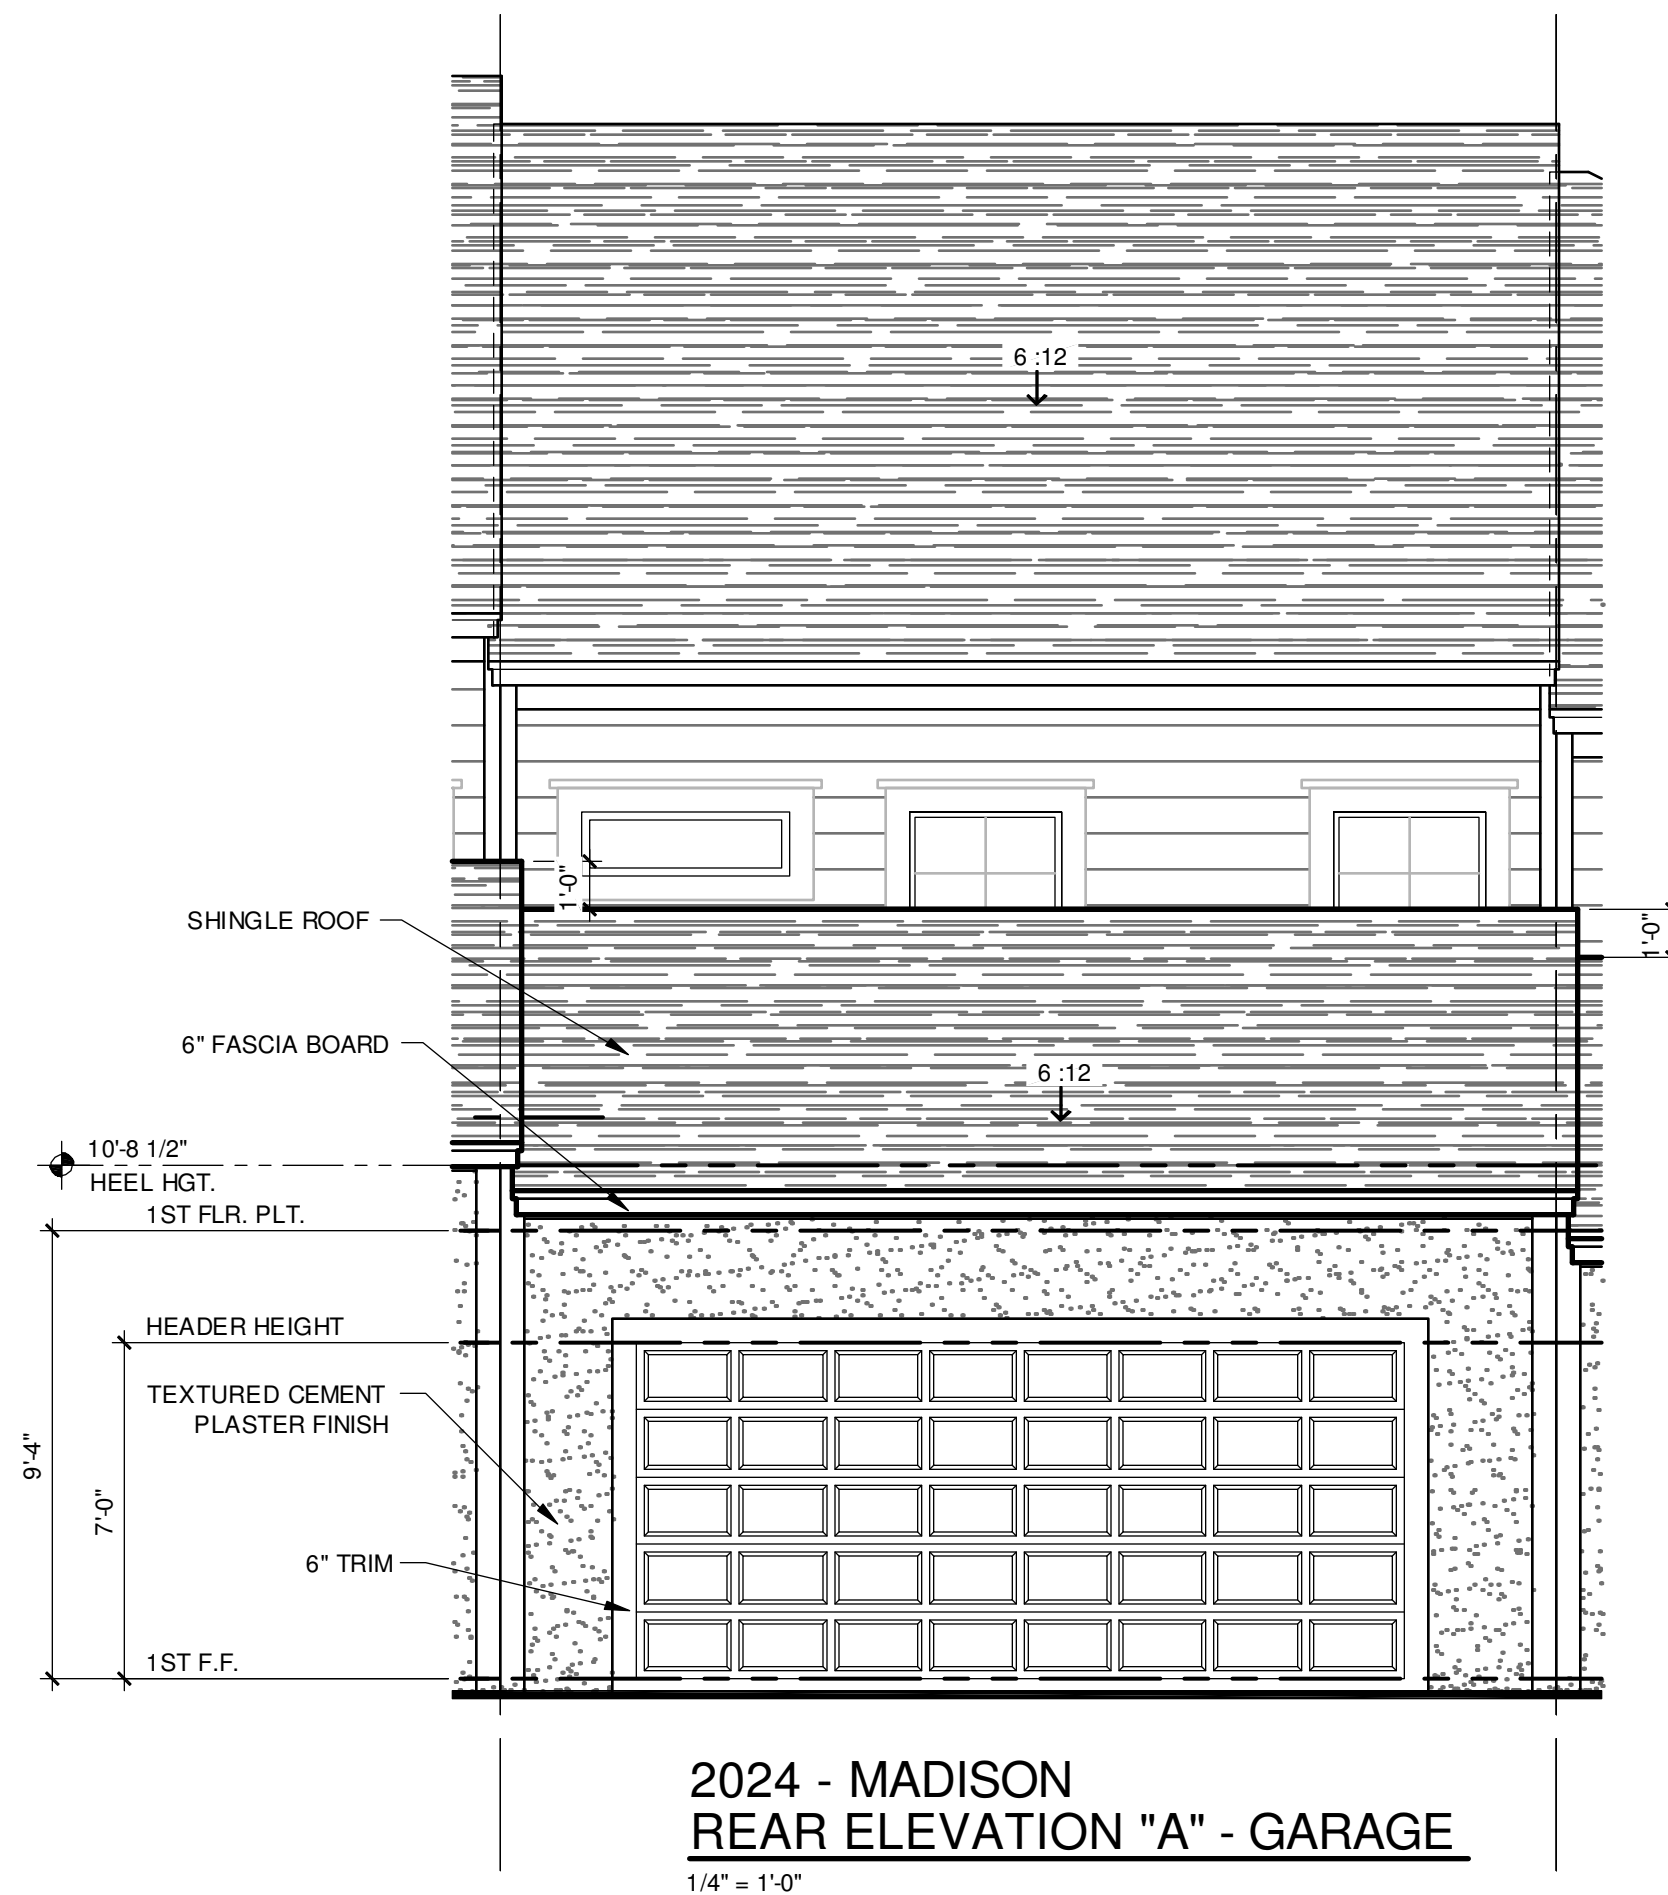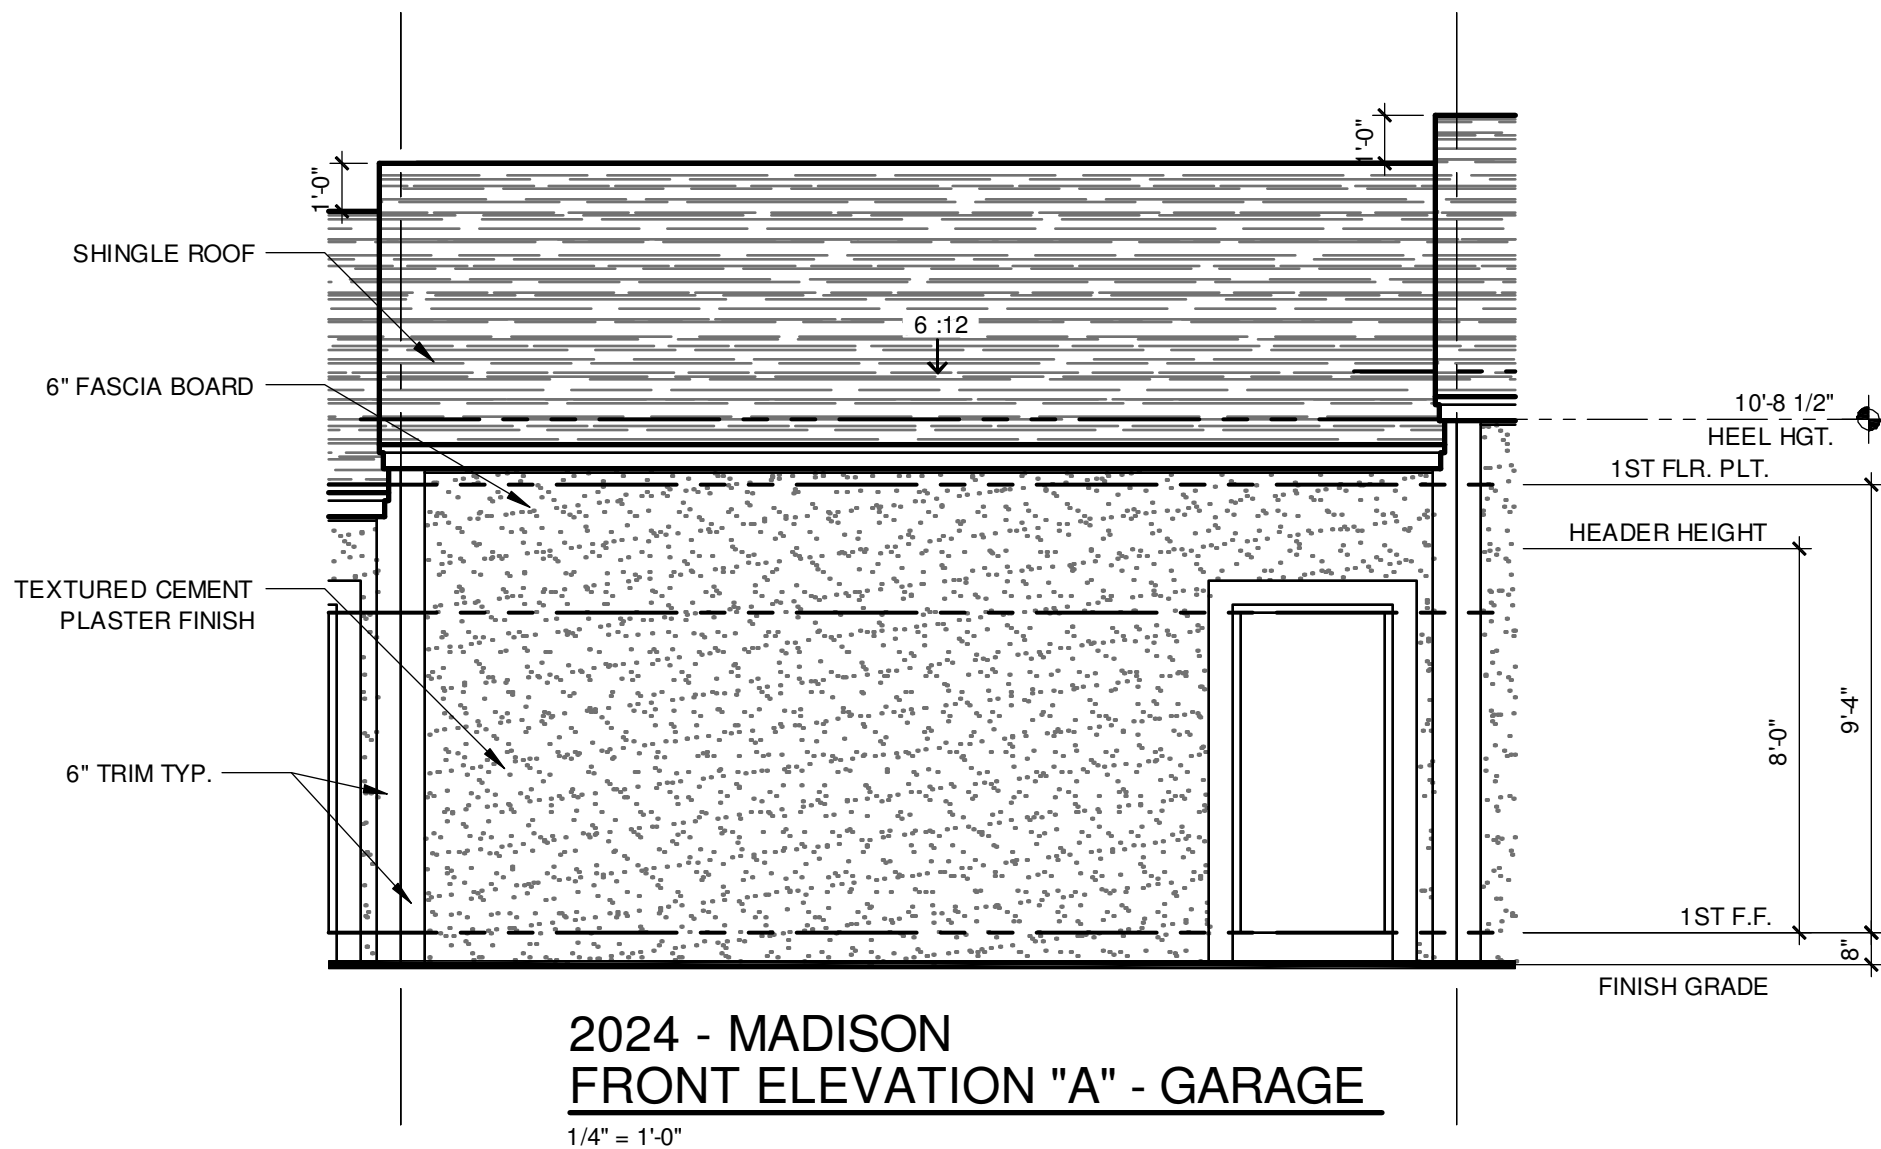

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fax 407 829 2040  
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**AMERICAN**  
INSTITUTE OF  
BUILDING DESIGN

**FDS**  
ENGINEERING ASSOCIATES  
228 Southall Lane, Suite 200, Melbourne, FL 32951  
P.O. Box 1000, Melbourne, FL 32901  
Certificate of Authorization No. 9101  
☐ CARL A. BROWN, P.E. - FL #51028  
☐ SCOTT LEWIS, P.E. - FL #78760  
DATE: April 14, 2023  
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**PARK SQUARE  
HORIZONS WEST  
BABCOCK RANCH BLDG 6 (LOTS 6082-6089) 4 UNIT**

Title: **2024 - MADISON  
EXT. ELEVATIONS**

project no. 2023083  
checked: BF  
drawn: BA  
date: 04-12-23  
scale: AS SHOWN

**2.2C  
ELEV. A**


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UNIT 6092


1914 ADAMS REVERSED

G.C. TO VERIFY  
FASCIA CALLOUT




ELEVATION - KEY PLAN

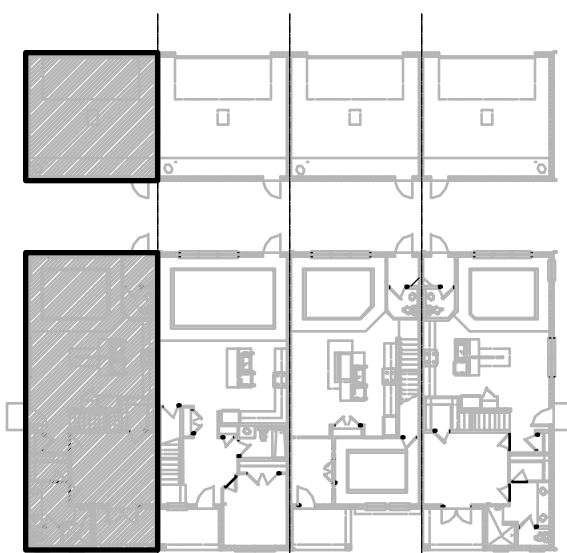1/32" = 1'-0"

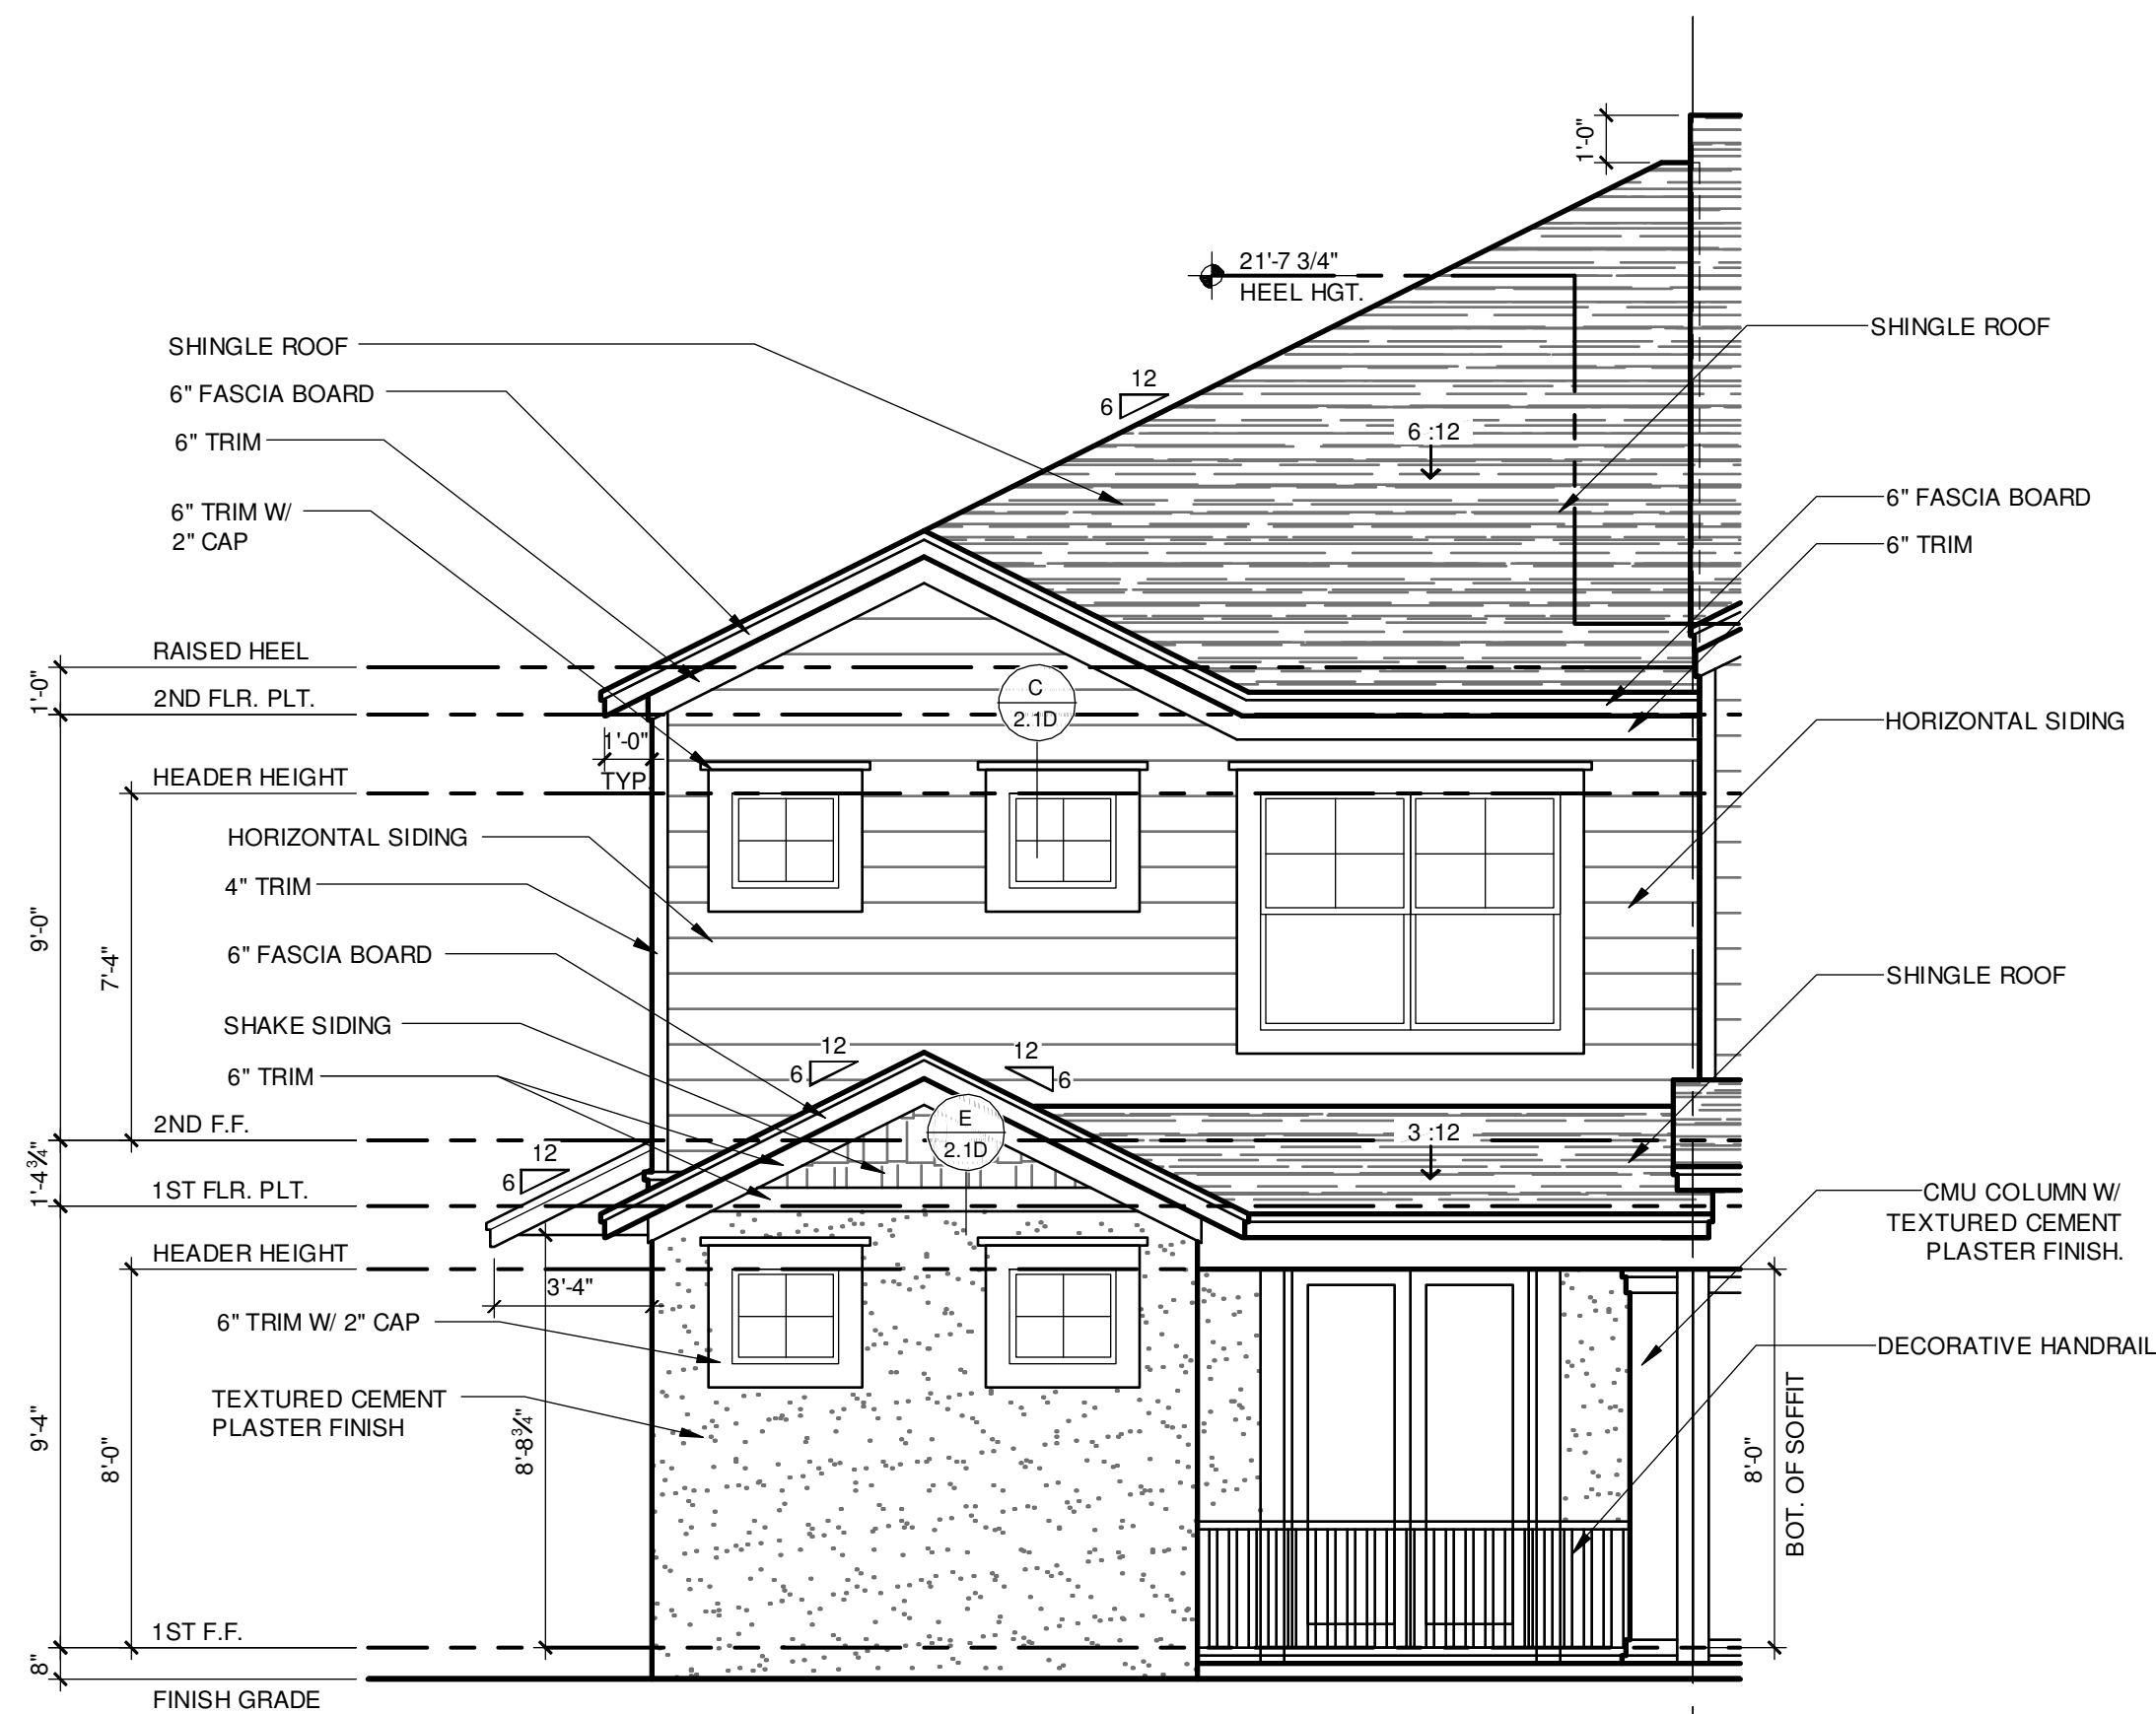



1914 - ADAMS REVERSED  
FRONT ELEVATION "A"

1/4" = 1'-0"

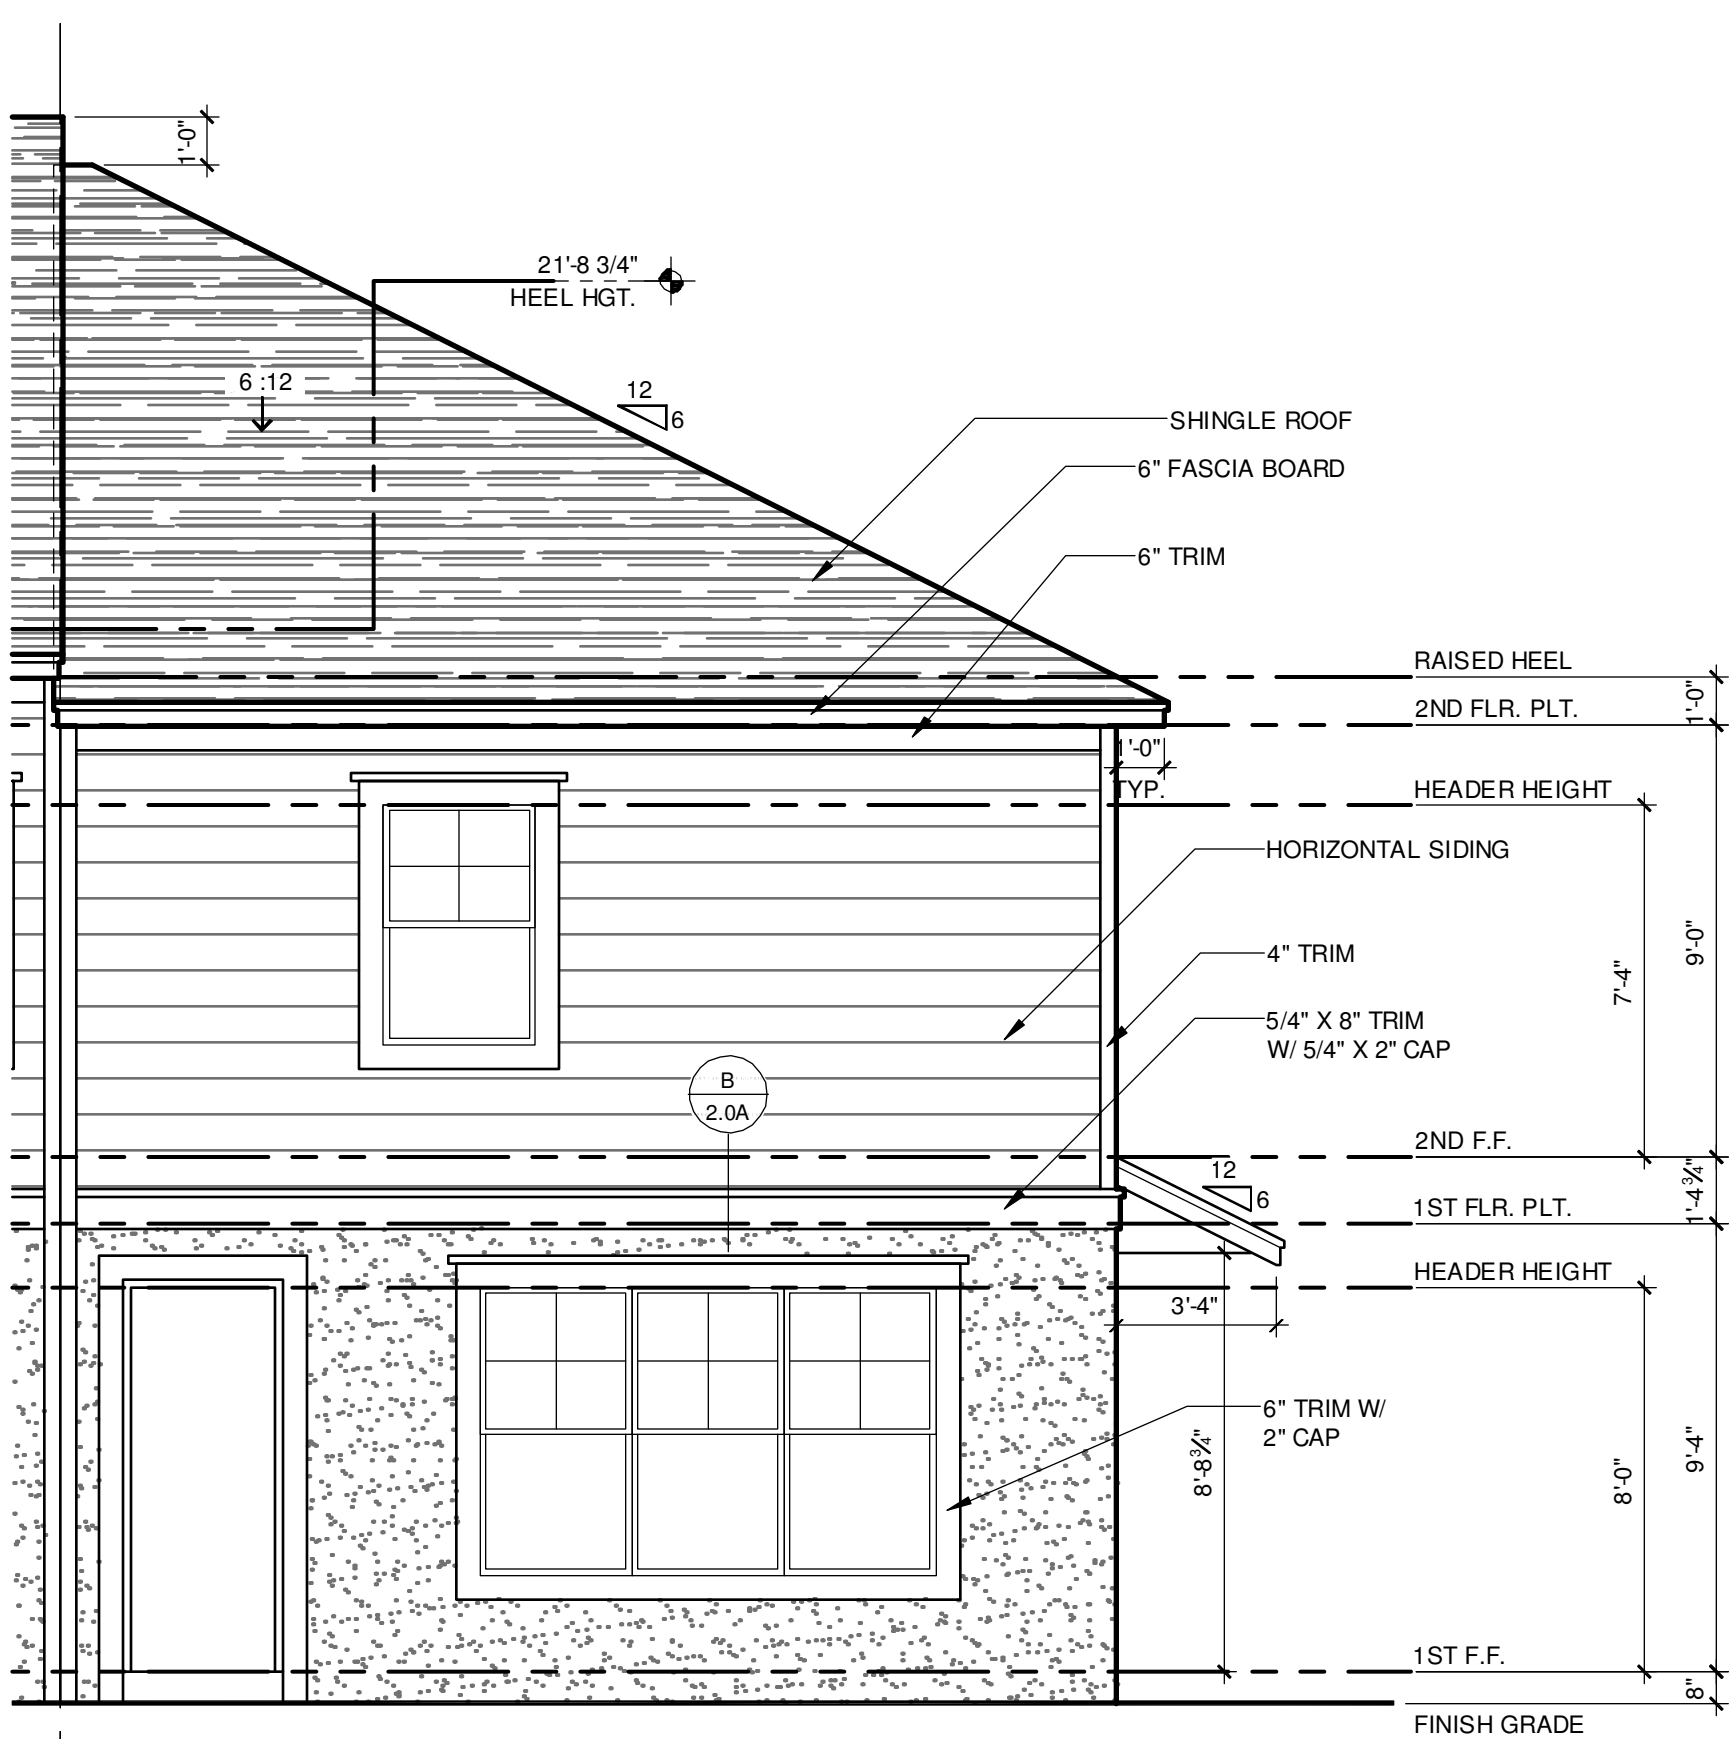


1914 - ADAMS REVERSED  
REAR ELEVATION "A"

1/4" = 1'-0"

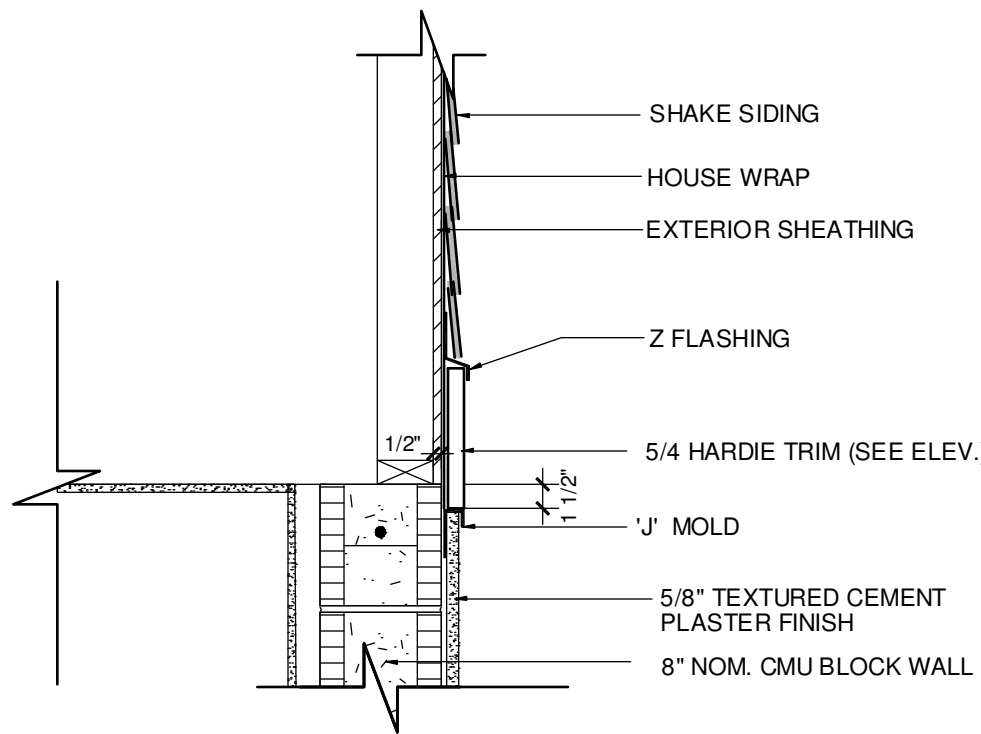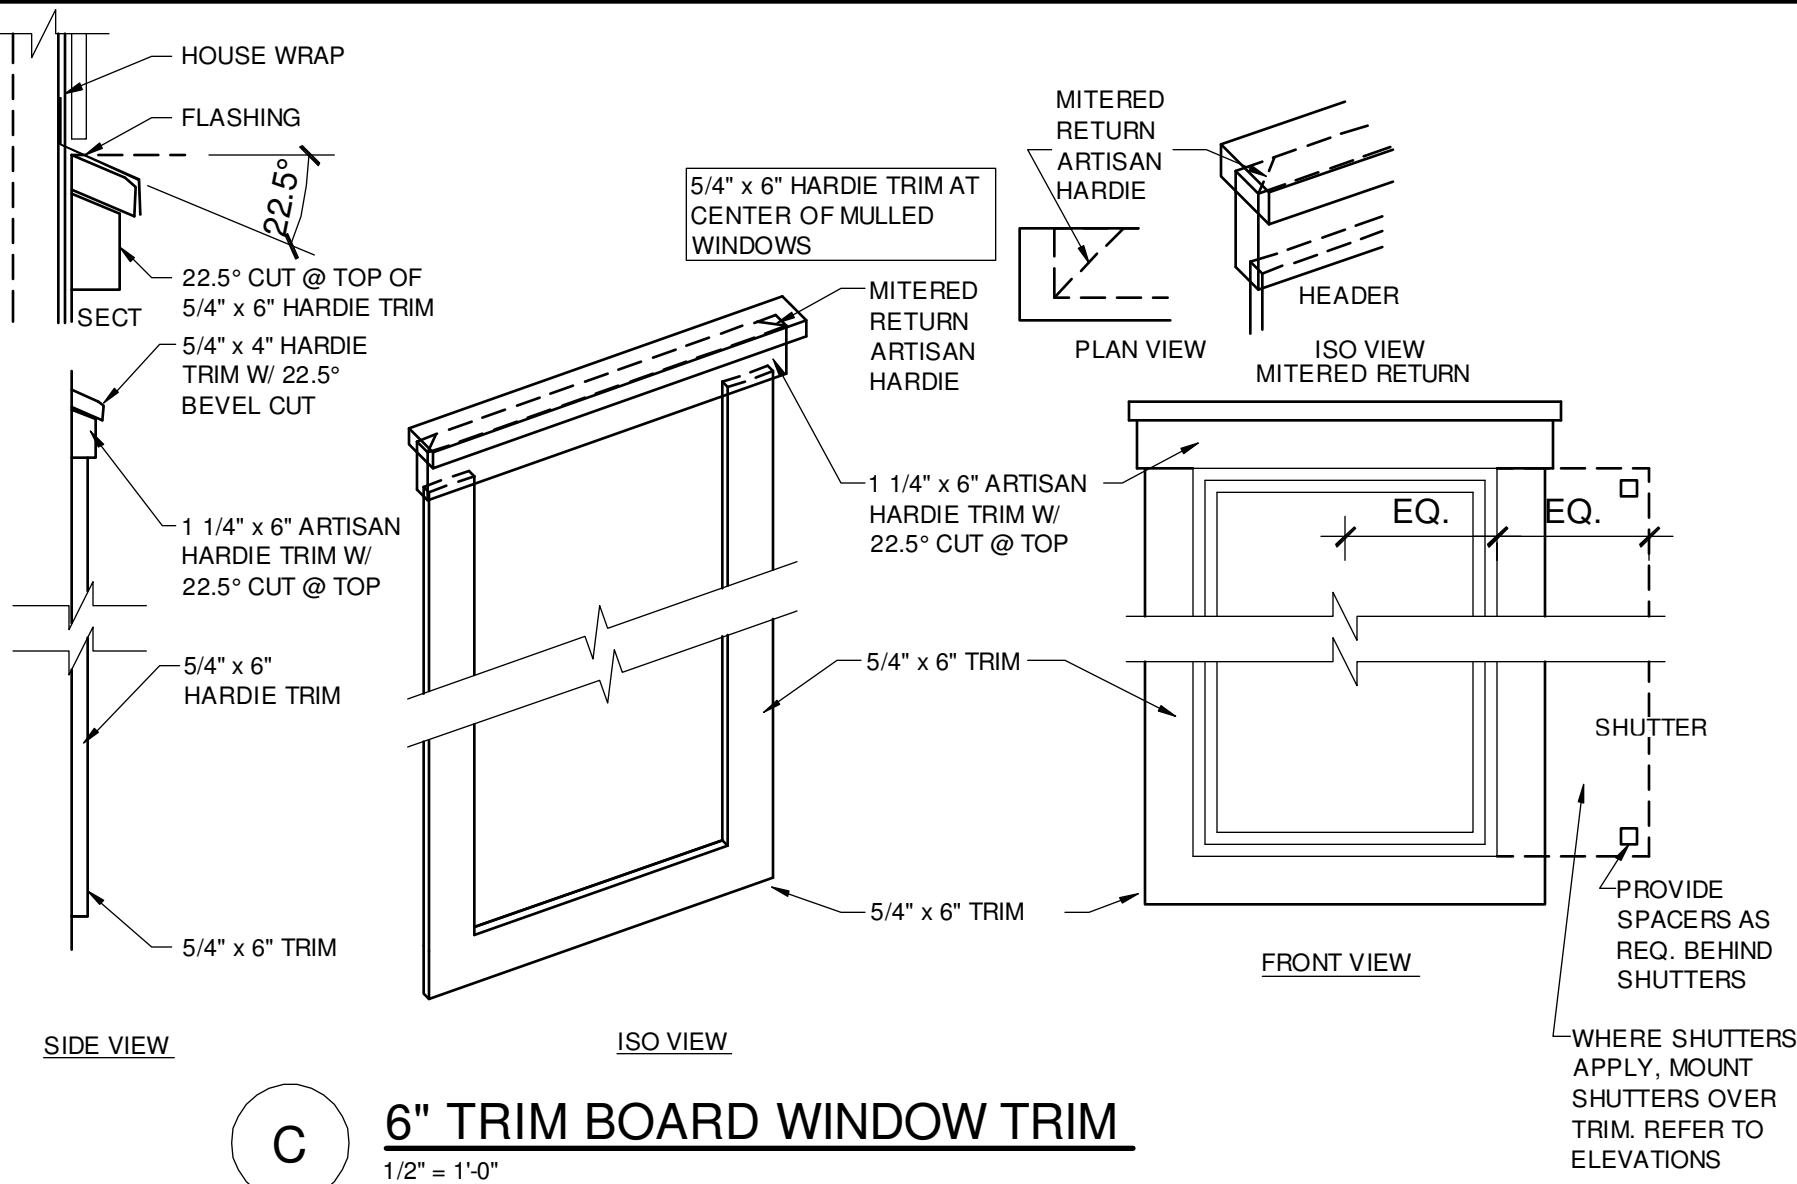

E SHAKE SIDING AT GABLE  
SCALE: 1" = 1'-0"

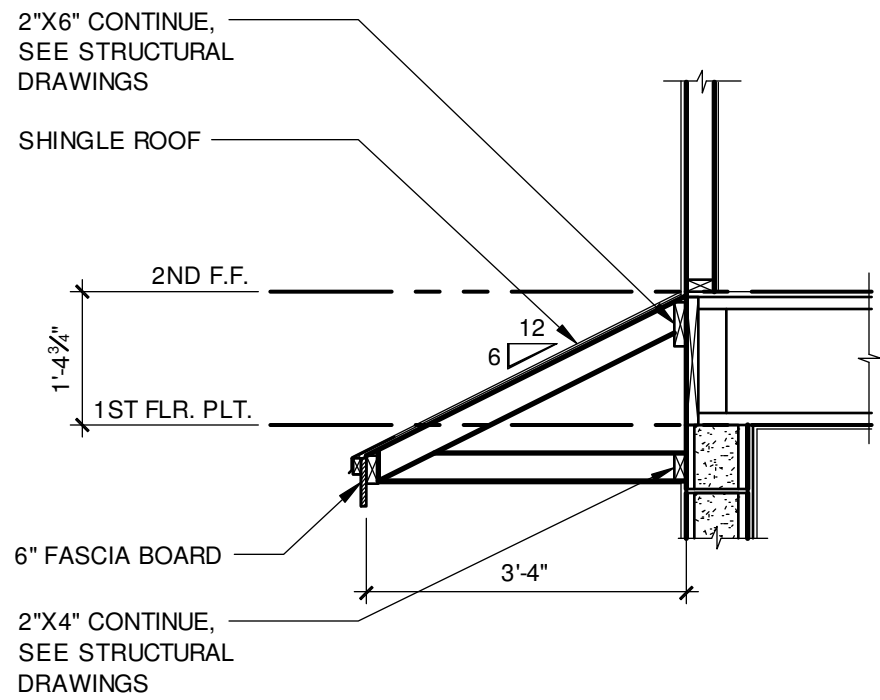

F SHED ROOF SECTION  
SCALE: 1" = 1'-0"

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AMERICAN  
INSTITUTE OF  
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289 Southall Lane, Suite 200, Melbourne, FL 32975  
P.O. Box 10000, Melbourne, FL 32902  
Office of Architecture No. 9181  
Office of Professional Engineering No. 12512  
DATE: April 14, 2023  
NOTES: SEE LIST OF REVISIONS FOR ALL REVISIONS. THE INFORMATION HEREIN IS UNLESS OTHERWISE NOTED FOR THE DRAWING.

FDS JOB NO.:

PARK SQUARE  
HORIZONS WEST  
BABCOCK RANCH BLDG 6 (LOTS 6092-6099) 4 UNIT

title:  
1914 - ADAMS  
EXT. ELEVATIONS

project no. 2023083  
checked: BF  
drawn: BA  
date: 04-12-23  
scale: AS SHOWN

2.1D  
ELEV. A


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DISCLAIMER


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UNIT 6092 1914 ADAMS REVERSED



ELEVATION - KEY PLAN

1/32" = 1'-0"

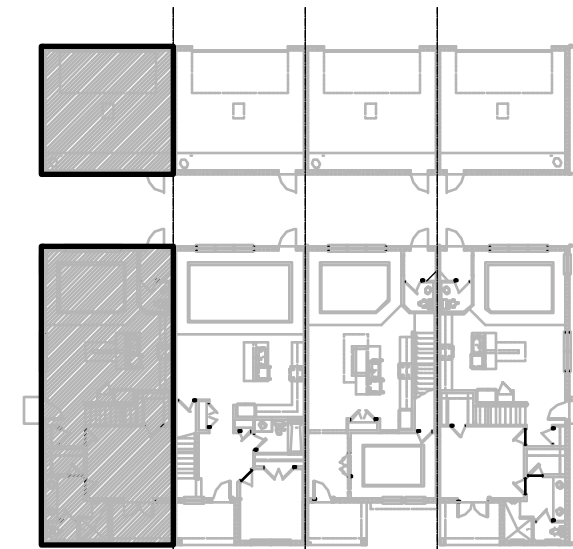

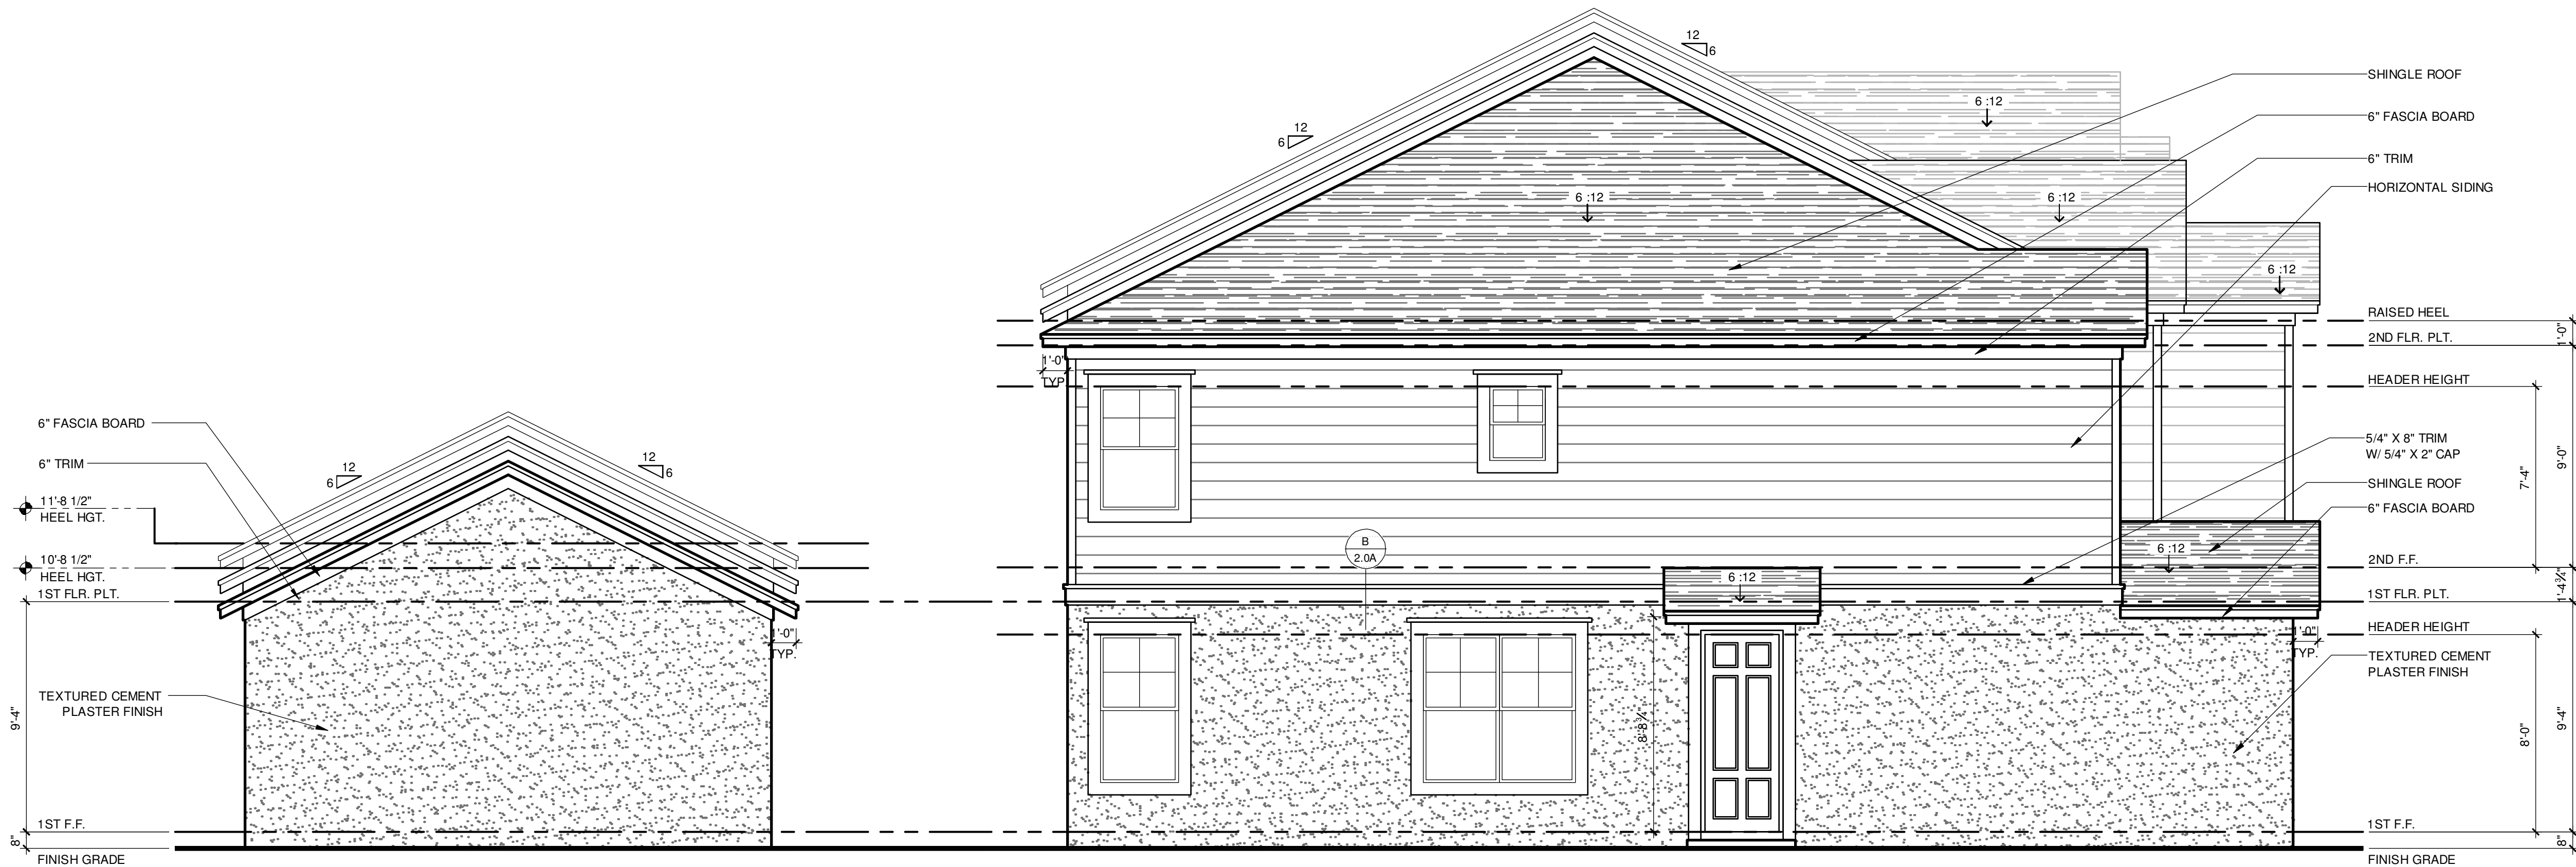1914 - ADAMS REVERSED  
LEFT ELEVATION "A"

1/4" = 1'-0"



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Cell: 321.225.1112  
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SCOTT LEWIS, P.E., F.D.S.  
SCOTT LEWIS, P.E., F.D.S.

DATE: April 14, 2023

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FDS JOB NO.:

PARK SQUARE  
HORIZONS WEST  
BABCOCK RANCH BLDG 6 (LOTS 6092-6099) 4 UNIT

Title:  
1914 - ADAMS  
EXT. ELEVATIONS

project no. 2023083  
checked: BF  
drawn: BA  
date: 04-12-23  
scale: AS SHOWN

2.2D  
ELEV. A

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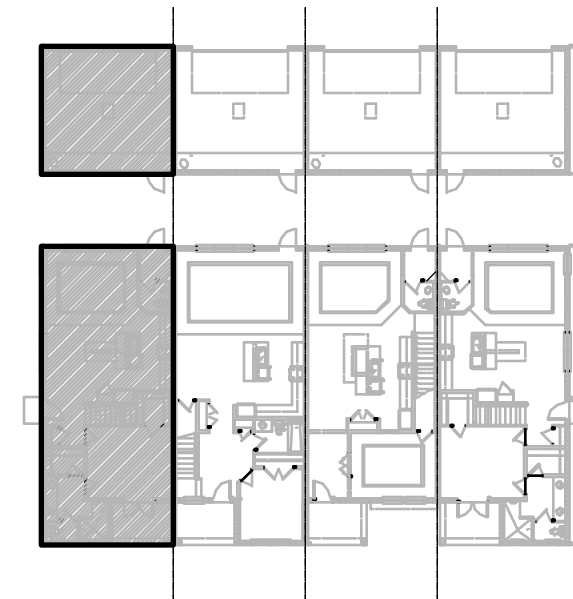
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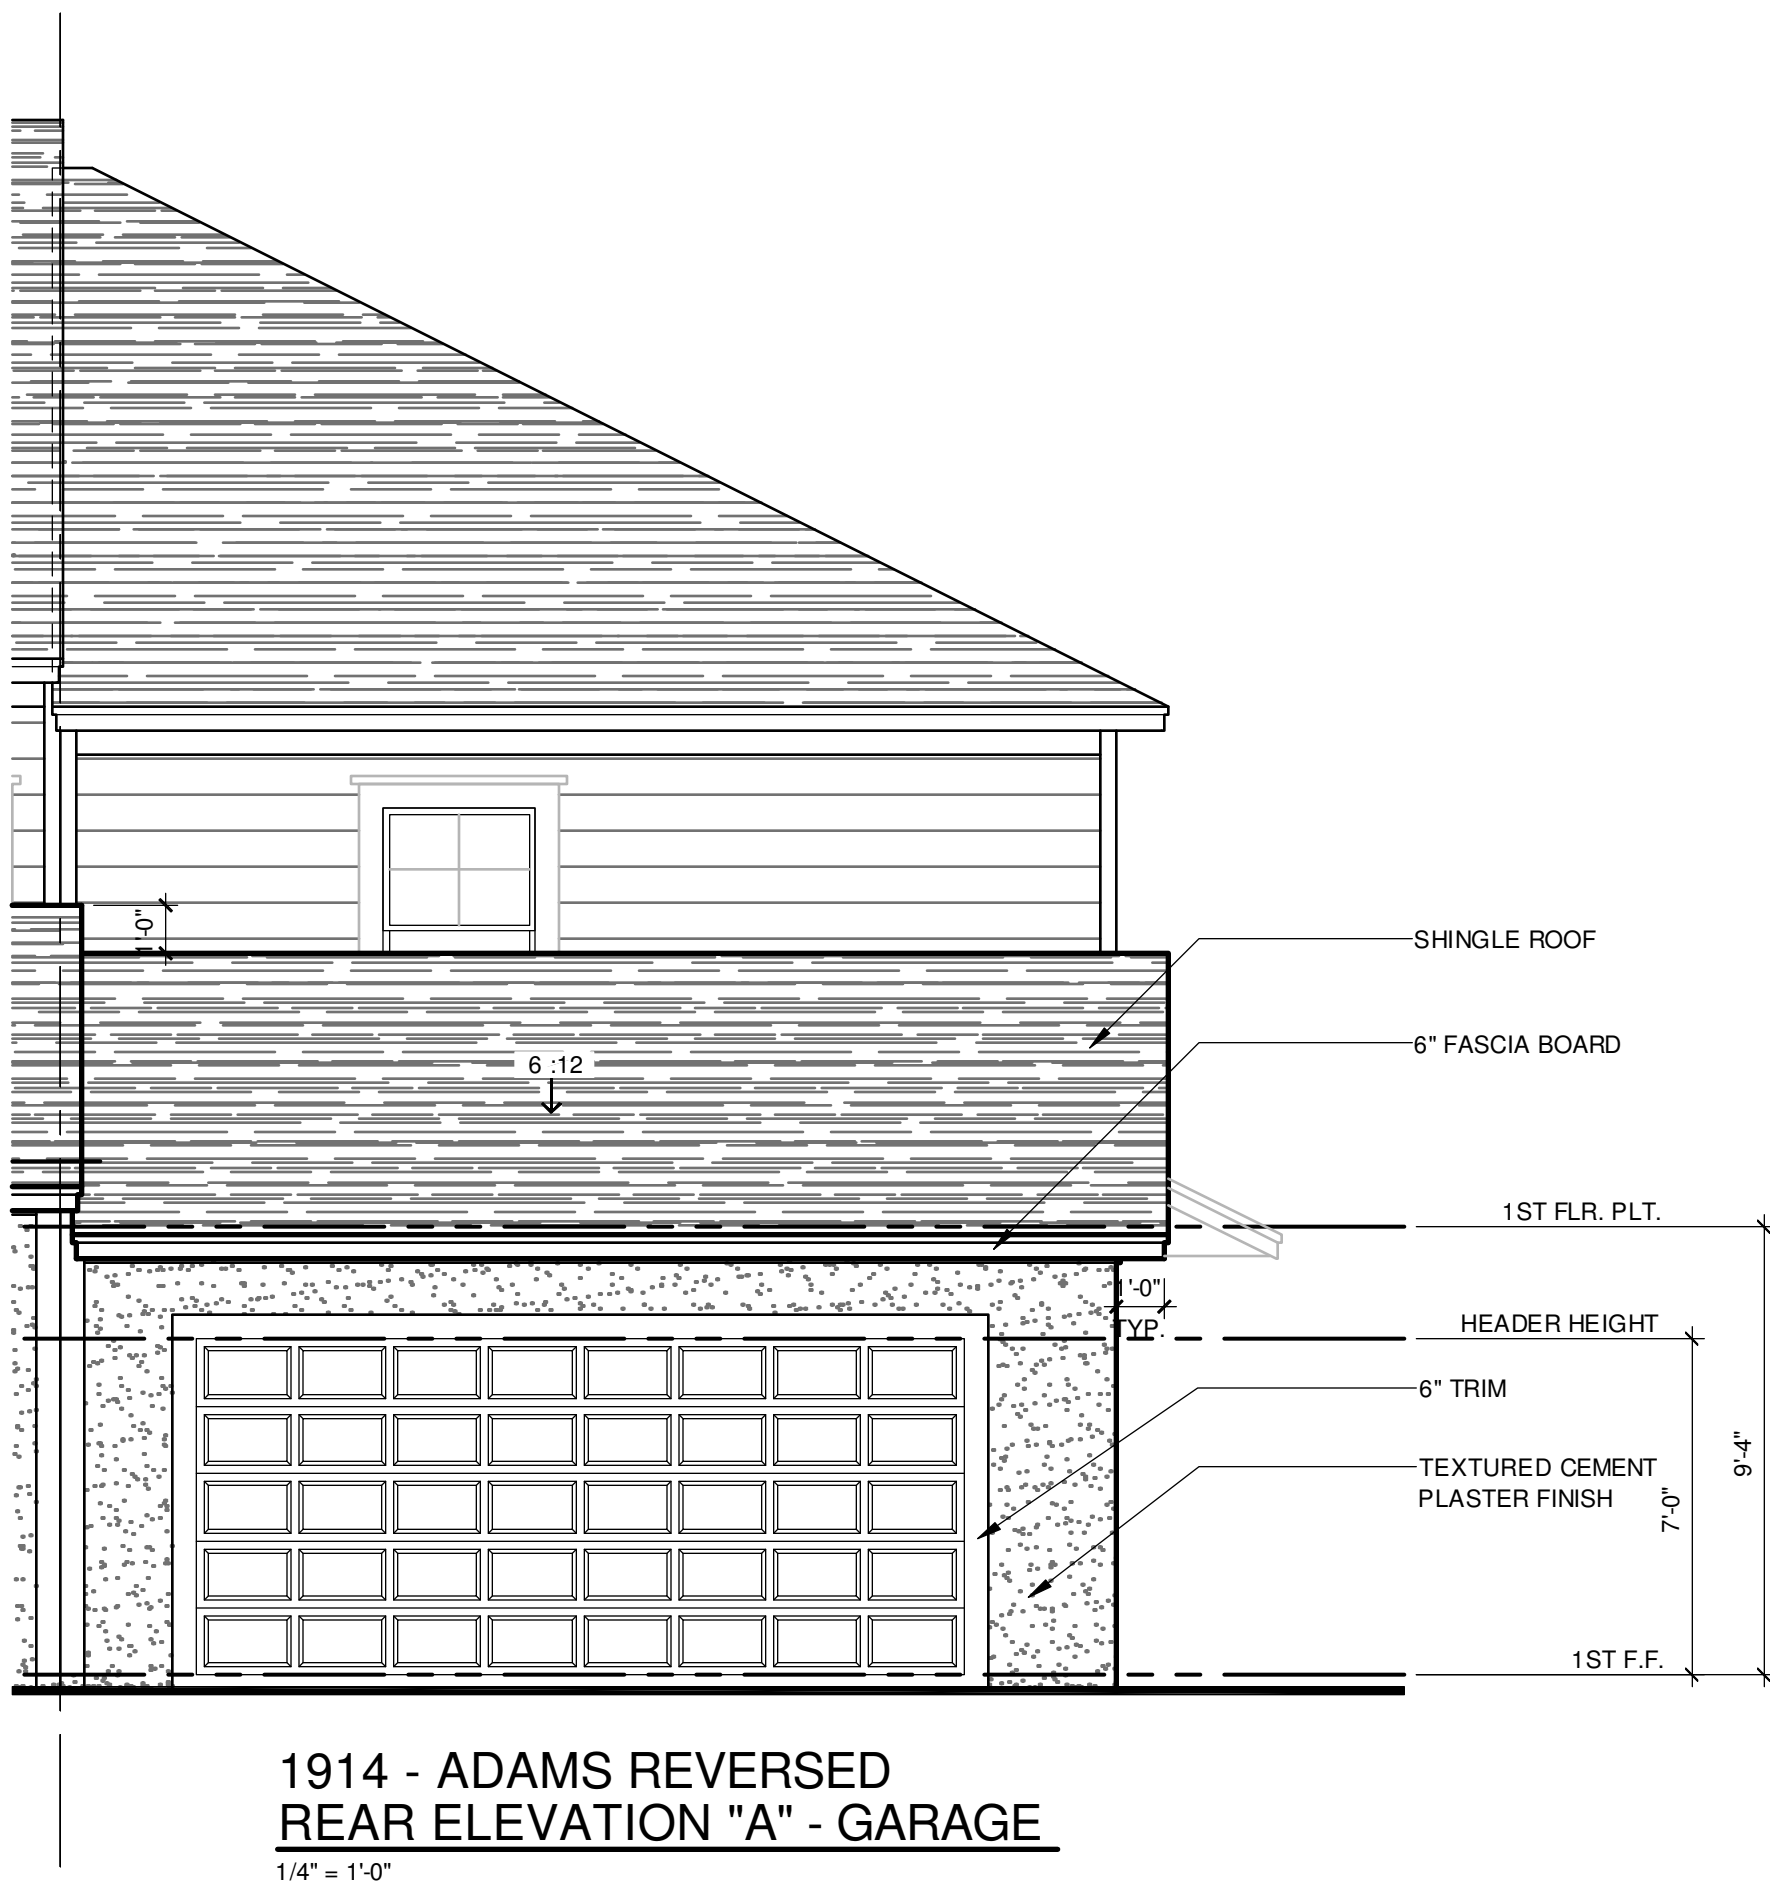
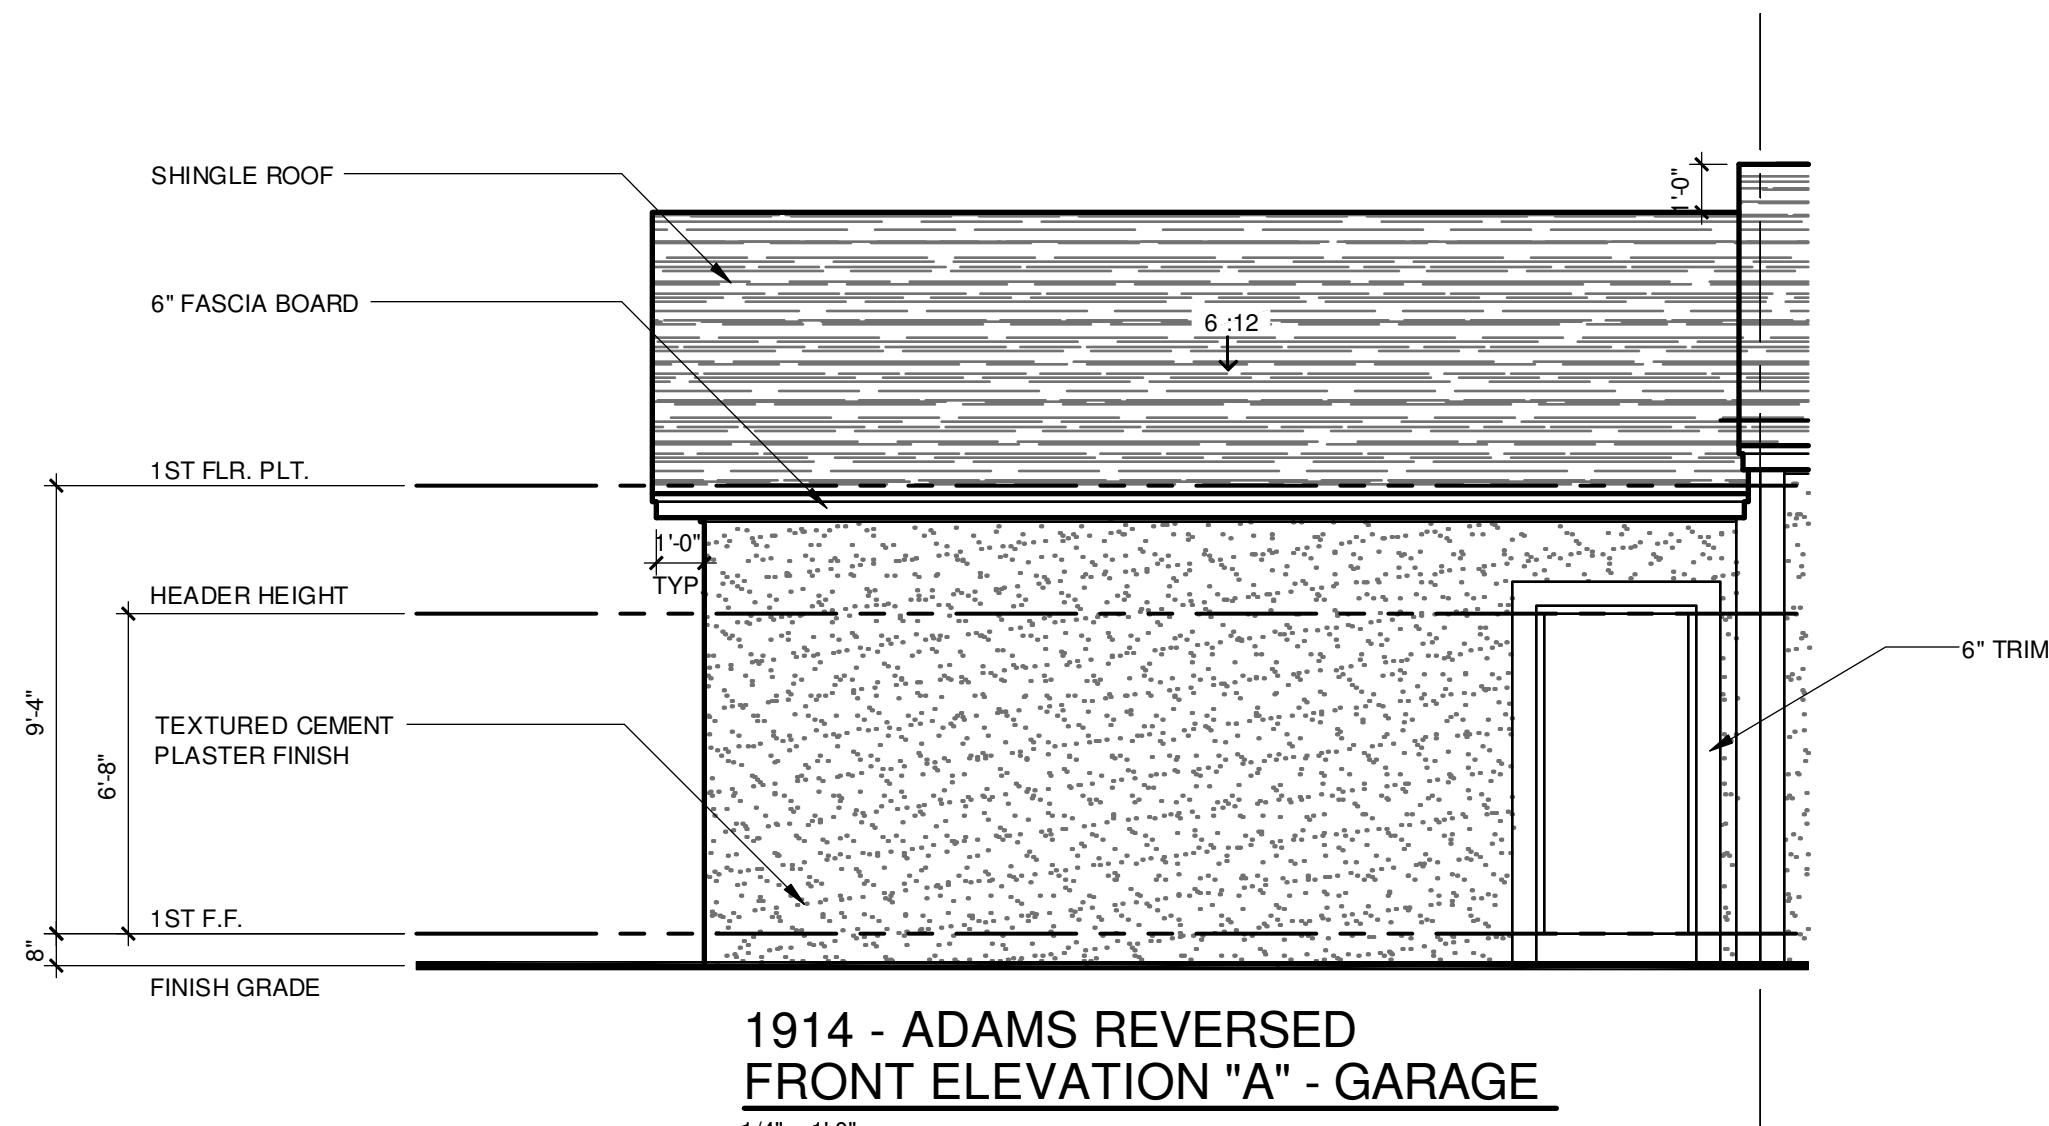
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UNIT 6092 1914 ADAMS REVERSED



ELEVATION - KEY PLAN

1/32" = 1'-0"



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DATE: April 14, 2023

FDS JOB NO.:

PARK SQUARE  
HORIZONS WEST  
BABCOCK RANCH BLDG 6 (LOTS 6092-6099) 4 UNIT

title:  
1914 - ADAMS  
EXT. ELEVATIONS

project no. 2023083  
checked: BF  
drawn: BA  
date: 04-12-23  
scale: AS SHOWN

2.3D  
ELEV. A


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Title:  
4 UNIT / 2-STORY  
SLAB INTERFACE

project no. 2023083  
checked:  
drawn: BA  
date: 04-12-23  
scale: AS SHOWN

3.0  
ELEV. A

PARK SQUARE  
HORIZONS WEST  
BABCOCK RANCH BLDG 6 (LOTS 6092-6089) 4 UNIT

FDS JOB NO.:

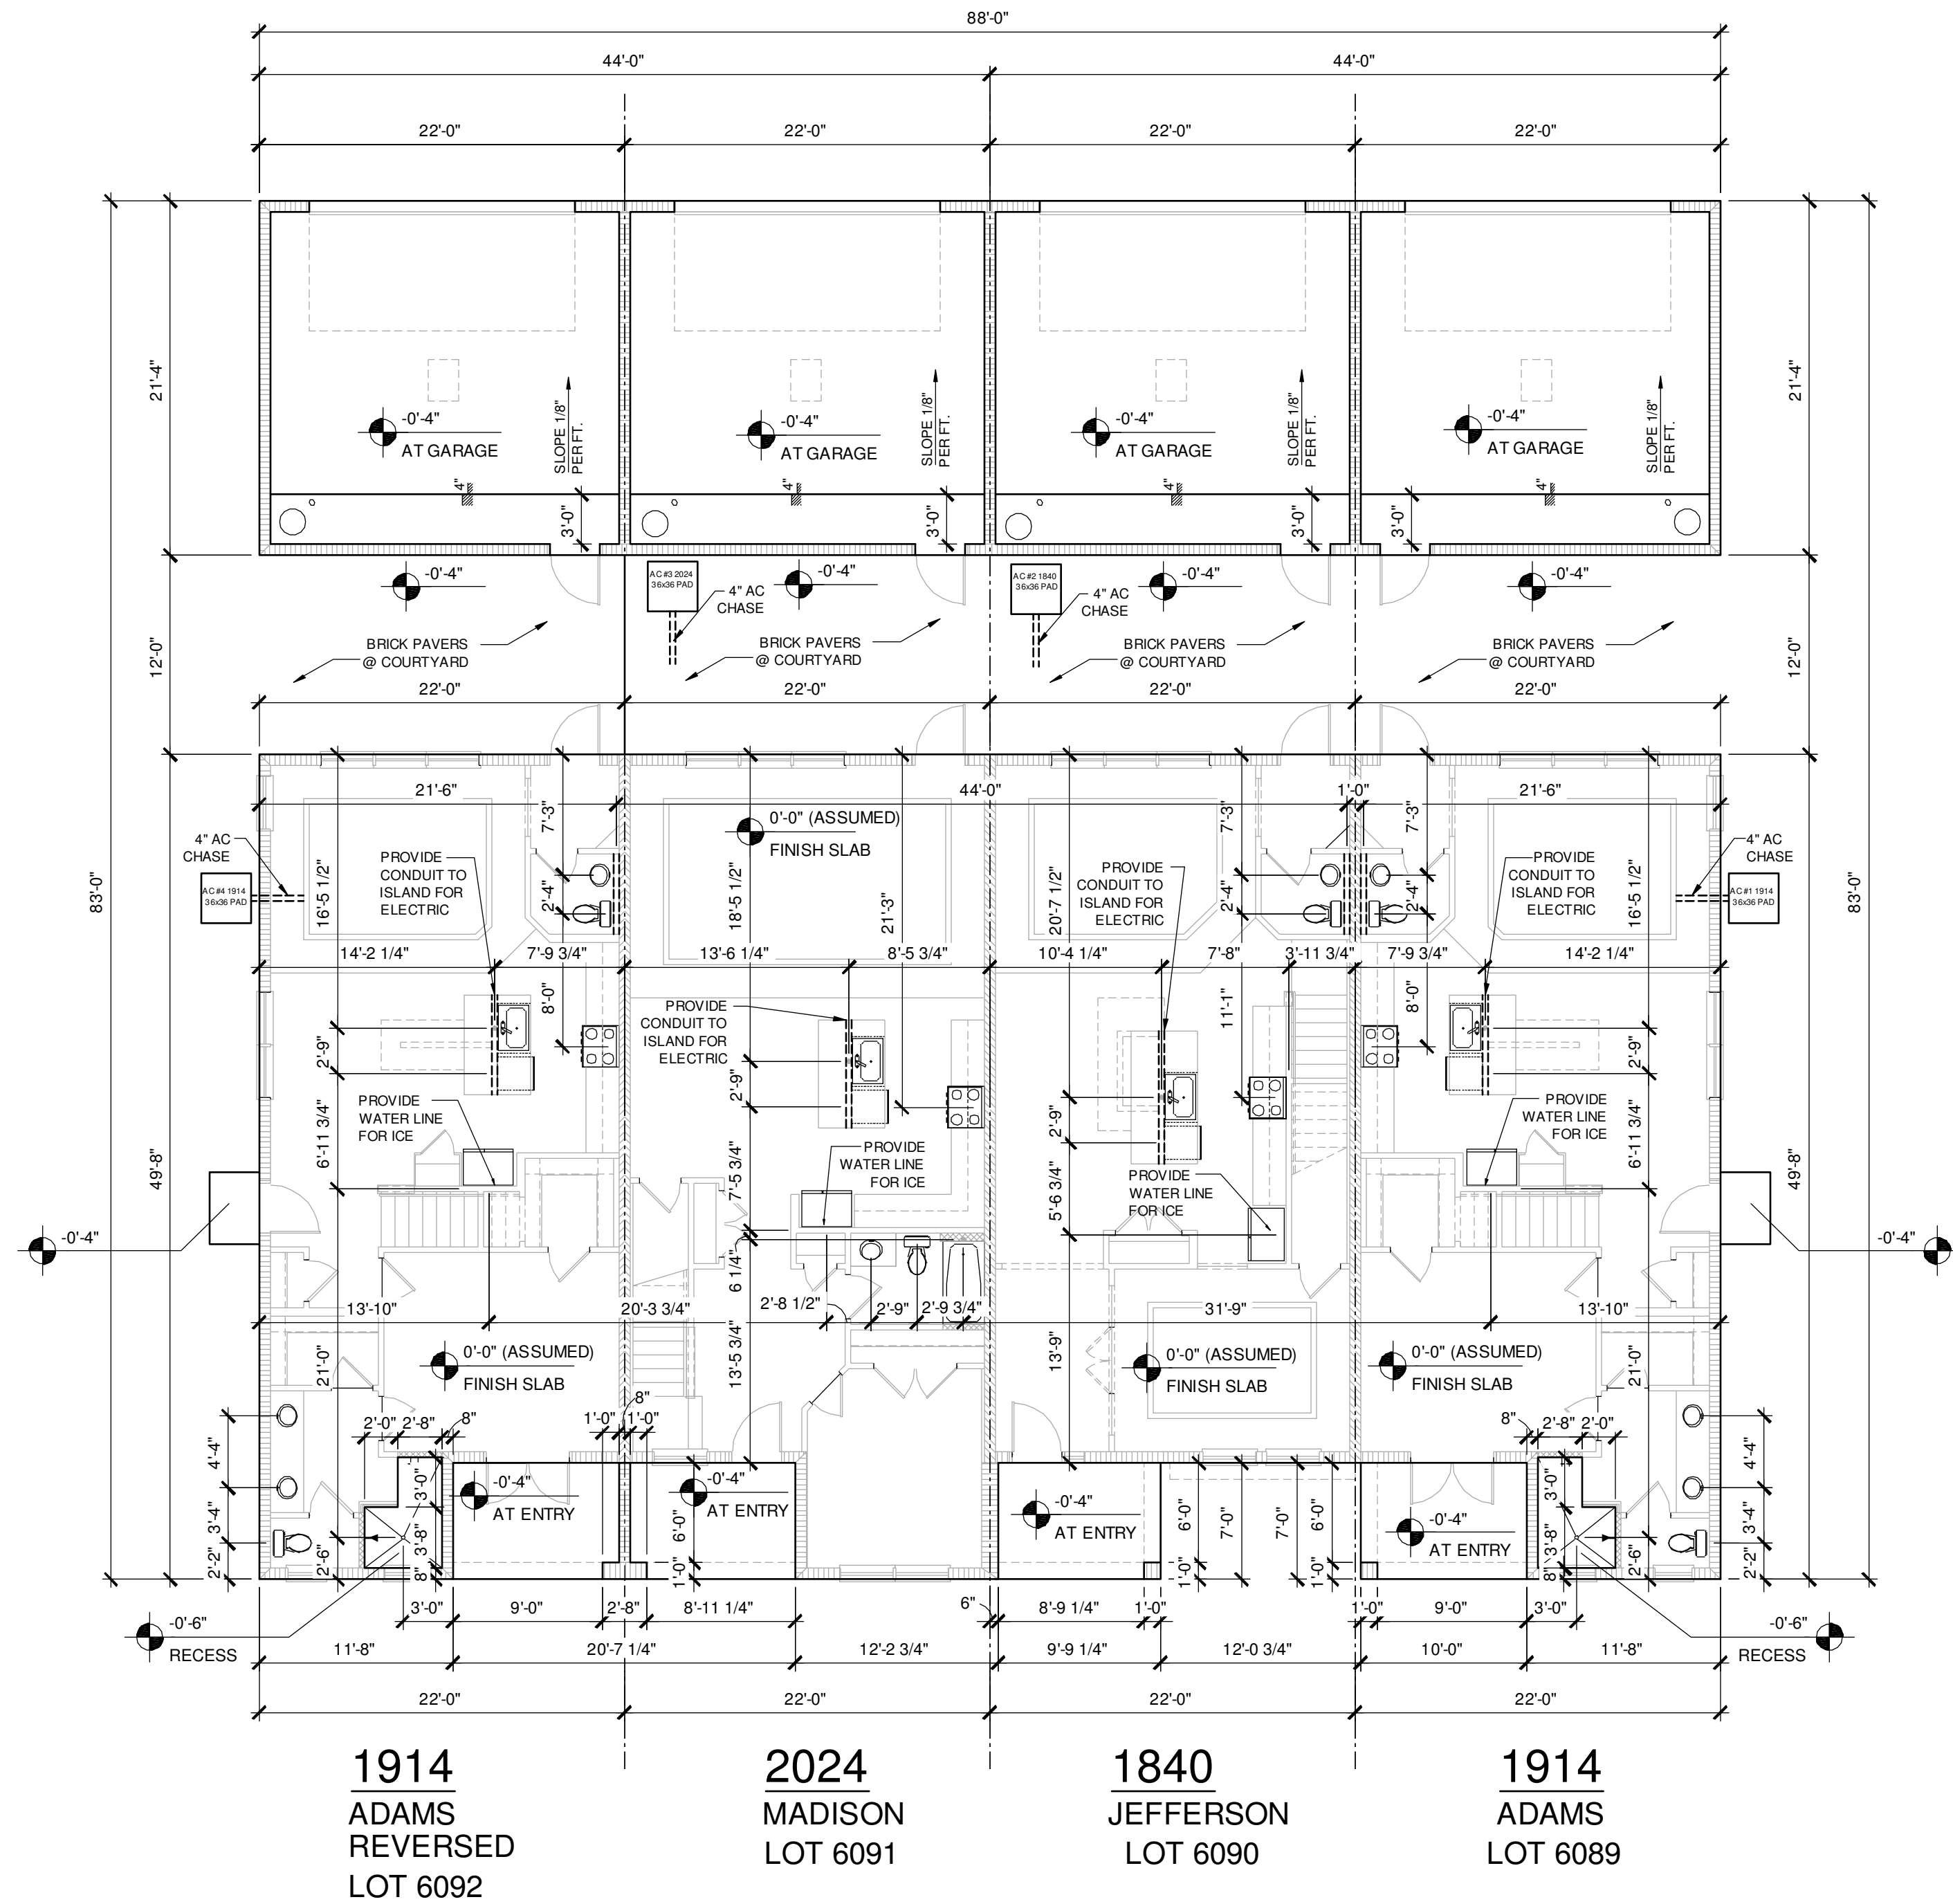

288 Southall Lane, Suite 200, Maitland, FL 32751  
P.O. Box 16000, Maitland, FL 32751  
Certificate of Authorization No. 9191  
□ CARLA A. BROWN, PE, FL #5828  
□ SCOTT LEWIS, PE, FL #78700  
DATE: April 14, 2023  
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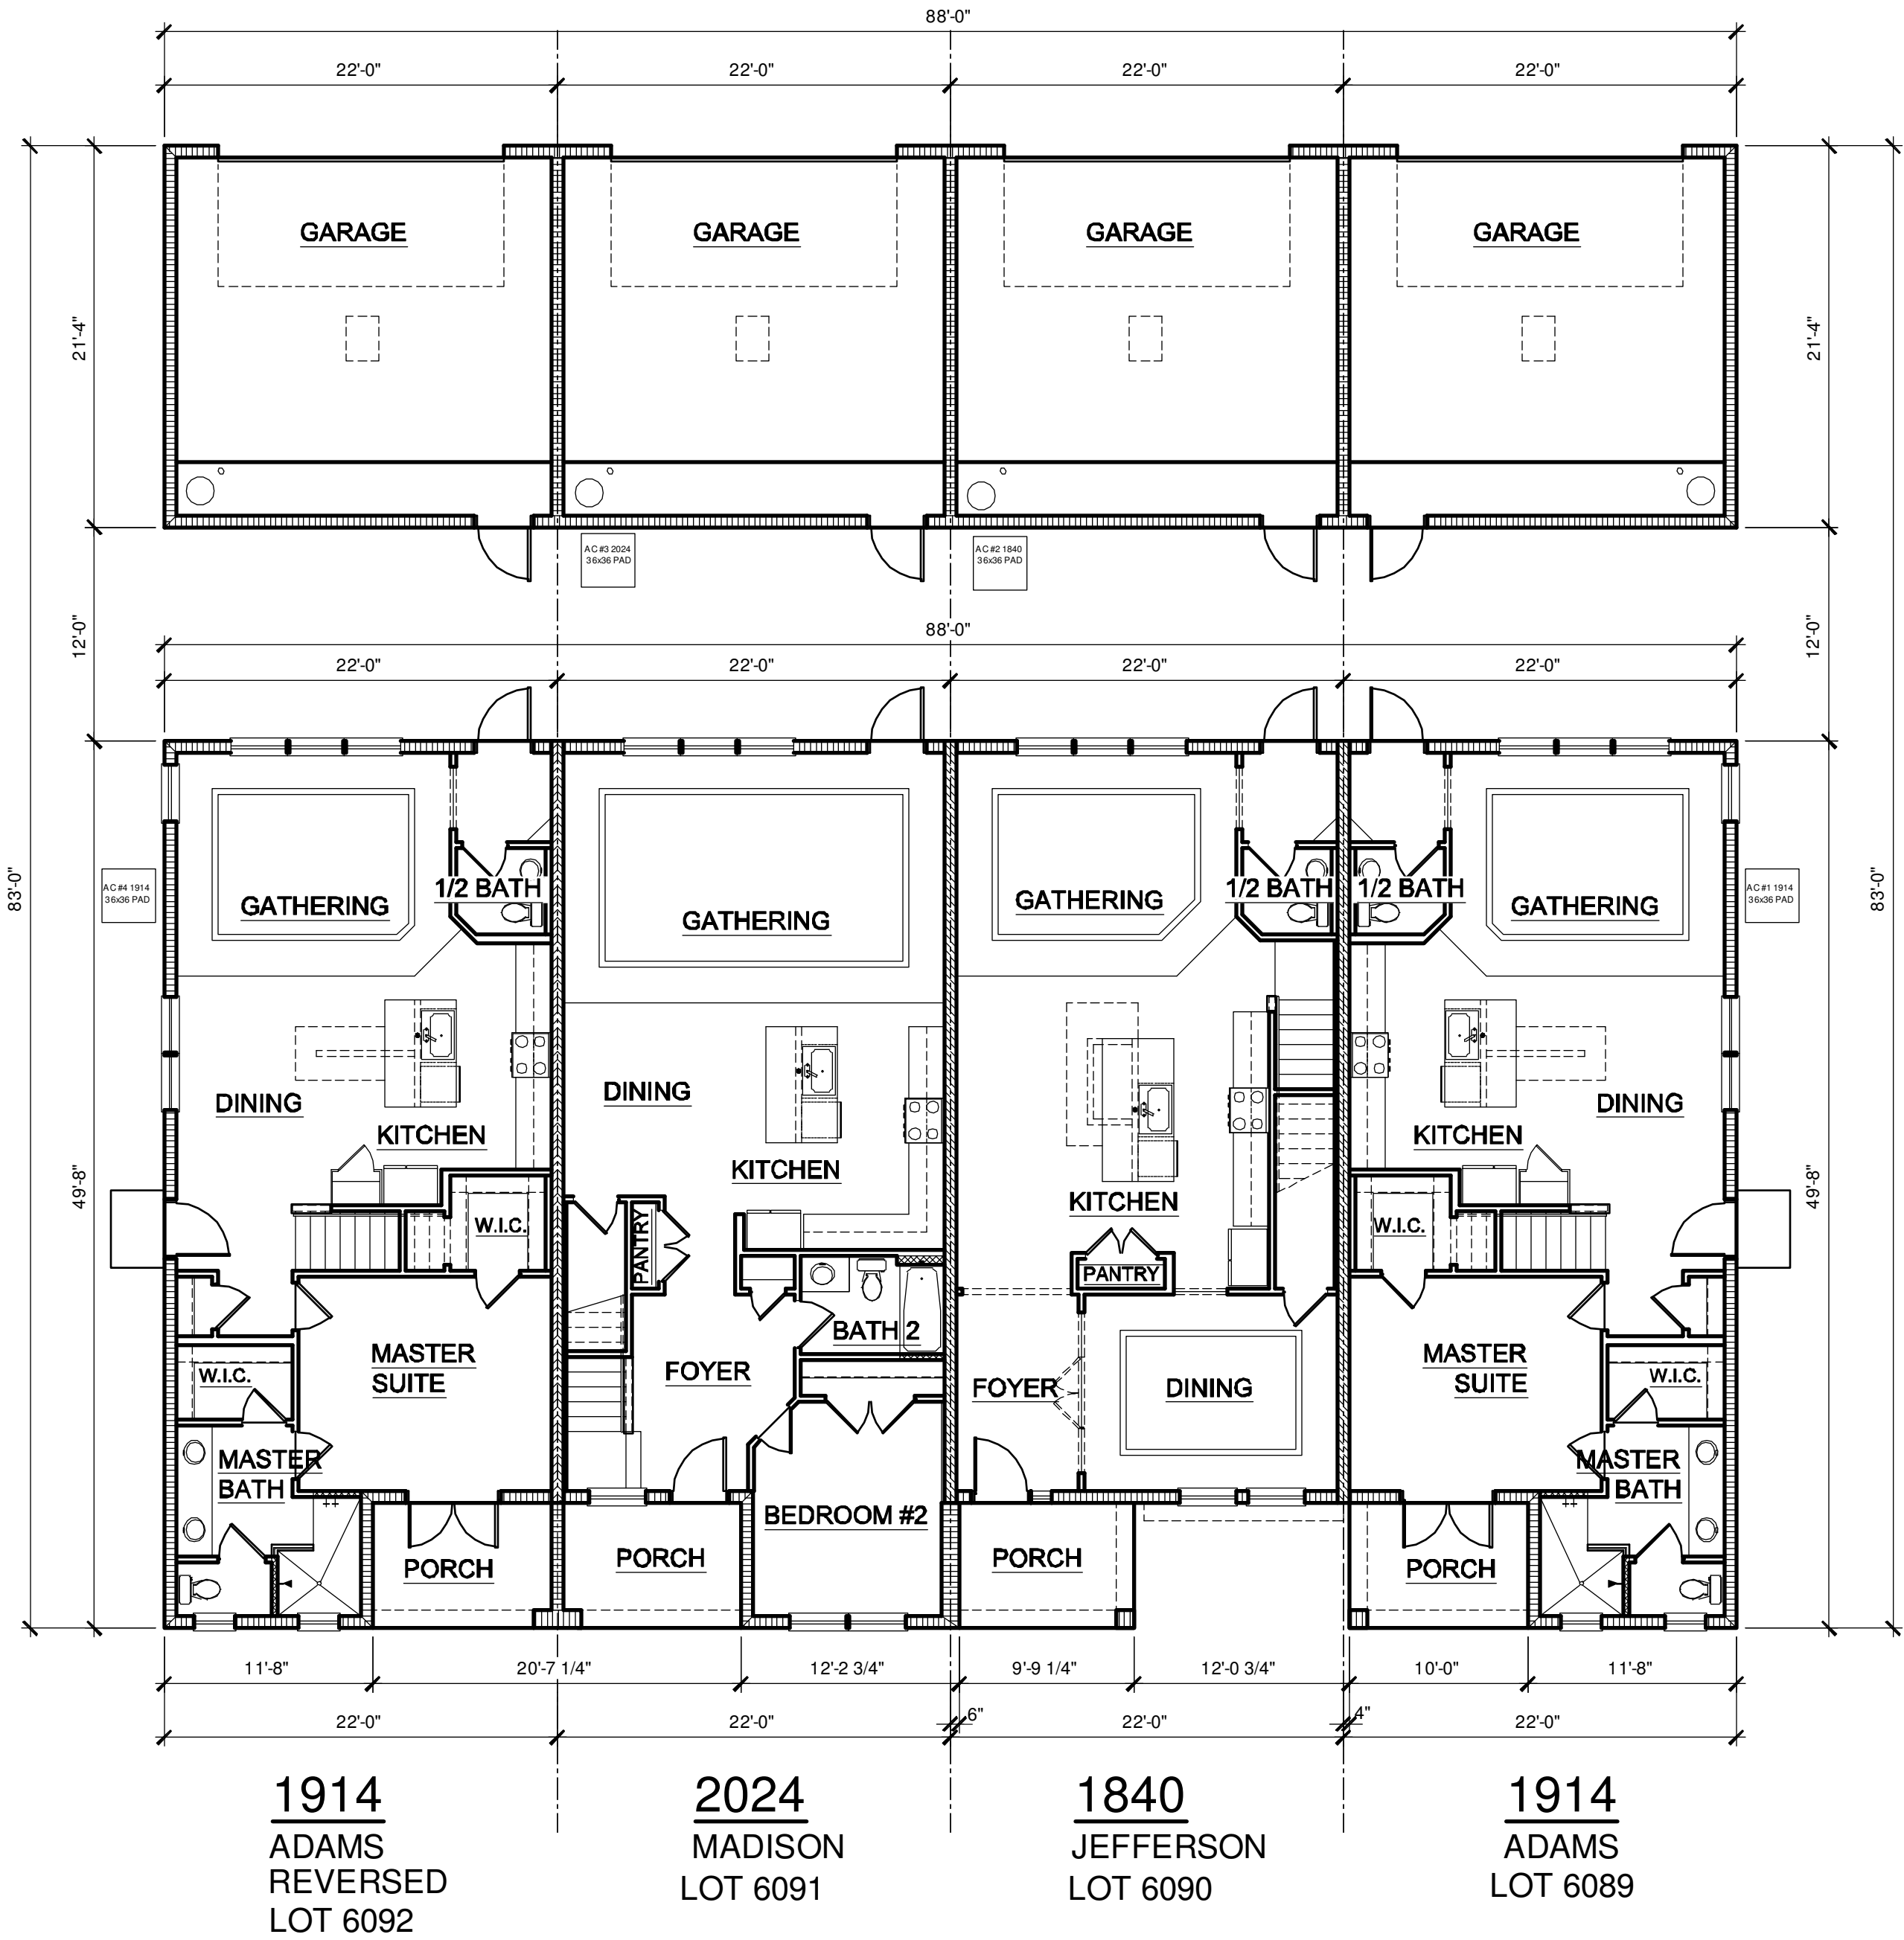


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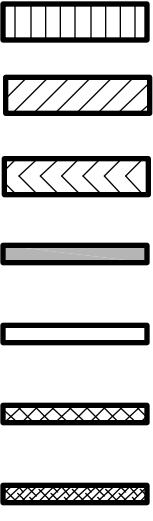


**1ST FLOOR PLAN - 4 UNIT**

1/8" = 1'-0"

**WALL LEGEND**

- INDICATES 8x8x16 (NOM.) C.M.U. (EXTERIOR LOAD BEARING ), 9'-4" TOP OF CMU
- INDICATES 8x8x16 (NOM.) C.M.U. (EXTERIOR LOAD BEARING ), 10'-8" TOP OF CMU
- INDICATES 8x8x16 (NOM.) C.M.U. (EXTERIOR LOAD BEARING ), 10'-8" TOP OF CMU
- INDICATES WALLS TO BE UTILIZED FOR TRUSS BEARING 2x4 WOOD STUDS @ 16" O.C. U.N.O.
- INDICATES 2X WOOD PARTITIONS, (NON LOAD BEARING INTERIOR PARTITIONS ONLY.) (U.N.O.)
- INDICATES WET WALLS, 2X WOOD STUDS @ 12" O.C.
- INDICATES INSULATED WALLS



Title:  
**4 UNIT / 2-STORY  
1ST FLOOR PLAN**


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checked: BF  
drawn: BA  
date: 04-12-23  
scale: AS SHOWN

**3.1  
ELEV. A**

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Office: 908.226.1111  
Fax: 908.226.1112  
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□ CARLA BROWN, PE, FL #58128  
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DATE: April 14, 2023

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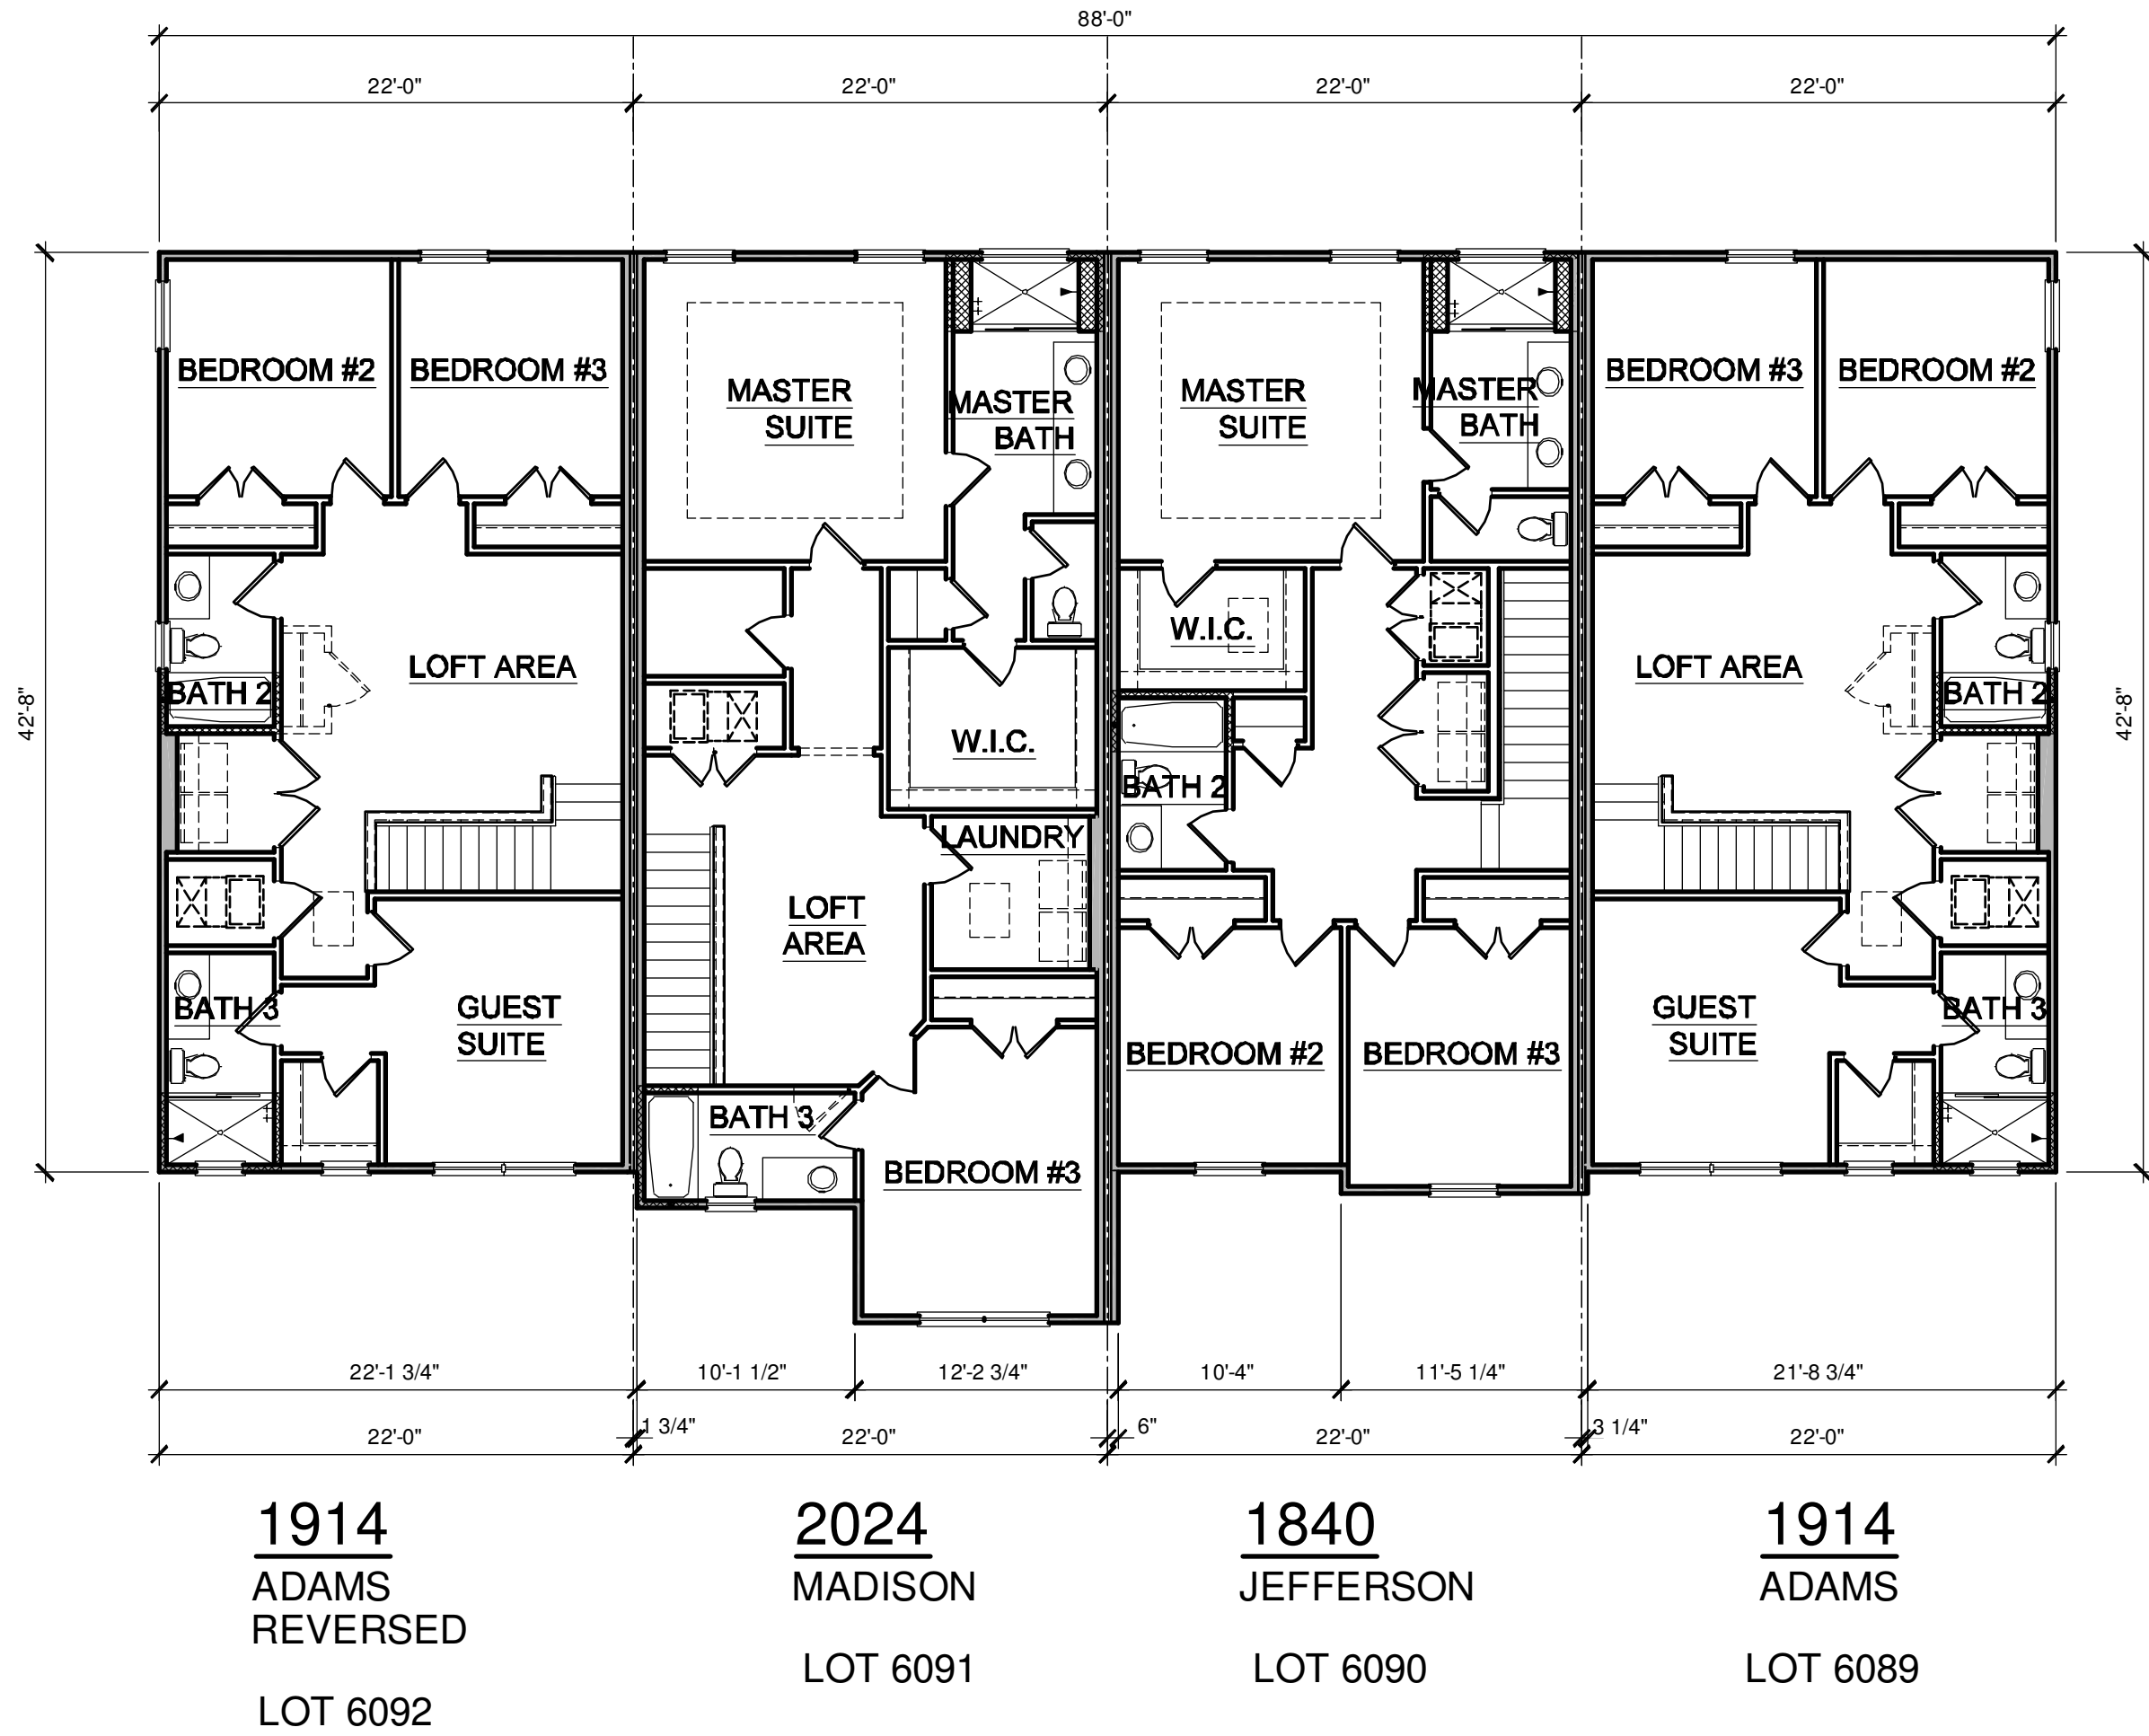
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**PARK SQUARE  
HORIZONS WEST  
BABCOCK RANCH BLDG 6 (LOTS 6092-6089) 4 UNIT**

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2ND FLOOR PLAN - 4 UNIT

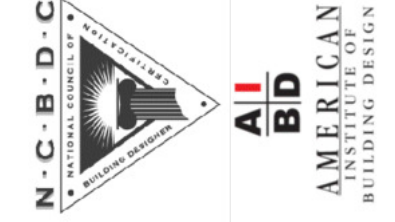1/4" = 1'-0"

WALL LEGEND

- INDICATES 8x8x16 (NOM.) C.M.U. (EXTERIOR LOAD BEARING ). 9'-4" TOP OF CMU
- INDICATES 8x8x16 (NOM.) C.M.U. (EXTERIOR LOAD BEARING ). 10'-8" TOP OF CMU
- INDICATES 8x8x16 (NOM.) C.M.U. (EXTERIOR LOAD BEARING ). 10'-8" TOP OF CMU
- INDICATES WALLS TO BE UTILIZED FOR TRUSS BEARING 2x4 WOOD STUDS @ 16" O.C. U.N.O.
- INDICATES 2X WOOD PARTITIONS. (NON LOAD BEARING INTERIOR PARTITIONS ONLY.) (U.N.O.)
- INDICATES WET WALLS. 2X WOOD STUDS @ 12" O.C.
- INDICATES INSULATED WALLS

Title:

4 UNIT / 2-STORY  
2ND FLOOR PLAN

project no. 2023083

checked: BF

drawn: BA

date: 04-12-23

scale: AS SHOWN

3.2  
ELEV. A

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B.D.  
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E-MAIL: info@fdseng.com  
DATE: April 14, 2023  
BY: SCOTT LEWIS, P.E., F.D.S. #178700  
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HORIZONS WEST  
BABCOCK RANCH BLDG 6 (LOTS 6092-6089) 4 UNIT

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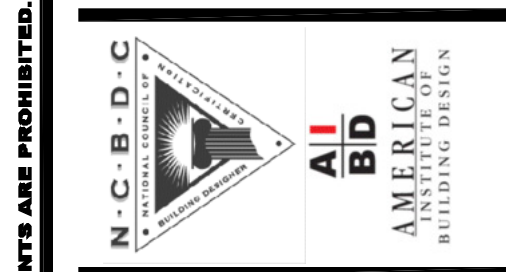
FRONT ELEVATION - 4 UNIT  
1/8" = 1'-0"



REAR ELEVATION - 4 UNIT  
1/8" = 1'-0"

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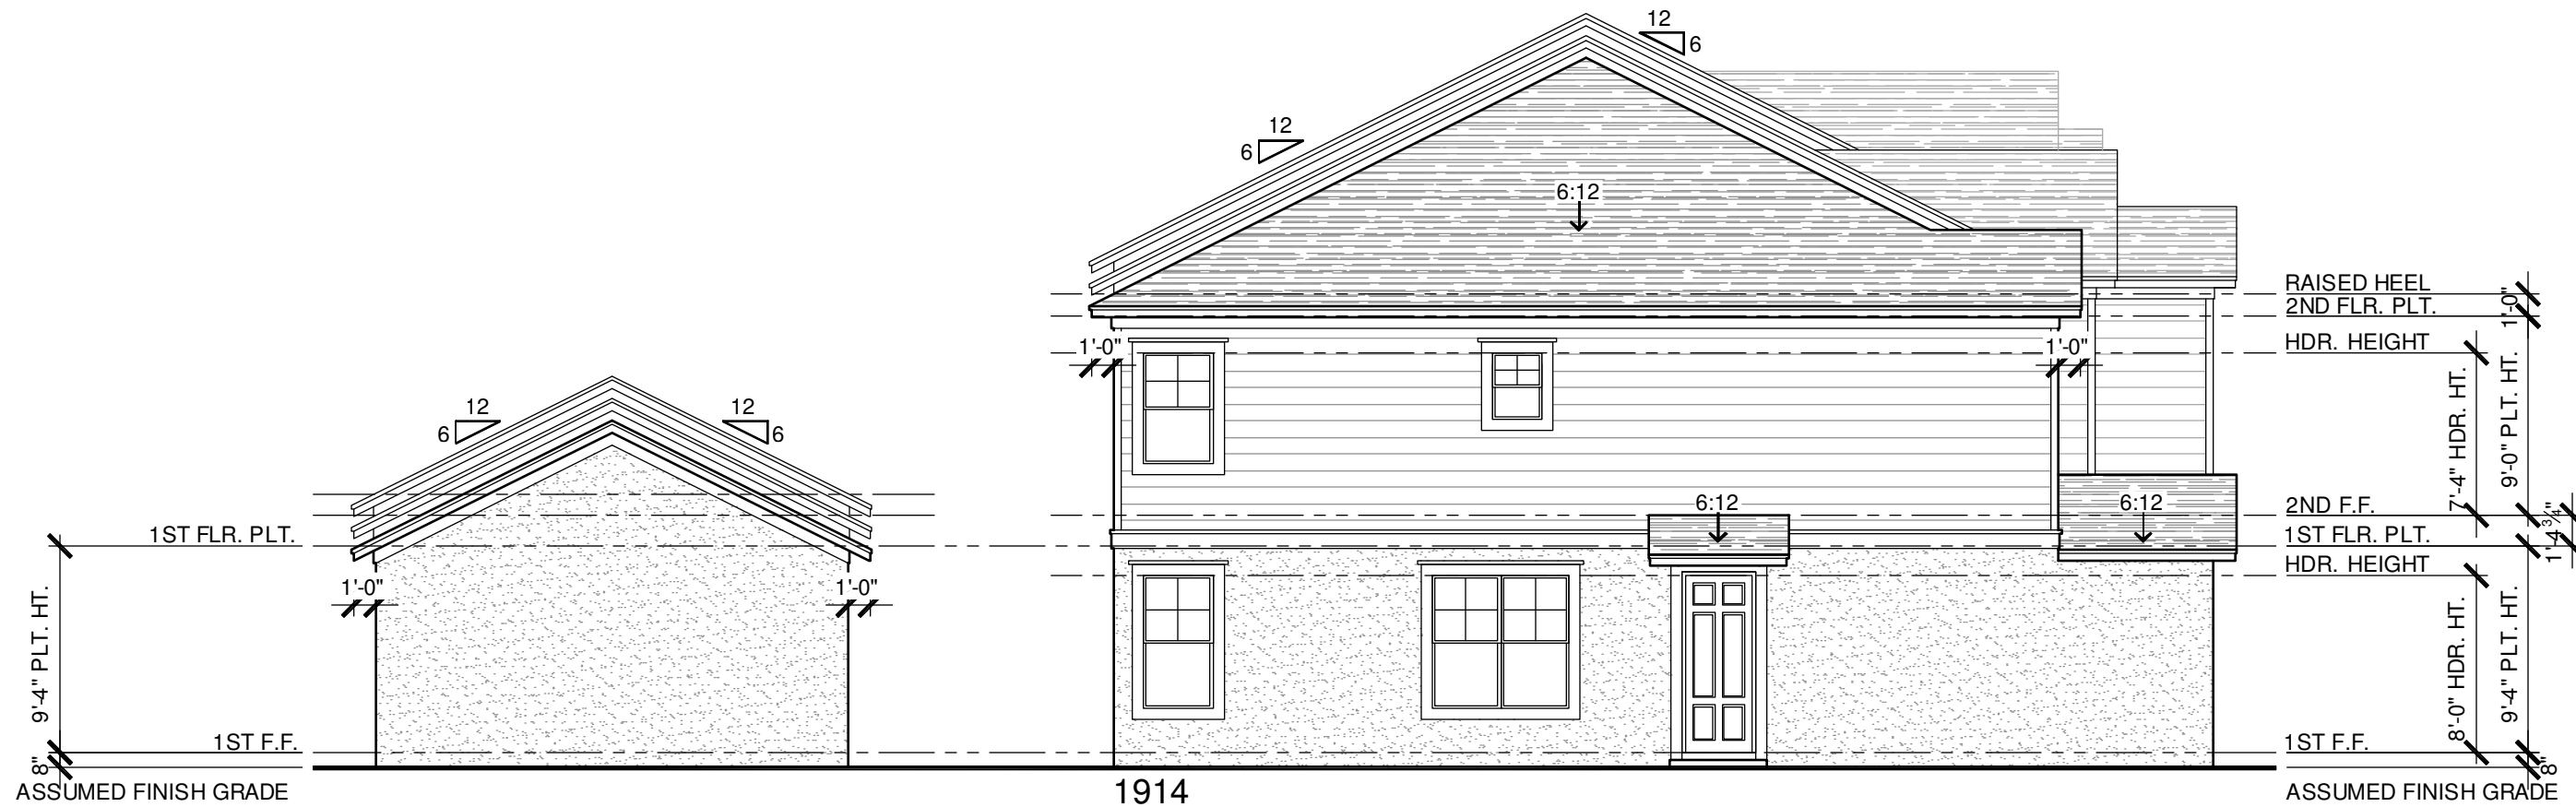
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P.O. Box 1000, Melbourne, FL 32902  
Certificate of Authorization No. 9161  
☐ CARL A. BROWN, PE - FL #58128  
☐ SCOTT LEWOWSKI, PE - FL #78750  
DATE: April 14, 2023  
TO THE BEST OF THE UNDERSIGNED'S KNOWLEDGE AND BELIEF, THE INFORMATION FURNISHED HEREON IS TRUE AND CORRECT IN ALL RESPECTS AND ACCORDS WITH THE REQUIREMENTS OF THE FLORIDA BUILDING CODE.

THIS JOB NO.:  
**PARK SQUARE  
HORIZONS WEST  
BABCOCK RANCH BLDG 6 (LOTS 6092-6089) 4 UNIT**


Title:  
**4 UNIT  
EXT. ELEVATIONS**

project no. 2023083  
checked: BF  
drawn: BA  
date: 04-12-23  
scale: AS SHOWN

**3.3  
ELEV. A**




LEFT ELEVATION - 4 UNIT  
1/8" = 1'-0"

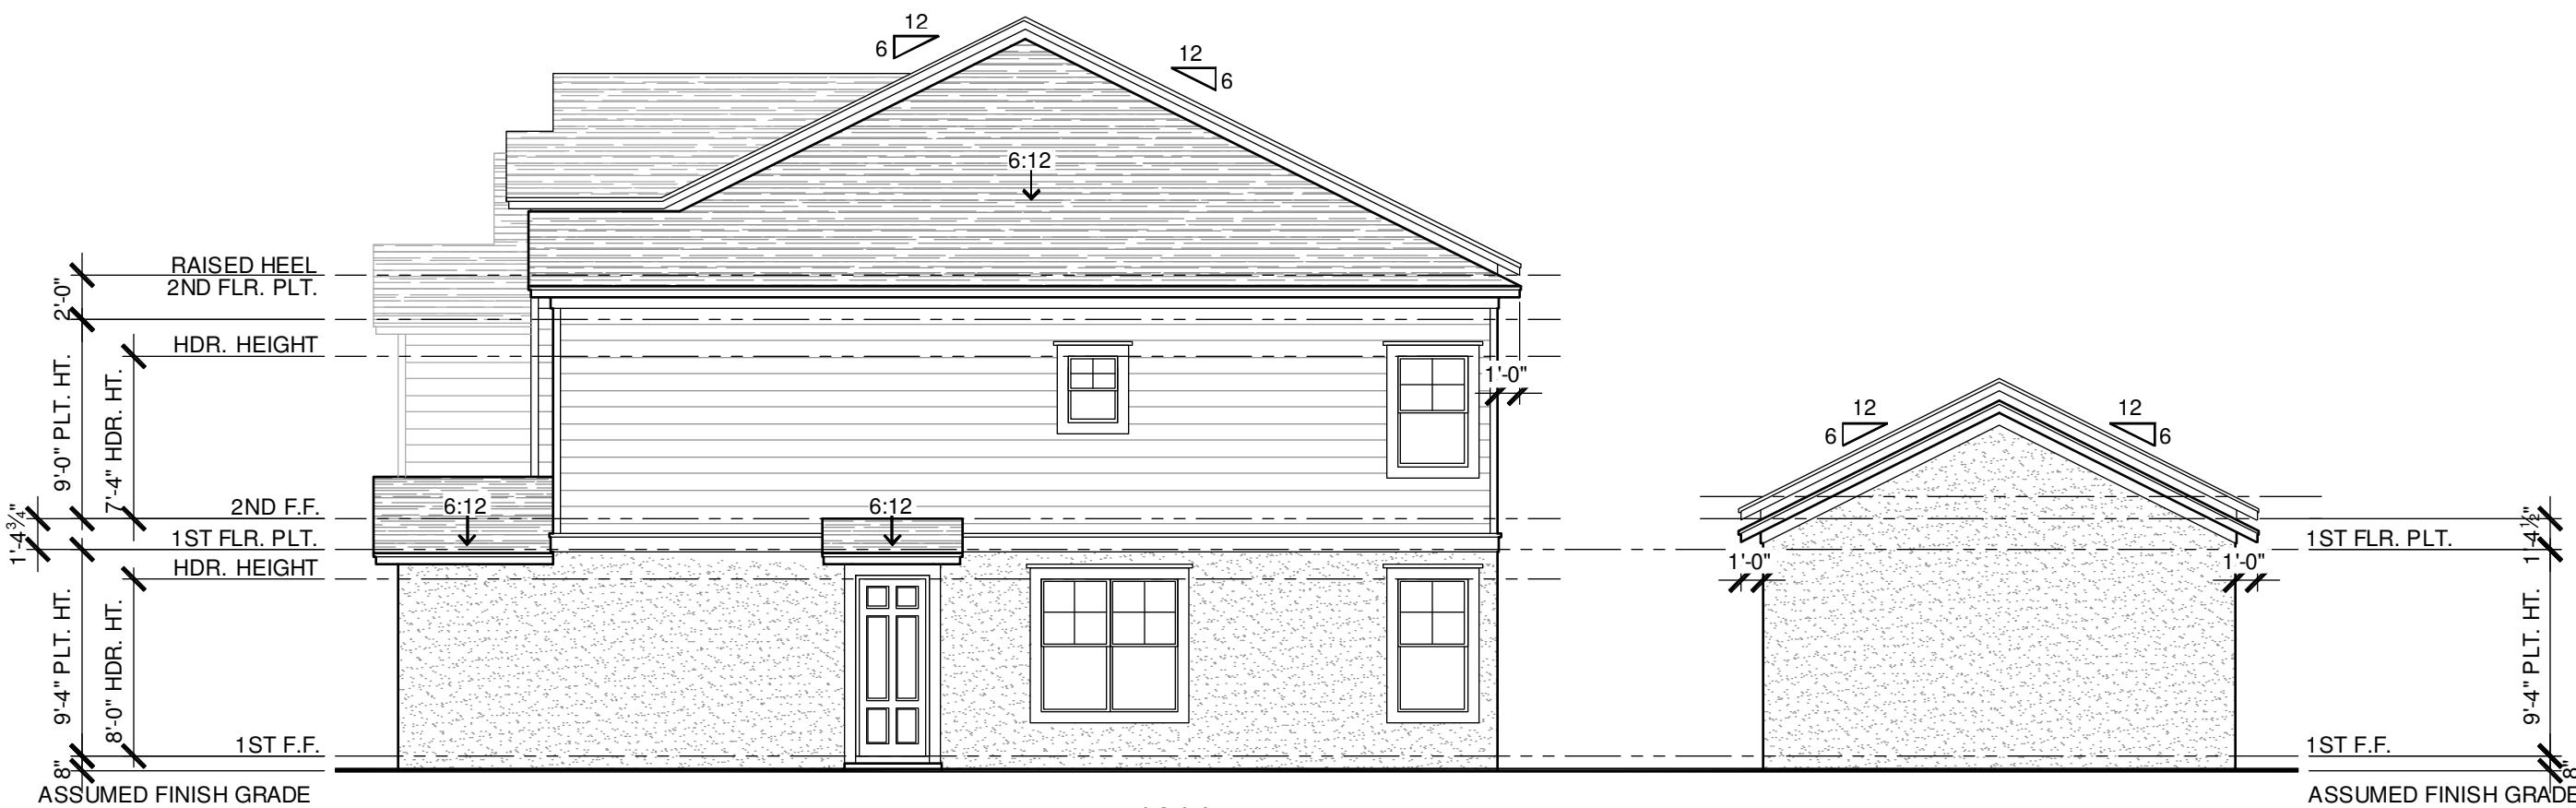

RIGHT ELEVATION - 4 UNIT  
1/8" = 1'-0"

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Certificate of Authorization No. 9181  
☐ CARL A. BROWN, P.E. - FL #51028  
☐ SCOTT LEWONSKI, P.E. - FL #78750  
DATE: April 14, 2023  
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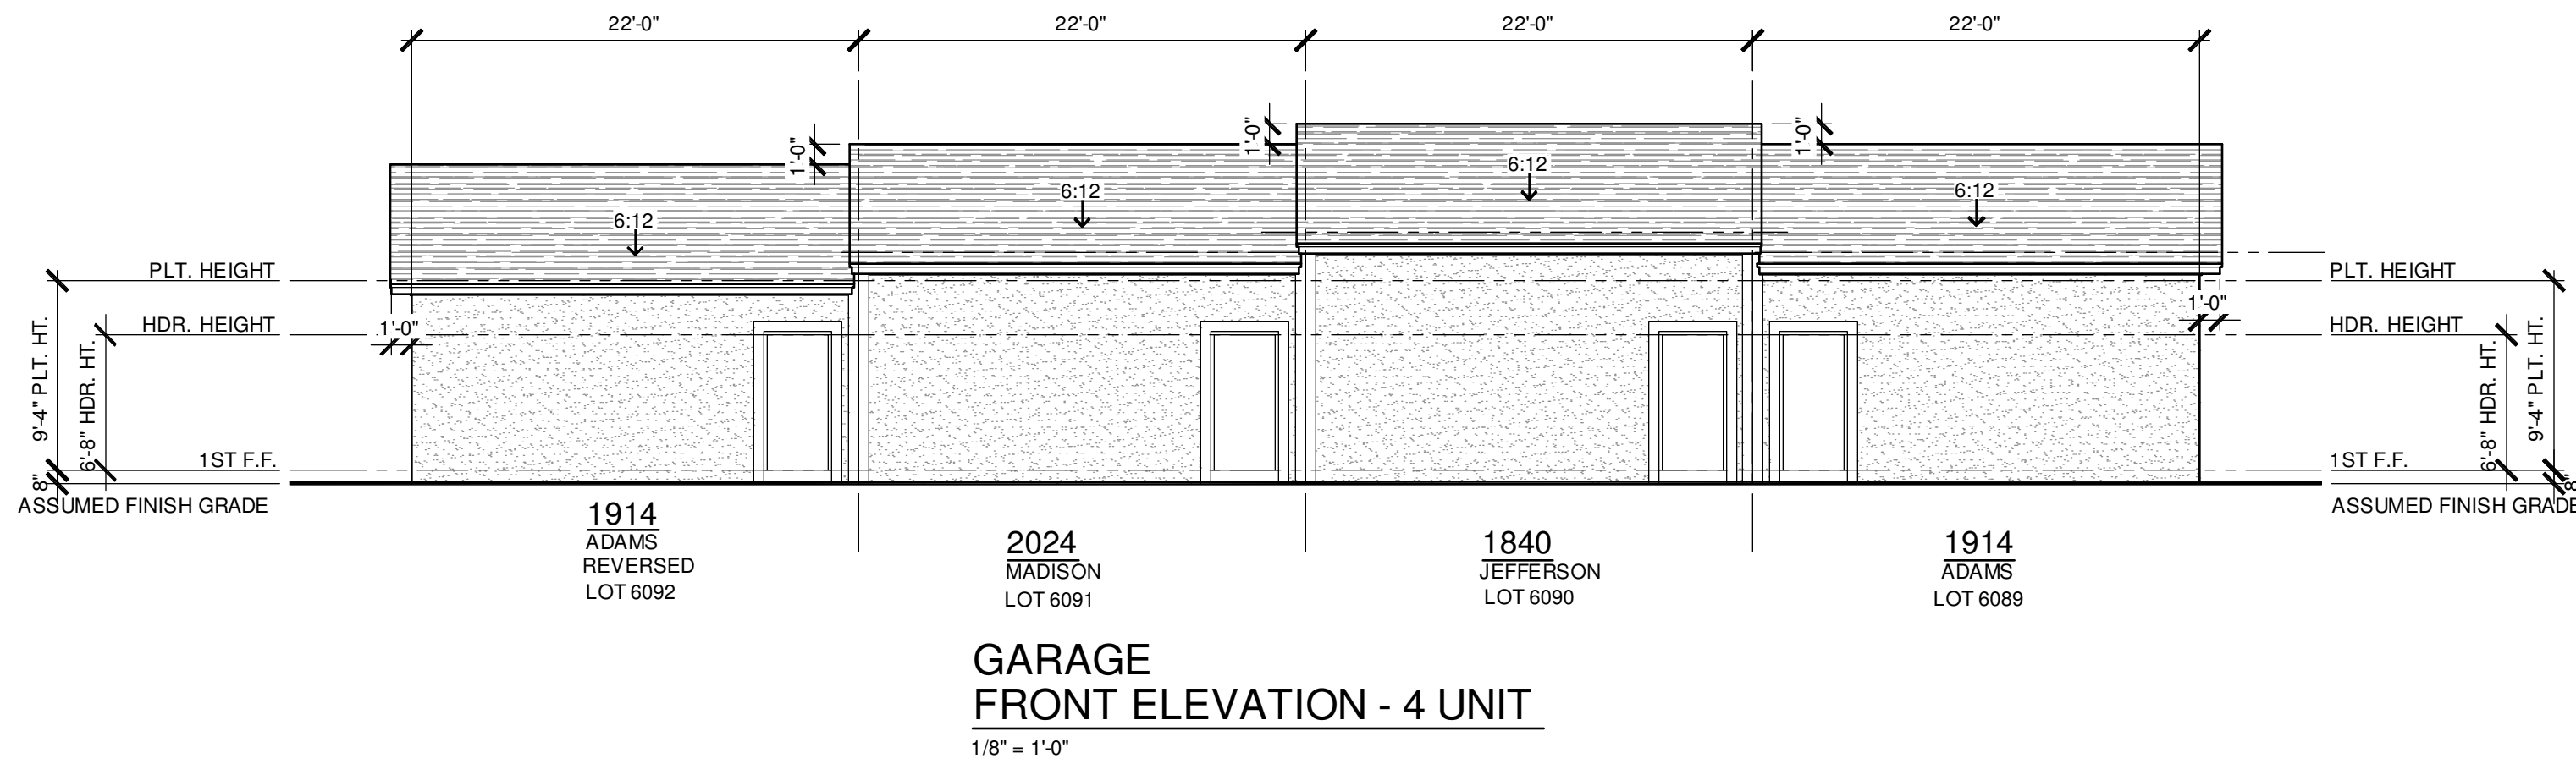
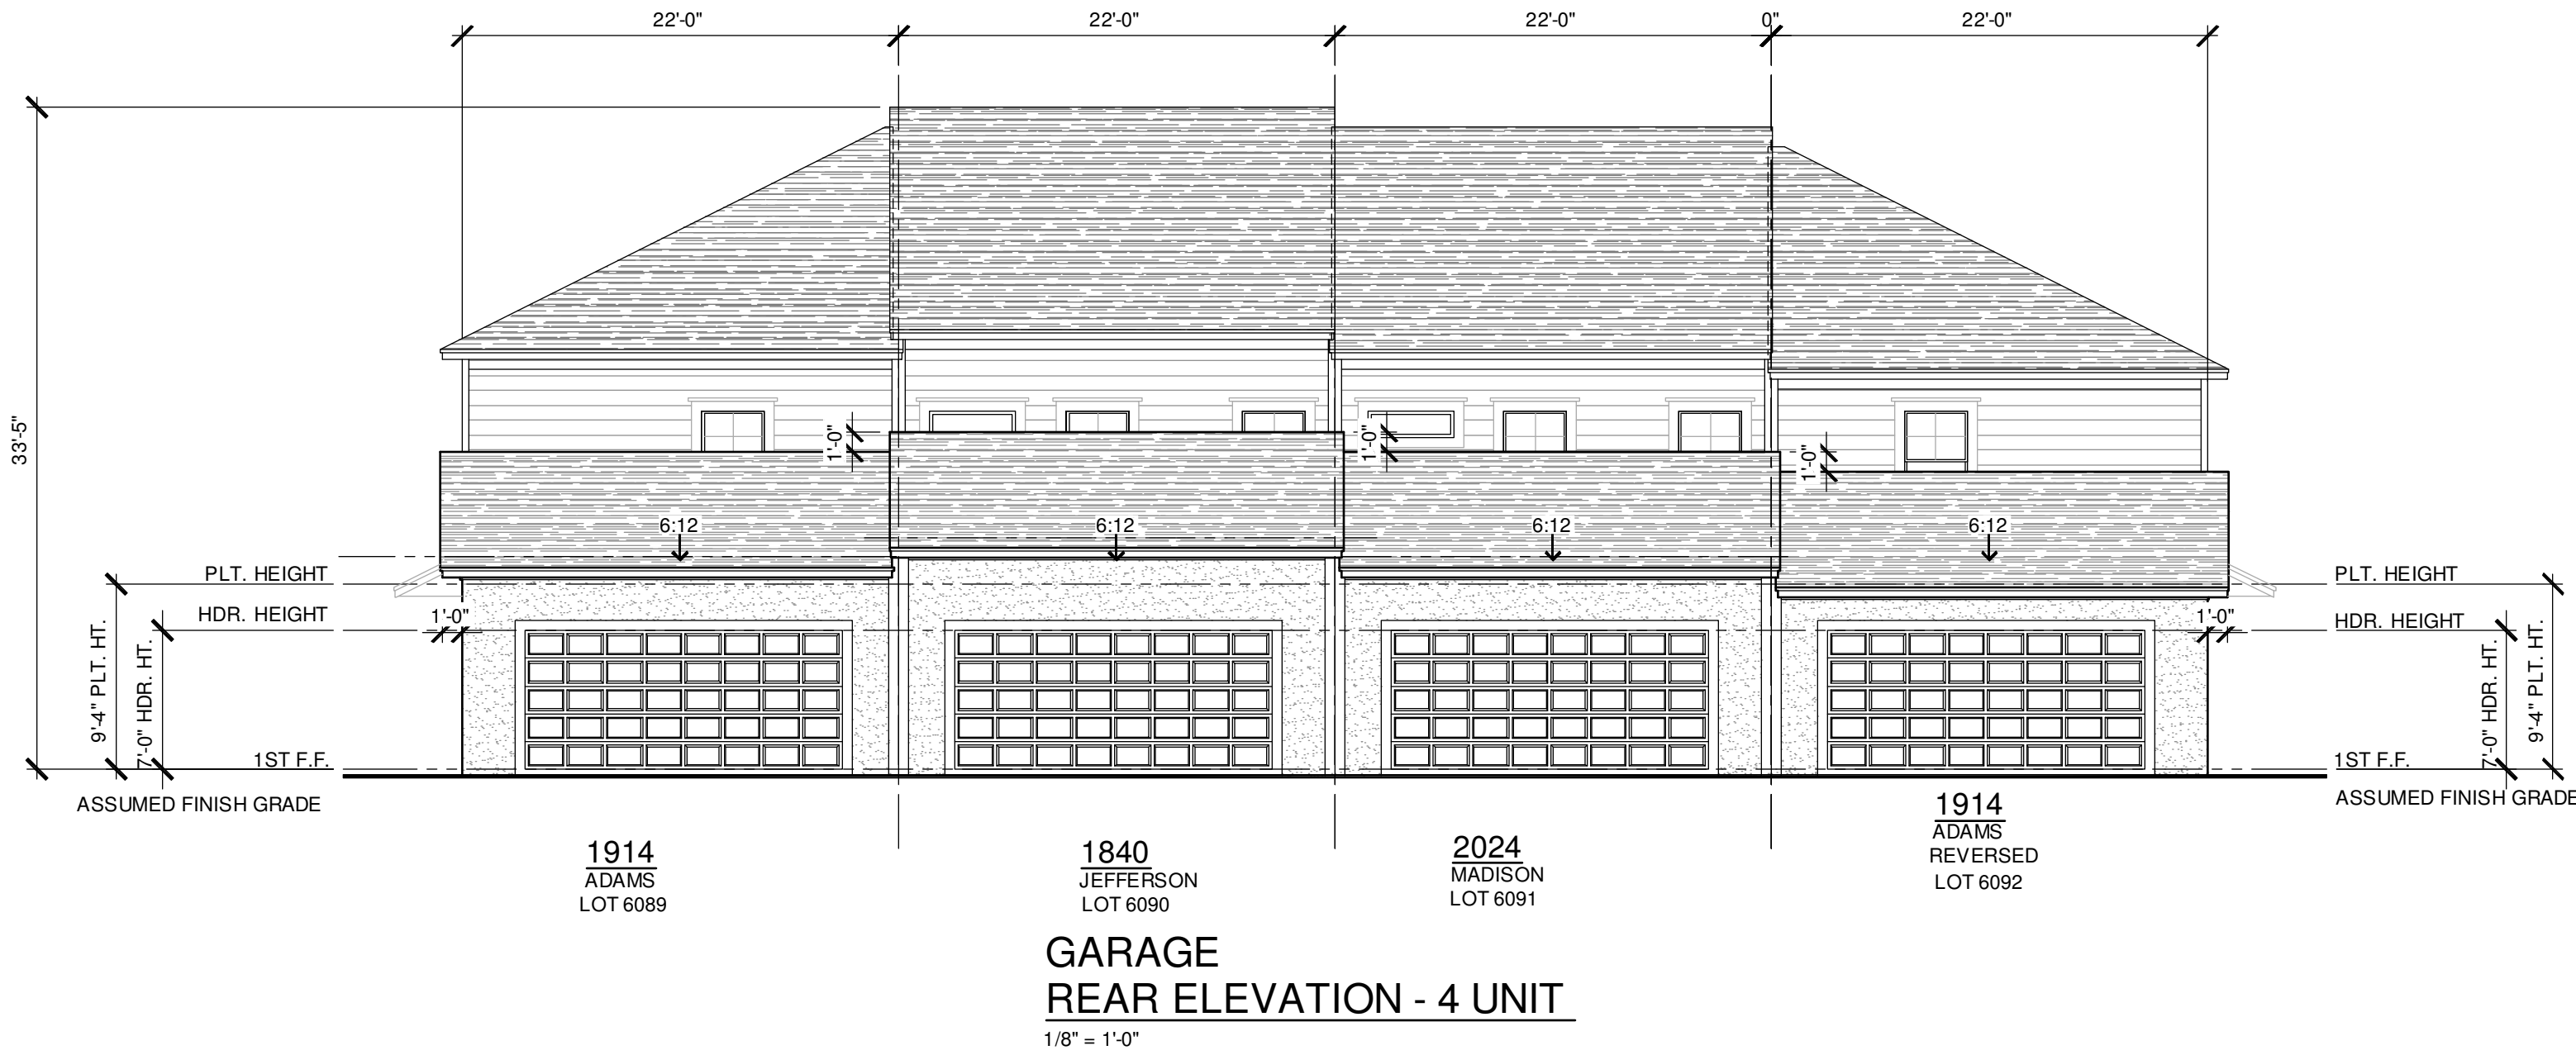
FDS JOB NO.:

PARK SQUARE  
HORIZONS WEST  
BABCOCK RANCH BLDG 6 (LOTS 6082-6089) 4 UNIT

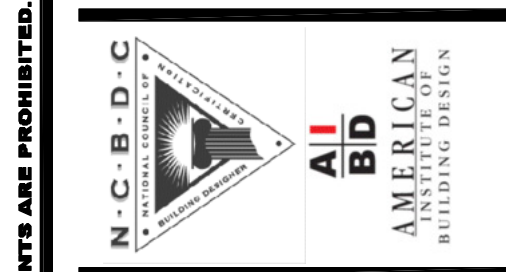Title:  
**4 UNIT  
EXT. ELEVATIONS**


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drawn: BA  
date: 04-12-23  
scale: AS SHOWN

**3.3 1  
ELEV. A**



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289 Southall Lane, Suite 200, Melbourne, FL 32951  
Office: 407.829.8900  
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Fax: 407.829.8902  
E-MAIL: info@fdseng.com  
DATE: April 14, 2023  
BY: Scott Lewowski, P.E., F.L.#78750  
FOR THE BEST OF THE PROFESSION, I HEREBY CERTIFY THAT I AM A LICENSED PROFESSIONAL ENGINEER AND ARCHITECT AND THAT I AM NOT PROVIDING ANY SERVICES OUTSIDE MY LICENSED AREA.

FDS JOB NO.:

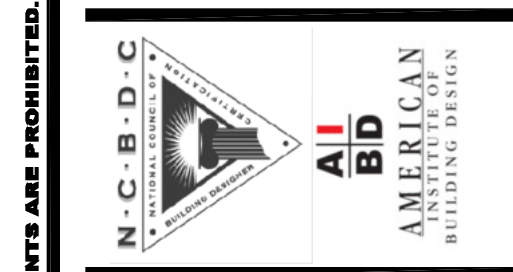**PARK SQUARE  
HORIZONS WEST  
BABCOCK RANCH BLDG 6 (LOTS 6092-6089) 4 UNIT**


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**4 UNIT  
EXT. ELEVATIONS**

project no. 2023083  
checked: BF  
drawn: BA  
date: 04-12-23  
scale: AS SHOWN

**3.3 2  
ELEV. A**

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LOWER ROOF PLAN - 4 UNIT

1/8" = 1'-0"

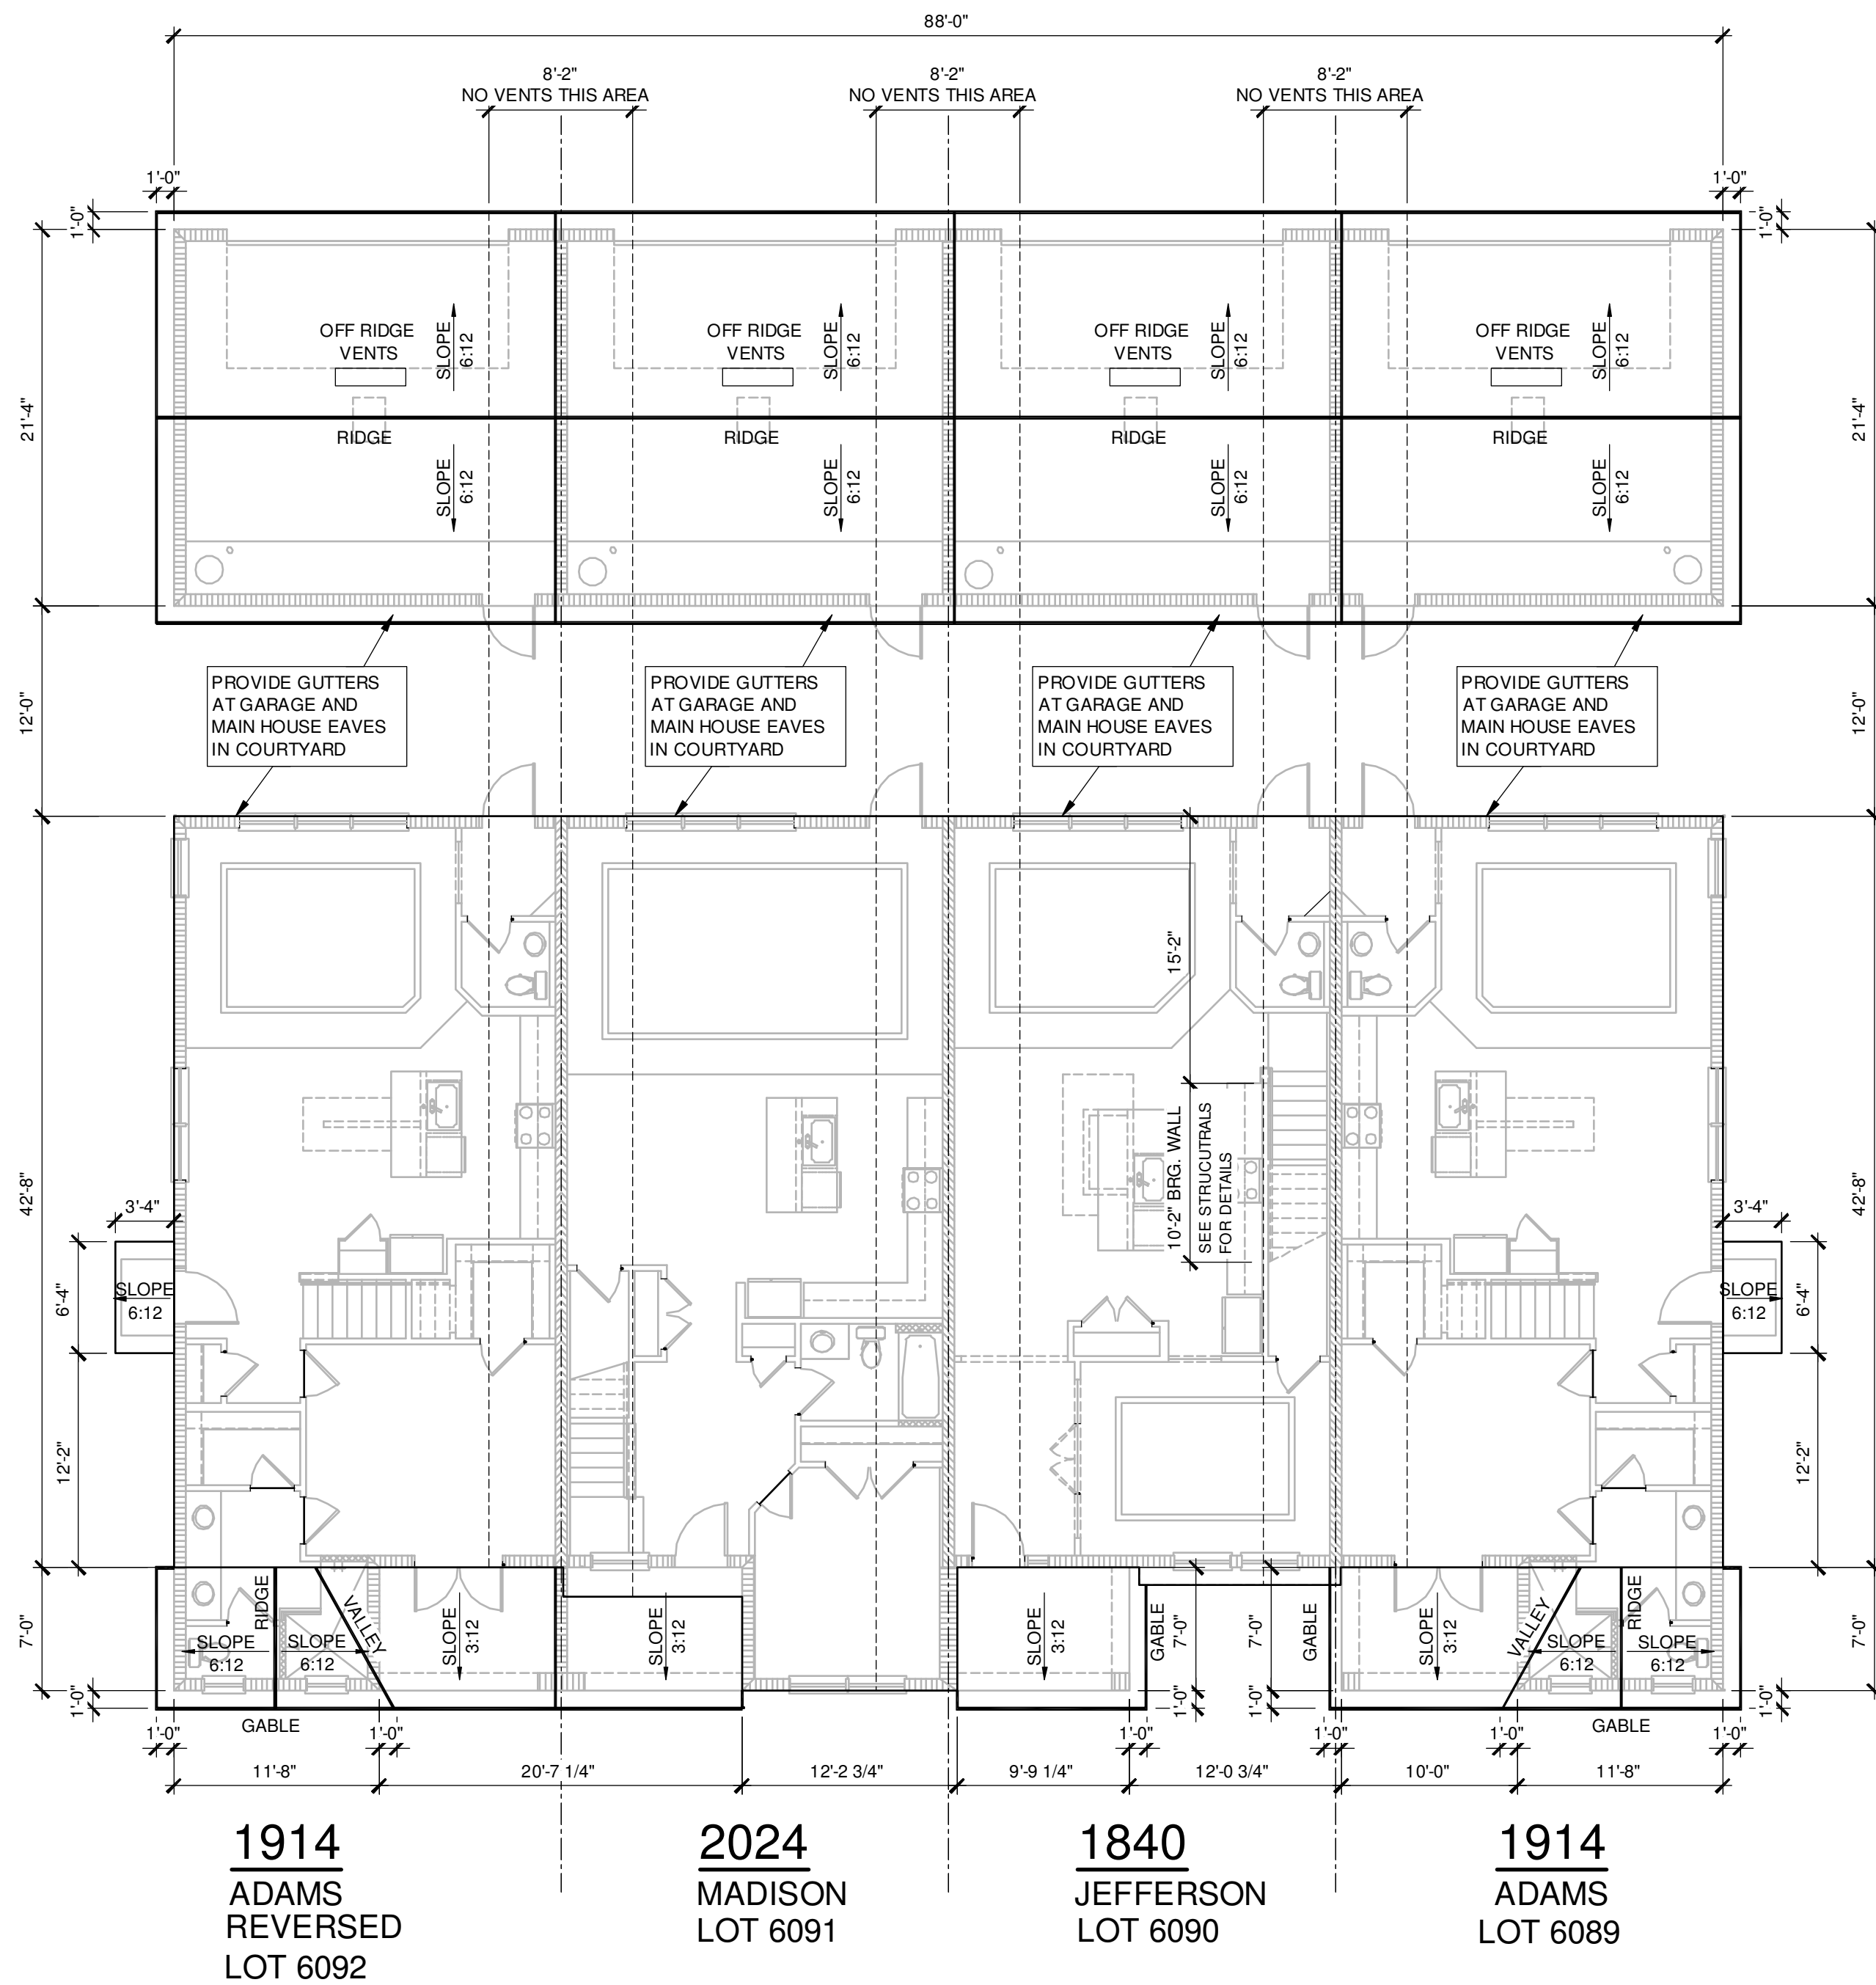1914 - ADAMS  
VENTILATION REQUIRED  
@ GARAGE

469 S.F. / 300 = 1.56  
1.56 / 2 = 0.78  
0.78 \*144 = 112.56 SQ. IN.  
113 SQ. IN. OF VENT REQUIRED

1914 - ADAMS  
VENTILATION REQUIRED  
@ ENTRY

154 S.F. / 300 = .51  
.51 / 2 = 0.26  
0.26 \*144 = 36.96 SQ. IN.  
37 SQ. IN. OF VENT REQUIRED  
SOFFIT VENTILATION PROVIDES  
ADEQUATE VENTILATION

1840 - JEFFERSON  
VENTILATION REQUIRED  
@ GARAGE

469 S.F. / 300 = 1.56  
1.56 / 2 = 0.78  
0.78 \*144 = 112.56 SQ. IN.  
113 SQ. IN. OF VENT REQUIRED

1840 - JEFFERSON  
VENTILATION REQUIRED  
@ ENTRY


72 S.F. / 300 = .24  
.24 / 2 = 0.12  
0.12 \*144 = 17.28 SQ. IN.  
18 SQ. IN. OF VENT REQUIRED  
SOFFIT VENTILATION PROVIDES  
ADEQUATE VENTILATION

2024 - MADISON  
VENTILATION REQUIRED  
@ GARAGE

469 S.F. / 300 = 1.56  
1.56 / 2 = 0.78  
0.78 \*144 = 112.56 SQ. IN.  
113 SQ. IN. OF VENT REQUIRED

2024 - MADISON  
VENTILATION REQUIRED  
@ ENTRY

72 S.F. / 300 = .24  
.24 / 2 = 0.12  
0.12 \*144 = 17.28 SQ. IN.  
18 SQ. IN. OF VENT REQUIRED  
SOFFIT VENTILATION PROVIDES  
ADEQUATE VENTILATION

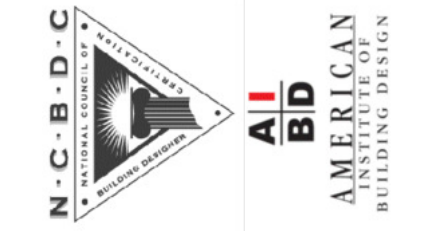

FDS JOB NO.:

PARK SQUARE  
HORIZONS WEST  
BABCOCK RANCH BLDG 6 (LOTS 6092-6089) 4 UNIT

Title:  
4 UNIT - 2 STORY  
1ST FL. ROOF PLAN


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drawn: BA  
date: 04-12-23  
scale: AS SHOWN

3.4  
ELEV. A

NOTE: DRAWINGS ON 11"x17" SHEET WILL BE ONE HALF THE SCALE NOTED

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1914  
ADAMS  
REVERSED  
LOT 6092

2024  
MADISON  
LOT 6091

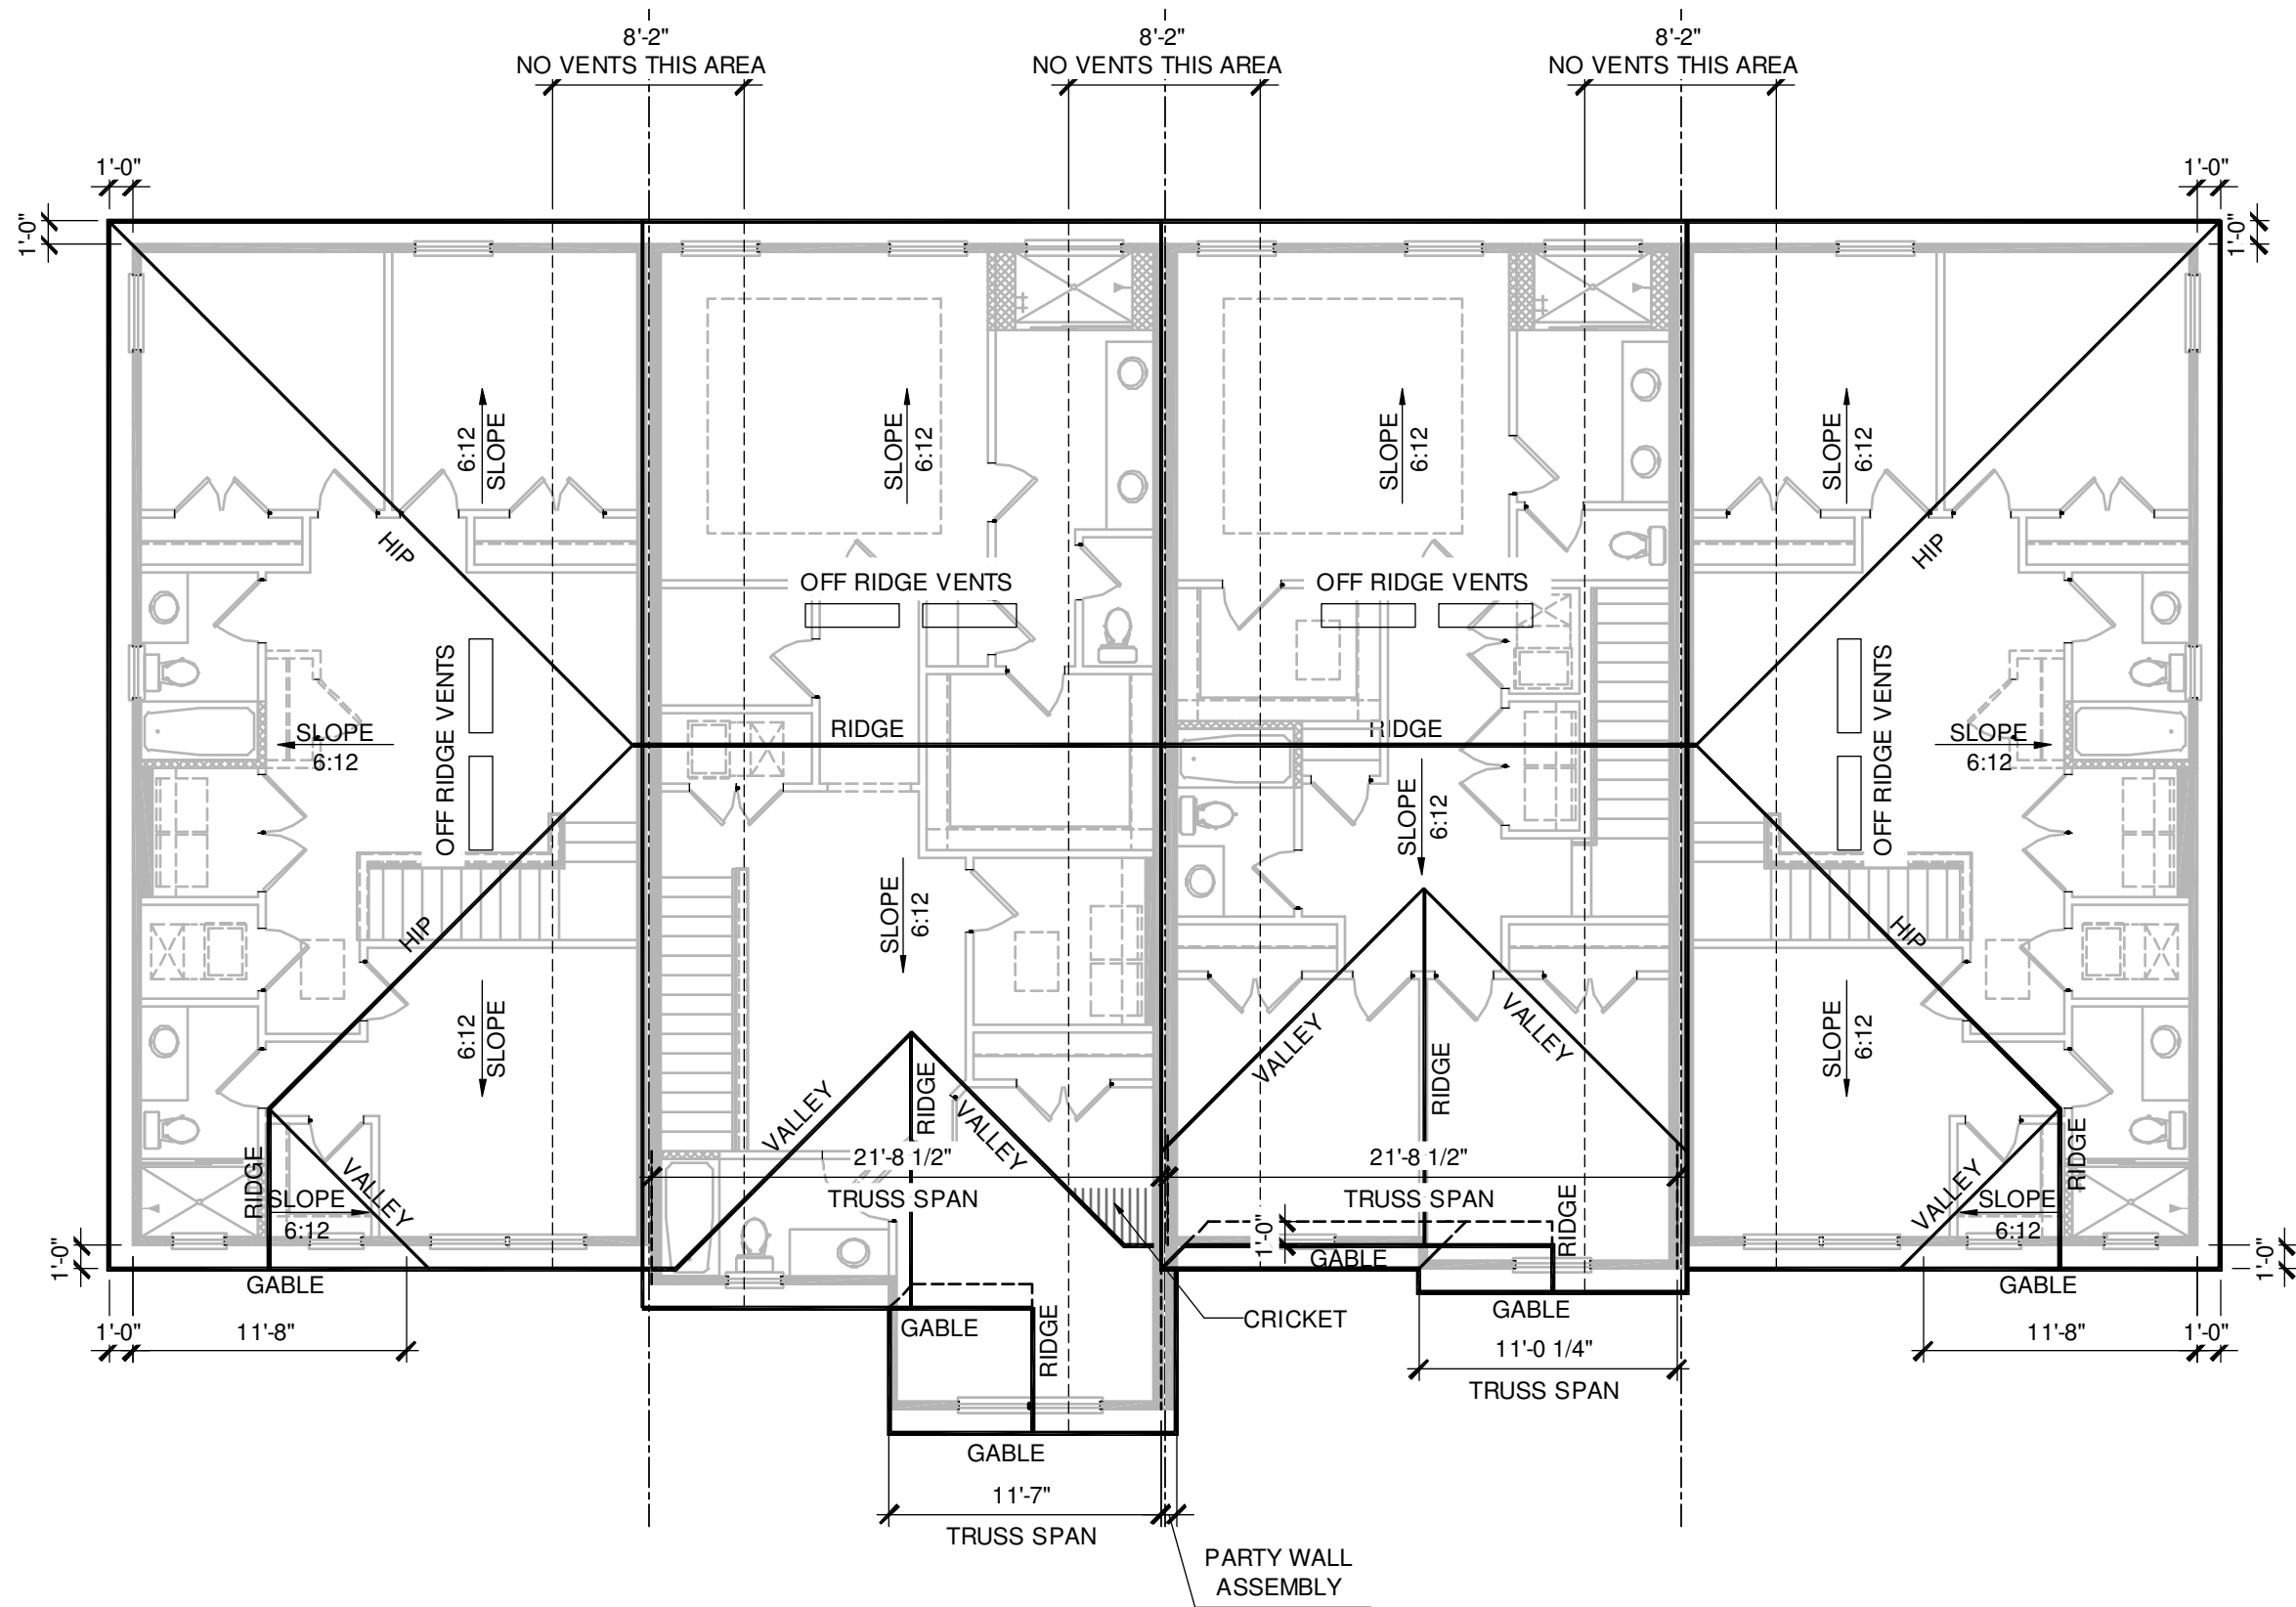1840  
JEFFERSON  
LOT 6090

1914  
ADAMS  
LOT 6089

UPPER ROOF PLAN - 4 UNIT

1/8" = 1'-0"

2024 - MADISON  
VENTILATION REQUIRED  
1040 S.F. / 300 = 3.47  
3.47 / 2 = 1.735  
1.735 \*144 = 249.84 SQ. IN.  
250 SQ. IN. OF VENT REQUIRED

1840 - JEFFERSON  
VENTILATION REQUIRED  
950 S.F. / 300 = 3.17  
3.17 / 2 = 1.585  
1.585 \*144 = 228.24 SQ. IN.  
229 SQ. IN. OF VENT REQUIRED

1914 - ADAMS  
VENTILATION REQUIRED  
939 S.F. / 300 = 3.13  
3.13 / 2 = 1.565  
1.565 \*144 = 225.36 SQ. IN.  
226 SQ. IN. OF VENT REQUIRED

title:

4 UNIT - 2 STORY  
2ND FL. ROOF PLAN

project no. 2023083

checked: BF

drawn: BA

date: 04-12-23

scale: AS SHOWN

3.5  
ELEV. A

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REGISTERED ARCHITECT  
288 SOUTH SHORE DRIVE, SUITE 100  
O 321.972-0481 F 407.580-0304  
Certificate Of Authorization No. 6161  
☐ CARL A. BROWN, PE, FE, LE #59128  
☐ GOSY LEWCHENKO, PE, FE, LE #76750  
DATE: April 14, 2023  
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FDS JOB NO.:

PARK SQUARE  
HORIZONS WEST  
BABCOCK RANCH BLDG 6 (LOTS 6092-6089) 4 UNIT

title:

4 UNIT - 2 STORY  
2ND FL. ROOF PLAN

project no. 2023083

checked: BF

drawn: BA

date: 04-12-23


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3.5  
ELEV. A




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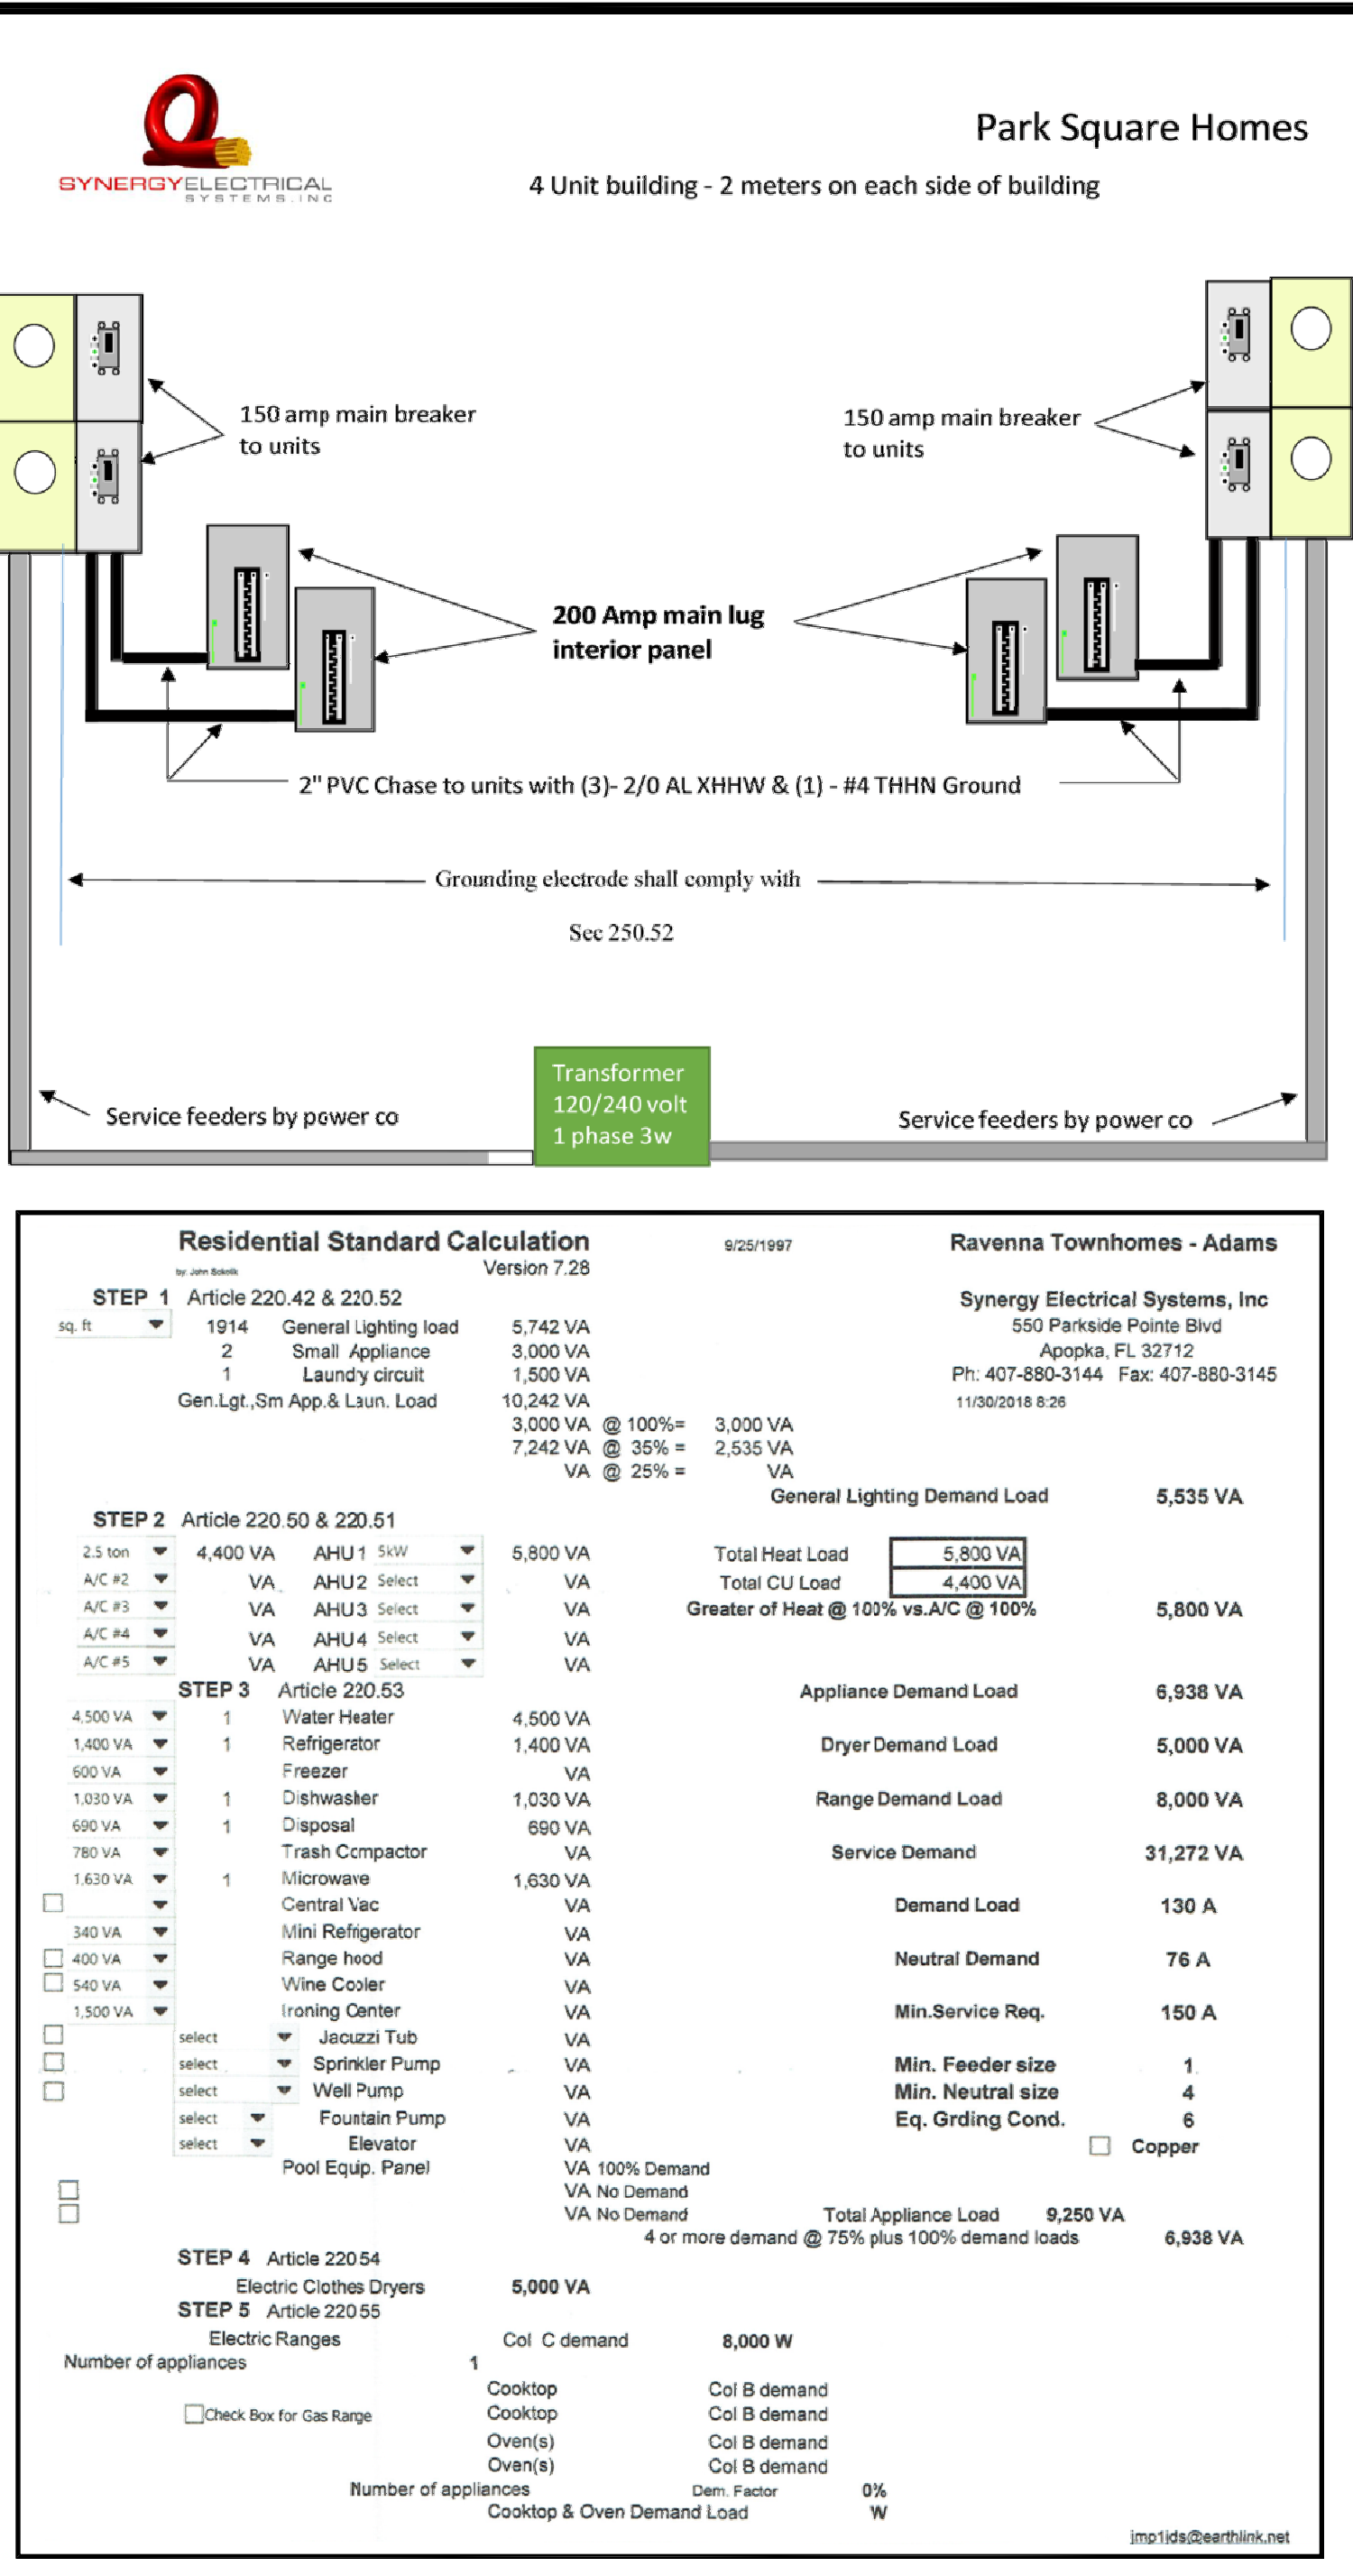
1914 - ADAMS REVERSED  
1ST FLOOR ELECTRICAL

1/4" = 1'-0"

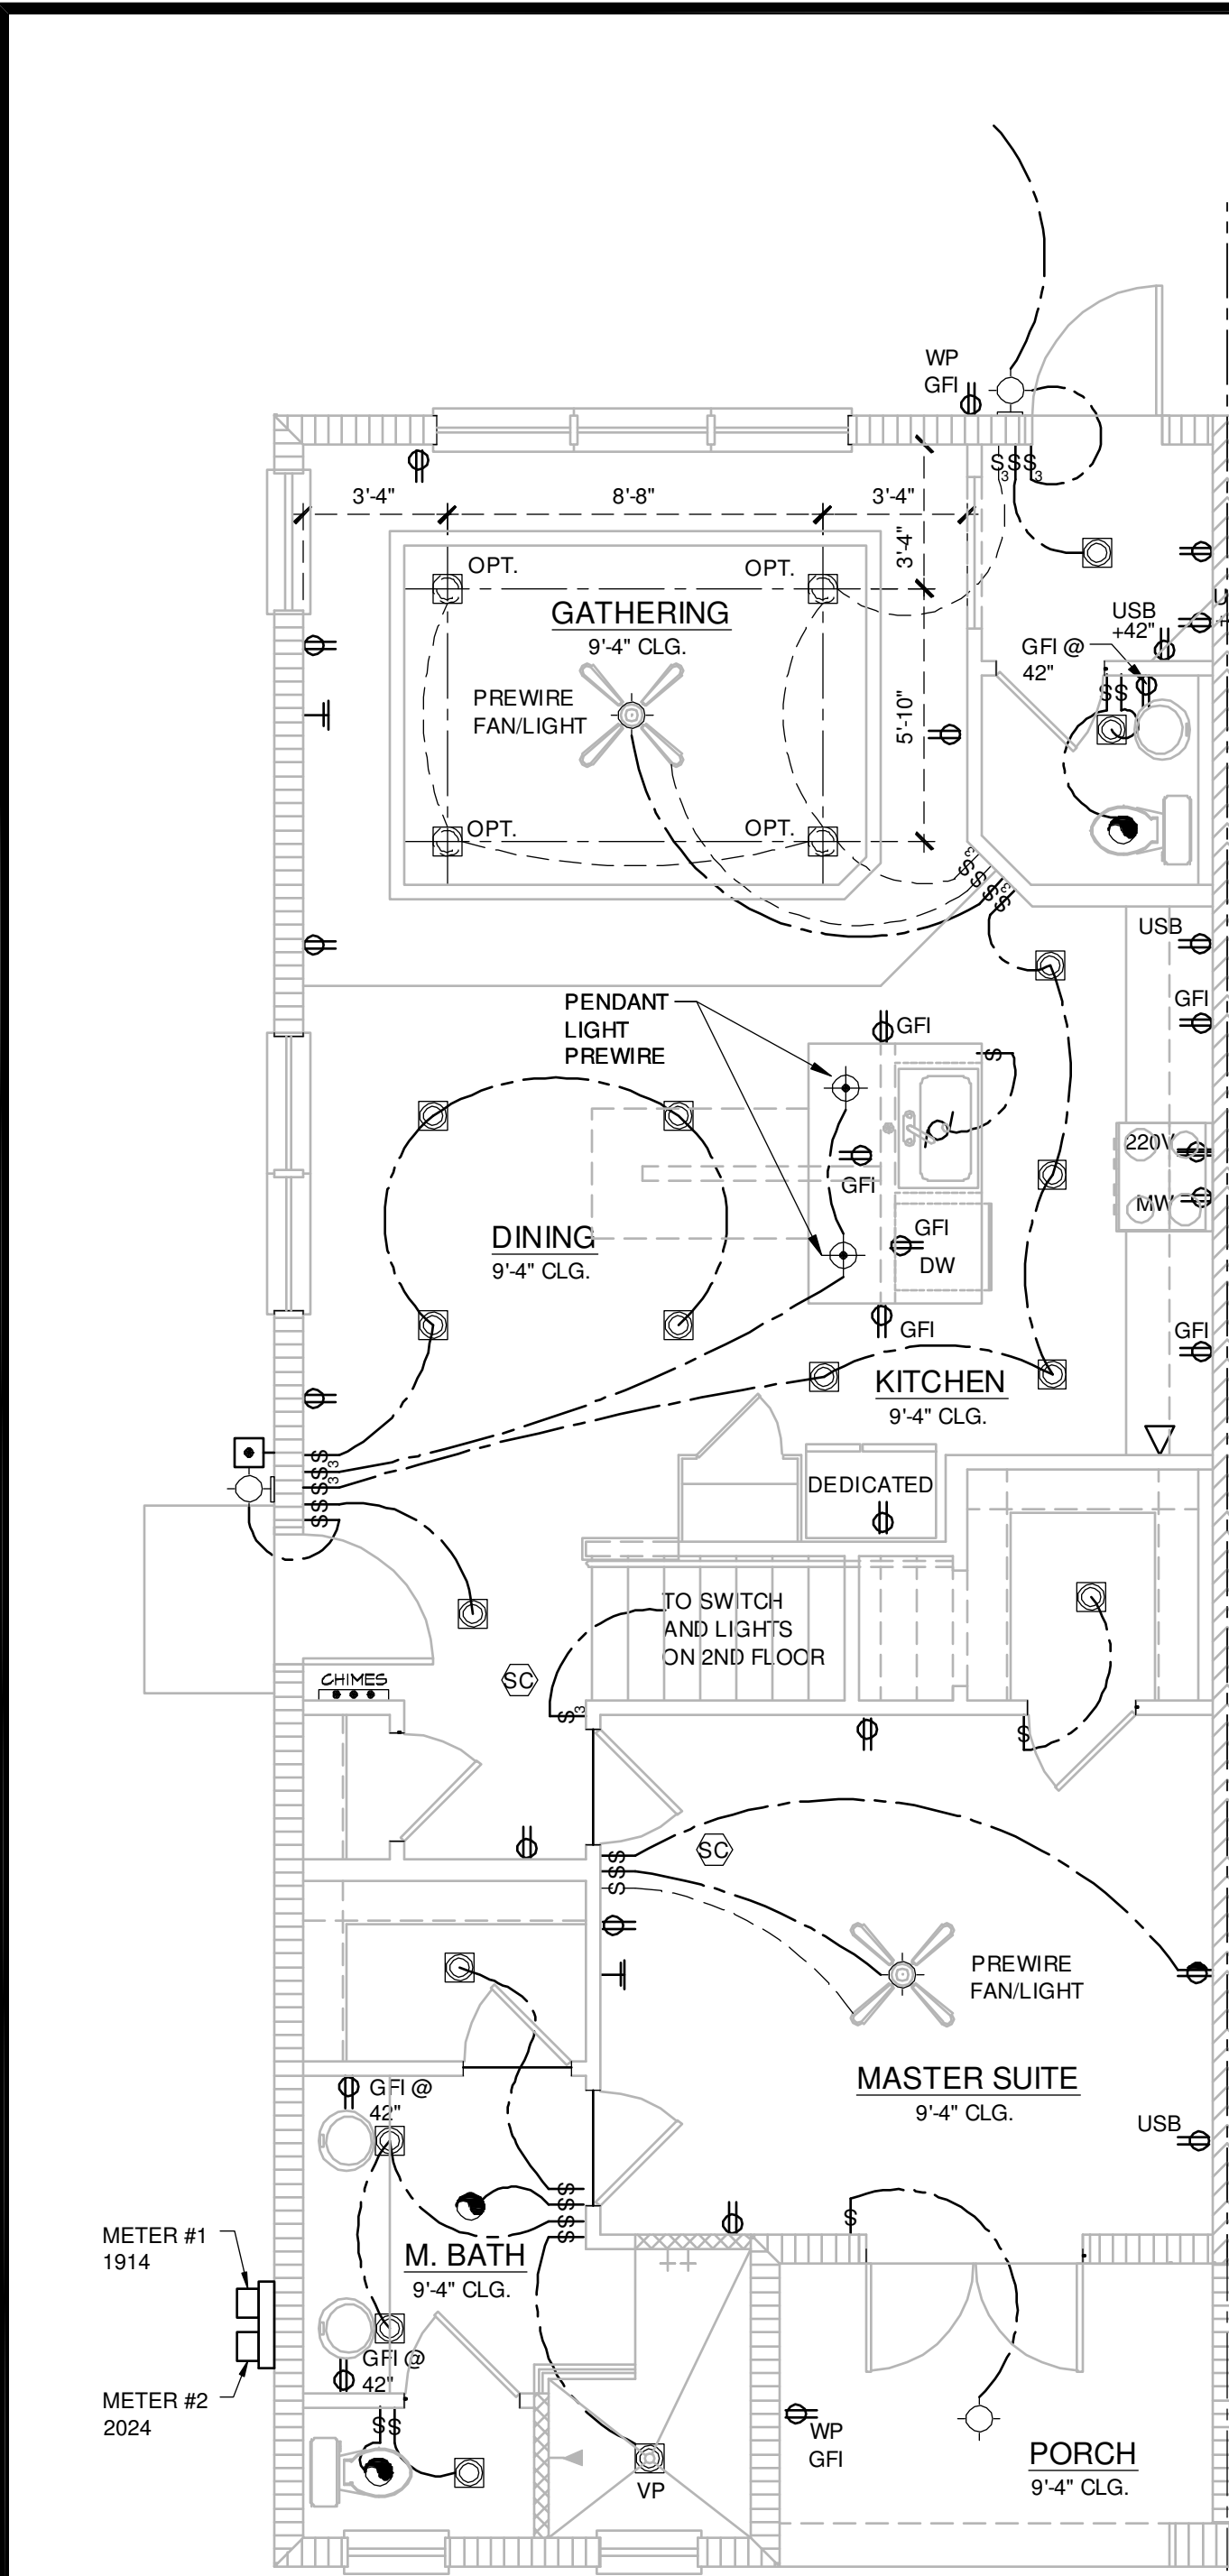

1914 - ADAMS  
1ST FLOOR ELECTRICAL - GARAGE

1/4" = 1'-0"

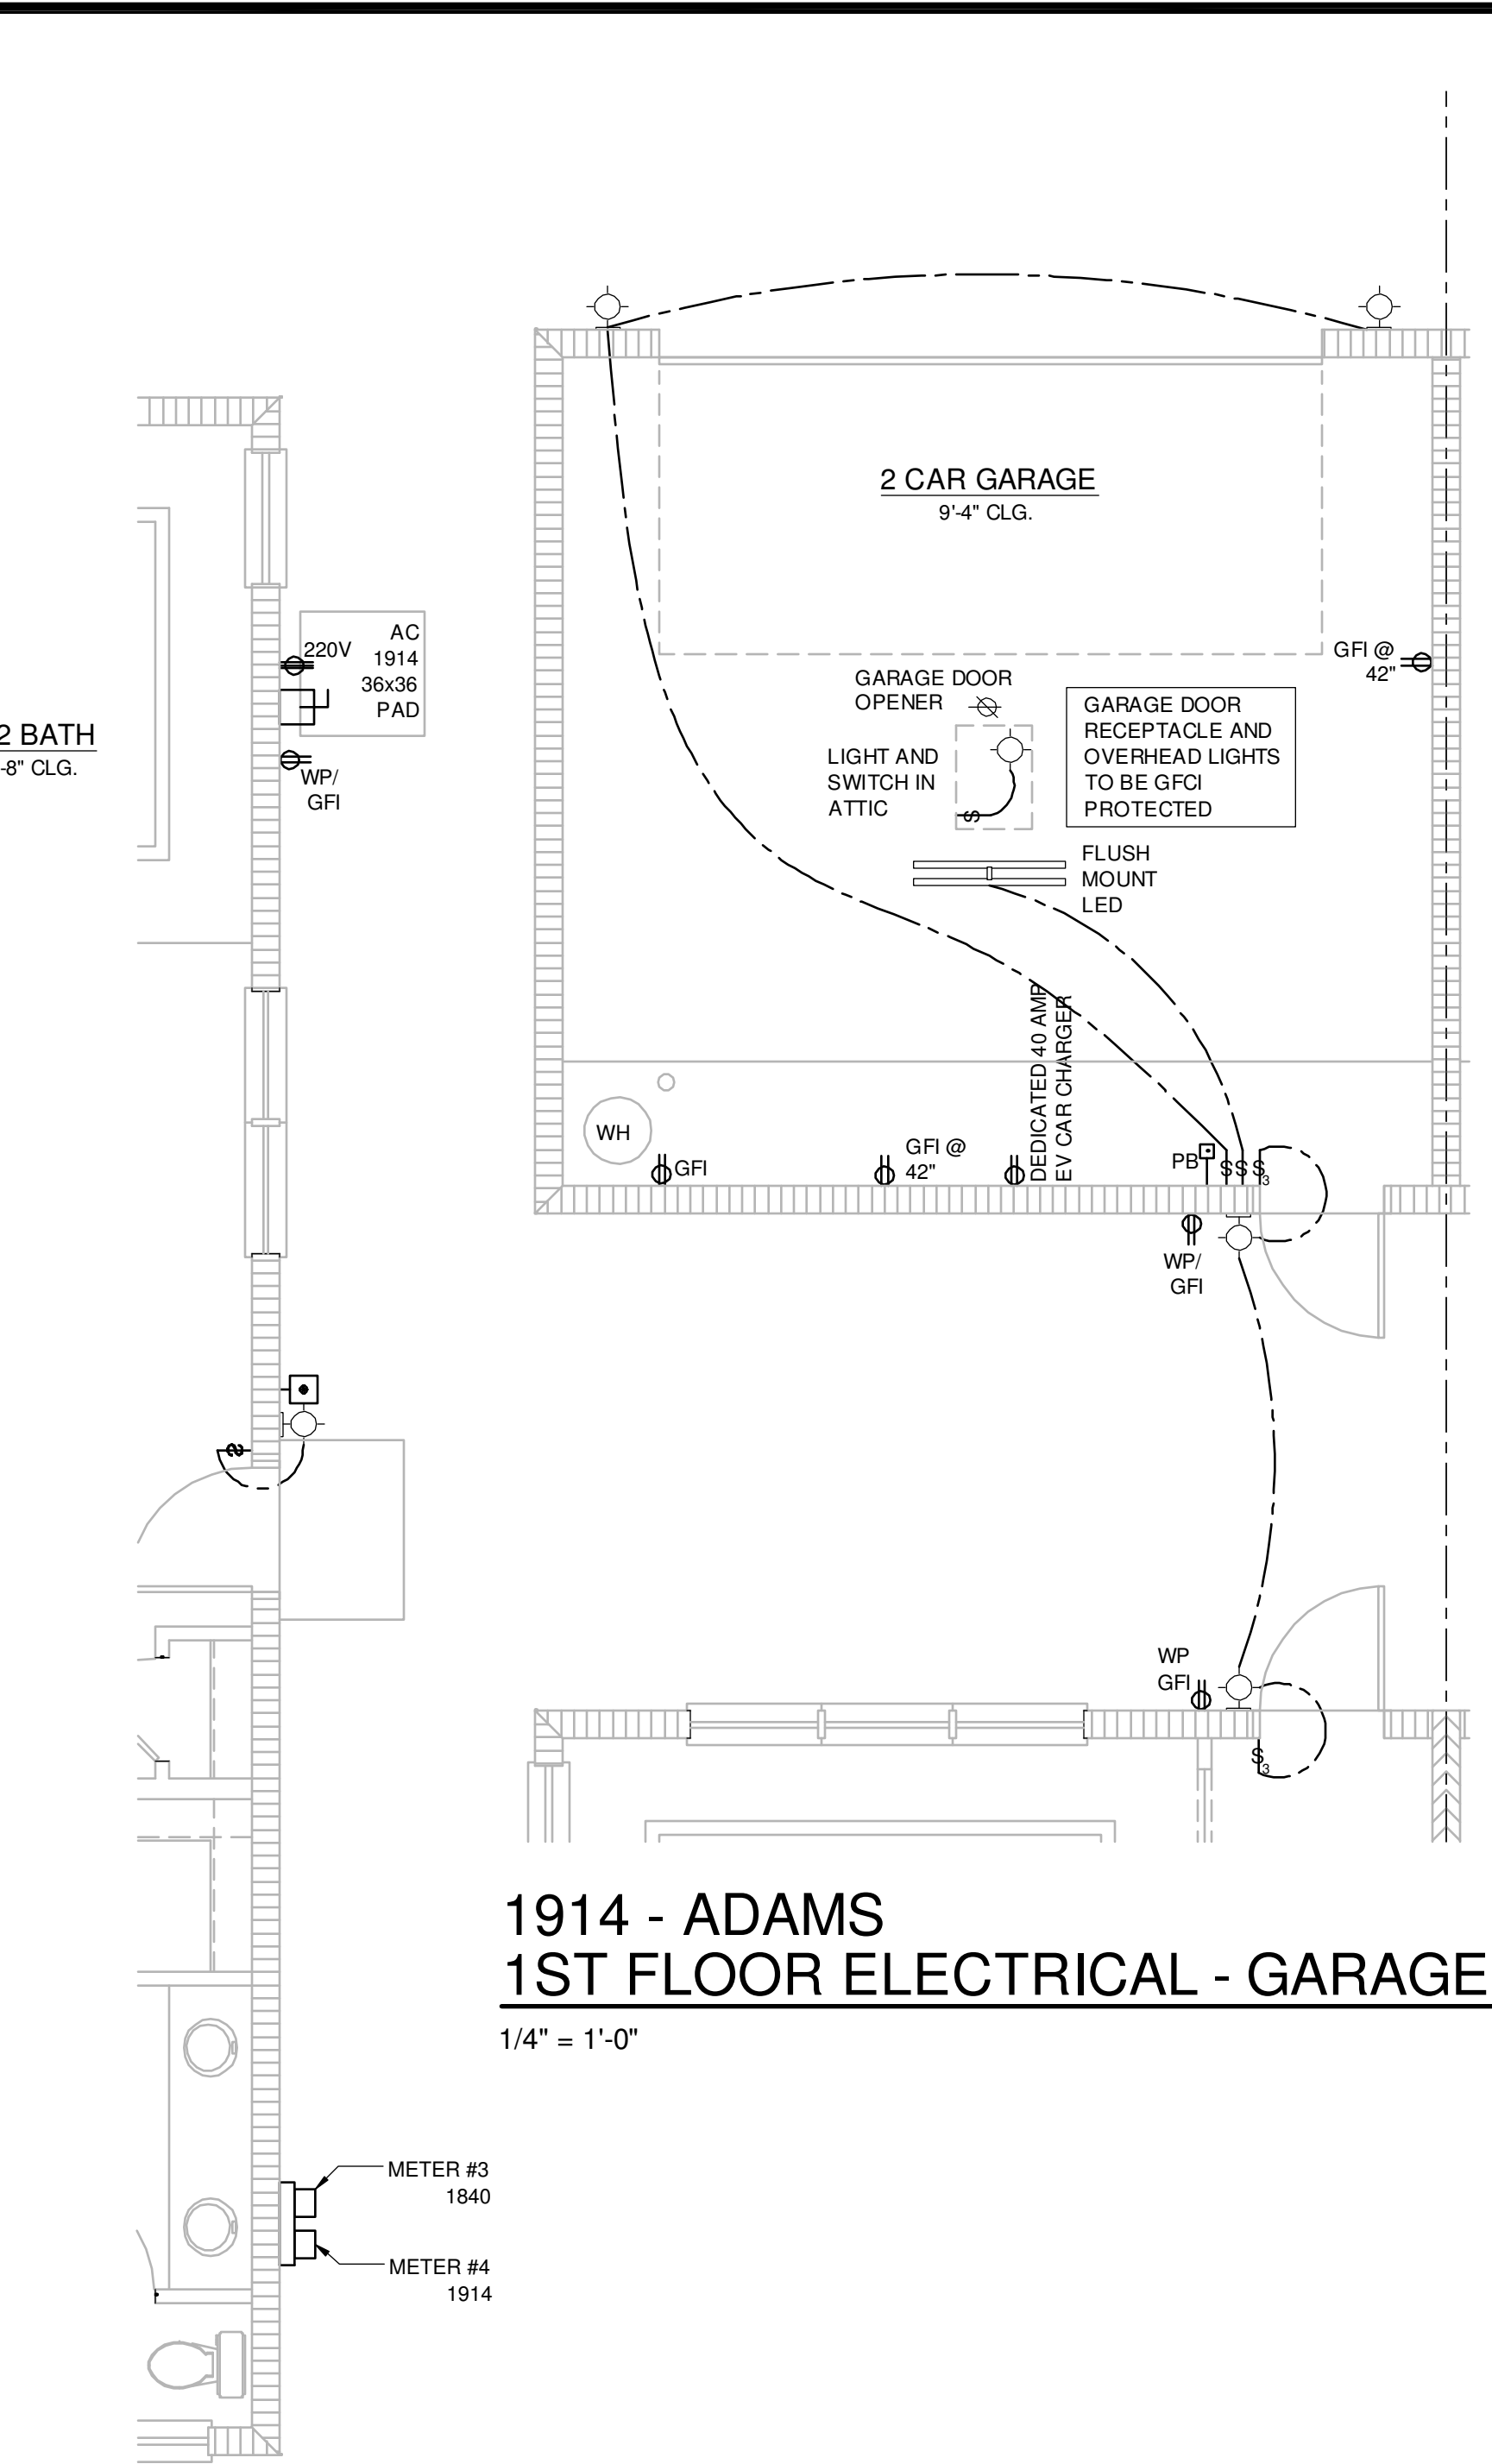


## ELECTRICAL KEY

- DUPLEX CONVENIENCE OUTLET
- WEATHERPROOF DUPLEX OUTLET
- GROUND FAULT INTERRUPTER DUPLEX OUTLET
- HALF-SWITCHED DUPLEX OUTLET
- DUPLEX OUTLET IN FLOOR
- 220V 220 VOLT OUTLET
- DISPOSAL
- WALL SWITCH
- THREE-WAY SWITCH
- FOUR-WAY SWITCH
- DIMMER SWITCH
- MOTION DETECTOR SWITCH (OPTIONAL)
- PRE-WIRED SPEAKER
- FLUSH MOUNT LED LIGHT FIXTURE
- FLUSH MOUNT LED LIGHT FIXTURE - VAPOR PROOF
- MONO POINT TRACK HEAD (OPTIONAL)
- PENDANT FIXTURE
- SURFACE MOUNTED LED LIGHT FIXTURE
- WALL MOUNTED LIGHT FIXTURE
- FLUSH MOUNTED LED LIGHT FIXTURE
- WALL MOUNTED STRIP LIGHT # OF BULBS SPECIFIED BY BUILDER
- UNDERCABINET LIGHTING (OPTIONAL)
- WALL SCONCE
- EXHAUST FAN
- EXHAUST FAN & LIGHT COMBO
- OUTLET FOR GARAGE DOOR OPENER
- SOFFIT OUTLET (OPTIONAL)
- CHIMES
- PUSHBUTTON SWITCH
- SMOKE DETECTOR
- SMOKE DETECTOR/CARBON MONOXIDE DETECTOR
- CAT 5 TELEPHONE OUTLET PREWIRE
- TELEVISION OUTLET PREWIRE
- THERMOSTAT
- ELECTRIC METER
- ELECTRIC PANEL
- DISCONNECT SWITCH
- SECURITYSYSTEMKEYPAD
- PRE-WIRE FOR CEILING FAN
- PRE-WIRE FOR CEILING FAN / LIGHT COMBO
- SECURITY/FLOOD LIGHTS
- GAS METER
- JUNCTION BOX

Residential Standard Calculation				Ravenna Townhomes - Adams	
Version 7.28		8/22/1997		Synergy Electrical Systems, Inc	
STEP 1 Article 220.42 & 220.52		1914		550 Penside Pointe Blvd	
sq. ft.		1914		Apogee, FL 32712	
General Lighting load		5,742 VA		Ph: 407-880-3144 Fax: 407-880-3145	
Small Appliance		3,000 VA		11/30/2018 8:26	
Laundry circuit		1,500 VA			
Gen Lgt., Sm App & Laun. Load		10,242 VA			
		3,000 VA @ 100% = 3,000 VA			
		7,242 VA @ 35% = 2,535 VA			
		VA @ 25% = VA			
		General Lighting Demand Load		5,535 VA	
STEP 2 Article 220.50 & 220.51				Total Heat Load	
2.3 ton		4,400 VA		5,800 VA	
A/C #2		VA		Total CU Load	
A/C #3		VA		4,200 VA	
A/C #4		VA		Greater of Heat @ 100% vs A/C @ 100%	
A/C #5		VA		5,800 VA	
STEP 3 Article 220.53				Appliance Demand Load	
4,500 VA		1		6,938 VA	
1,400 VA		1		Dryer Demand Load	
500 VA		1		5,000 VA	
1,030 VA		1		Range Demand Load	
600 VA		1		8,000 VA	
780 VA		1		Service Demand	
1,630 VA		1		31,272 VA	
340 VA		1		Demand Load	
400 VA		1		130 A	
540 VA		1		Neutral Demand	
1,500 VA		1		76 A	
select		select		Min. Service Req.	
select		select		150 A	
select		select		Min. Feeder size	
select		select		1	
select		select		Min. Neutral size	
select		select		4	
select		select		Eq. Grdng Cond.	
select		select		6	
select		select		Copper	
STEP 4 Article 220.54				Total Appliance Load	
Electric Clothes Dryers		5,000 VA		9,250 VA	
STEP 5 Article 220.55				4 or more demand @ 75% plus 100% demand loads	
Electric Ranges		8,000 W		6,938 VA	
Number of appliances		1			
Cooktop		Col B demand			
Cooktop		Col B demand			
Oven(s)		Col B demand			
Oven(s)		Col B demand			
Number of appliances		Demand Factor		0%	
Cooktop & Oven Demand Load		W			

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NFPA 70  
ADD GFCI PROTECTION TO RECEPTACLES IN LAUNDRY ROOMS AND UTILITY ROOMS OF DWELLINGS WHERE INSTALLED WITHIN 6' OF THE OUTSIDE EDGE OF A SINK. THIS WOULD INCLUDE THE RECEPTACLE INSTALLED FOR A WASHING MACHINE.  
RECEPTACLE OUTLETS SHALL NOT BE REQUIRED ON A WALL DIRECTLY BEHIND A RANGE OR SINK TO FULFILL THE REQUIREMENT FOR AN OUTLET EVERY 24". THE WIDTH OF THE SINK OR RANGE IS NOT TO BE INCLUDED IN THE SPACING OF THE OUTLETS UNLESS THE DISTANCE FROM THE SINK OR RANGE IS GREATER THAN 12" FOR STRAIGHT COUNTER TOPS AND 18" FOR SINKS AND RANGES INSTALLED IN CORNER COUNTERS.

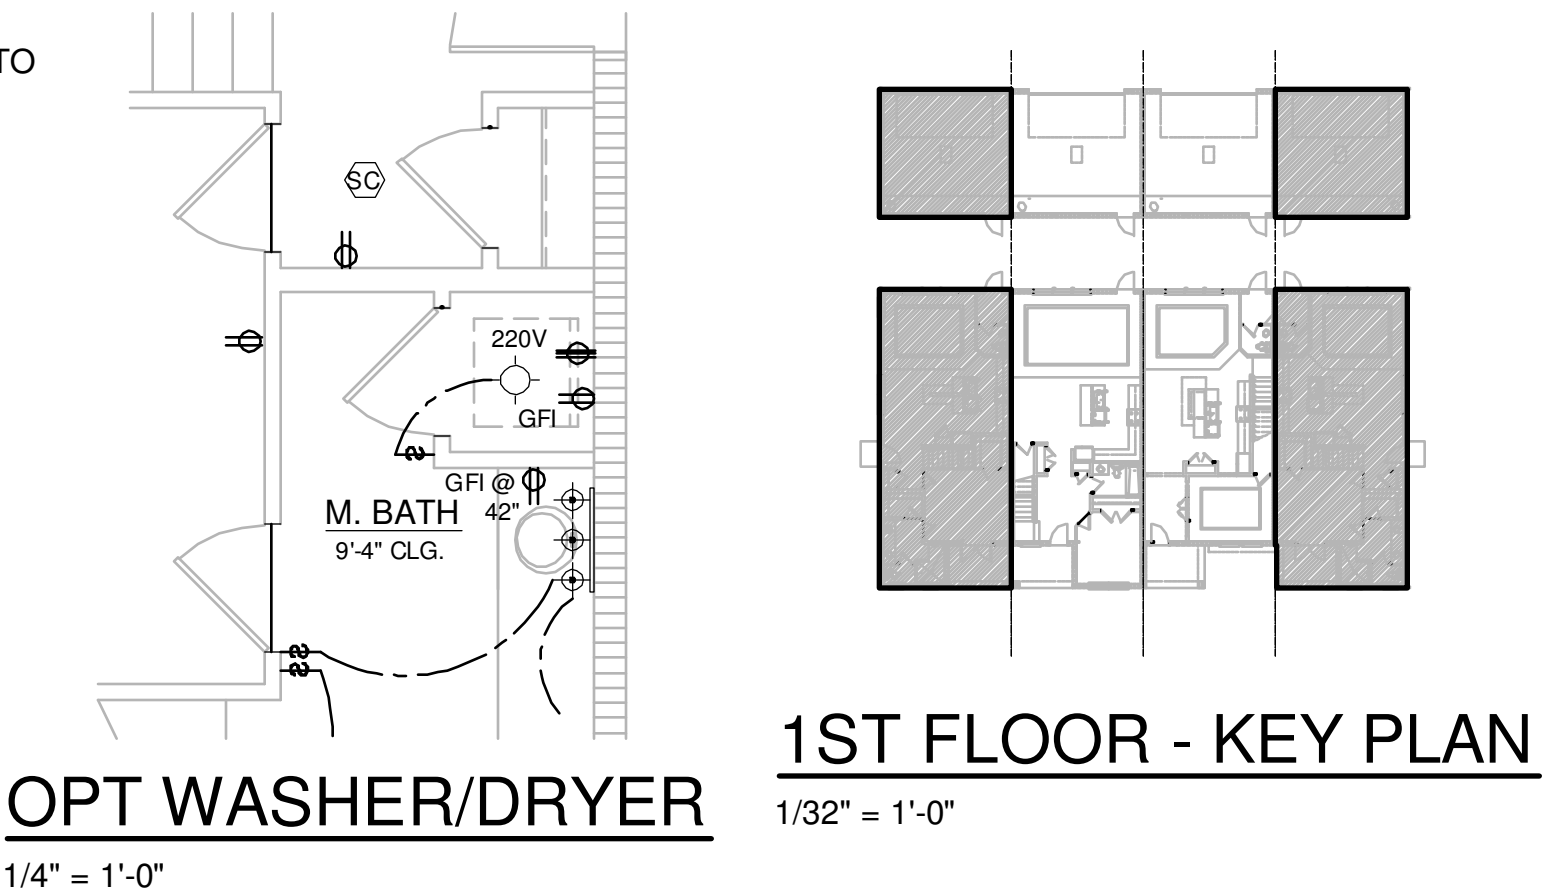

1ST FLOOR - KEY PLAN


1/32" = 1'-0"

## GENERAL NOTES

- FAN, PHONE, & CATV LOCATIONS PER CONTRACT.
- ALL SMOKE/CARBON MONOXIDE DETECTORS TO BE INSTALLED PER 2020 FBCR. REFERENCED NFPA 72 AND R314. SMOKE DETECTORS SHALL BE HARDWIRED INTO AN AC ELECTRICAL POWER SOURCE AND SHALL BE EQUIPPED WITH A MONITORED BATTERY BACKUP AND SHALL BE INTERCONNECTED.
- ARCH FAULT BREAKERS: ALL BRANCH CIRCUITS SERVING BEDROOMS, FAMILY ROOMS, HALLWAYS, KITCHEN, LIVING ROOMS, DINING ROOMS, PARLORS, LIBRARIES, DEN, SUNROOMS, REC. ROOMS, CLOSETS AND LAUNDRY AREAS SHALL BE PROTECTED BY ARCH FAULT BREAKERS, PER 2020 FBCR. (REFER TO CHAPTERS 34 - 43)
- NEC 2017 210.52(G)(1) GARAGES. IN EACH ATTACHED GARAGE AND IN EACH DETACHED GARAGE WITH ELECTRIC POWER, AT LEAST ONE RECEPTACLE OUTLET SHALL BE INSTALLED IN EACH VEHICLE BAY, NOT MORE THAN 1.7M (5-1/2 FT.) ABOVE THE FLOOR.
- TAMPER-RESISTANT "TR" RECEPTACLES: ALL 125-VOLT, 15 & 20 AMPERE ELECTRICAL OUTLETS (RECEPTACLES) IN LIVING ROOM AREAS, BATHROOMS, KITCHEN, GARAGE, LAUNDRY ROOM, AND EXTERIOR LOCATIONS MUST BE "TAMPER-RESISTANT" PER 2020 FBCR. (REFER TO CHAPTERS 34 - 43)
- ALL ELECTRICAL WORK AND APPLIANCES SHALL CONFORM TO 2020 FBCR. REFERENCED NFPA 70.
- EXCEPTIONS FROM GFI REQUIREMENTS SHALL BE PERMITTED PROVIDED LOCATION WHERE EXCEPTION IS DESIRED IS ALLOWED PER 2020 FBCR REFERENCED NFPA 70.
- UNLESS OTHERWISE INDICATED OR GOVERNED BY CODE, INSTALL SWITCHES AND RECEPTACLES AT THE FOLLOWING HEIGHTS ABOVE FINISH FLOOR.

ELECTRICAL DEVICES	ABOVE FIN. FLR.
SWITCHES AND WALL OUTLETS OVER COUNTERS	48" TO C.L.
REMAINING SWITCHES	48" TO C.L.
WALL OUTLETS	12" TO C.L.
TELEPHONE OUTLETS	12" TO C.L.
TELEVISION OUTLETS	12" TO C.L.
EXTERIOR GFIS	12" TO C.L.
GARAGE GFIS (ABOVE GARAGE FLOOR)	48" TO C.L.
THERMOSTAT	54" TO C.L.
DOOR BELL CHIMES	84" TO C.L.
DOOR BELL BUTTON	LEVEL W/ DOOR HANDLE
KITCHEN HOOD FAN "WHIP"	78" TO C.L.
KITCHEN WALL HUNG MICROWAVE RECEPTACLE	78" TO C.L.
KITCHEN DISHWASHER RECEPTACLE	UNDER SINK
KITCHEN RANGE	24" TO C.L.
KITCHEN REFRIGERATOR	48" TO C.L.
WASHER DRYER OUTLET	36" TO C.L.
HOLLYWOOD LIGHTS	84" TO C.L.
C.L. = CENTER LINE	

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ENGINEERING ARCHITECTURE  
228 Southall Lane, Suite 200, Maitland, FL 32751  
Phone: 407-880-3144  
Fax: 407-880-3145  
www.fdseng.com  
DATE: April 14, 2023

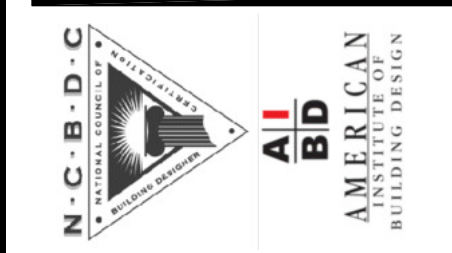**PARK SQUARE  
HORIZONS WEST  
BABCOCK RANCH BLDG 6 (LOTS 6092-6099) 4 UNIT**

project no. 2023083  
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drawn: BA  
date: 04-12-23  
scale: AS SHOWN

**4.1A  
ELEV. A**

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1914 - ADAMS  
2ND FLOOR ELECTRICAL

1/4" = 1'-0"

NFPA 70  
ADD GFCI PROTECTION TO RECEPTACLES IN LAUNDRY ROOMS AND UTILITY ROOMS OF DWELLINGS WHERE INSTALLED WITHIN 6' OF THE OUTSIDE EDGE OF A SINK. THIS WOULD INCLUDE THE RECEPTACLE INSTALLED FOR A WASHING MACHINE.


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2ND FLOOR - KEY PLAN

1/32" = 1'-0"

UNIT 6092	1914 ADAMS REVERSED
UNIT 6089	1914 ADAMS



ELECTRICAL KEY

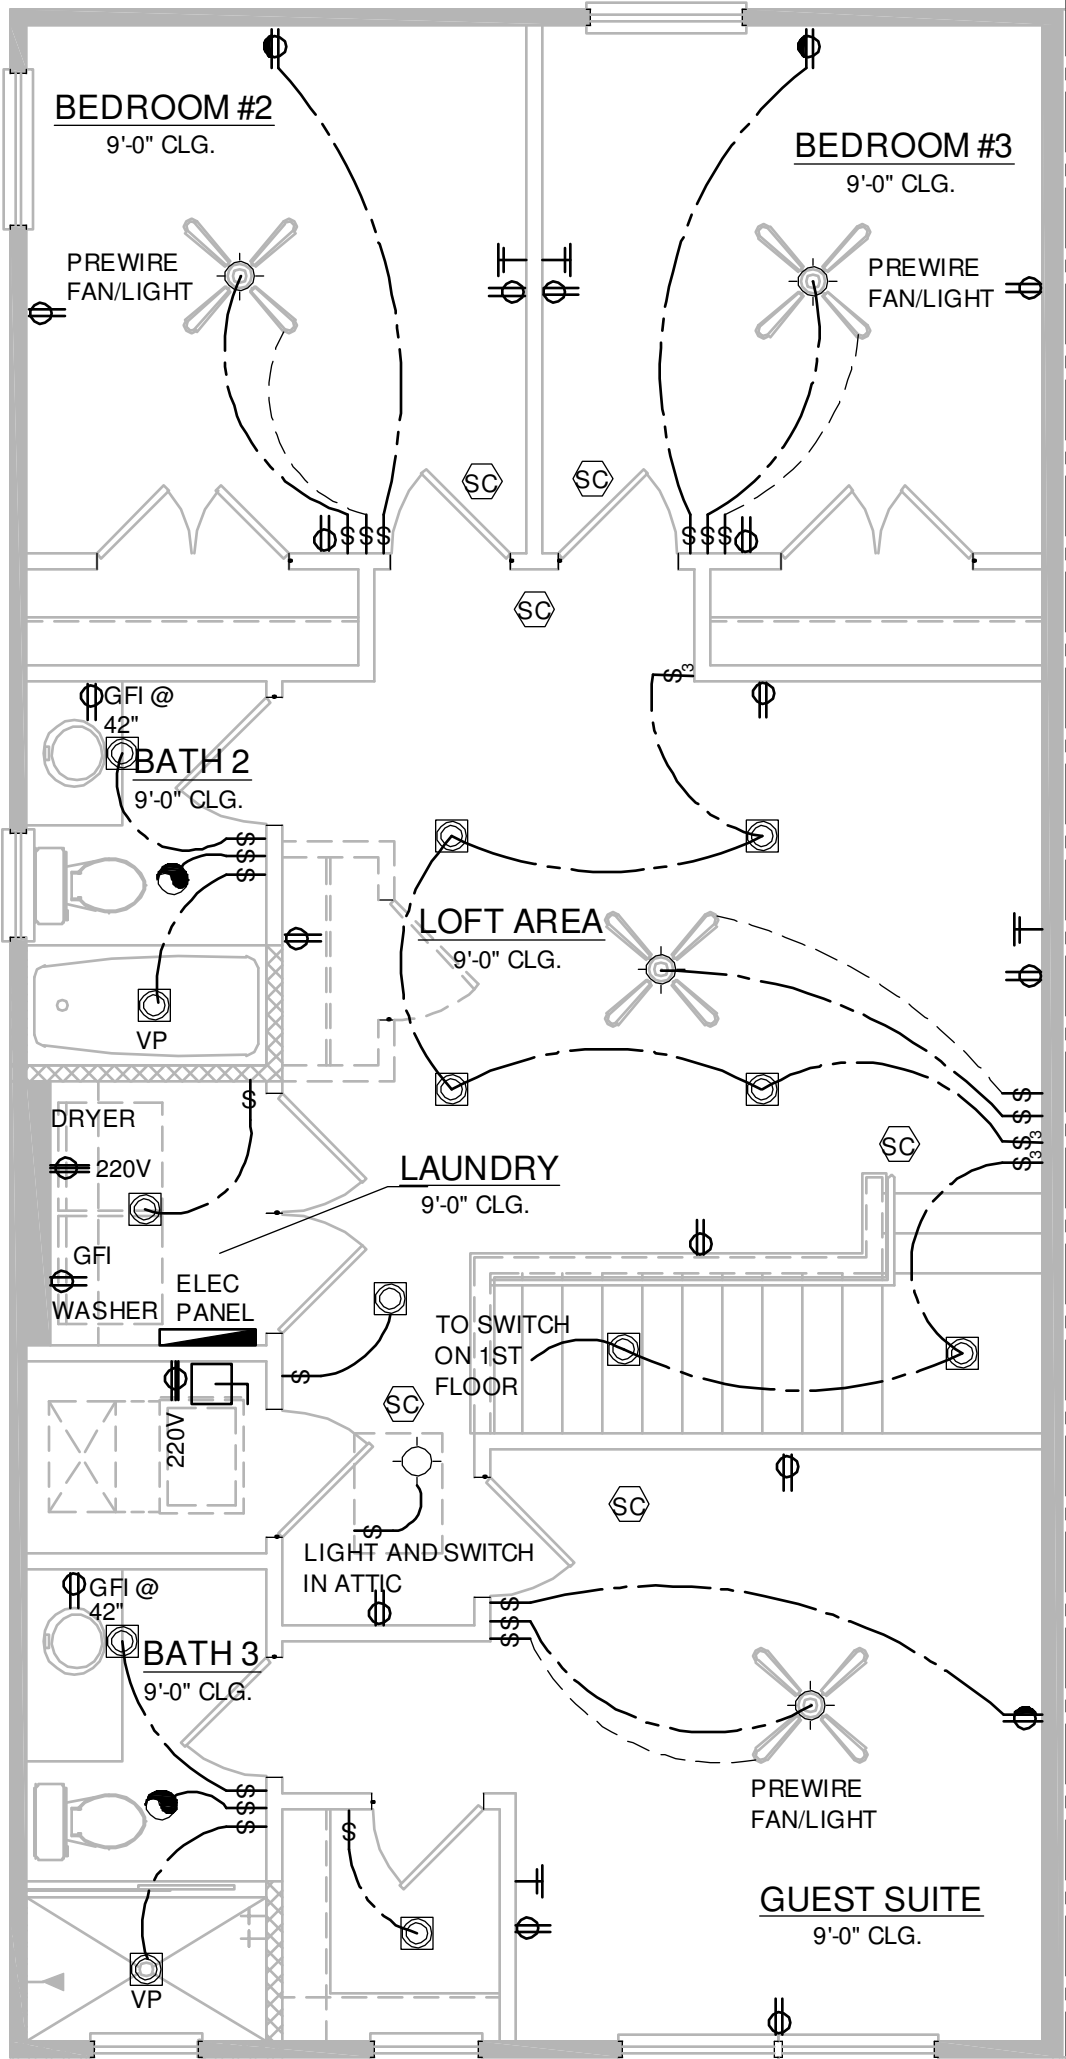- DUPLEX CONVENIENCE OUTLET
- WEATHERPROOF DUPLEX OUTLET
- GROUND FAULT INTERRUPTER DUPLEX OUTLET
- HALF-SWITCHED DUPLEX OUTLET
- DUPLEX OUTLET IN FLOOR
- 220 VOLT OUTLET
- DISPOSAL
- WALL SWITCH
- THREE-WAY SWITCH
- FOUR-WAY SWITCH
- DIMMER SWITCH
- MOTION DETECTOR SWITCH (OPTIONAL)
- PRE-WIRED SPEAKER
- FLUSH MOUNT LED LIGHT FIXTURE
- FLUSH MOUNT LED LIGHT FIXTURE - VAPOR PROOF
- MONO POINT TRACK HEAD (OPTIONAL)
- PENDANT FIXTURE
- SURFACE MOUNTED LED LIGHT FIXTURE
- WALL MOUNTED LIGHT FIXTURE
- FLUSH MOUNTED LED LIGHT FIXTURE
- WALL MOUNTED STRIP LIGHT # OF BULBS SPECIFIED BY BUILDER
- UNDERCABINET LIGHTING (OPTIONAL)
- WALL SCONCE
- EXHAUST FAN
- EXHAUST FAN & LIGHT COMBO
- OUTLET FOR GARAGE DOOR OPENER
- SOFFIT OUTLET (OPTIONAL)
- CHIMES
- PUSHBUTTON SWITCH
- SMOKE DETECTOR
- SMOKE DETECTOR/CARBON MONOXIDE DETECTOR
- CAT 5 TELEPHONE OUTLET PREWIRE
- TELEVISION OUTLET PREWIRE
- THERMOSTAT
- ELECTRIC METER
- ELECTRIC PANEL
- DISCONNECT SWITCH
- SECURITY SYSTEM KEYPAD
- PRE-WIRE FOR CEILING FAN
- PRE-WIRE FOR CEILING FAN / LIGHT COMBO
- SECURITY/FLOOD LIGHTS
- GAS METER
- JUNCTION BOX

GENERAL NOTES

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- TAMPER-RESISTANT "TR" RECEPTACLES: ALL 125-VOLT, 15 & 20 AMPERE ELECTRICAL OUTLETS (RECEPTACLES) IN LIVING ROOM AREAS, BATHROOMS, KITCHEN, GARAGE, LAUNDRY ROOM, AND EXTERIOR LOCATIONS MUST BE "TAMPER-RESISTANT" PER 2020 FBCR. (REFER TO CHAPTERS 34 - 43)
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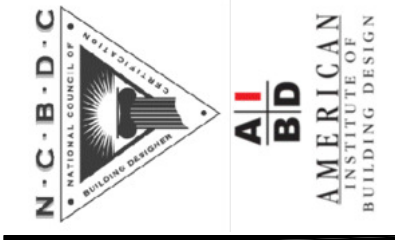
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WALL OUTLETS	12" TO C.L.
TELEPHONE OUTLETS	12" TO C.L.
TELEVISION OUTLETS	12" TO C.L.
EXTERIOR GFIS	12" TO C.L.
GARAGE GFIS (ABOVE GARAGE FLOOR)	48" TO C.L.
THERMOSTAT	54" TO C.L.
DOOR BELL CHIMES	84" TO C.L.
DOOR BELL BUTTON	LEVEL W/ DOOR HANDLE
KITCHEN HOOD FAN "WHIP"	66" TO C.L.
KITCHEN WALL HUNG MICROWAVE RECEPTACLE	76" TO C.L.
KITCHEN DISHWASHER RECEPTACLE	UNDER SINK
KITCHEN RANGE	24" TO C.L.
KITCHEN REFRIGERATOR	48" TO C.L.
WASHER/DRYER OUTLET	36" TO C.L.
HOLLYWOOD LIGHTS	84" TO C.L.
C.L. = CENTER LINE	

title:  
1914 - ADAMS  
FLOOR PLAN

project no. 2023083  
checked: BF  
drawn: BA  
date: 04-12-23  
scale: AS SHOWN


4.2A  
ELEV. A

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www.badesignstudios.com



ENGINEERING PROFESSIONAL SEAL  
SCOTT BROWN, PE, FL #17500  
DATE: April 14, 2023  
TO THE BEST OF MY KNOWLEDGE AND BELIEF, THE INFORMATION CONTAINED HEREIN IS TRUE AND CORRECT AND I AM NOT PROVIDING ANY SERVICE OUTSIDE THE SCOPE OF MY LICENSE.

PARK SQUARE  
HORIZONS WEST  
BABCOCK RANCH BLDG 6 (LOTS 6092-6089) 4 UNIT

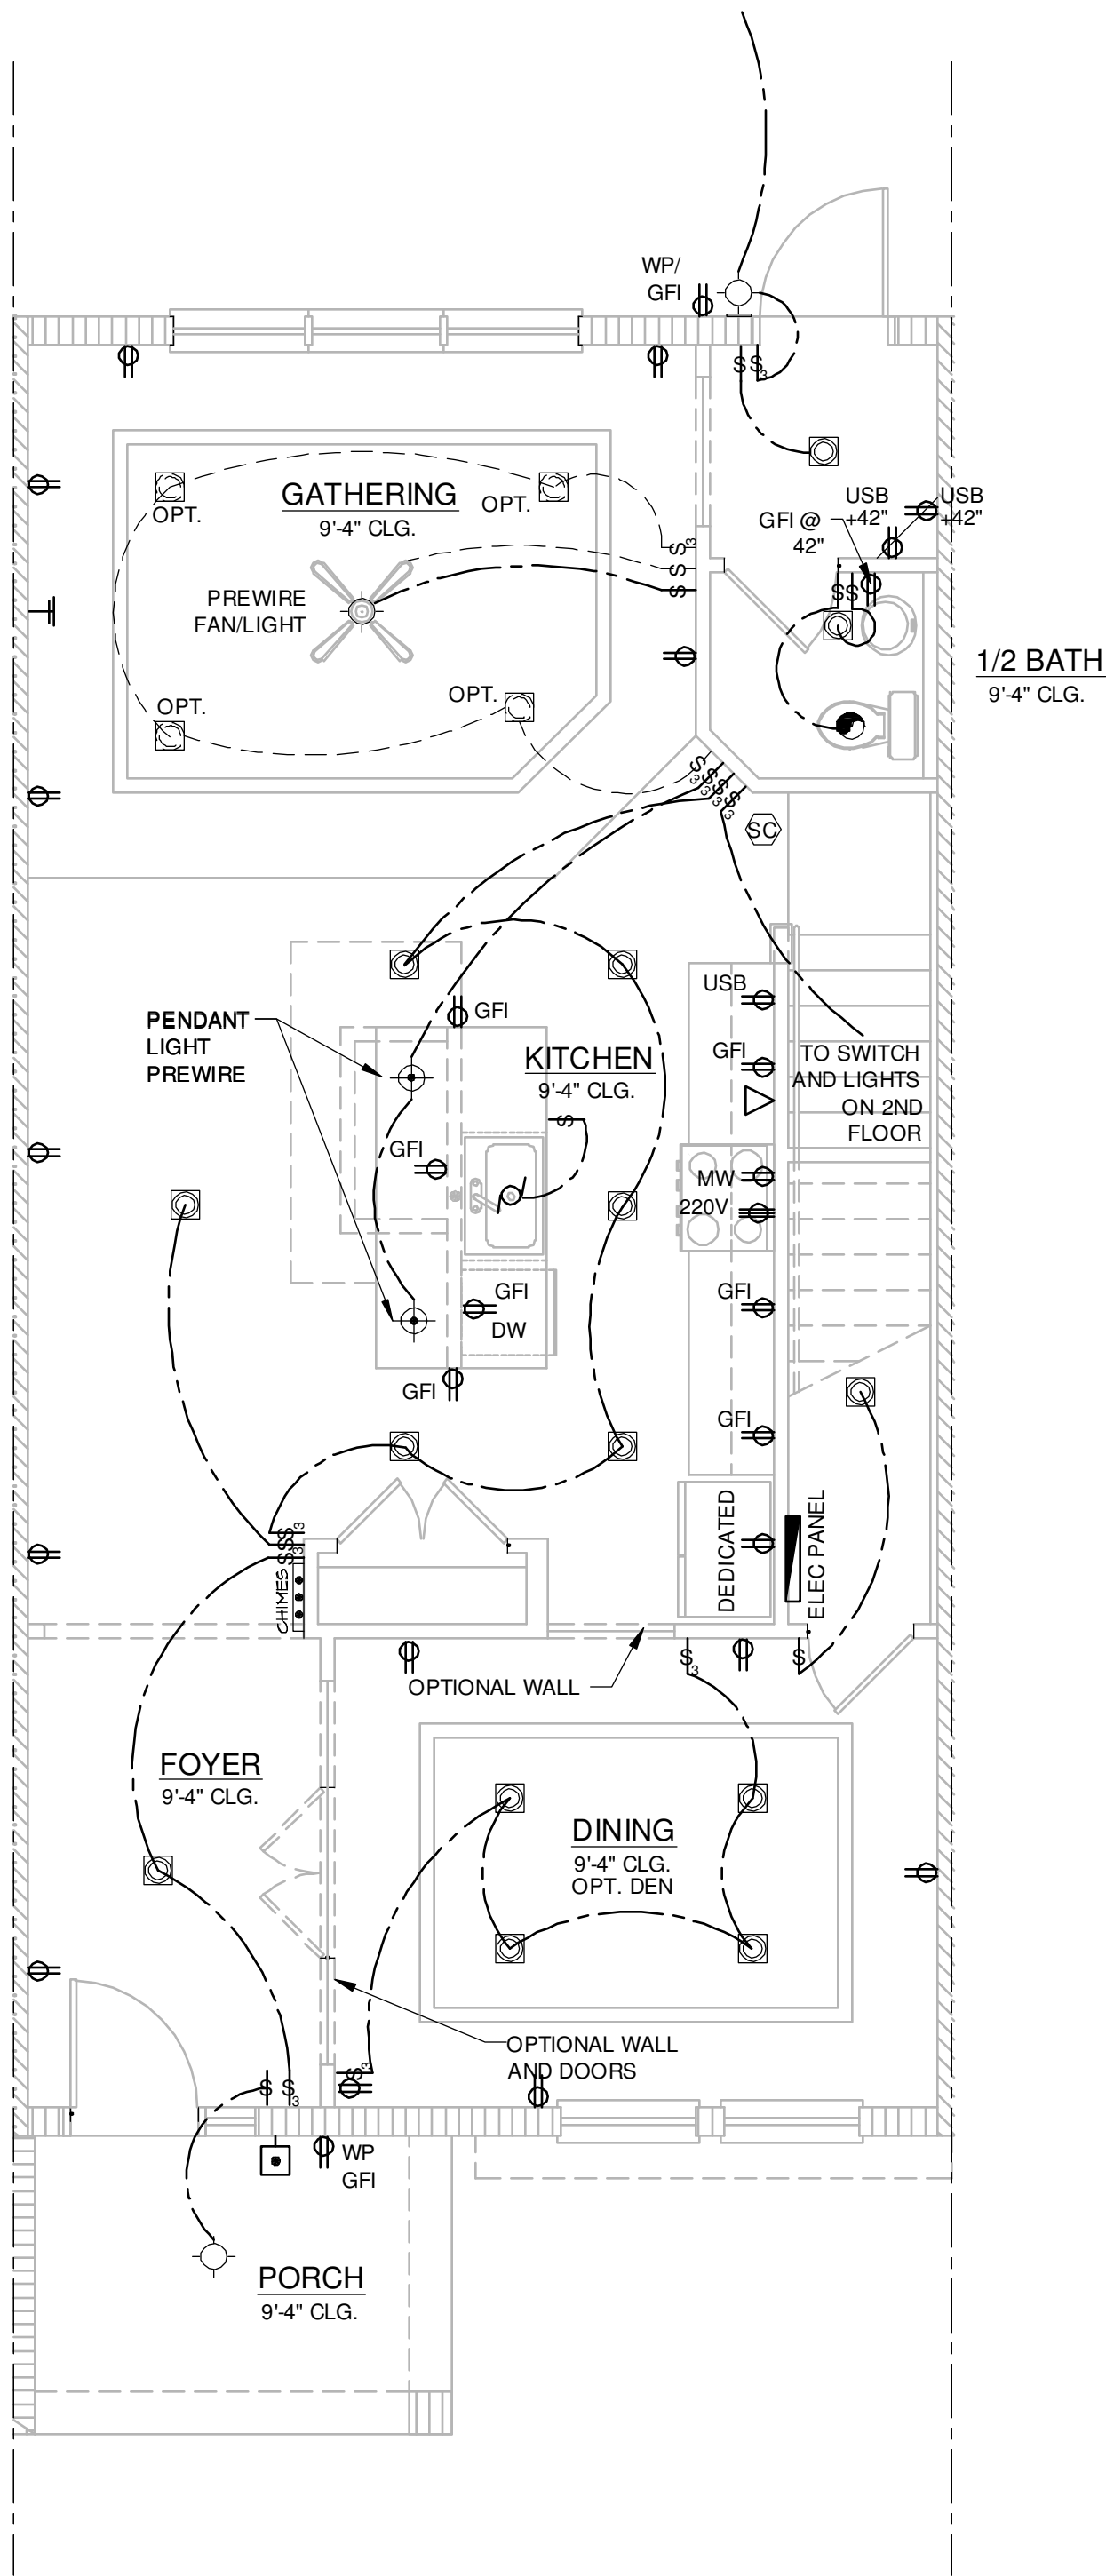


1840 - JEFFERSON  
1ST FLOOR ELECTRICAL

1/4" = 1'-0"

DISCLAIMER

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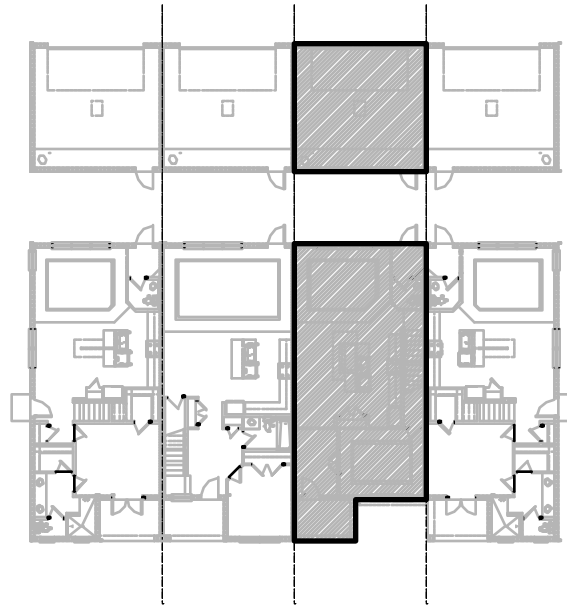


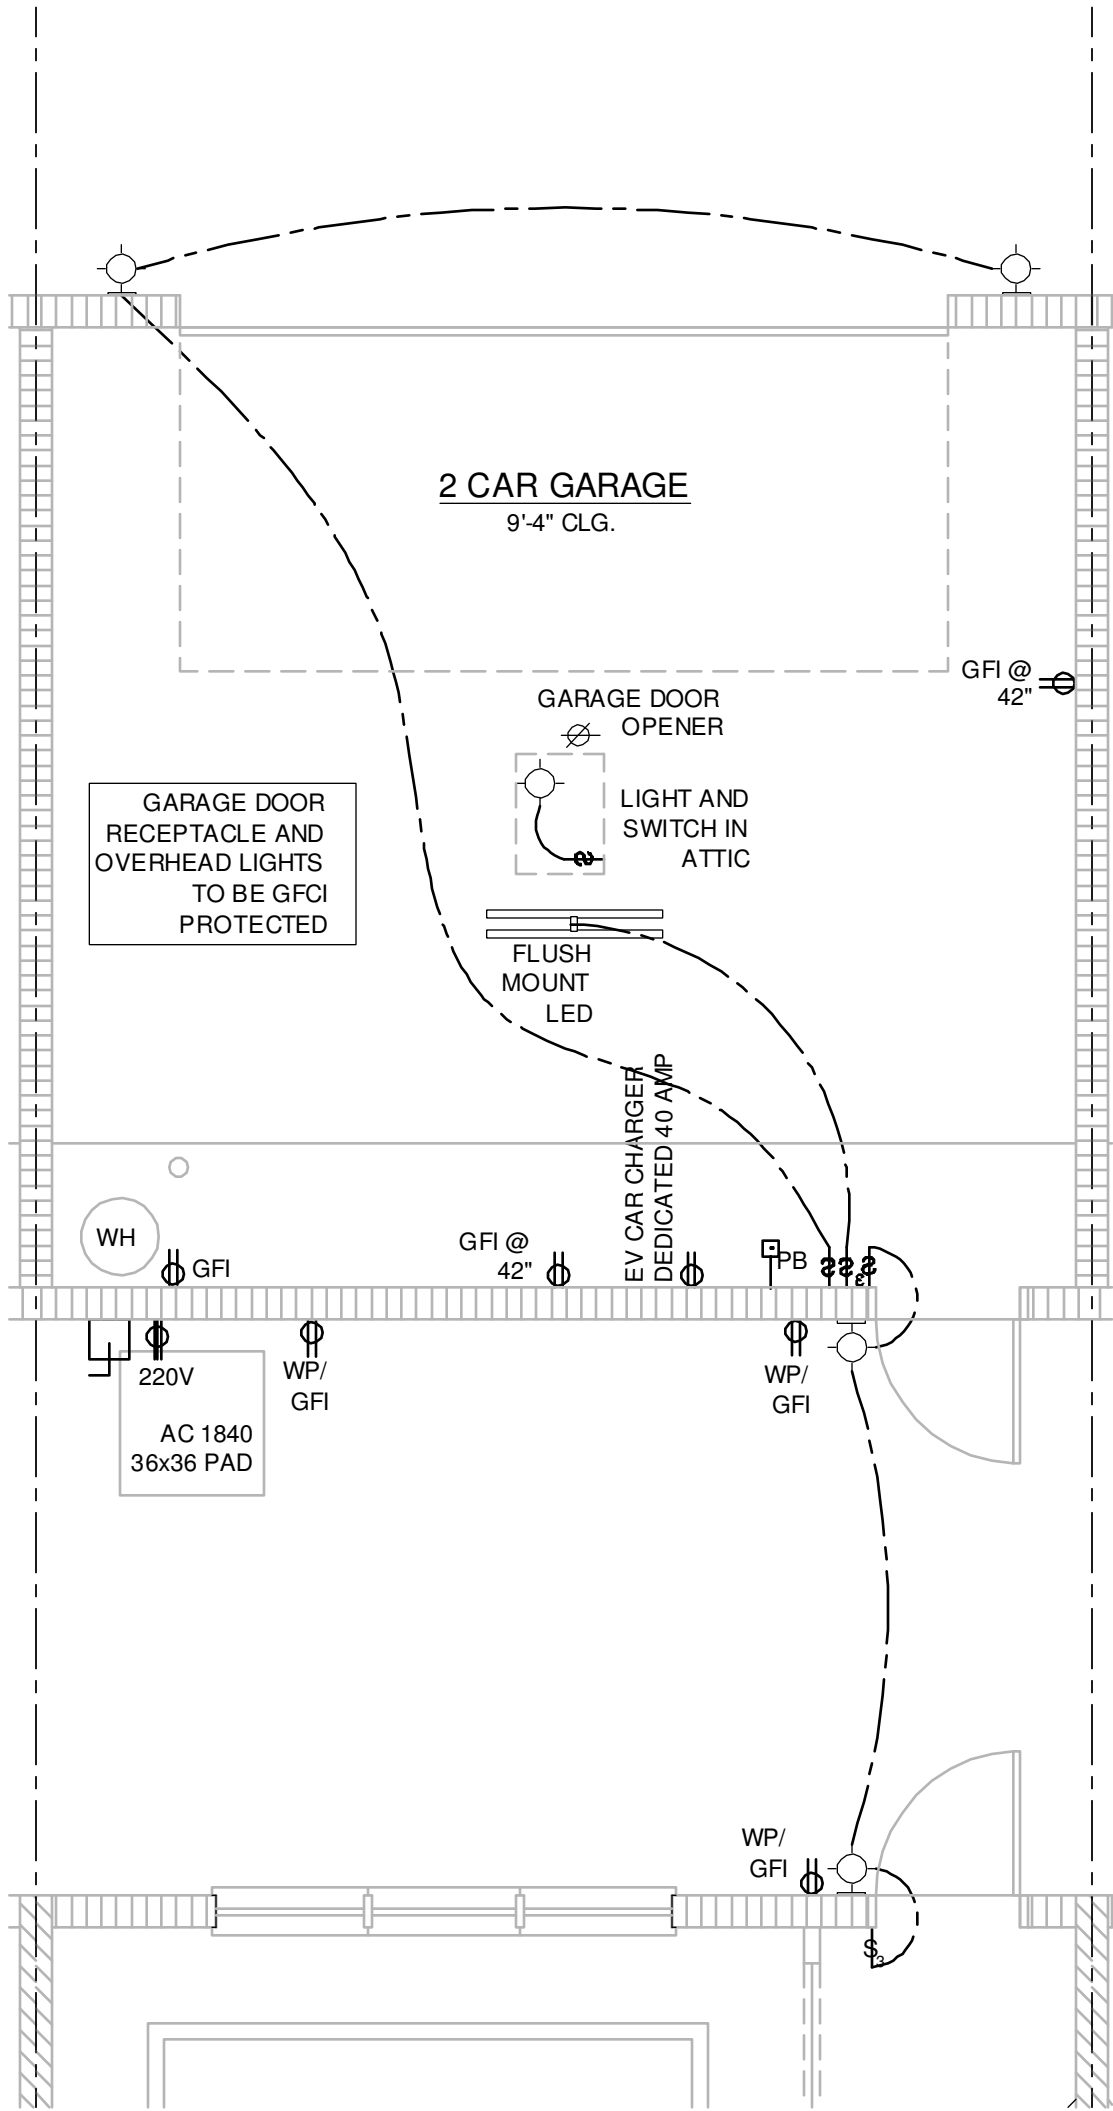1840 - JEFFERSON  
1ST FLOOR ELECTRICAL - GARAGE

1/4" = 1'-0"

NFPA 70  
ADD GFCI PROTECTION TO RECEPTACLES IN LAUNDRY ROOMS AND UTILITY ROOMS OF DWELLINGS WHERE INSTALLED WITHIN 6' OF THE OUTSIDE EDGE OF A SINK. THIS WOULD INCLUDE THE RECEPTACLE INSTALLED FOR A WASHING MACHINE.

RECEPTACLE OUTLETS SHALL NOT BE REQUIRED ON A WALL DIRECTLY BEHIND A RANGE OR SINK TO FULFILL THE REQUIREMENT FOR AN OUTLET EVERY 24". THE WIDTH OF THE SINK OR RANGE IS NOT TO BE INCLUDED IN THE SPACING OF THE OUTLETS UNLESS THE DISTANCE FROM THE SINK OR RANGE IS GREATER THAN 12" FOR STRAIGHT COUNTER TOPS AND 18" FOR SINKS AND RANGES INSTALLED IN CORNER COUNTERS.



1ST FLOOR - KEY PLAN

1/32" = 1'-0"

UNIT 6090 1840 JEFFERSON


Residential Standard Calculation				Version 7.28		9/25/1997		Ravenna Townhomes - Jefferson	
STEP 1 Article 220.42 & 220.52				5,520 VA		Synergy Electrical Systems, Inc. 550 Parkside Pointe Blvd Appoca, FL 32712 Ph: 407-880-3144 Fax: 407-880-3145 11/30/2018 8:27			
sq. ft.	1840	General Lighting load		3,000 VA					
	2	Small Appliance		1,500 VA					
	1	Laundry circuit		10,020 VA					
Gen Lgt. 5m App & Lun. Load				3,000 VA @ 100% = 3,000 VA					
				7,020 VA @ 35% = 2,457 VA					
				VA @ 25% = VA					
				General Lighting Demand Load		5,457 VA			
STEP 2 Article 220.50 & 220.51				5,800 VA		Total Heat Load 5,800 VA			
2.5 ton	4,400 VA	AHU1 5kW		VA		Total CU Load 4,400 VA			
A/C #2	VA	AHU2 Select		VA		Greater of Heat @ 100% vs A/C @ 100% 5,800 VA			
A/C #3	VA	AHU3 Select		VA					
A/C #4	VA	AHU4 Select		VA					
A/C #5	VA	AHU5 Select		VA					
STEP 3 Article 220.53				4,500 VA		Appliance Demand Load 6,938 VA			
1	4,500 VA	Water Heater		1,400 VA		Dryer Demand Load 5,000 VA			
1	1,400 VA	Refrigerator		1,400 VA		Range Demand Load 8,000 VA			
1	600 VA	Freezer		1,030 VA		Service Demand 31,195 VA			
1	1,030 VA	Dishwasher		690 VA		Demand Load 130 A			
1	690 VA	Disposal		VA		Neutral Demand 75 A			
1	780 VA	Trash Compactor		1,630 VA		Min. Service Req. 150 A			
1	1,630 VA	Microwave		VA		Min. Feeder size 4			
		Central Vac		VA		Min. Neutral size 1			
	340 VA	Mini Refrigerator		VA		Eq. Grding. Cond. 6			
	420 VA	Range hood		VA		<input type="checkbox"/> Copper			
	540 VA	Wine Cooler		VA					
	1,500 VA	Ironing Center		VA					
<input type="checkbox"/>	select	Jacuzzi Tub		VA					
<input type="checkbox"/>	select	Sprinkler Pump		VA					
<input type="checkbox"/>	select	Well Pump		VA					
<input type="checkbox"/>	select	Fountain Pump		VA					
<input type="checkbox"/>	select	Elevator		VA					
<input type="checkbox"/>	select	Pool Equip. Panel		VA					
				VA 100% Demand		Total Appliance Load 8,250 VA			
				VA No Demand		4 or more demand @ 75% plus 100% demand loads 6,938 VA			
				VA No Demand					
STEP 4 Article 220.54				5,000 VA					
Electric Clothes Dryers				Col C demand 8,000 W					
STEP 5 Article 220.55				8,000 W					
Electric Ranges				Col B demand 8,000 W					
Number of appliances 1				Cooktop Col B demand					
<input type="checkbox"/> Check Box for Gas Range				Cooktop Col B demand					
				Oven(s) Col B demand					
				Oven(s) Col B demand					
				Oven(s) Col B demand					
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NFPA 70  
ADD GFCI PROTECTION TO RECEPTACLES IN LAUNDRY ROOMS AND UTILITY ROOMS OF DWELLINGS WHERE INSTALLED WITHIN 6' OF THE OUTSIDE EDGE OF A SINK. THIS WOULD INCLUDE THE RECEPTACLE INSTALLED FOR A WASHING MACHINE.

RECEPTACLE OUTLETS SHALL NOT BE REQUIRED ON A WALL DIRECTLY BEHIND A RANGE OR SINK TO FULFILL THE REQUIREMENT FOR AN OUTLET EVERY 24". THE WIDTH OF THE SINK OR RANGE IS NOT TO BE INCLUDED IN THE SPACING OF THE OUTLETS UNLESS THE DISTANCE FROM THE SINK OR RANGE IS GREATER THAN 12" FOR STRAIGHT COUNTER TOPS AND 18" FOR SINKS AND RANGES INSTALLED IN CORNER COUNTERS.



2ND FLOOR - KEY PLAN

1/32" = 1'-0"

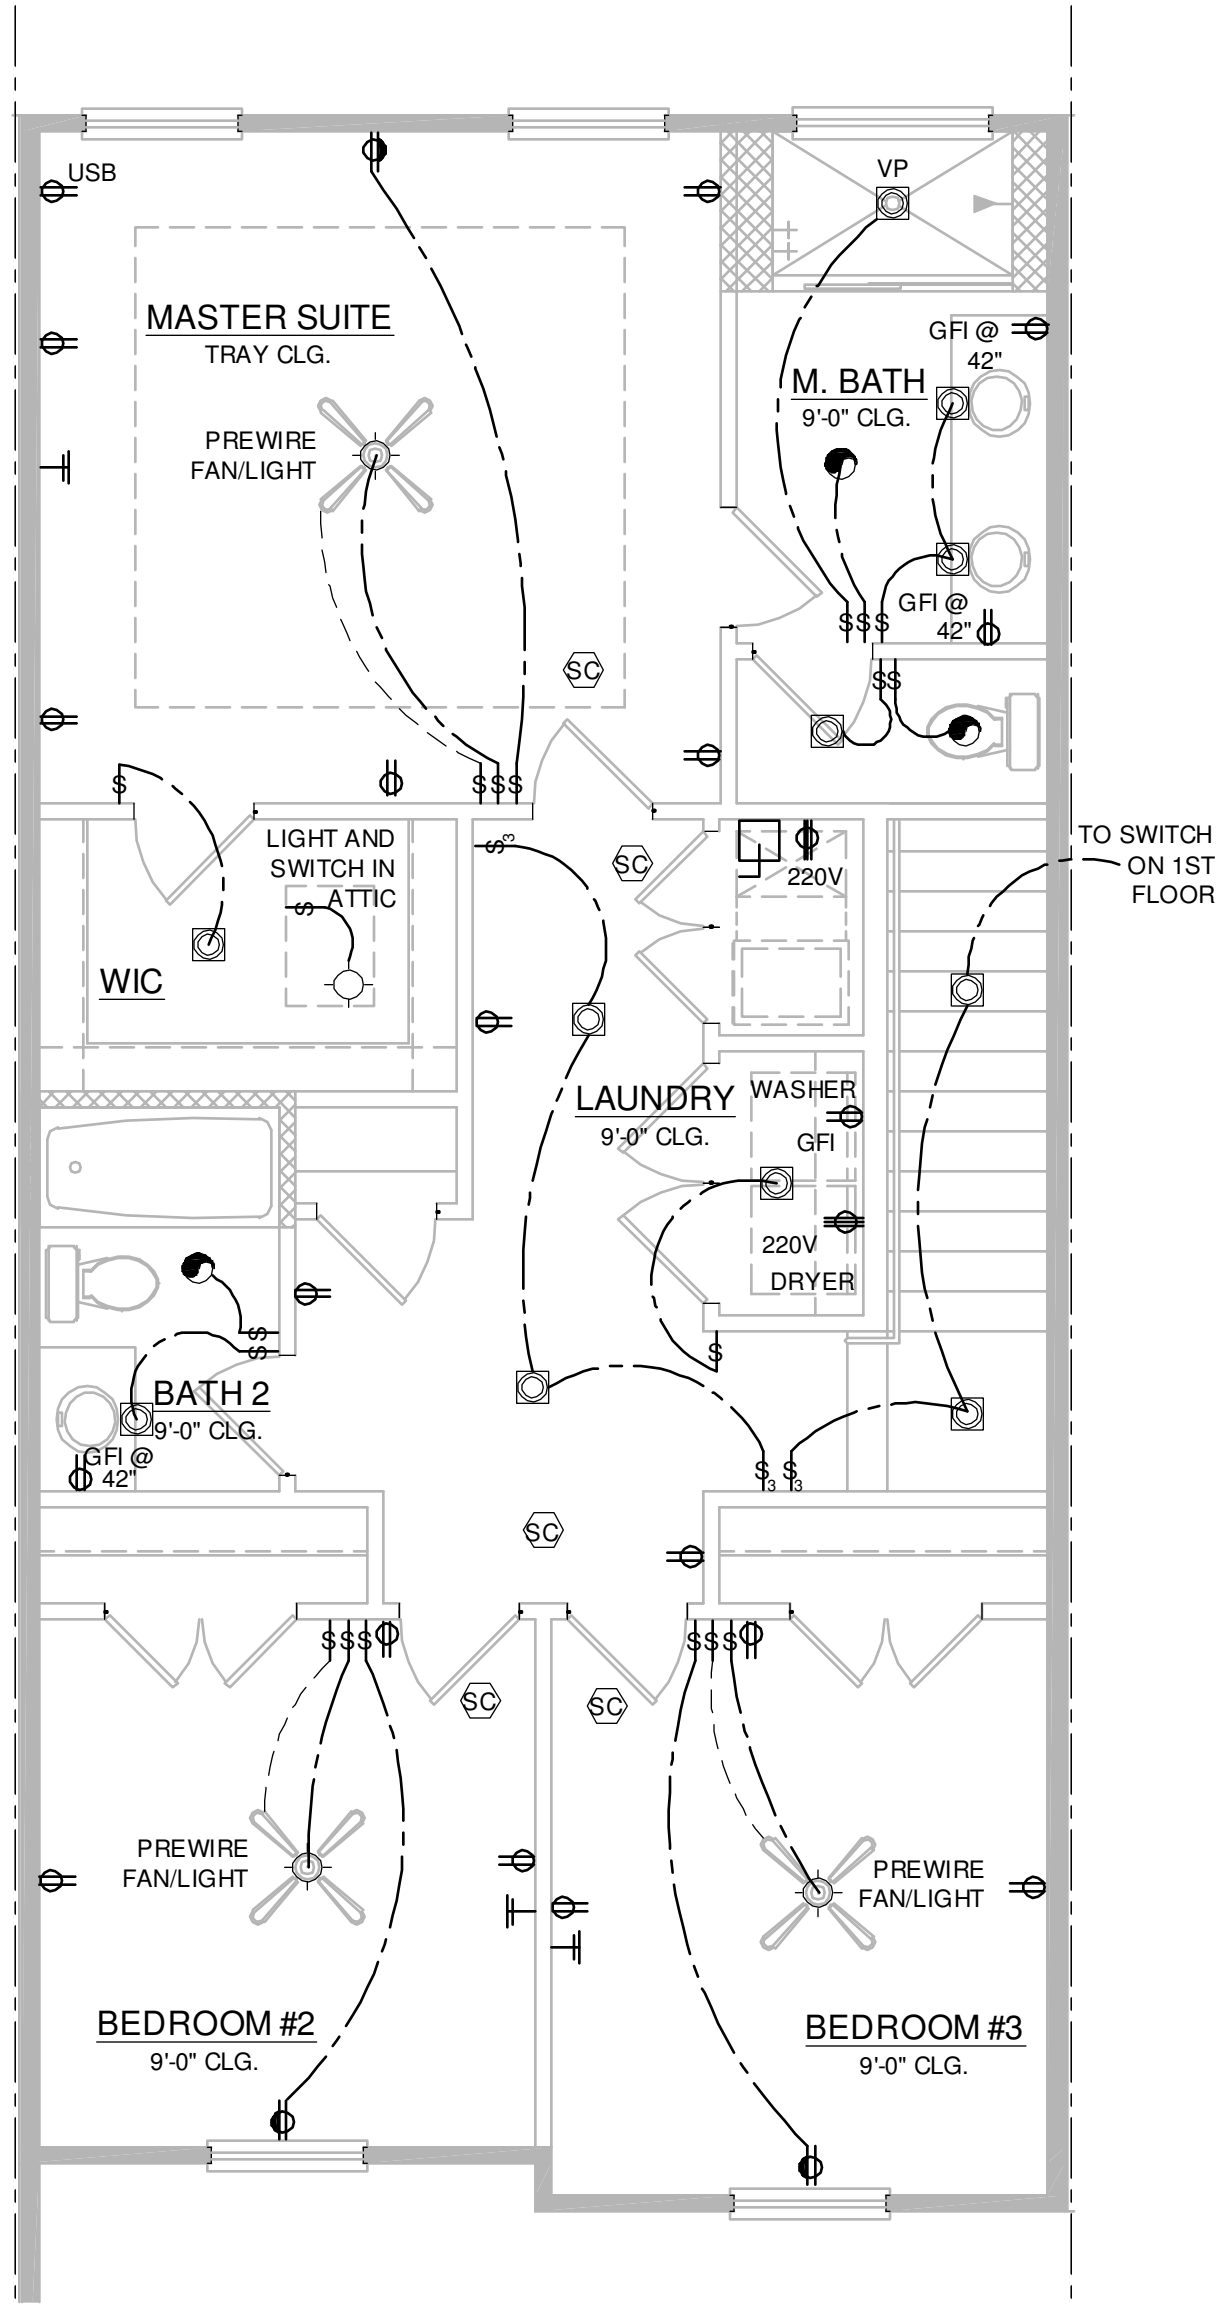UNIT 6090 1840 JEFFERSON

ELECTRICAL KEY

- DUPLEX CONVENIENCE OUTLET
- WEATHERPROOF DUPLEX OUTLET
- GROUND FAULT INTERRUPTER DUPLEX OUTLET
- HALF-SWITCHED DUPLEX OUTLET
- DUPLEX OUTLET IN FLOOR
- 220V OUTLET
- DISPOSAL
- WALL SWITCH
- THREE-WAY SWITCH
- FOUR-WAY SWITCH
- DIMMER SWITCH
- MOTION DETECTOR SWITCH (OPTIONAL)
- PRE-WIRED SPEAKER
- FLUSH MOUNT LED LIGHT FIXTURE
- FLUSH MOUNT LED LIGHT FIXTURE - VAPOR PROOF
- MONO POINT TRACK HEAD (OPTIONAL)
- PENDANT FIXTURE
- SURFACE MOUNTED LED LIGHT FIXTURE
- WALL MOUNTED LIGHT FIXTURE
- FLUSH MOUNTED LED LIGHT FIXTURE
- WALL MOUNTED STRIP LIGHT # OF BULBS SPECIFIED BY BUILDER
- UNDERCABINET LIGHTING (OPTIONAL)
- WALL SCONCE
- EXHAUST FAN
- EXHAUST FAN & LIGHT COMBO
- OUTLET FOR GARAGE DOOR OPENER
- SOFFIT OUTLET (OPTIONAL)
- CHIMES
- PUSHBUTTON SWITCH
- SMOKE DETECTOR
- SMOKE DETECTOR/CARBON MONOXIDE DETECTOR
- CAT 5 TELEPHONE OUTLET PREWIRE
- TELEVISION OUTLET PREWIRE
- THERMOSTAT
- ELECTRIC METER
- ELECTRIC PANEL
- DISCONNECT SWITCH
- SECURITY SYSTEM KEYPAD
- PRE-WIRE FOR CEILING FAN
- PRE-WIRE FOR CEILING FAN / LIGHT COMBO
- SECURITY/FLOOD LIGHTS
- GAS METER
- JUNCTION BOX

GENERAL NOTES

- FAN, PHONE, & CATV LOCATIONS PER CONTRACT.
- ALL SMOKE/CARBON MONOXIDE DETECTORS TO BE INSTALLED PER 2020 FBCR. REFERENCED NFPA 72 AND R314. SMOKE DETECTORS SHALL BE HARDWIRED INTO AN AC ELECTRICAL POWER SOURCE AND SHALL BE EQUIPPED WITH A MONITORED BATTERY BACKUP AND SHALL BE INTERCONNECTED.
- ARCH FAULT BREAKERS: ALL BRANCH CIRCUITS SERVING BEDROOMS, FAMILY ROOMS, HALLWAYS, KITCHEN, LIVING ROOMS, DINING ROOMS, PARLORS, LIBRARIES, DEN, SUNROOMS, REC. ROOMS, CLOSETS AND LAUNDRY AREAS SHALL BE PROTECTED BY ARCH FAULT BREAKERS, PER 2020 FBCR. (REFER TO CHAPTERS 34 - 43)
- NEC 2017 210.52(G)(1) GARAGES. IN EACH ATTACHED GARAGE AND IN EACH DETACHED GARAGE WITH ELECTRIC POWER, AT LEAST ONE RECEPTACLE OUTLET SHALL BE INSTALLED IN EACH VEHICLE BAY, NOT MORE THAN 1.7M (5-1/2 FT.) ABOVE THE FLOOR.
- TAMPER-RESISTANT "TR" RECEPTACLES: ALL 125-VOLT, 15 & 20 AMPERE ELECTRICAL OUTLETS (RECEPTACLES) IN LIVING ROOM AREAS, BATHROOMS, KITCHEN, GARAGE, LAUNDRY ROOM, AND EXTERIOR LOCATIONS MUST BE "TAMPER-RESISTANT" PER 2020 FBCR. (REFER TO CHAPTERS 34 - 43)
- ALL ELECTRICAL WORK AND APPLIANCES SHALL CONFORM TO 2020 FBCR. REFERENCED NFPA 70.
- EXCEPTIONS FROM GFI REQUIREMENTS SHALL BE PERMITTED PROVIDED LOCATION WHERE EXCEPTION IS DESIRED IS ALLOWED PER 2020 FBCR REFERENCED NFPA 70.
- UNLESS OTHERWISE INDICATED OR GOVERNED BY CODE, INSTALL SWITCHES AND RECEPTACLES AT THE FOLLOWING HEIGHTS ABOVE FINISH FLOOR.


ELECTRICAL DEVICES	ABOVE FIN. FLR.
SWITCHES AND WALL OUTLETS OVER COUNTERS	48" TO C.L.
REMAINING SWITCHES	48" TO C.L.
WALL OUTLETS	12" TO C.L.
TELEPHONE OUTLETS	12" TO C.L.
TELEVISION OUTLETS	12" TO C.L.
EXTERIOR GFIS	12" TO C.L.
GARAGE GFIS (ABOVE GARAGE FLOOR)	48" TO C.L.
THERMOSTAT	54" TO C.L.
DOOR BELL CHIMES	84" TO C.L.
DOOR BELL BUTTON	LEVEL W/ DOOR HANDLE
KITCHEN WALL HUNG MICROWAVE RECEPTACLE	66" TO C.L.
KITCHEN HOOD FAN "WHIP"	76" TO C.L.
KITCHEN DISHWASHER RECEPTACLE	UNDER SINK
KITCHEN RANGE	24" TO C.L.
KITCHEN REFRIGERATOR	48" TO C.L.
WASHER/DRYER OUTLET	36" TO C.L.
HOLLYWOOD LIGHTS	84" TO C.L.
C.L. = CENTER LINE	

title:  
1840 - JEFFERSON  
FLOOR PLAN

project no. 2023083  
checked: BF  
drawn: BA  
date: 04-12-23  
scale: AS SHOWN

4.2B  
ELEV. A


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288 Southall Lane, Suite 200, Maitland, FL 32751  
www.fdseng.com  
Professional Engineer (PE) License No. 9191  
Professional Architect License No. 9191  
DATE: April 14, 2023  
TO THE BEST OF MY KNOWLEDGE AND BELIEF, THE INFORMATION CONTAINED HEREIN IS TRUE AND CORRECT AND I AM NOT PROVIDING ANY GUARANTEE OR WARRANTY FOR THE SAME.

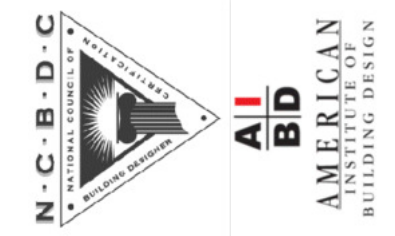PARK SQUARE  
HORIZONS WEST  
BABCOCK RANCH BLDG 6 (LOTS 6092-6099) 4 UNIT

NOTE: DRAWINGS ON 11"x17" SHEET WILL BE ONE HALF THE SCALE NOTED




2024 - MADISON  
1ST FLOOR ELECTRICAL

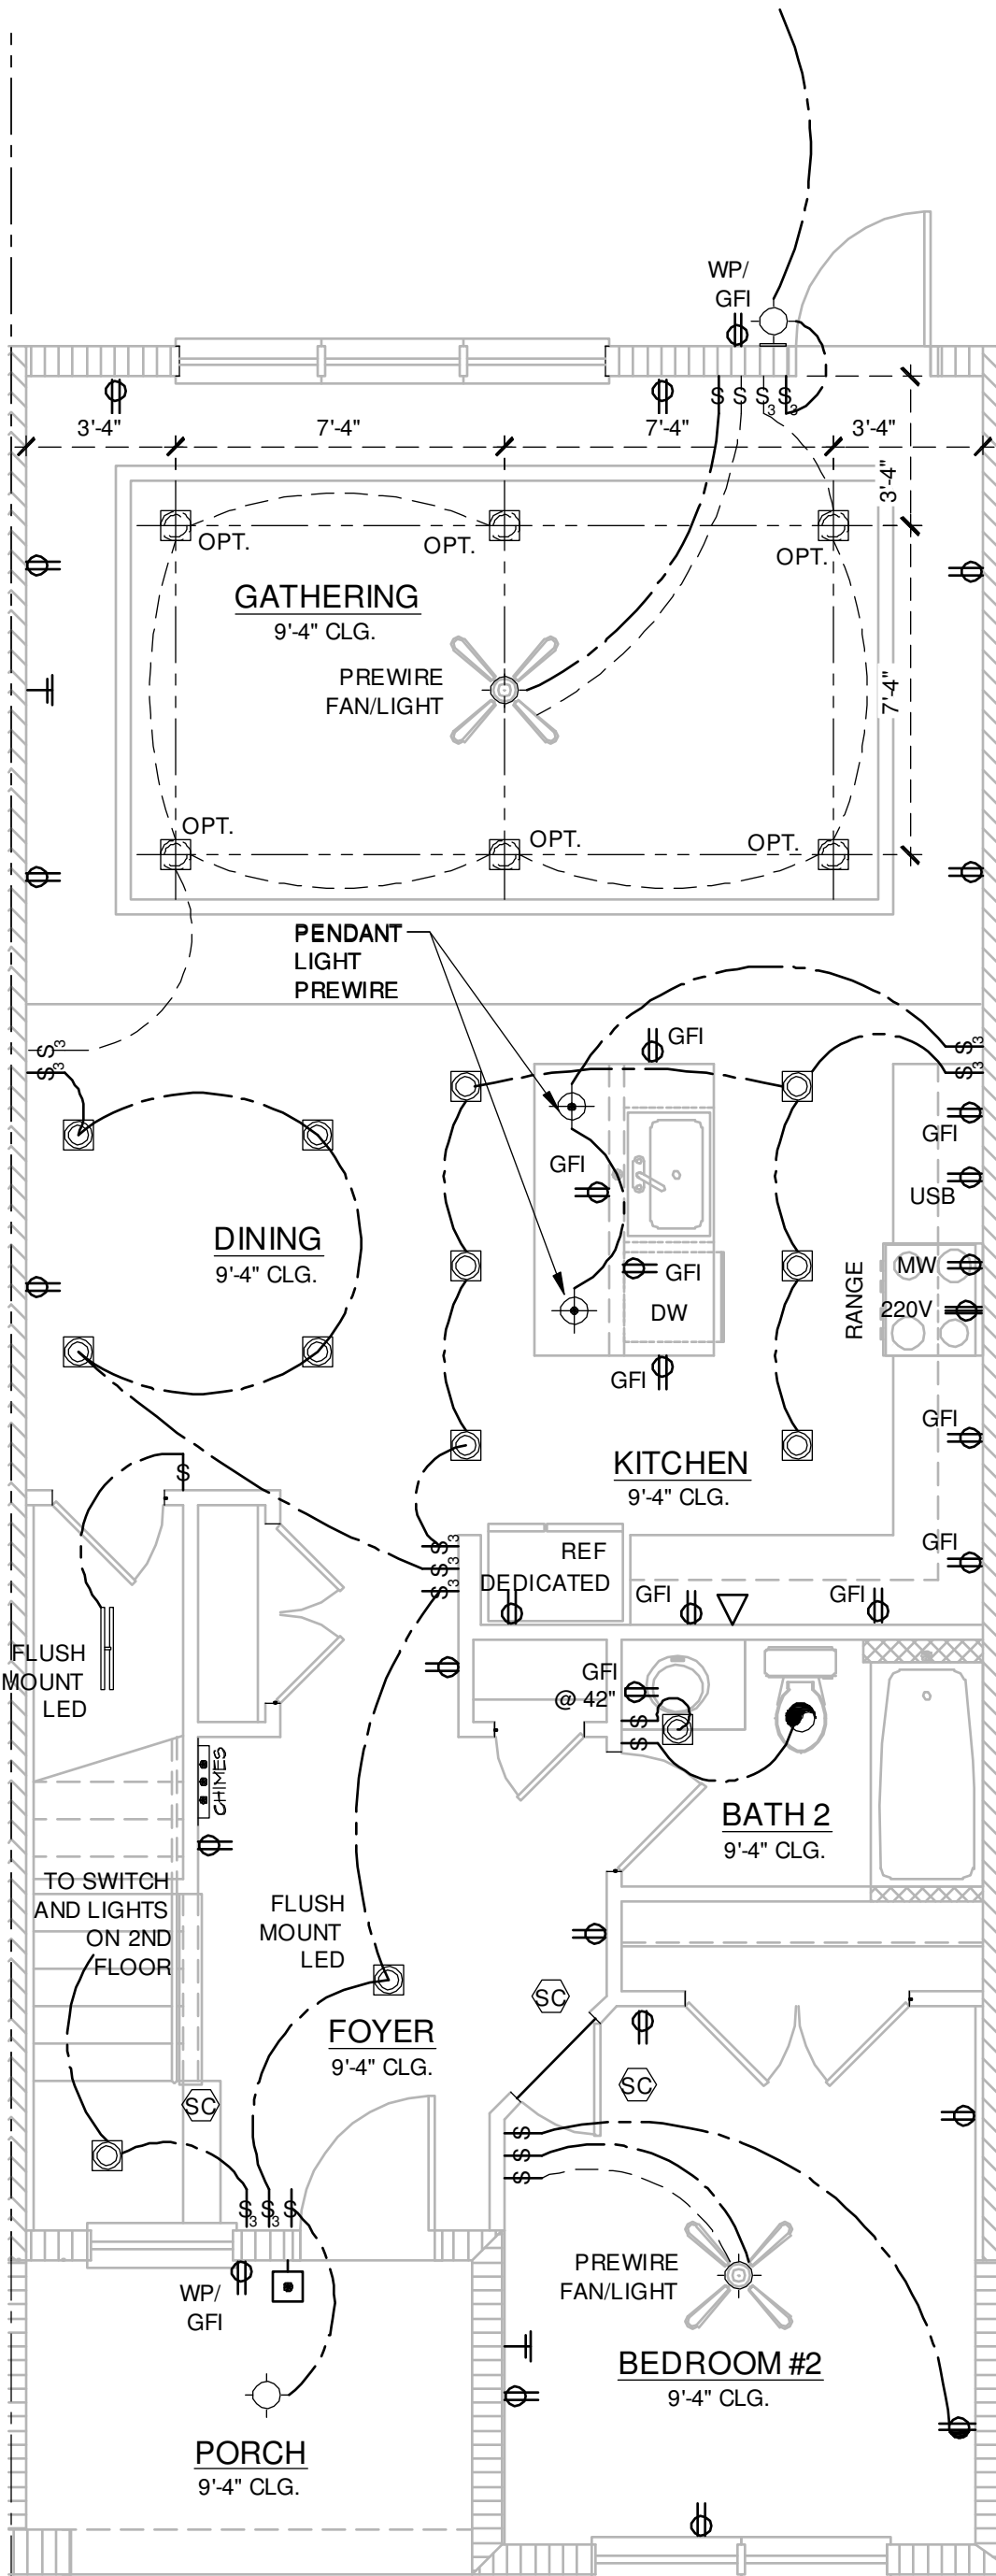1/4" = 1'-0"

DISCLAIMER

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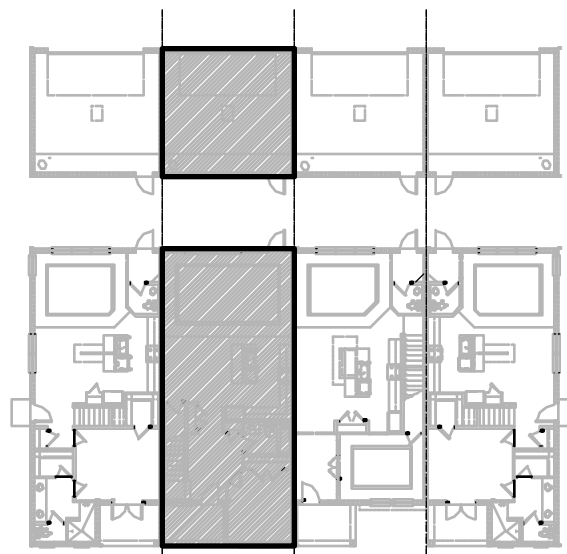


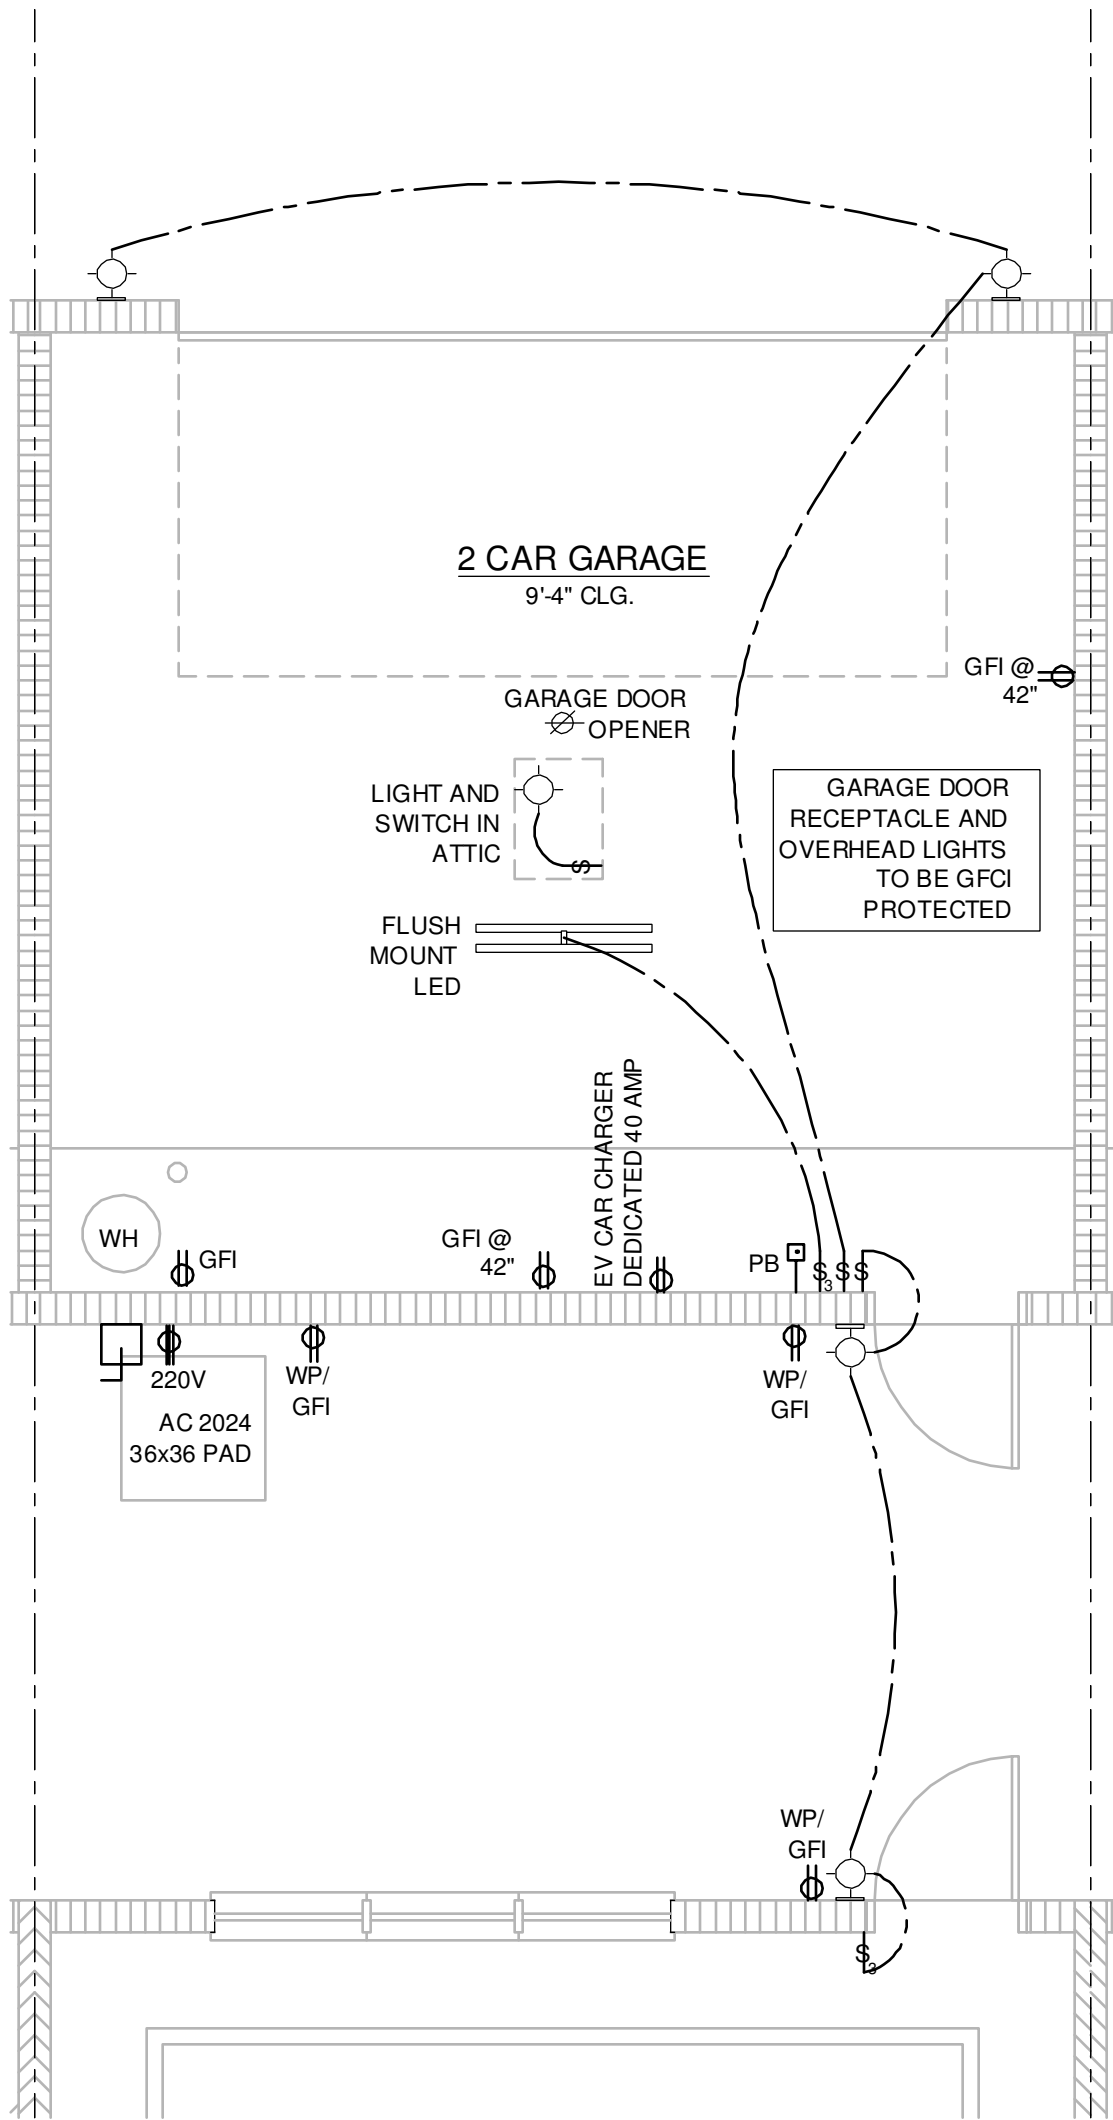2024 - MADISON  
1ST FLOOR ELECTRICAL - GARAGE

1/4" = 1'-0"

NFPA 70  
ADD GFCI PROTECTION TO RECEPTACLES IN LAUNDRY ROOMS AND UTILITY ROOMS OF DWELLINGS WHERE INSTALLED WITHIN 6' OF THE OUTSIDE EDGE OF A SINK. THIS WOULD INCLUDE THE RECEPTACLE INSTALLED FOR A WASHING MACHINE.

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1ST FLOOR - KEY PLAN

1/32" = 1'-0"

UNIT 6091    2024 MADISON

Residential Standard Calculation				Ravenna Townhomes - Madison	
Version 7.28				Synergy Electrical Systems, Inc.	
9/25/1997				550 Parkside Pointe Blvd	
				Apopka, FL 32712	
				Ph: 407-880-3144 Fax: 407-880-3145	
				11/30/2018 9:27	
STEP 1 Article 220.42 & 220.52					
sq. ft.	2014	General Lighting load	6,042 VA		
	2	Small Appliance	3,000 VA		
	1	Laundry circuit	1,500 VA		
		Gen.Lgt., Sm App & Laun. Load	10,542 VA		
		@ 100% =	3,000 VA		
		@ 35% =	2,840 VA		
		@ 25% =	2,640 VA		
STEP 2 Article 220.50 & 220.51				General Lighting Demand Load	
2.5 ton	4,400 VA	AHU1 1 SW	5,800 VA	Total Heat Load	
A/C #2	VA	AHU2 Select	VA	5,800 VA	
A/C #3	VA	AHU3 Select	VA	Total CU Load	
A/C #4	VA	AHU4 Select	VA	4,400 VA	
A/C #5	VA	AHU5 Select	VA	Greater of Heat @ 100% vs. A/C @ 100%	
STEP 3 Article 220.53					
4,500 VA	1	Water Heater	4,500 VA	Appliance Demand Load	
1,400 VA	1	Refrigerator	1,400 VA	6,938 VA	
600 VA		Freezer	VA	Dryer Demand Load	
1,030 VA	1	Dishwasher	1,030 VA	5,000 VA	
690 VA	1	Disposal	690 VA	Range Demand Load	
780 VA		Trash Compactor	VA	8,000 VA	
1,630 VA	1	Microwave	1,630 VA	Service Demand	
		Central Vac	VA	31,377 VA	
		Mini Refrigerator	VA	Demand Load	
		Range Hood	VA	131 A	
		Wine Cooler	VA	Neutral Demand	
		Ironing Center	VA	76 A	
		Jacuzzi Tub	VA	Min. Service Req.	
		Sprinkler Pump	VA	150 A	
		Well Pump	VA	Min. Feeder size	
		Fountain Pump	VA	1	
		Elevator	VA	Min. Neutral size	
		Pool Equip. Panel	VA	4	
			VA	Eq. Grdng Cond.	
			VA	6	
			VA	100% Demand	
			VA	No Demand	
			VA	No Demand	
			VA	4 or more demand @ 75% plus 100% demand loads	
			VA	6,938 VA	
STEP 4 Article 220.54				Total Appliance Load	
STEP 5 Article 220.55				9,250 VA	
Electric Clothes Dryers				5,000 VA	
Electric Ranges				8,000 W	
Number of appliances				1	
				Cooktop	
				Cooktop	
				Oven(s)	
				Oven(s)	
				Number of appliances	
				Cooktop & Oven Demand Load	
				0%	
				W	

ELECTRICAL KEY

- DUPLEX CONVENIENCE OUTLET
- WEATHERPROOF DUPLEX OUTLET
- GROUND FAULT INTERRUPTER DUPLEX OUTLET
- HALF-SWITCHED DUPLEX OUTLET
- DUPLEX OUTLET IN FLOOR
- 220 VOLT OUTLET
- DISPOSAL
- WALL SWITCH
- THREE-WAY SWITCH
- FOUR-WAY SWITCH
- DIMMER SWITCH
- MOTION DETECTOR SWITCH (OPTIONAL)
- PRE-WIRED SPEAKER
- FLUSH MOUNT LED LIGHT FIXTURE
- FLUSH MOUNT LED LIGHT FIXTURE - VAPOR PROOF
- MONO POINT TRACK HEAD (OPTIONAL)
- PENDANT FIXTURE
- SURFACE MOUNTED LED LIGHT FIXTURE
- WALL MOUNTED LIGHT FIXTURE
- FLUSH MOUNTED LED LIGHT FIXTURE
- WALL MOUNTED STRIP LIGHT # OF BULBS SPECIFIED BY BUILDER
- UNDERCABINET LIGHTING (OPTIONAL)
- WALL SCONCE
- EXHAUST FAN
- EXHAUST FAN & LIGHT COMBO
- OUTLET FOR GARAGE DOOR OPENER
- SOFFIT OUTLET (OPTIONAL)
- CHIMES
- PUSHBUTTON SWITCH
- SMOKE DETECTOR
- SMOKE DETECTOR/CARBON MONOXIDE DETECTOR
- CAT 5 TELEPHONE OUTLET PREWIRE
- TELEVISION OUTLET PREWIRE
- THERMOSTAT
- ELECTRIC METER
- ELECTRIC PANEL
- DISCONNECT SWITCH
- SECURITY SYSTEM KEYPAD
- PRE-WIRE FOR CEILING FAN
- PRE-WIRE FOR CEILING FAN / LIGHT COMBO
- SECURITY/FLOOD LIGHTS
- GAS METER
- JUNCTION BOX

GENERAL NOTES

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- TAMPER-RESISTANT "TR" RECEPTACLES: ALL 125-VOLT, 15 & 20 AMPERE ELECTRICAL OUTLETS (RECEPTACLES) IN LIVING ROOM AREAS, BATHROOMS, KITCHEN, GARAGE, LAUNDRY ROOM, AND EXTERIOR LOCATIONS MUST BE "TAMPER-RESISTANT" PER 2020 FBOR. (REFER TO CHAPTERS 34 - 43)
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- UNLESS OTHERWISE INDICATED OR GOVERNED BY CODE, INSTALL SWITCHES AND RECEPTACLES AT THE FOLLOWING HEIGHTS ABOVE FINISH FLOOR.

ELECTRICAL DEVICES	ABOVE FIN. FLR.
SWITCHES AND WALL OUTLETS OVER COUNTERS	48" TO C.L.
REMAINING SWITCHES	48" TO C.L.
WALL OUTLETS	12" TO C.L.
TELEPHONE OUTLETS	12" TO C.L.
TELEVISION OUTLETS	12" TO C.L.
EXTERIOR GFIS	12" TO C.L.
GARAGE GFIS (ABOVE GARAGE FLOOR)	48" TO C.L.
THERMOSTAT	54" TO C.L.
DOOR BELL CHIMES	84" TO C.L.
DOOR BELL BUTTON	LEVEL W/ DOOR HANDLE
KITCHEN WALL HUNG MICROWAVE RECEPTACLE	76" TO C.L.
KITCHEN DISHWASHER RECEPTACLE	UNDER SINK
KITCHEN RANGE	24" TO C.L.
KITCHEN REFRIGERATOR	48" TO C.L.
WASHER DRYER OUTLET	36" TO C.L.
HOLLYWOOD LIGHTS	84" TO C.L.
C.L. = CENTER LINE	

B&A Design Studio, Inc.

FLORIDA DESIGN SOLUTIONS, INC.

FDS

FDS JOB NO.

PARK SQUARE  
HORIZONS WEST  
BARBECOCK RANCH BLDG 6 (LOTS 6092-6099) 4 UNIT

title:  
2024 - MADISON  
ELECTRICAL

project no. 2023083  
checked: BF  
drawn: BA  
date: 04-12-23  
scale: AS SHOWN

4.1C  
ELEV. A


4017 W. 1st Street  
Sanford, FL 32771  
ph 407 829 8800  
fax 407 829 2040  
www.badesignstudios.com

DISCLAIMER

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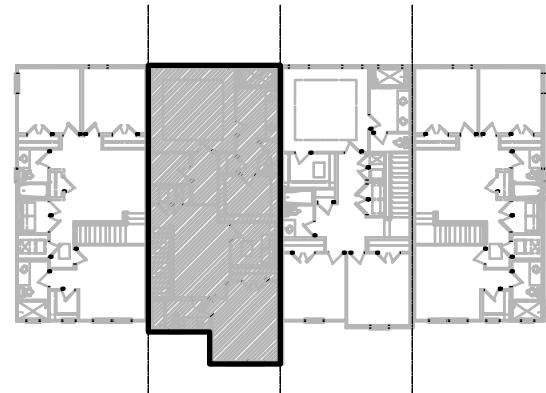
NFPA 70  
ADD GFCI PROTECTION TO RECEPTACLES IN LAUNDRY ROOMS AND UTILITY ROOMS OF DWELLINGS WHERE INSTALLED WITHIN 6' OF THE OUTSIDE EDGE OF A SINK. THIS WOULD INCLUDE THE RECEPTACLE INSTALLED FOR A WASHING MACHINE.

RECEPTACLE OUTLETS SHALL NOT BE REQUIRED ON A WALL DIRECTLY BEHIND A RANGE OR SINK TO FULFILL THE REQUIREMENT FOR AN OUTLET EVERY 24". THE WIDTH OF THE SINK OR RANGE IS NOT TO BE INCLUDED IN THE SPACING OF THE OUTLETS UNLESS THE DISTANCE FROM THE SINK OR RANGE IS GREATER THAN 12" FOR STRAIGHT COUNTER TOPS AND 18" FOR SINKS AND RANGES INSTALLED IN CORNER COUNTERS.

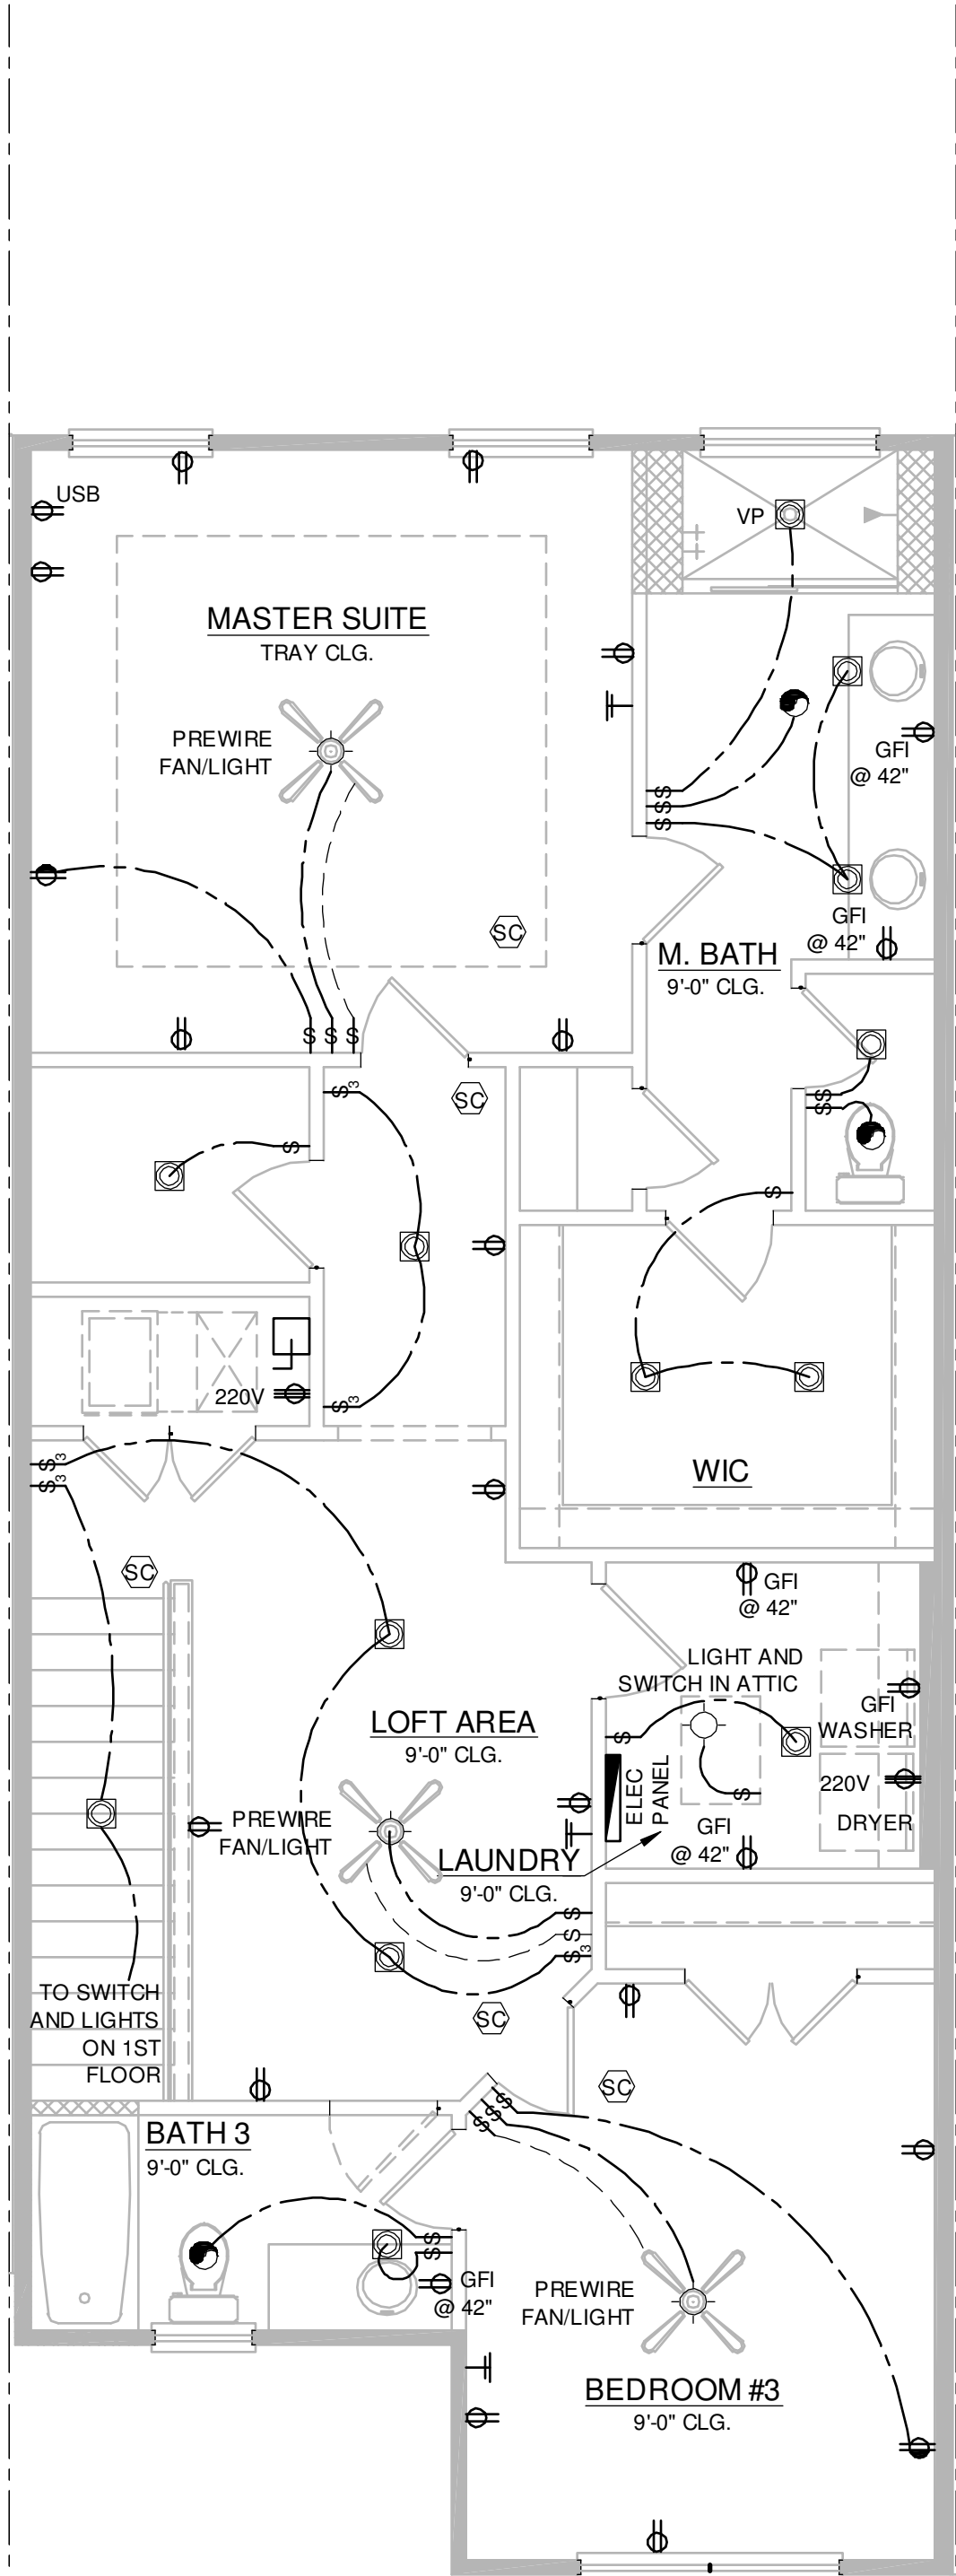

2024 - MADISON  
2ND FLOOR ELECTRICAL

1/4" = 1'-0"



2ND FLOOR - KEY PLAN

1/32" = 1'-0"

UNIT 6091

2024 MADISON

ELECTRICAL KEY

- DUPLEX CONVENIENCE OUTLET
- WEATHERPROOF DUPLEX OUTLET
- GROUND FAULT INTERRUPTER DUPLEX OUTLET
- HALF-SWITCHED DUPLEX OUTLET
- DUPLEX OUTLET IN FLOOR
- 220 VOLT OUTLET
- DISPOSAL
- WALL SWITCH
- THREE-WAY SWITCH
- FOUR-WAY SWITCH
- DIMMER SWITCH
- MOTION DETECTOR SWITCH (OPTIONAL)
- PRE-WIRED SPEAKER
- FLUSH MOUNT LED LIGHT FIXTURE
- FLUSH MOUNT LED LIGHT FIXTURE - VAPOR PROOF
- MONO POINT TRACK HEAD (OPTIONAL)
- PENDANT FIXTURE
- SURFACE MOUNTED LED LIGHT FIXTURE
- WALL MOUNTED LIGHT FIXTURE
- FLUSH MOUNTED LED LIGHT FIXTURE
- WALL MOUNTED STRIP LIGHT # OF BULBS SPECIFIED BY BUILDER
- UNDERCABINET LIGHTING (OPTIONAL)
- WALL SCONCE
- EXHAUST FAN
- EXHAUST FAN & LIGHT COMBO
- OUTLET FOR GARAGE DOOR OPENER
- SOFFIT OUTLET (OPTIONAL)
- CHIMES
- PUSHBUTTON SWITCH
- SMOKE DETECTOR
- SMOKE DETECTOR/CARBON MONOXIDE DETECTOR
- CAT 5 TELEPHONE OUTLET PREWIRE
- TELEVISION OUTLET PREWIRE
- THERMOSTAT
- ELECTRIC METER
- ELECTRIC PANEL
- DISCONNECT SWITCH
- SECURITY/SYSTEM KEYPAD
- PRE-WIRE FOR CEILING FAN
- PRE-WIRE FOR CEILING FAN / LIGHT COMBO
- SECURITY/FLOOD LIGHTS
- GAS METER
- JUNCTION BOX

GENERAL NOTES

- FAN, PHONE, & CATV LOCATIONS PER CONTRACT.
- ALL SMOKE/CARBON MONOXIDE DETECTORS TO BE INSTALLED PER 2020 FBOR. REFERENCED NFPA 72 AND R314. SMOKE DETECTORS SHALL BE HARDWIRED INTO AN AC ELECTRICAL POWER SOURCE AND SHALL BE EQUIPPED WITH A MONITORED BATTERY BACKUP AND SHALL BE INTERCONNECTED.
- ARCH FAULT BREAKERS: ALL BRANCH CIRCUITS SERVING BEDROOMS, FAMILY ROOMS, HALLWAYS, KITCHEN, LIVING ROOMS, DINING ROOMS, PARLORS, LIBRARIES, DEN, SUNROOMS, REC. ROOMS, CLOSETS AND LAUNDRY AREAS SHALL BE PROTECTED BY ARCH FAULT BREAKERS, PER 2020 FBOR. (REFER TO CHAPTERS 34 - 43)
- NEC 2017 210.52(G)(1) GARAGES. IN EACH ATTACHED GARAGE AND IN EACH DETACHED GARAGE WITH ELECTRIC POWER, AT LEAST ONE RECEPTACLE OUTLET SHALL BE INSTALLED IN EACH VEHICLE BAY, NOT MORE THAN 1.7M (5-1/2 FT.) ABOVE THE FLOOR.
- TAMPER-RESISTANT "TR" RECEPTACLES: ALL 125-VOLT, 15 & 20 AMPERE ELECTRICAL OUTLETS (RECEPTACLES) IN LIVING ROOM AREAS, BATHROOMS, KITCHEN, GARAGE, LAUNDRY ROOM, AND EXTERIOR LOCATIONS MUST BE "TAMPER-RESISTANT" PER 2020 FBOR. (REFER TO CHAPTERS 34 - 43)
- ALL ELECTRICAL WORK AND APPLIANCES SHALL CONFORM TO 2020 FBOR. REFERENCED NFPA 70.
- EXCEPTIONS FROM GFI REQUIREMENTS SHALL BE PERMITTED PROVIDED LOCATION WHERE EXCEPTION IS DESIRED IS ALLOWED PER 2020 FBOR REFERENCED NFPA 70.
- UNLESS OTHERWISE INDICATED OR GOVERNED BY CODE, INSTALL SWITCHES AND RECEPTACLES AT THE FOLLOWING HEIGHTS ABOVE FINISH FLOOR.


ELECTRICAL DEVICES	ABOVE FIN. FLR.
SWITCHES AND WALL OUTLETS OVER COUNTERS	48" TO C.L.
REMAINING SWITCHES	48" TO C.L.
WALL OUTLETS	12" TO C.L.
TELEPHONE OUTLETS	12" TO C.L.
TELEVISION OUTLETS	12" TO C.L.
EXTERIOR GFIS	12" TO C.L.
GARAGE GFIS (ABOVE GARAGE FLOOR)	48" TO C.L.
THERMOSTAT	54" TO C.L.
DOOR BELL CHIMES	84" TO C.L.
DOOR BELL BUTTON	LEVEL W/ DOOR HANDLE
KITCHEN WALL HUNG MICROWAVE RECEPTACLE	66" TO C.L.
KITCHEN HOOD FAN "WHIP"	76" TO C.L.
KITCHEN DISHWASHER RECEPTACLE	UNDER SINK
KITCHEN RANGE	24" TO C.L.
KITCHEN REFRIGERATOR	48" TO C.L.
WASHER/DRYER OUTLET	36" TO C.L.
HOLLYWOOD LIGHTS	84" TO C.L.
C.L. = CENTER LINE	

title:  
2024 - MADISON  
FLOOR PLAN

project no. 2023083  
checked: BF  
drawn: BA  
date: 04-12-23  
scale: AS SHOWN

4.2C  
ELEV. A

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ph 407 829 8800  
fax 407 829 2040  
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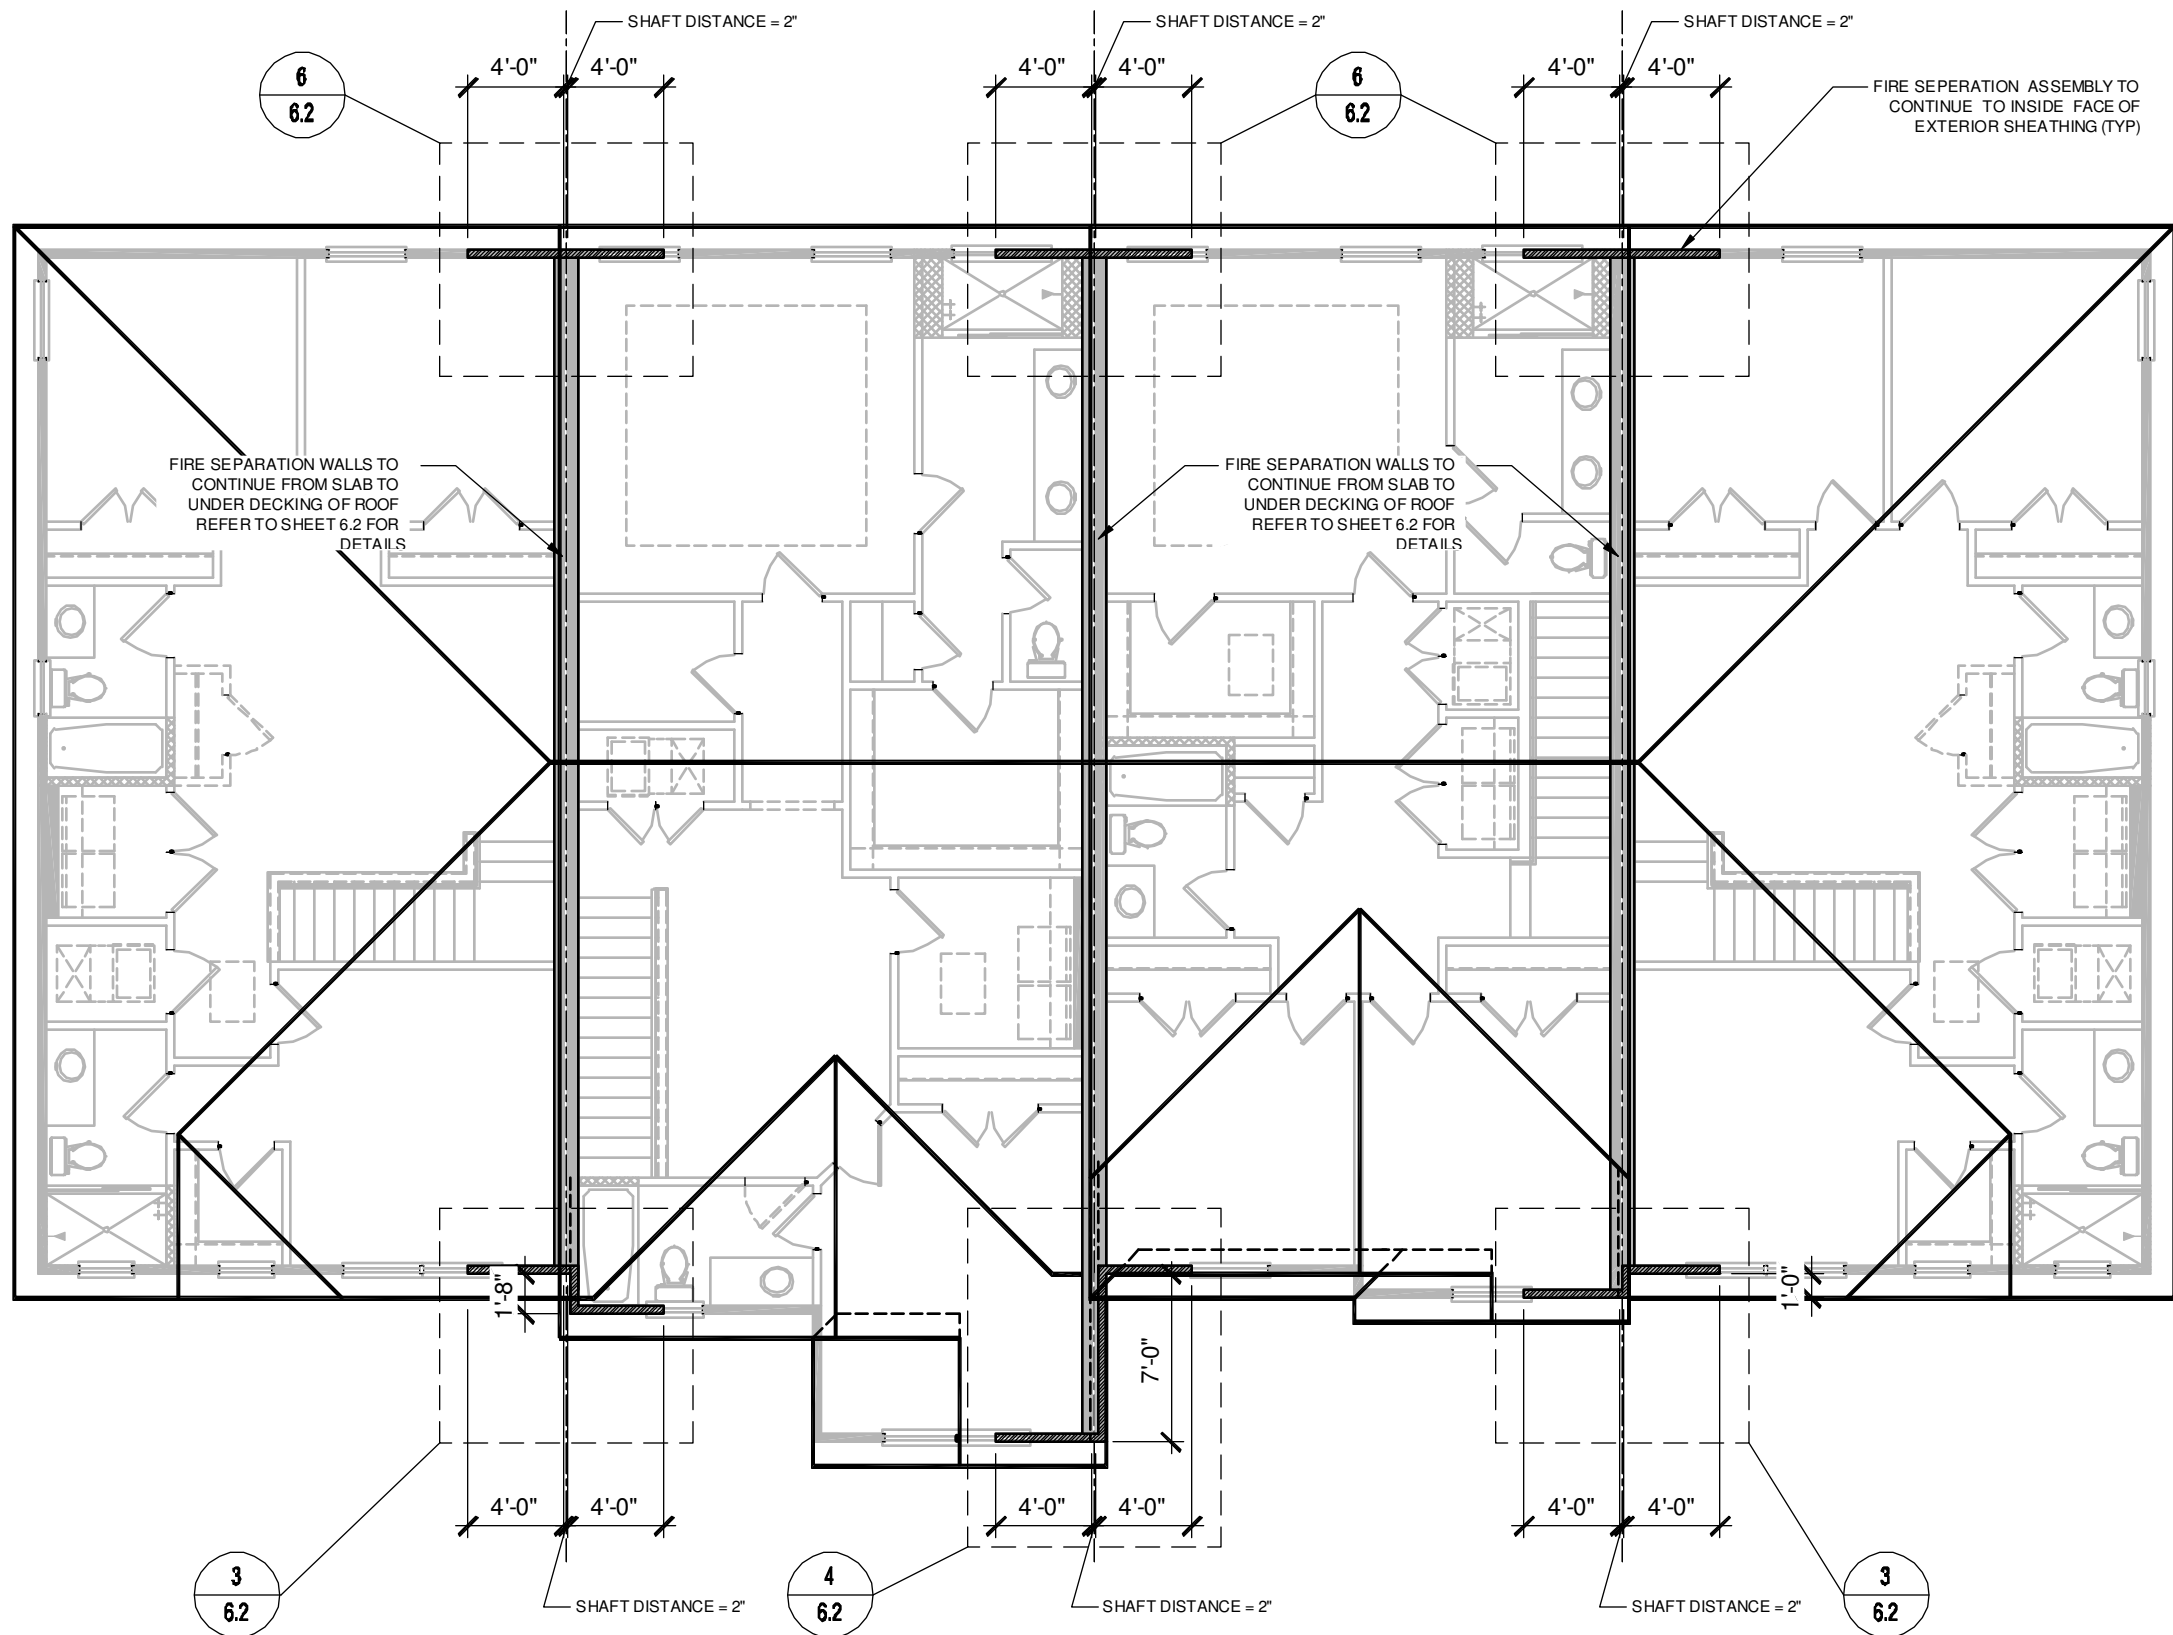


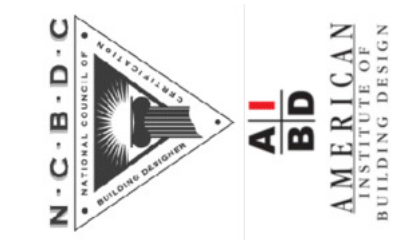ENGINEERING ASSOCIATES  
288 Southall Lane, Suite 200, Maitland, FL 32751  
www.fdseng.com  
Certificate of Authorization No. 9191  
CARLA A. BROWN, PE - FL # 58128  
SCOTT L. BROWN, PE - FL # 9191  
DATE: April 14, 2023  
TO THE BEST OF MY KNOWLEDGE AND BELIEF, THE INFORMATION CONTAINED HEREIN IS TRUE AND CORRECT AND I AM NOT PROVIDING ANY SERVICES OUTSIDE THE SCOPE OF MY LICENSE.

PARK SQUARE  
HORIZONS WEST  
BABCOCK RANCH BLDG 6 (LOTS 6092-6099) 4 UNIT

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1914  
ADAMS  
REVERSED  
LOT 6092

2024  
MADISON  
LOT 6091

1840  
JEFFERSON  
LOT 6090

1914  
ADAMS  
LOT 6089

ROOF - FIRE SEPERATION ELEV. "A"

1/8" = 1'-0"

title:  
4 UNIT - 2ND FLOOR  
FIRE SEPERATION

project no. 2023083  
checked: BF  
drawn: BA  
date: 04-12-23  
scale: AS SHOWN

5.1  
ELEV. A

PARK SQUARE  
HORIZONS WEST  
BABCOCK RANCH BLDG 6 (LOTS 6092-6089) 4 UNIT

FDS JOB NO.:



ENGINEERING ASSOCIATES, INC.  
289 Southall Lane, Suite 200, Maitland, FL 32751  
Phone: 407.829.8900  
Fax: 407.829.8901  
Scott A. Brown, PE - FL #58128  
Scott A. Brown, PE - FL #58128  
Scott A. Brown, PE - FL #58128  
DATE: April 14, 2023


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1914  
ADAMS  
REVERSED  
LOT 6092

2024  
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LOT 6091

1840  
JEFFERSON  
LOT 6090

1914  
ADAMS  
LOT 6089

ROOF - FIRE SEPERATION ELEV. "A"

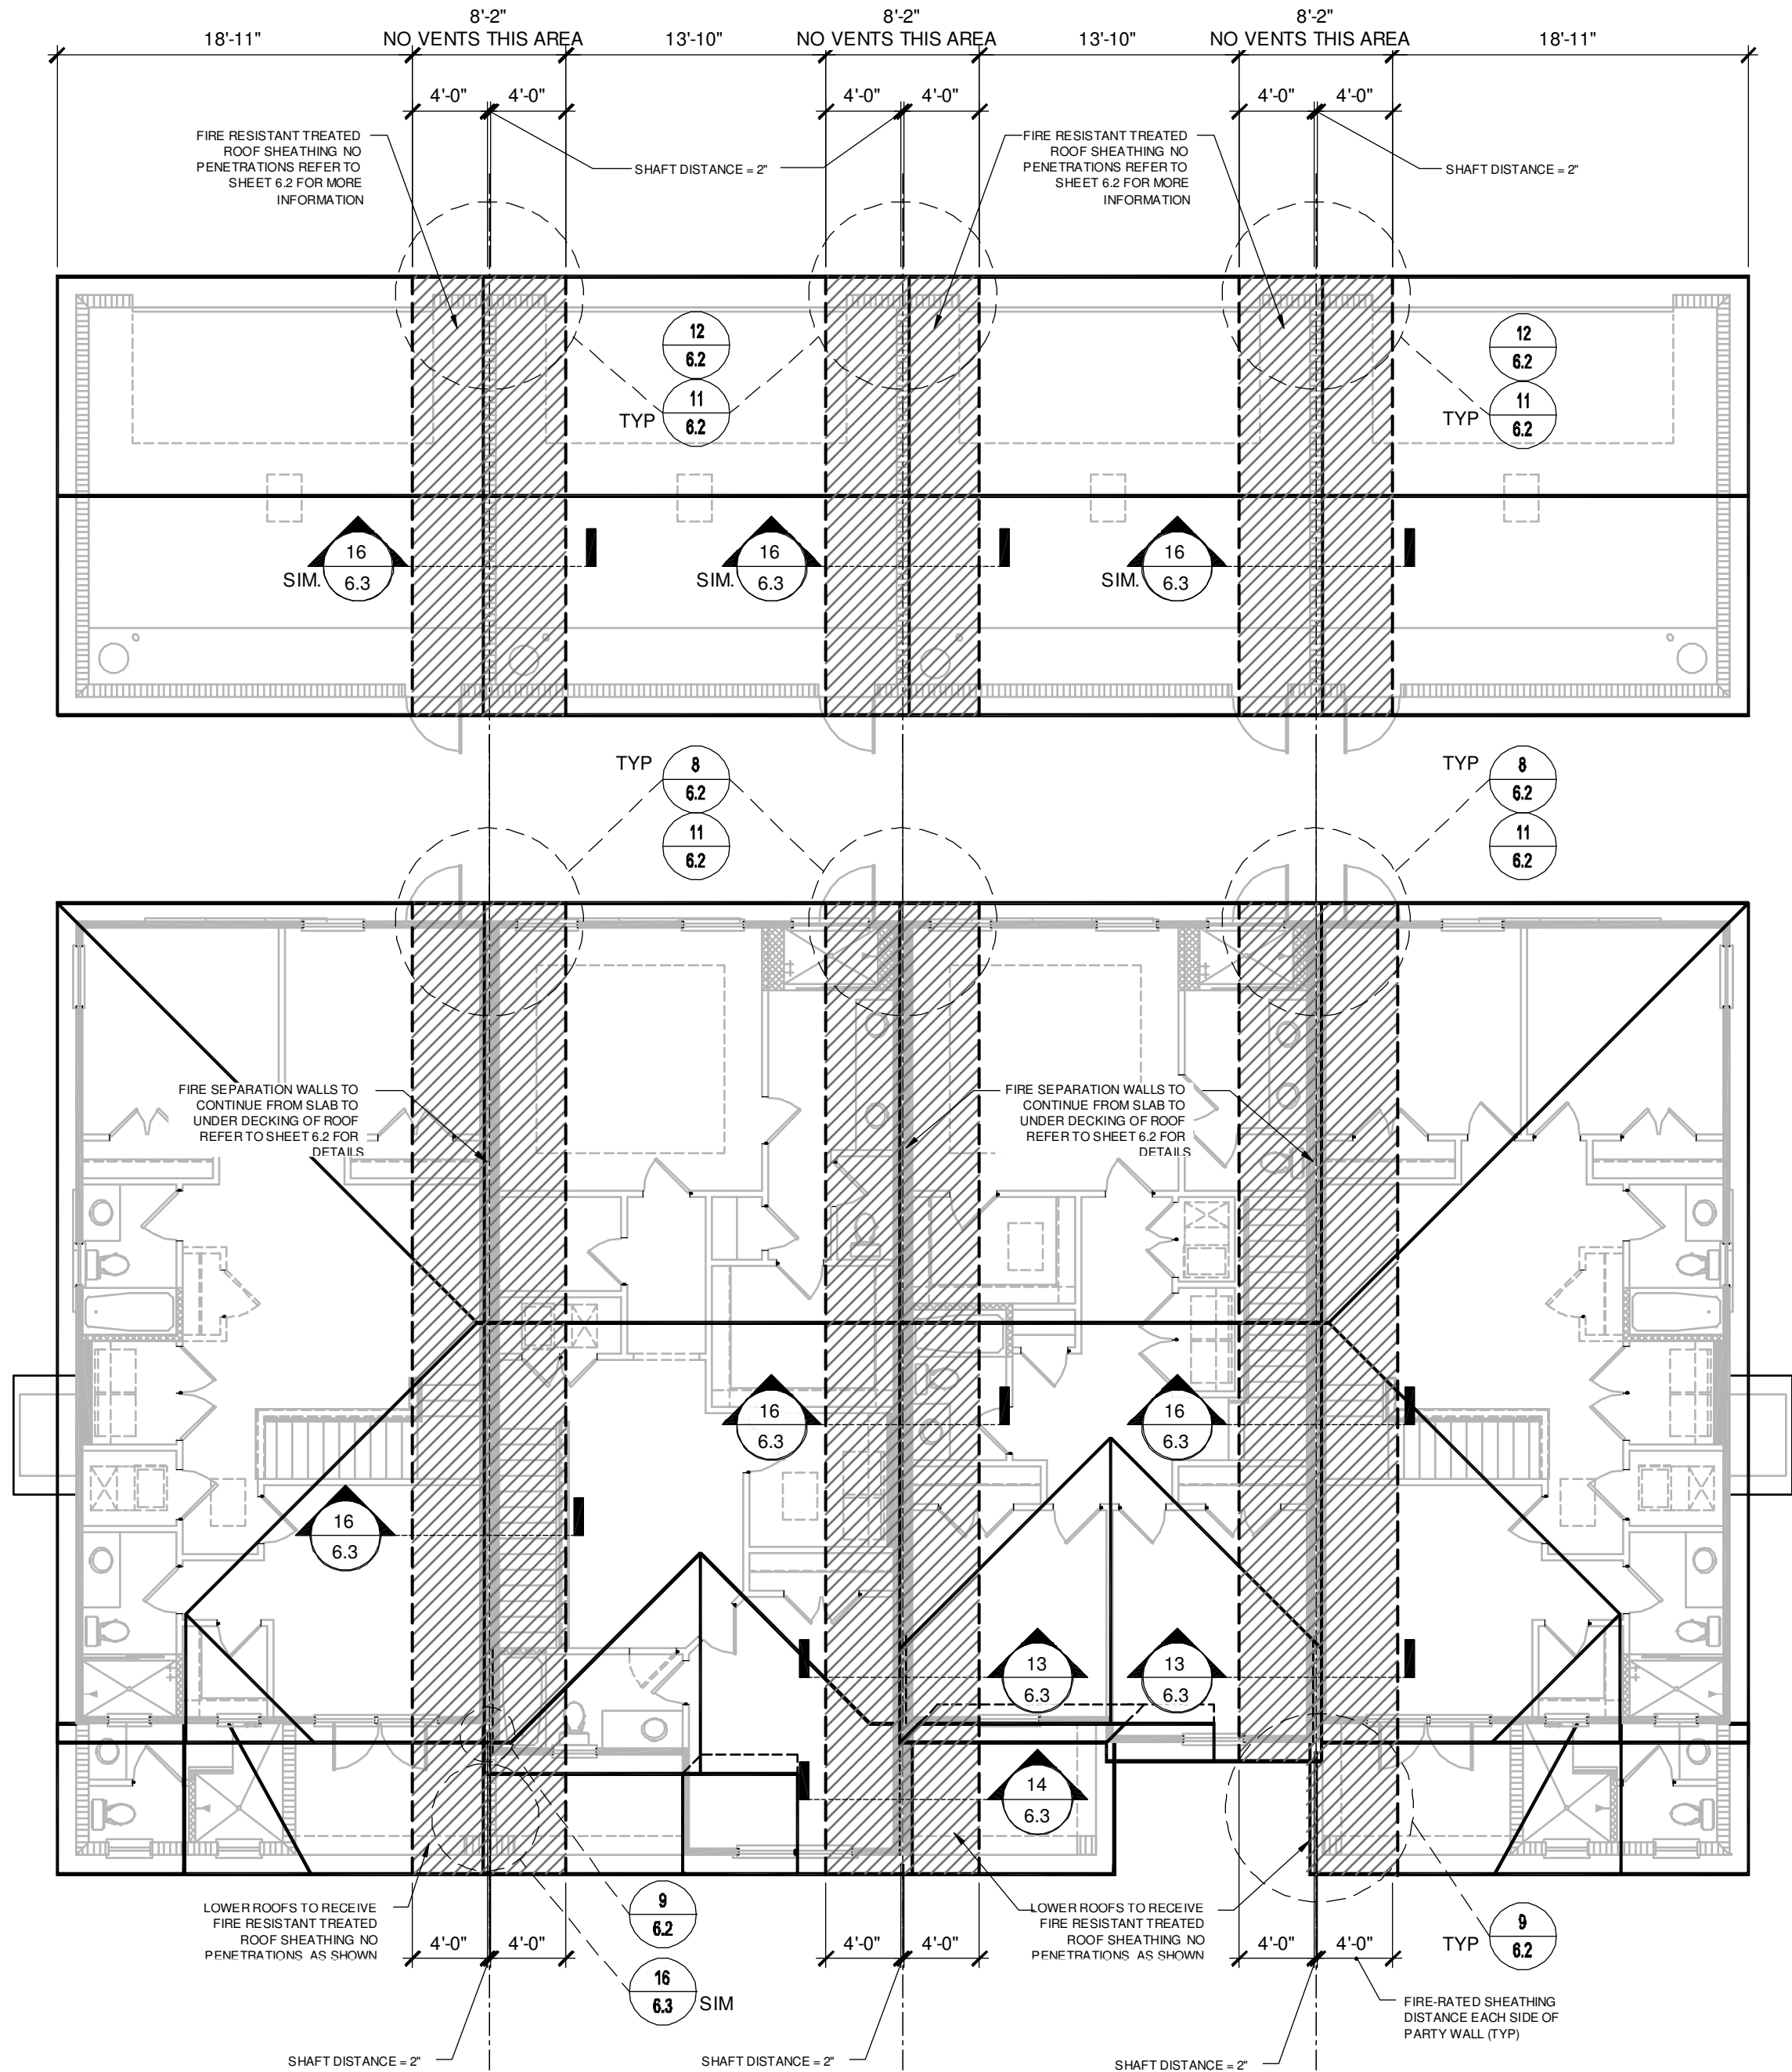1/8" = 1'-0"

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www.badesignstudios.com

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**AI**  
**BD**  
**AMERICAN**  
INSTITUTE OF  
BUILDING DESIGN

**FDS**  
ENGINEERING ASSOCIATES  
289 Southall Lane, Suite 200, Maitland, FL 32751  
Phone: 407.829.8900  
Fax: 407.829.2040  
Email: info@fdseng.com  
Scott A. Brown, PE, FL #58128  
Scott J. Brown, PE, FL #78750  
DATE: April 14, 2023  
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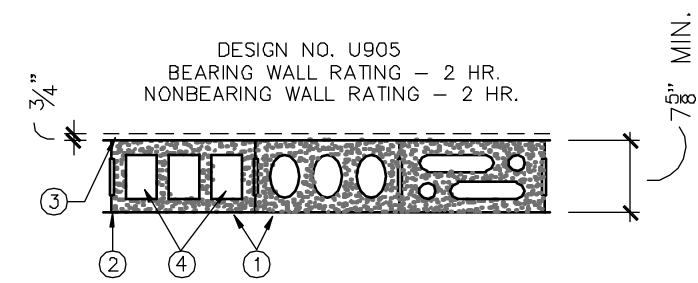
**PARK SQUARE  
HORIZONS WEST  
BABCOCK RANCH BLDG 6 (LOTS 6092-6089) 4 UNIT**

Title:  
**4 UNIT - ROOF  
FIRE SEPERATION**

project no. 2023083  
checked: BF  
drawn: BA  
date: 04-12-23  
scale: AS SHOWN

**6.1  
ELEV. A**

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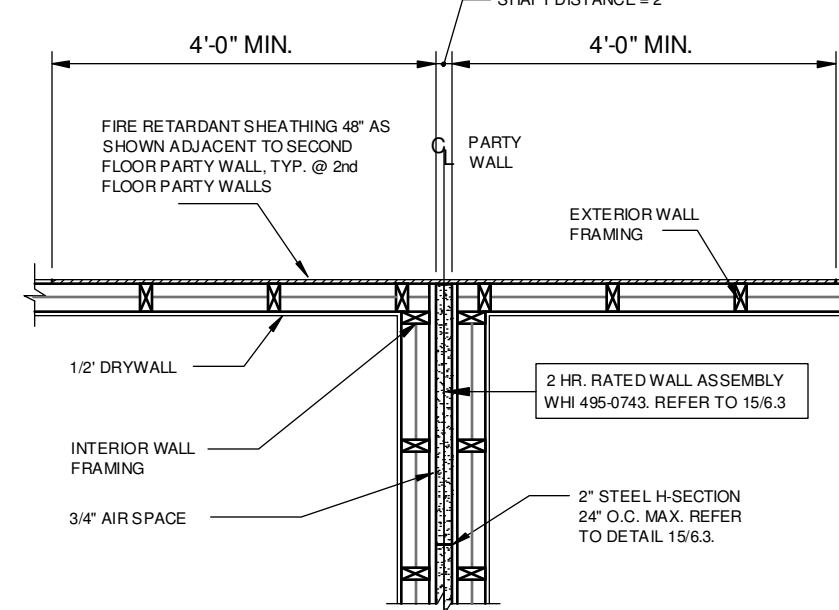


1. CONCRETE BLOCKS\* - VARIOUS DESIGNS. CLASSIFICATION D-2 (2 HR)
2. MORTAR - BLOCKS LAID IN FULL BED OF MORTAR, NOM. 3/8 IN. THICK, OF NOT LESS THAN 2-1/4 AND NOT MORE THAN 3-1/2 PARTS OF CLEAN SHARP SAND TO 1 PART PORTLAND CEMENT (PROPORTIONED BY VOLUME) AND NOT MORE THAN 50 PERCENT HYDRATED LIME (BY CEMENT VOLUME). VERTICAL JOINTS STAGGERED.
3. PORTLAND CEMENT STUCCO OR GYPSUM PLASTER - ADD 1/2 HR TO CLASSIFICATION IF USED. WHERE COMBUSTIBLE MEMBERS ARE FRAMED IN WALL, PLASTER OR STUCCO MUST BE APPLIED ON THE FACE OPPOSITE FRAMING TO ACHIEVE A MAX. CLASSIFICATION OF 1-1/2 HR. ATTACHED TO CONCRETE BLOCKS (ITEM 1).
4. LOOSE MASONRY FILL - IF ALL CORE SPACES ARE FILLED WITH LOOSE DRY EXPANDED SLAG, EXPANDED CLAY OR SHALE (ROTARY KILN PROCESS). WATER REPELLENT VERMICULITE MASONRY FILL INSULATION, OR SILICONE TREATED PERLITE LOOSE FILL INSULATION ADD 2 HR TO CLASSIFICATION.
5. FOAMED PLASTIC\* - (OPTIONAL NOT SHOWN) - 1-1/2 IN. THICK MAX. 4 FT WIDE SHEATHING ATTACHED TO CONCRETE BLOCKS (ITEM 1).

\* BEARING THE UL CLASSIFICATION MARK


## 2-HOUR SEPARATION WALL DETAIL

NTS




## 2 HR. FIRE WALL @ 2nd FLOOR FRAME TO FRAME

3/4"=1'-0"

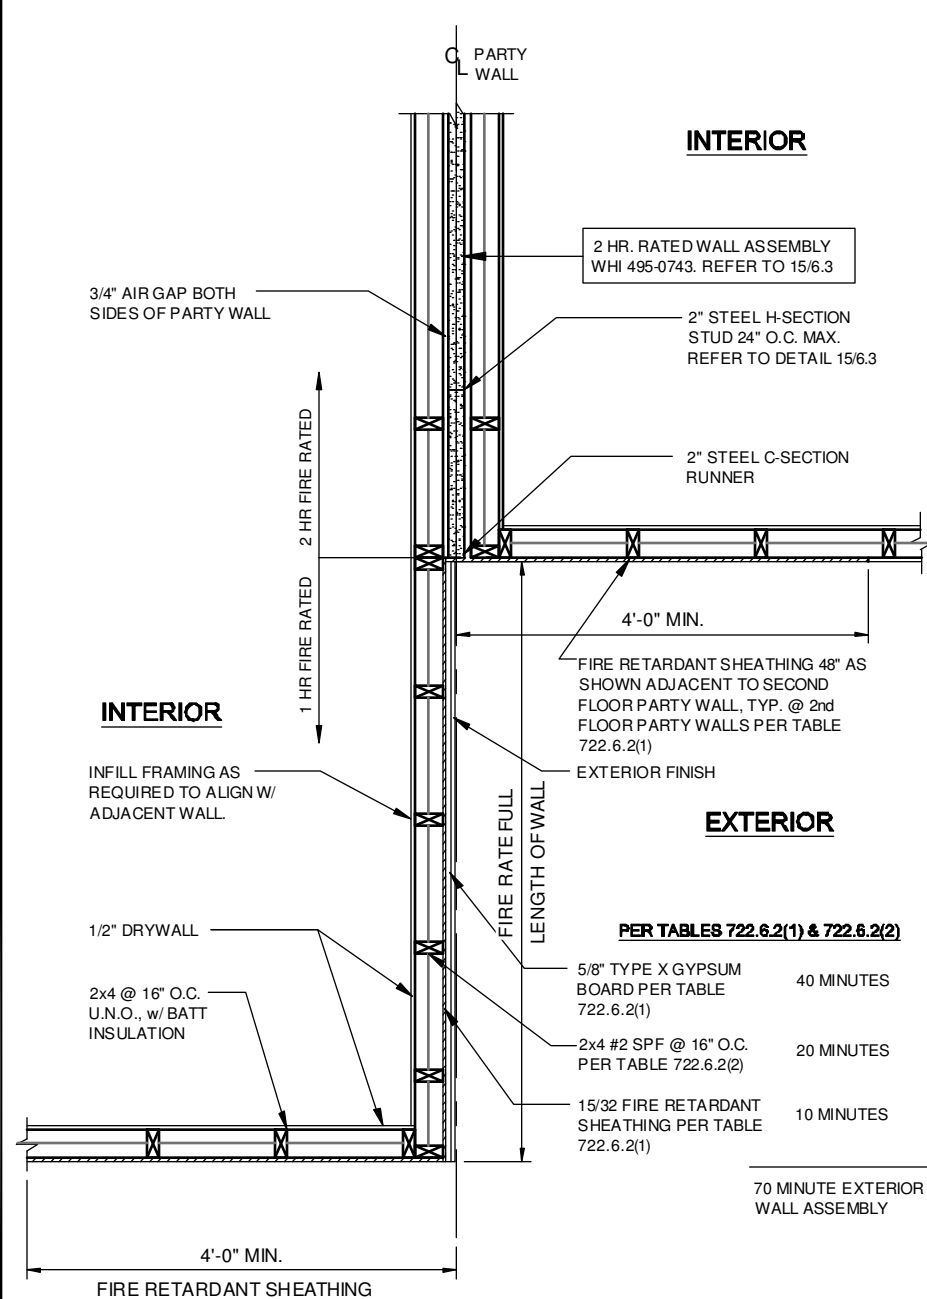


## 2 HR. TO 1HR. FIRE RATED WALL @ 2nd FLOOR OFFSET EXTERIOR WALL DETAIL

1/2"=1'-0"

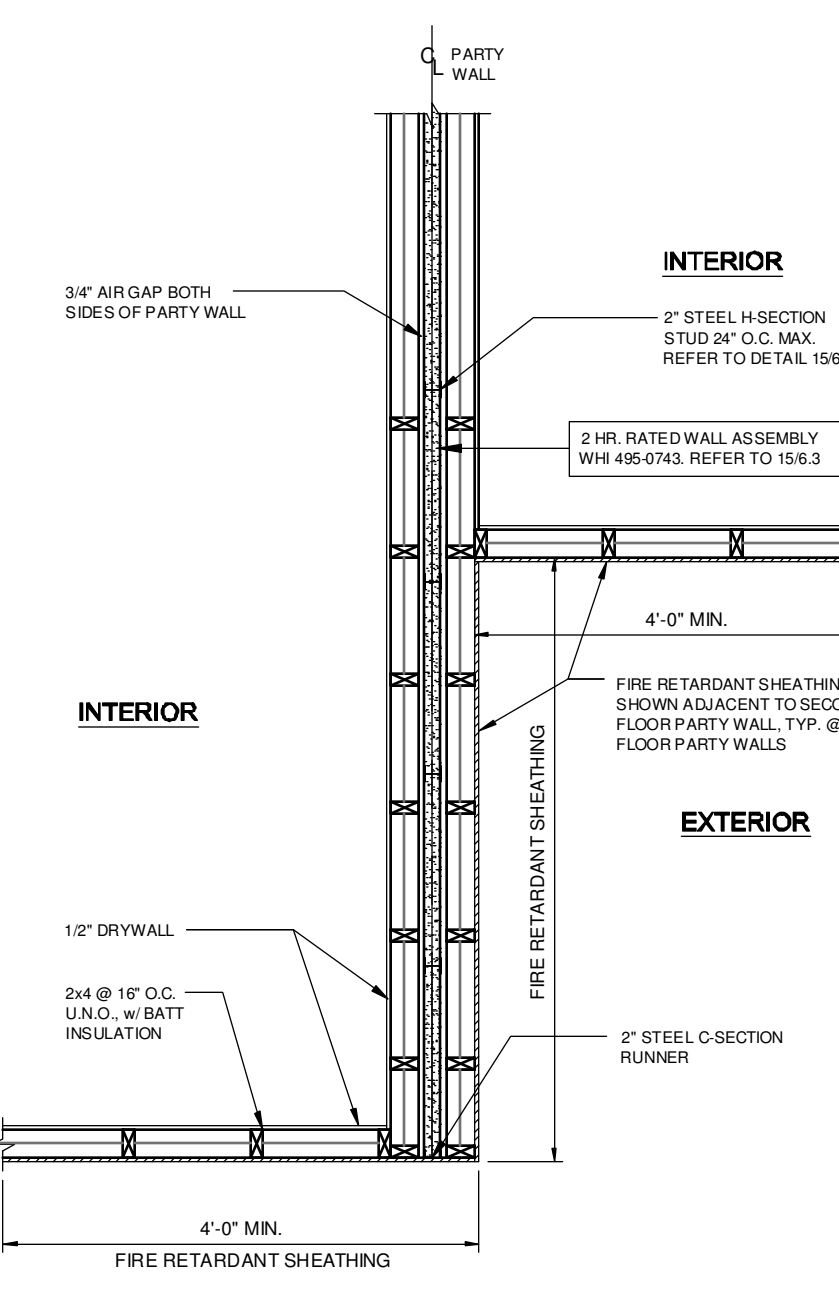


## 2 HR. FIRE RATED WALL @ 2nd FLOOR OFFSET EXTERIOR WALL DETAIL

1/2"=1'-0"

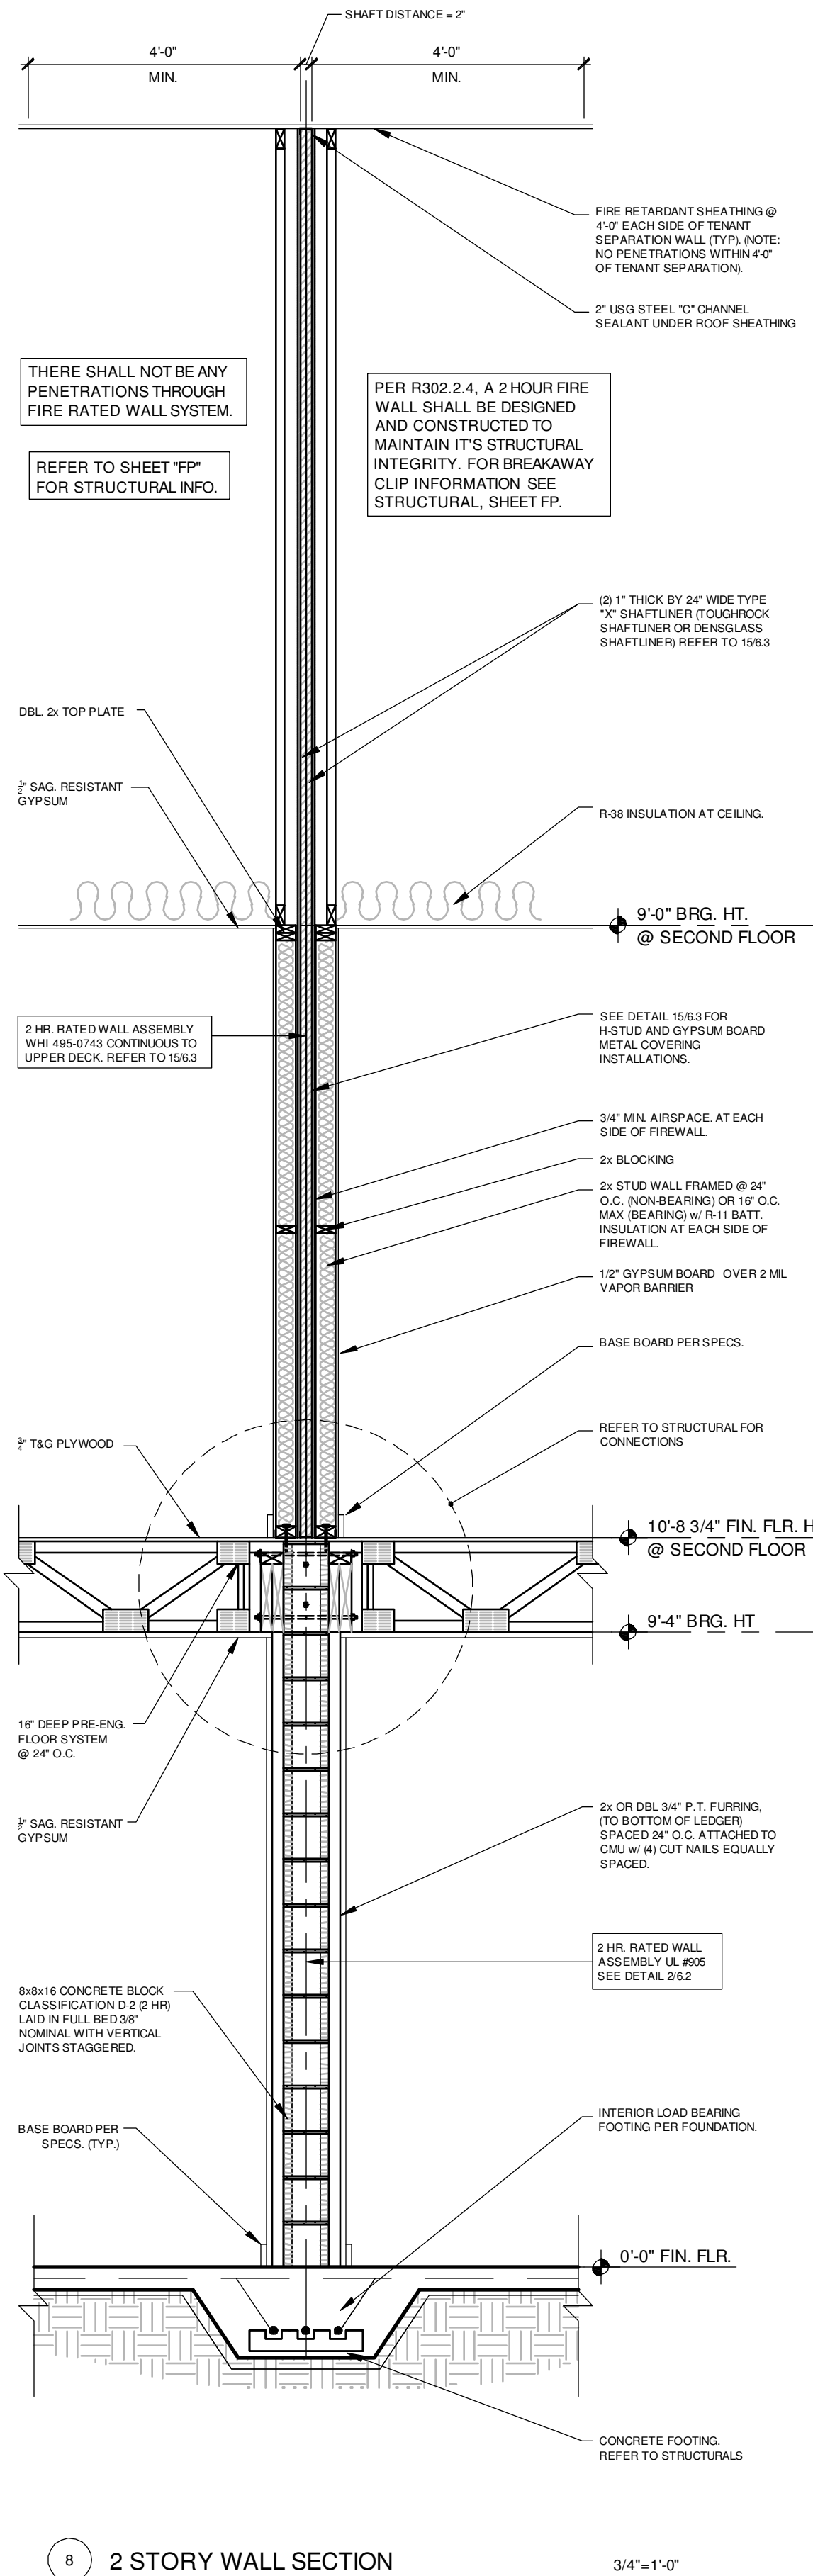


## 2 STORY WALL SECTION

3/4"=1'-0"

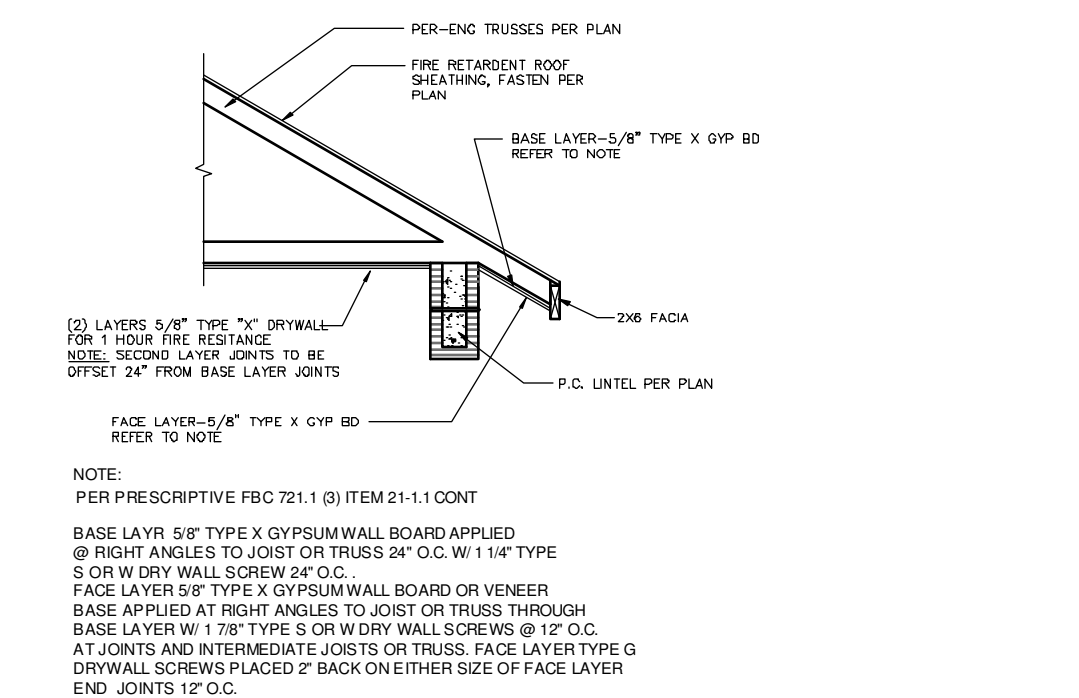


## 1-HR FIRE RATED CEILING DETAIL

3/4"=1'-0"

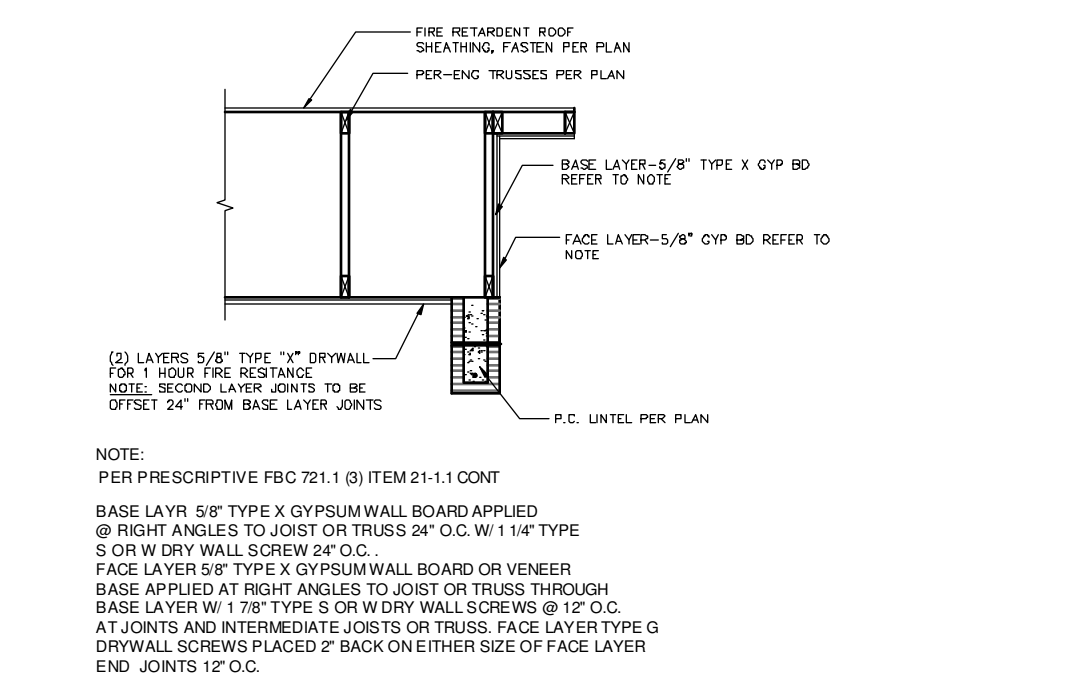

## 1-HR FIRE RATED @ GABLE CEILING DETAIL


3/4"=1'-0"

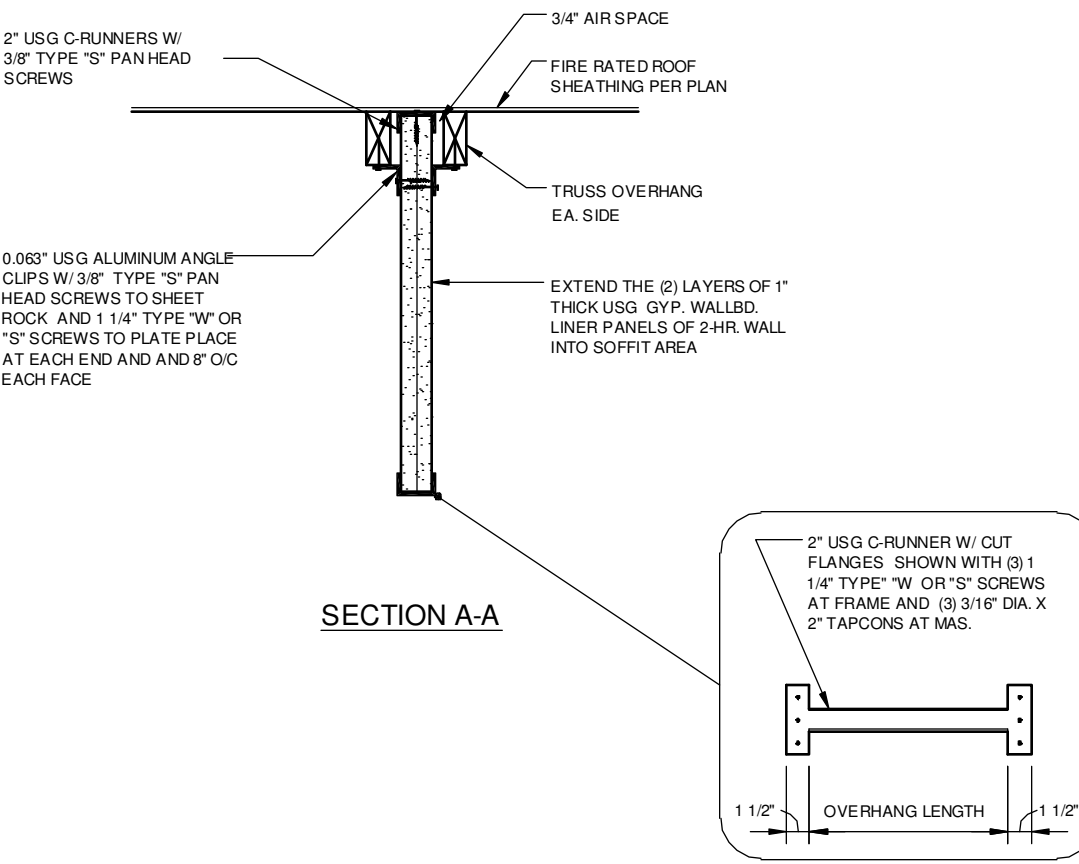

## SECTION A-A

## 2 HR. SEPARATION AT EAVE @ 2nd FLOOR - FRAME EXT. WALLS

3/4"=1'-0"

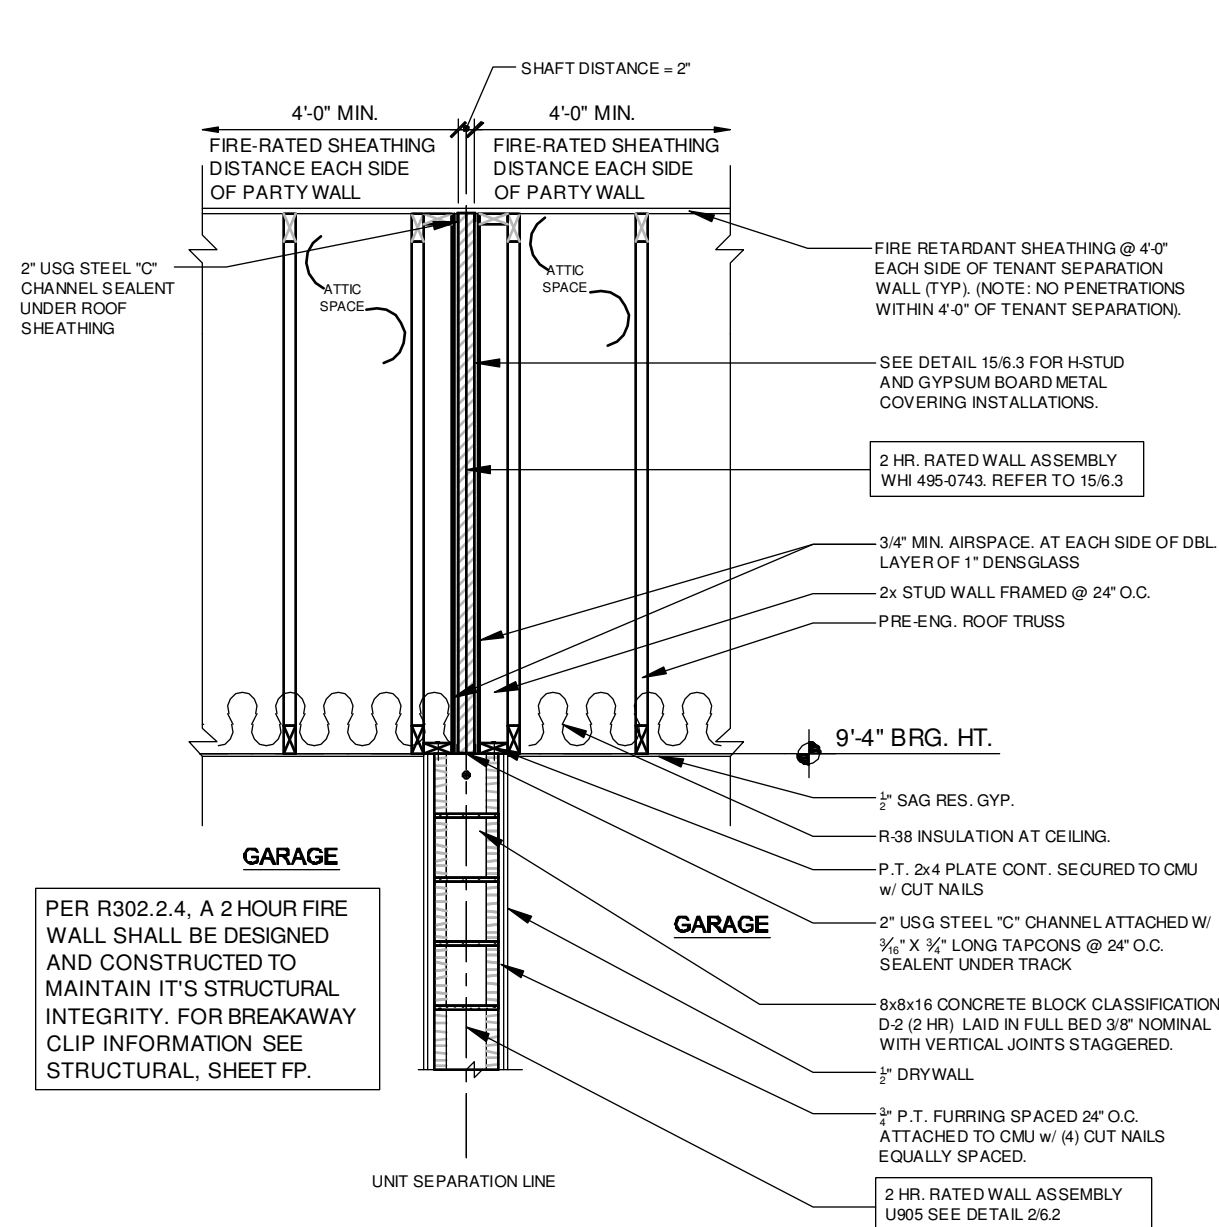

## 12 GARAGE SEPARATION FIREWALL

3/4"=1'-0"

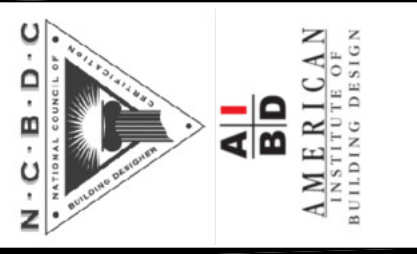
TABLE 722.6.2(1)		
DESCRIPTION OF FINISH	TIME(MINUTES)	
15/32-INCH WOOD STRUCTURAL PANEL BONDED WITH EXTERIOR GLUE	10	
5/8 INCH TYPE X GYPSUM WALLBOARD	40	

TABLE 722.6.2(2)		
DESCRIPTION	TIME(MINUTES)	
WOOD STUDS 16 INCHES O.C.	20	

TOTAL 70 MINUTE EXTERIOR WALL ASSEMBLY

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FDS JOB NO.:

**PARK SQUARE**  
**HORIZONS WEST**  
**BABCOCK RANCH BLDG 6 (LOTS 6092-6095) 4 UNIT**


title:  
**2-STORY FIRE SEPARATION**

project no. 2023083  
checked: BF  
drawn: BA  
date: 04-12-23  
scale: AS SHOWN

**6.2**

NOTE: DRAWINGS ON 11"x17" SHEET WILL BE ONE HALF THE SCALE NOTED


The structural design of this building is in accordance with the FLORIDA BUILDING CODE 7TH EDITION (2020) RESIDENTIAL and is certified as such.

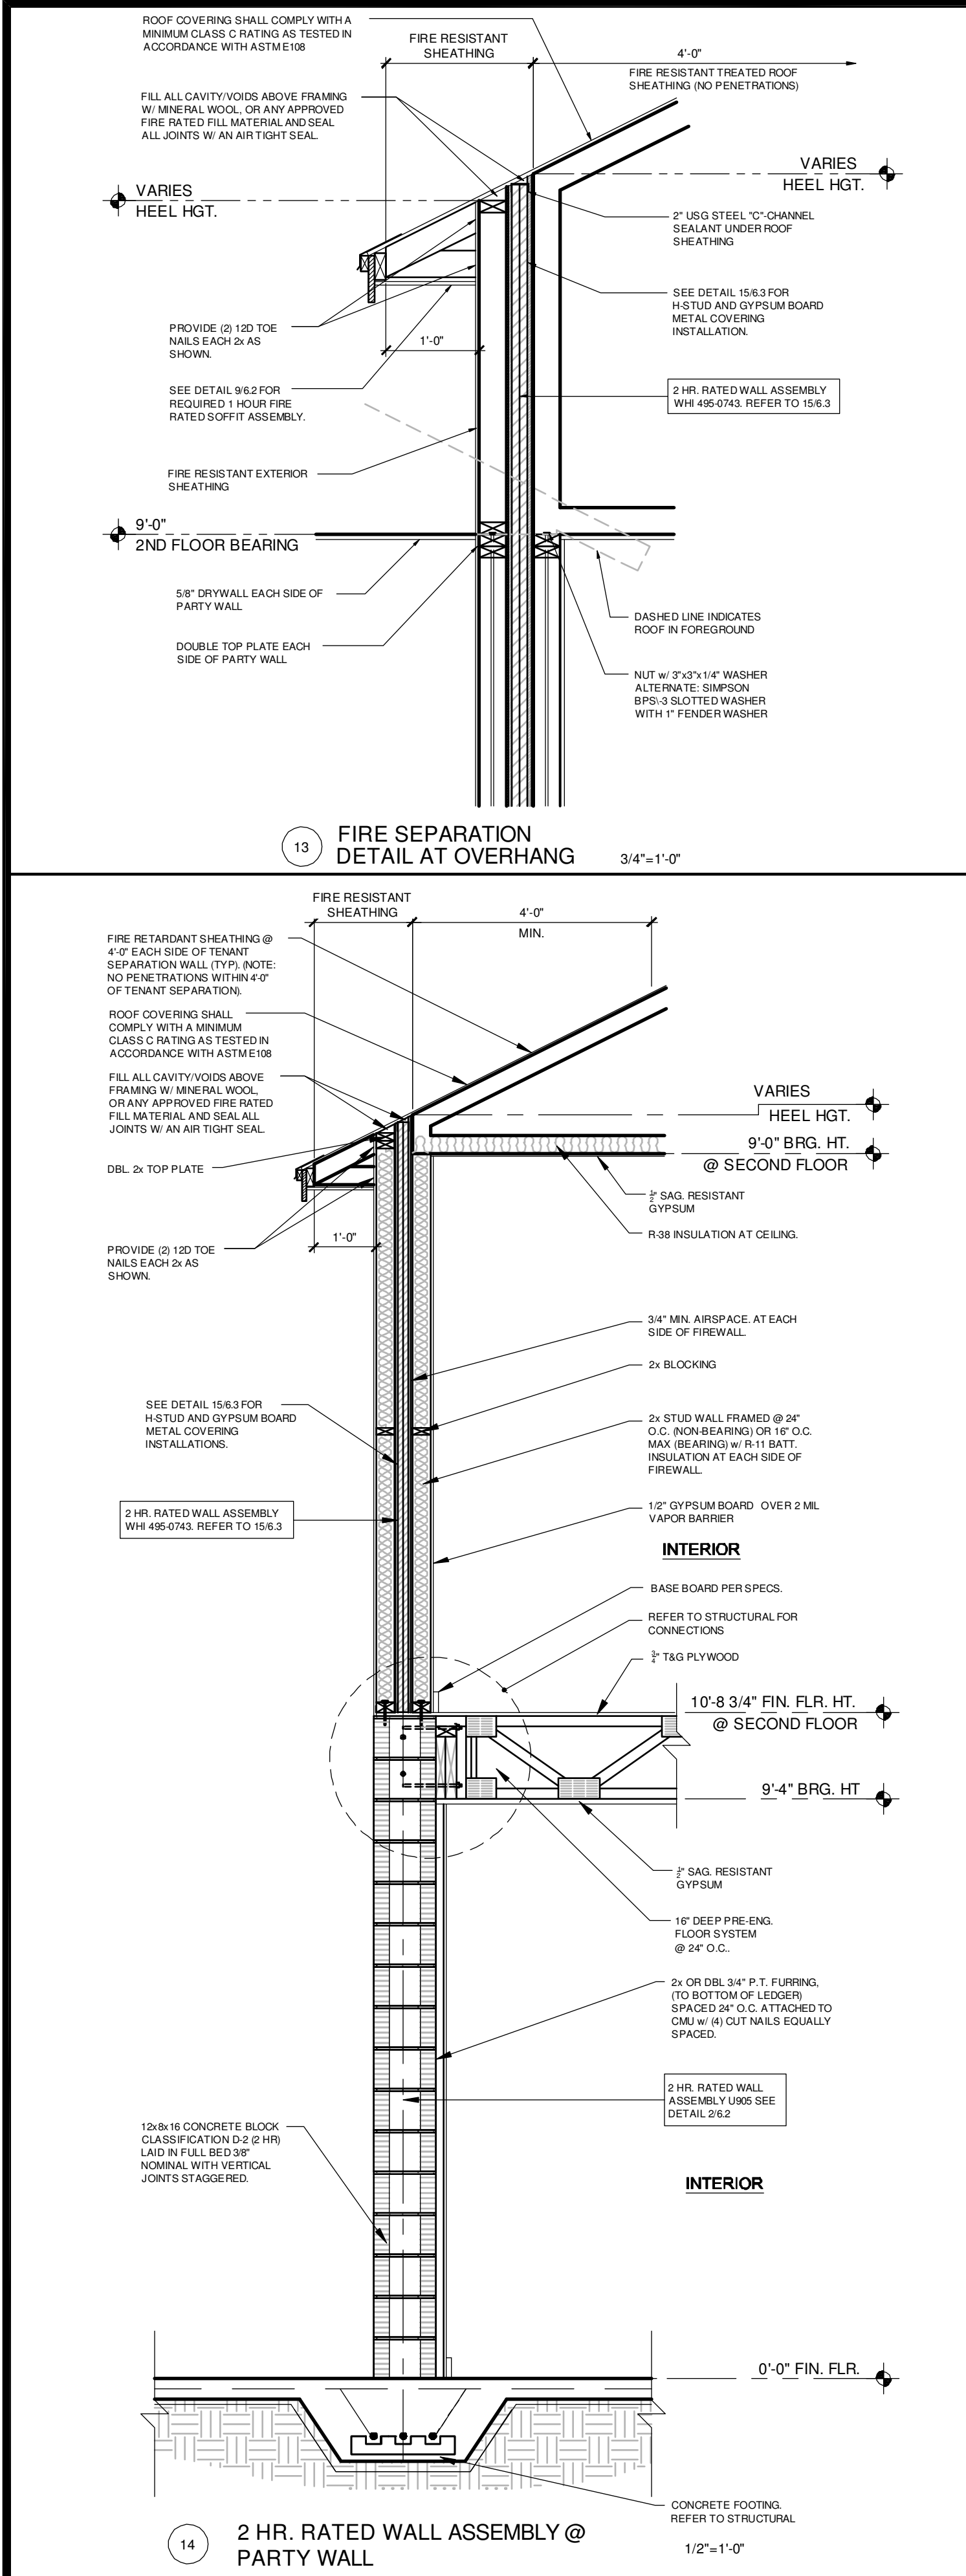

intertek  
Total Quality Assured.  
Assemblies


Division 09 – Finishes  
09 21 00 Plaster and Gypsum Board Assemblies  
09 21 16.33 Gypsum Board Area Separation Wall

Georgia-Pacific Gypsum, LLC  
Design No. GP/WA 120-05  
Non-Bearing Wall Assembly  
Area Separation Wall  
ASTM E119  
Rating: 2 hours

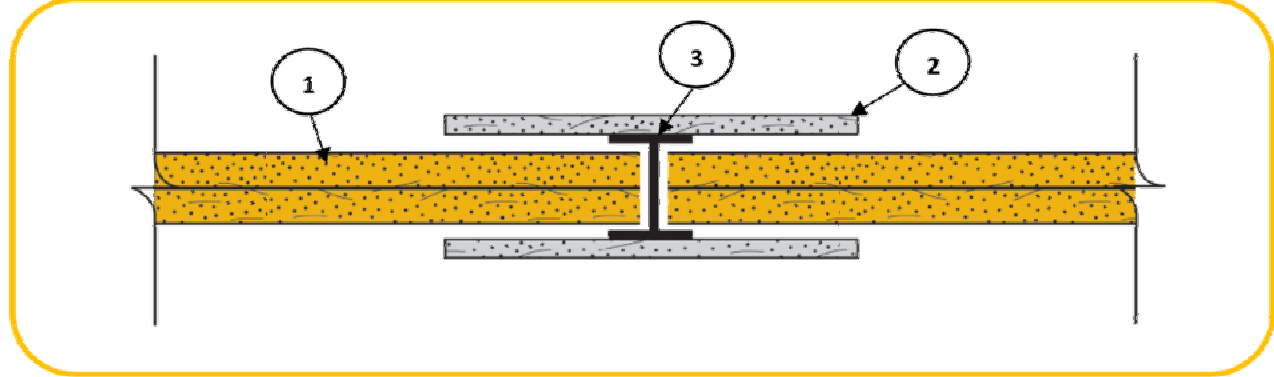

1. **CERTIFIED MANUFACTURER:** Georgia-Pacific Gypsum, LLC
- CERTIFIED PRODUCT:** Gypsum Shaftliner
- CERTIFIED MODEL:** ToughRock Shaftliner or DensGlass Shaftliner
- Gypsum Shaftliner:** Two layers 1-in. (25.4 mm) ToughRock Shaftliner or DensGlass Shaftliner inserted in H-Studs 24-in. (610 mm) o.c.
2. **Gypsum Board:** Metal covered using 6-in. (152 mm) wide 1/2-in. (12.7 mm) DensArmor Plus Fireguard C Interior Panels or 1/2-in. (12.7 mm) ToughRock Fireguard C gypsum board.
3. **Steel Studs:** 1/2-in. (12.7 mm) wide 1/2-in. (12.7 mm) deep, roll-formed from minimum 0.018-in. thick galvanized steel, cut to length 1/2-in. less than the openings height and spaced a maximum of 24-in. (610 mm) o.c.


Date Issued: June 5, 2019 Page 1 of 1 Project No. WHI-495-0743  
Version: 02 August 2017 SFT-BC-OP-151

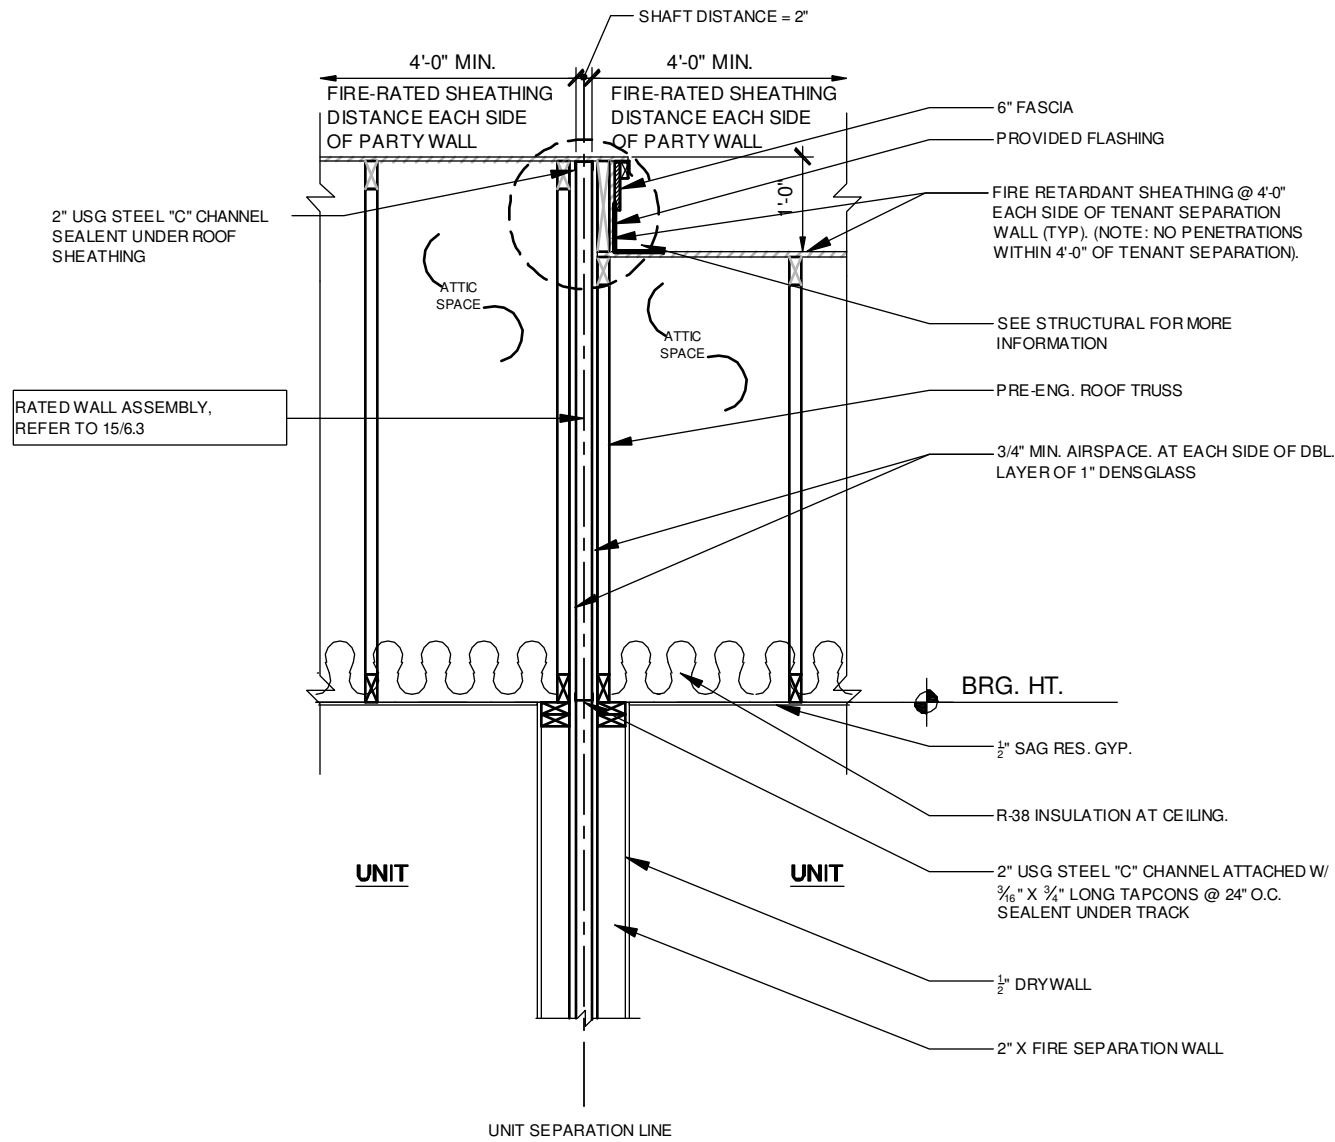

WARNOCK HERSEY INTERNATIONAL INC. WHI-495-0743/0744 PAGE 18 OF 40


FIGURE #1  
"H" STUD AND "U" TRACK

ALL MATERIAL ROLL-FORMED FROM HOT-DIPPED, GALVANIZED STEEL, 0.016" THICK AND DIMENSIONED AS SHOWN.

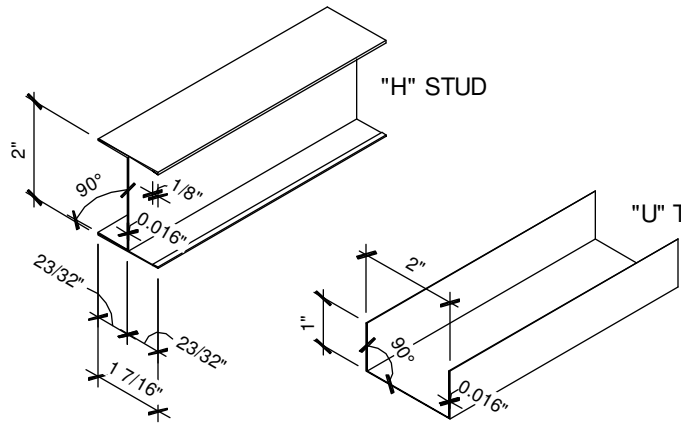


WARNOCK HERSEY INTERNATIONAL INC. WHI-495-0743/0744 PAGE 21 OF 40

FIGURE #4  
TOP OR BOTTOM DETAIL BETWEEN STUDS OR END DETAIL

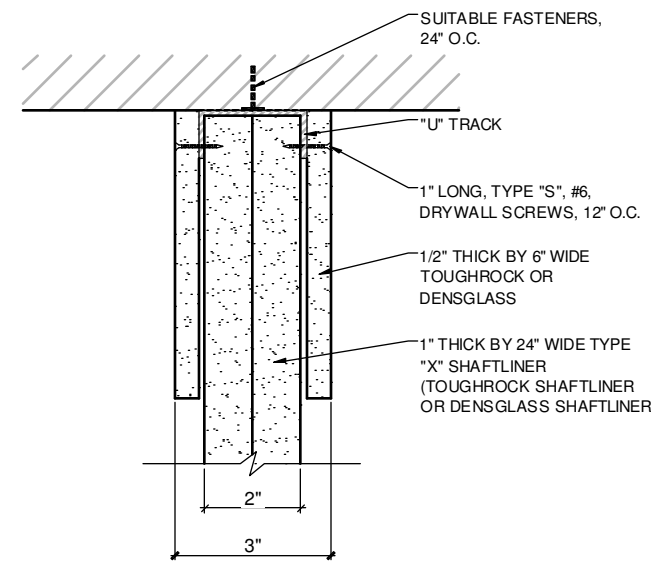


WARNOCK HERSEY INTERNATIONAL INC. WHI-495-0743/0744 PAGE 19 OF 40

FIGURE #2  
ELEVATION - SCREW LOCATIONS

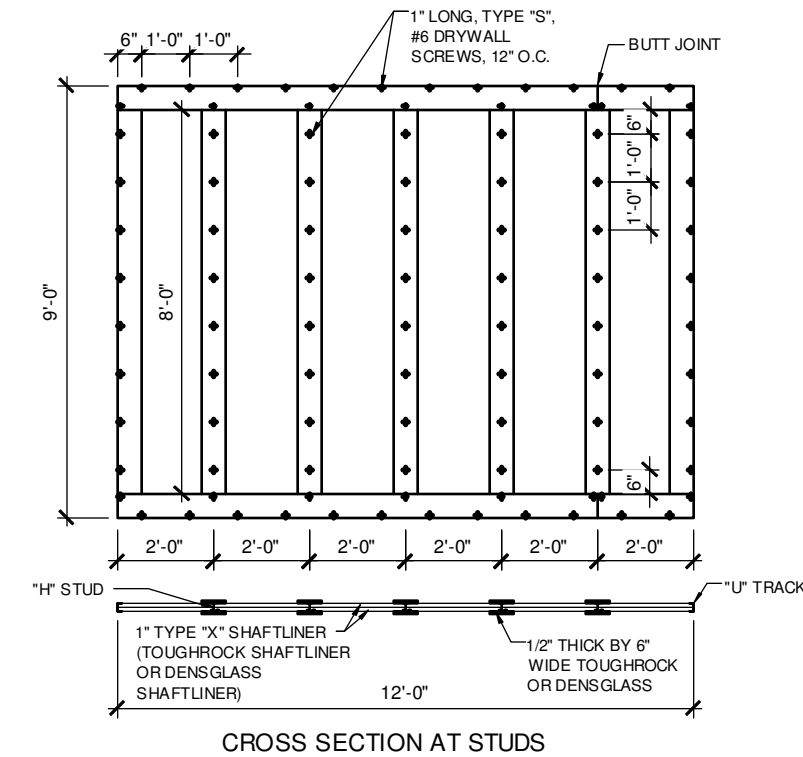


WARNOCK HERSEY INTERNATIONAL INC. WHI-495-0743/0744 PAGE 22 OF 40

FIGURE #5  
TOP OR BOTTOM DETAIL AT STUDS

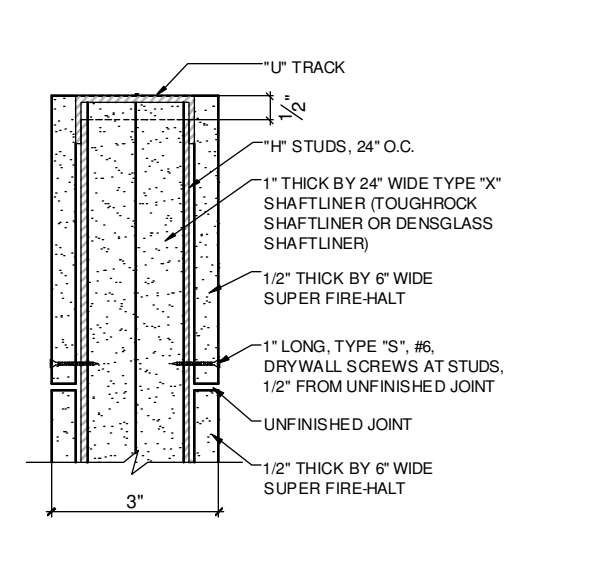

WARNOCK HERSEY INTERNATIONAL INC. WHI-495-0743/0744 PAGE 20 OF 40

FIGURE #3  
CROSS SECTION DETAIL AT STUD

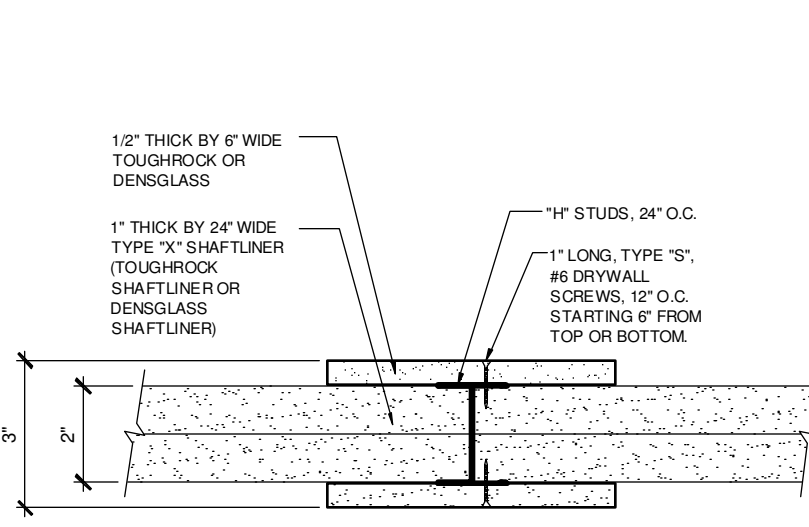

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**A.I.**  
**AMERICAN INSTITUTE OF BUILDING DESIGN**

**FDS**  
ENGINEERING ASSOCIATES  
288 Southall Lane, Suite 200, Midland, TX 79701  
P.O. Box 1000, Midland, TX 79701  
Certificate of Authorization No. 8781  
□ CARL A. BROWN, PE - FL #5028  
□ SCOTT LEWIS, PE - FL #78750  
DATE: April 14, 2023  
BY: [Signature]  
I, the Engineer, certify that I am a duly Licensed Professional Engineer in the State of Florida and I am not providing my services under the name of another engineer.

WWW.FDSENGINEERING.COM

FDS JOB NO.:

**PARK SQUARE  
HORIZONS WEST  
BARBECOCK RANCH BLDG 6 (LOTS 6092-6099) 4 UNIT**

Title:  
**2-STORY  
FIRE SEPERATION**


project no. 2023083  
checked:  
drawn: BA  
date: 04-12-23  
scale: AS SHOWN

**6.3**

project no. 2023083  
checked:  
drawn: BA  
date: 04-12-23  
scale: AS SHOWN

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INTERIOR DOOR ROUGH OPENING SIZING CHART					
DOOR TYPE	DOOR CALL SIZE ON PRINT	ROUGH OPENING WIDTH DETERMINED BY	ROUGH OPENING HEIGHT DETERMINED BY	6'-0" DOOR R.O. HEIGHT	8'-0" DOOR R.O. HEIGHT
SINGLE DOOR	WIDTH x 6'-8" OR WIDTH x 8'-0"	ADDING 2 INCHES TO THE WIDTH OF THE CALL SIZE	ADDING 2 1/2" INCHES TO THE HEIGHT OF THE CALL SIZE	82-1/2"	98-1/2"
DOUBLE BI-PASS	WIDTH x 6'-8" OR WIDTH x 8'-0"	WIDTH EQUALS THE CALL SIZE WIDTH	ADDING 3 INCHES TO THE HEIGHT OF THE CALL SIZE	83"	99"
DOUBLE BALL CATCH	WIDTH x 6'-8" OR WIDTH x 8'-0"	ADDING 2 1/2 INCHES TO THE WIDTH OF THE CALL SIZE	ADDING 2 1/2 INCHES TO THE HEIGHT OF THE CALL SIZE	82-1/2"	98-1/2"
DOUBLE WITH T-ASTRAGAL	WIDTH x 6'-8" OR WIDTH x 8'-0"	ADDING 3 INCHES TO THE WIDTH OF THE CALL SIZE	ADDING 2 1/2 INCHES TO THE HEIGHT OF THE CALL SIZE	82-1/2"	98-1/2"

ADD 2"

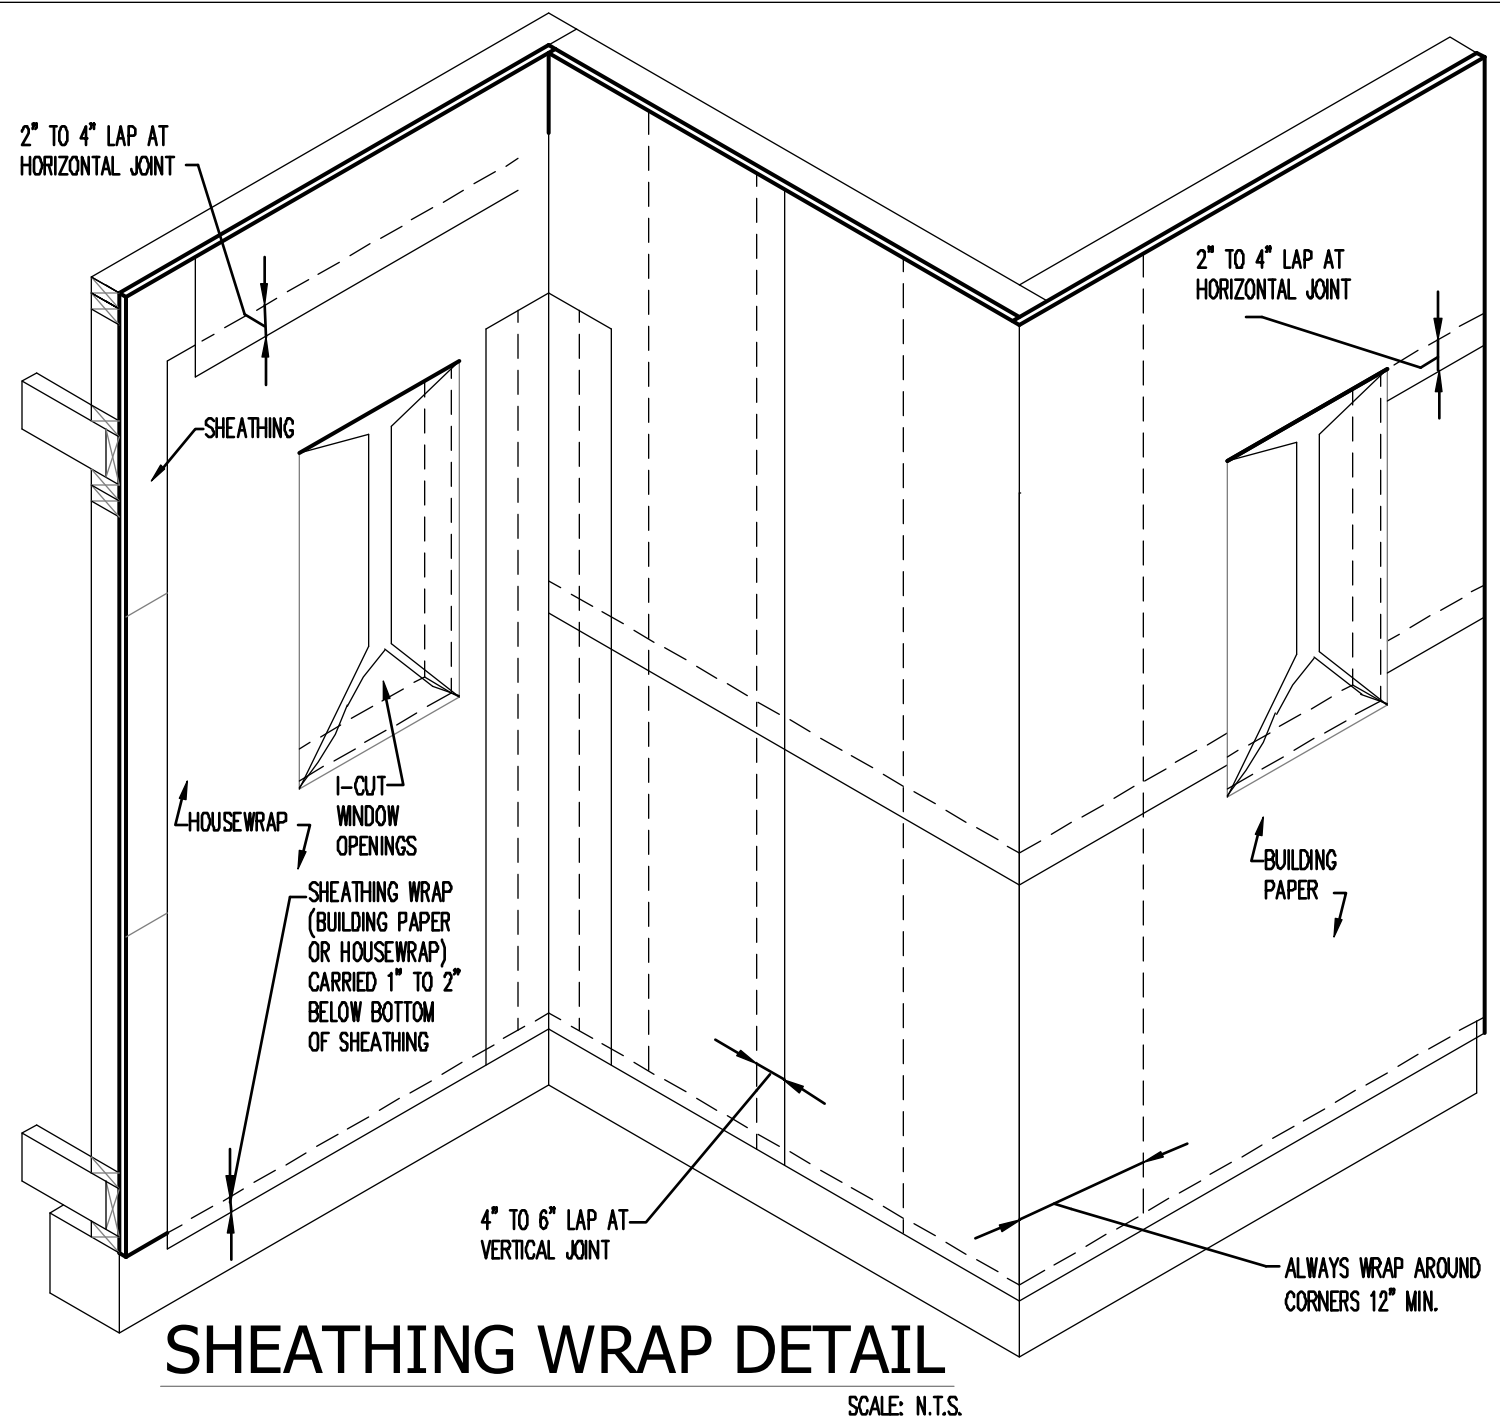SINGLE

ADD 2 1/2"

DOUBLE BI-PASS



ADD 2 1/2"

DOUBLE BALL CATCH


ADD 3"

DOUBLE W/ T-ASTRAGAL

INTERIOR DOOR ROUGH-OPENING SIZING CHART

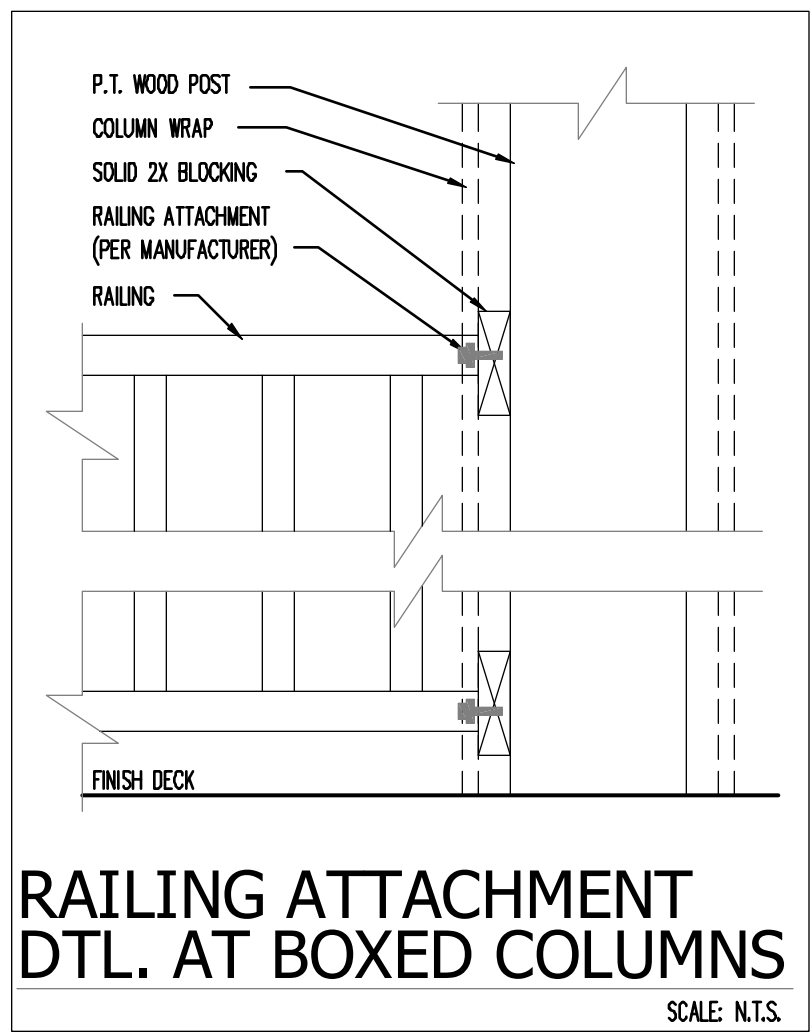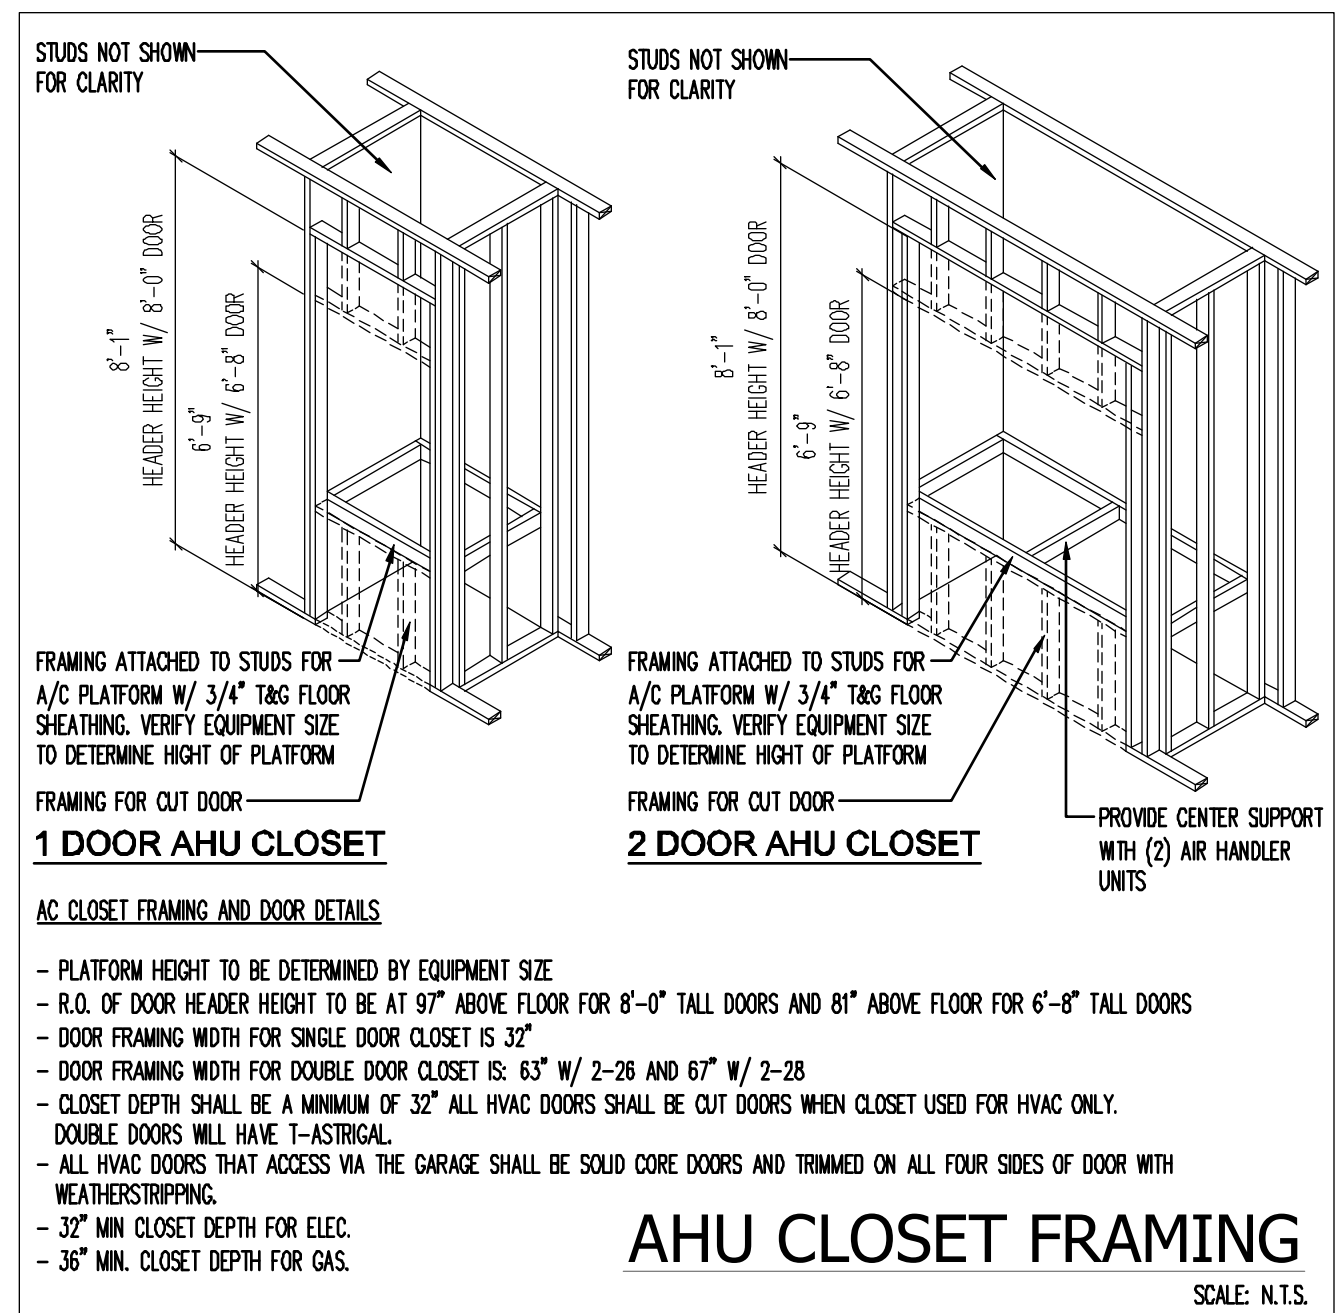


RAILING ATTACHMENT DTL. AT BOXED COLUMNS

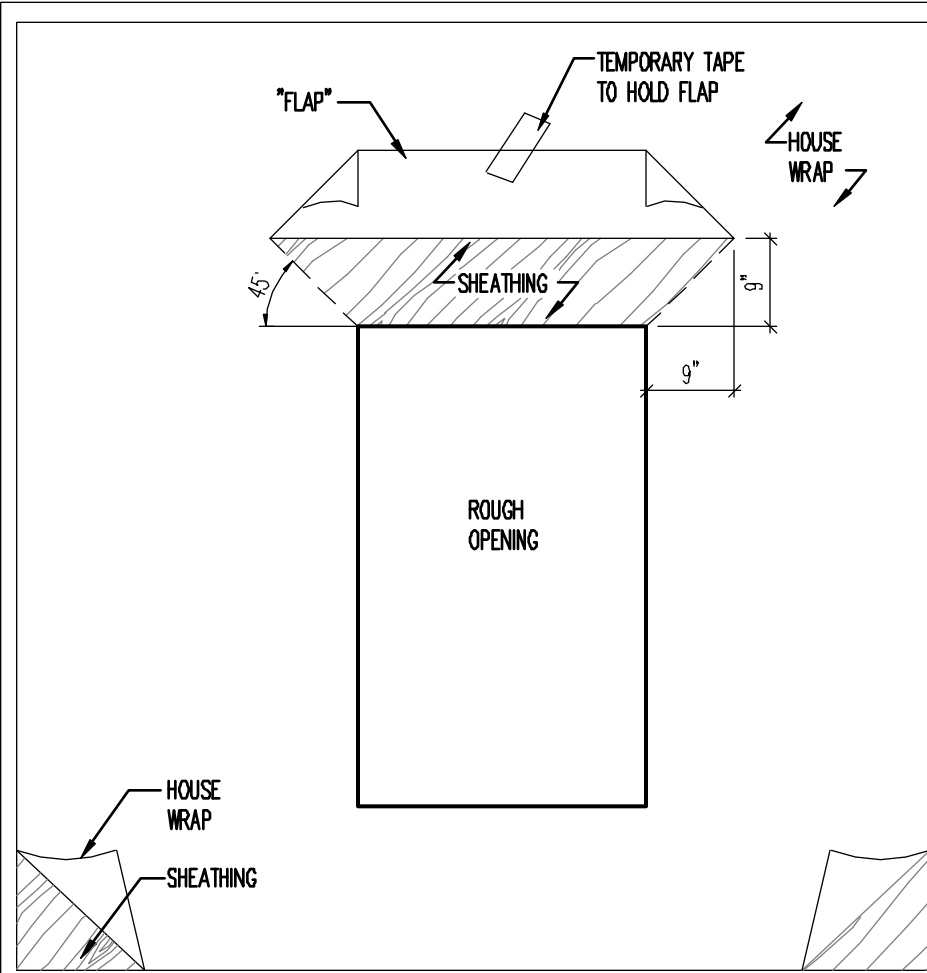


WINDOW FLASHING METHOD "A-1"

1 A. A WINDOW INSTALLER WILL CUT THE BUILDING PAPER AT A 45° ANGLE TO A POINT 9" UP AND 9" OUT FROM THE UPPER CORNERS OF THE ROUGH OPENING.  
B. THIS WILL MAKE A "FLAP" THAT WILL BE USED TO COVER THE HEAD FLASHING IN STEP 6.

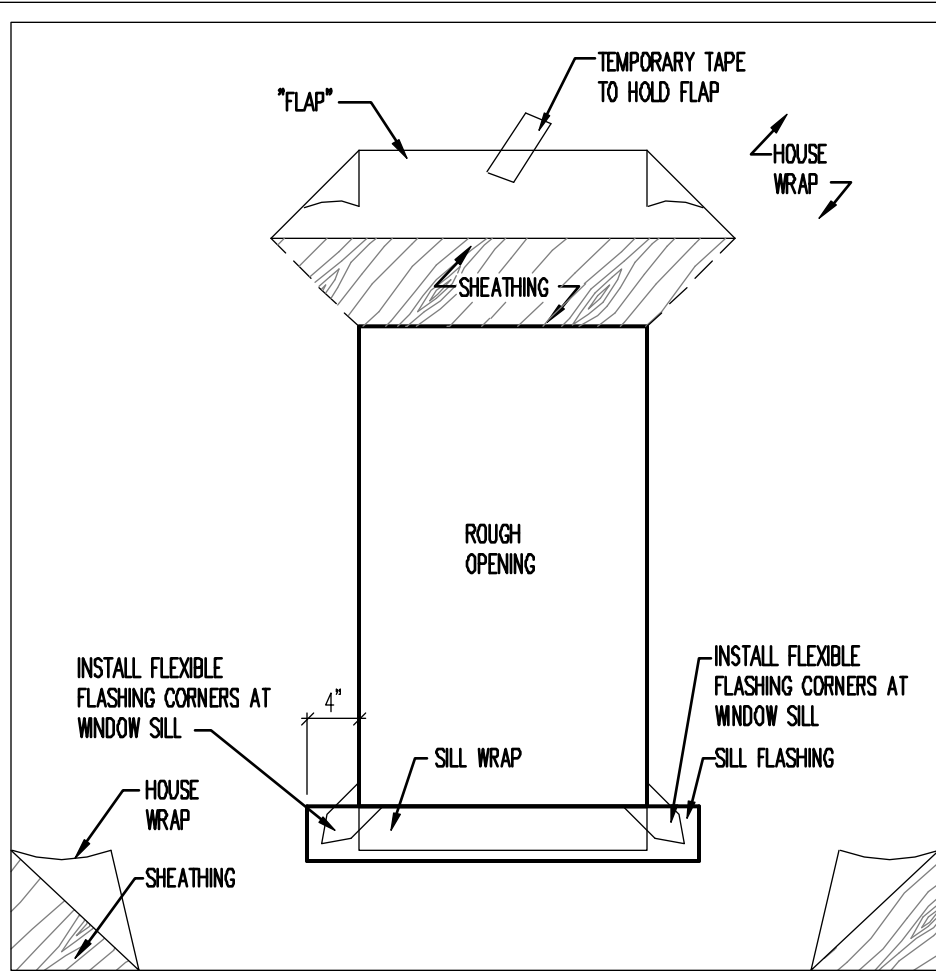


WINDOW FLASHING METHOD "A-1"

2 3-STEP PROCESS:  
A. INSTALL SILL FLASHING (EXTENDING 4" BEYOND THE ROUGH OPENING ON EACH SIDE)  
B. INSTALL CORNER SHIELD FLASHINGS (FASTEN WITH MOSTOP SEALANT OR EQUAL)  
C. INSTALL SILL WRAP (MUST COMPLETELY COVER ROUGH OPENING SILL (INCLUDING CORNER SHIELDS))

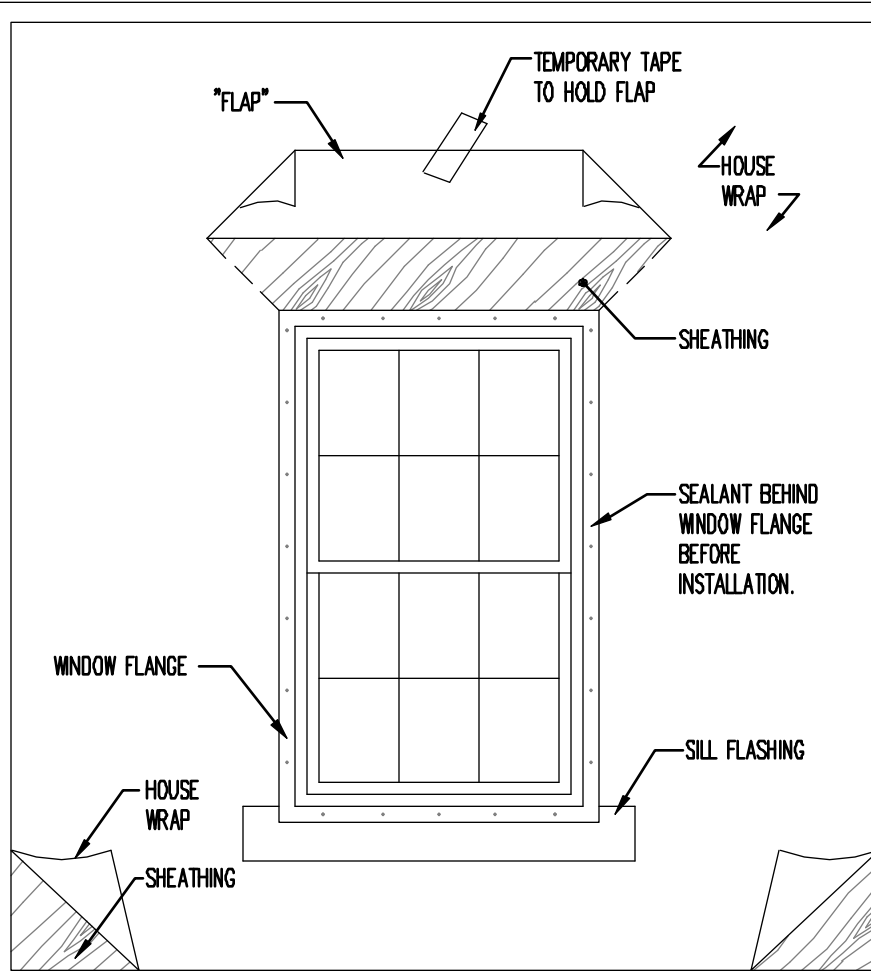


WINDOW FLASHING METHOD "A-1"

3 A. APPLY A CONTINUOUS BEAD OF SEALANT ON THE BACK SIDE OF THE WINDOW FLANGE.  
B. INSTALL THE WINDOW ACCORDING TO THE MANUFACTURERS SPECIFICATIONS.

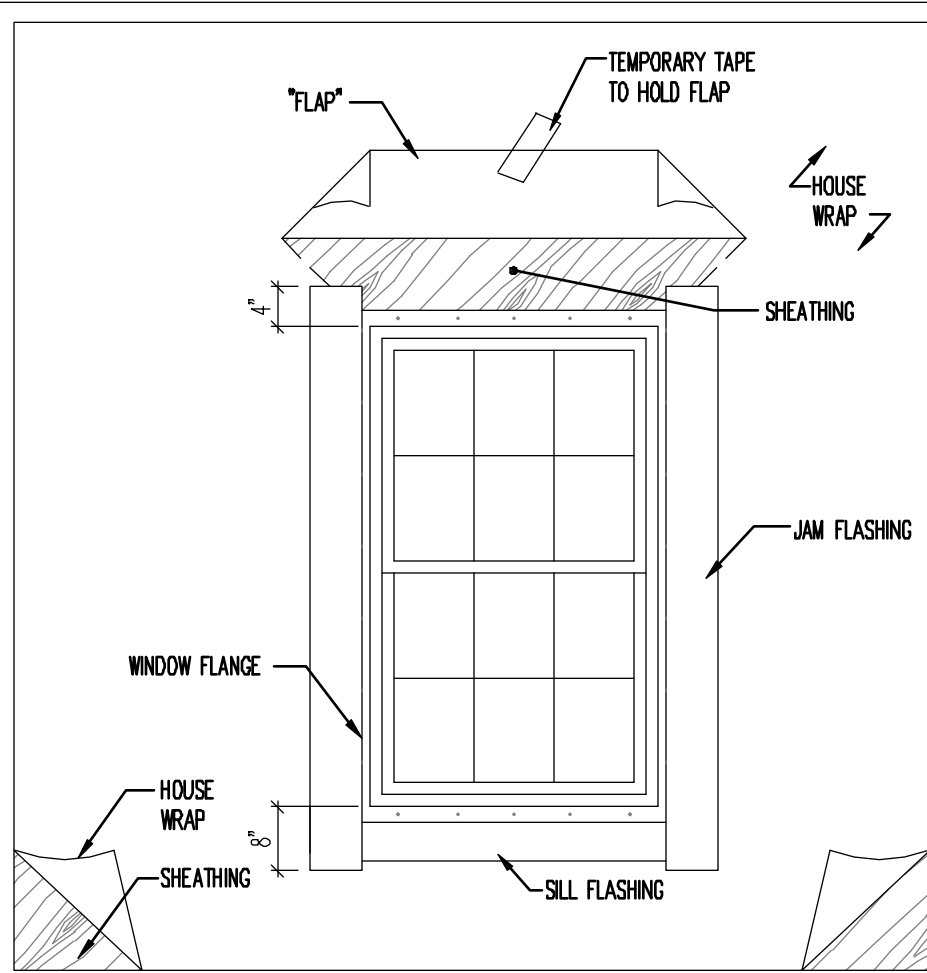


WINDOW FLASHING METHOD "A-1"

4 A. INSTALL JAMB FLASHING OVER THE WINDOW FLANGE ON EACH SIDE.  
B. EXTEND THE JAMB FLASHING 4" ABOVE THE ROUGH OPENING AND 8" BELOW THE ROUGH OPENING.  
C. INSTALL THE WINDOW ACCORDING TO THE MANUFACTURERS SPECIFICATIONS.

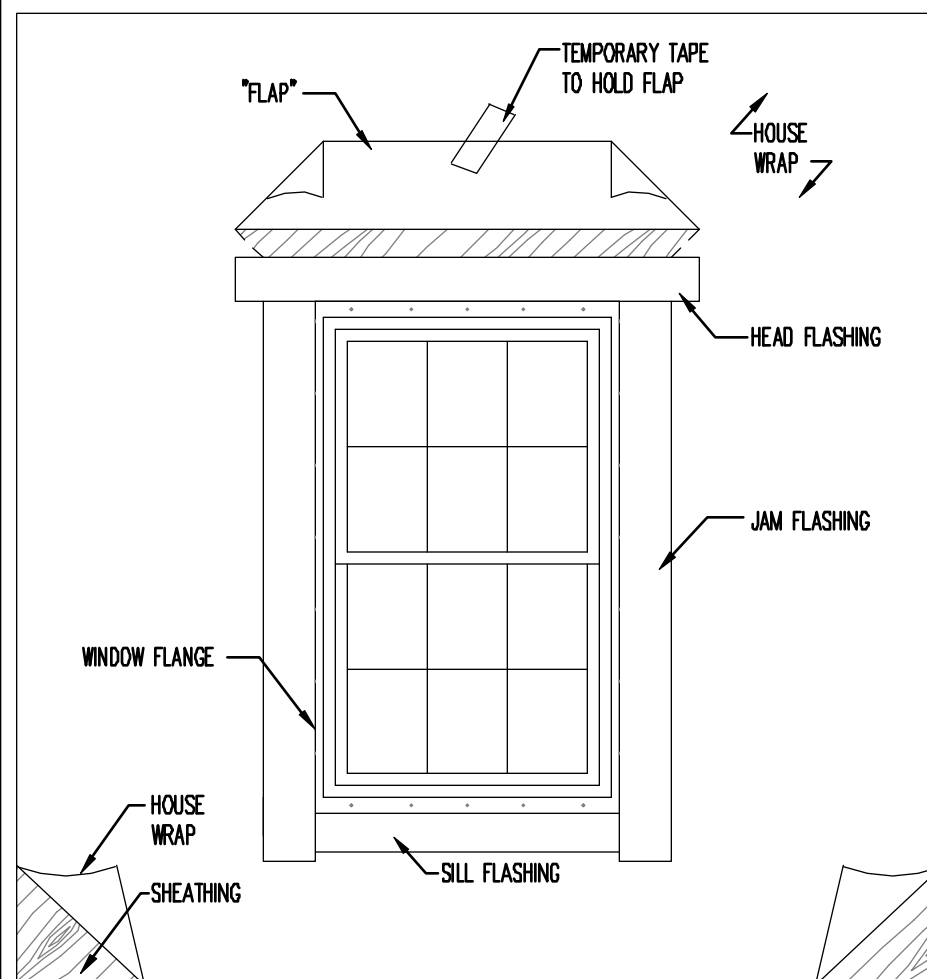


WINDOW FLASHING METHOD "A-1"

5 A. INSTALL HEAD FLASHING OVER THE WINDOW FLANGE.  
B. EXTEND THE HEAD FLASHING 8" BEYOND THE ROUGH OPENING ON EACH SIDE.

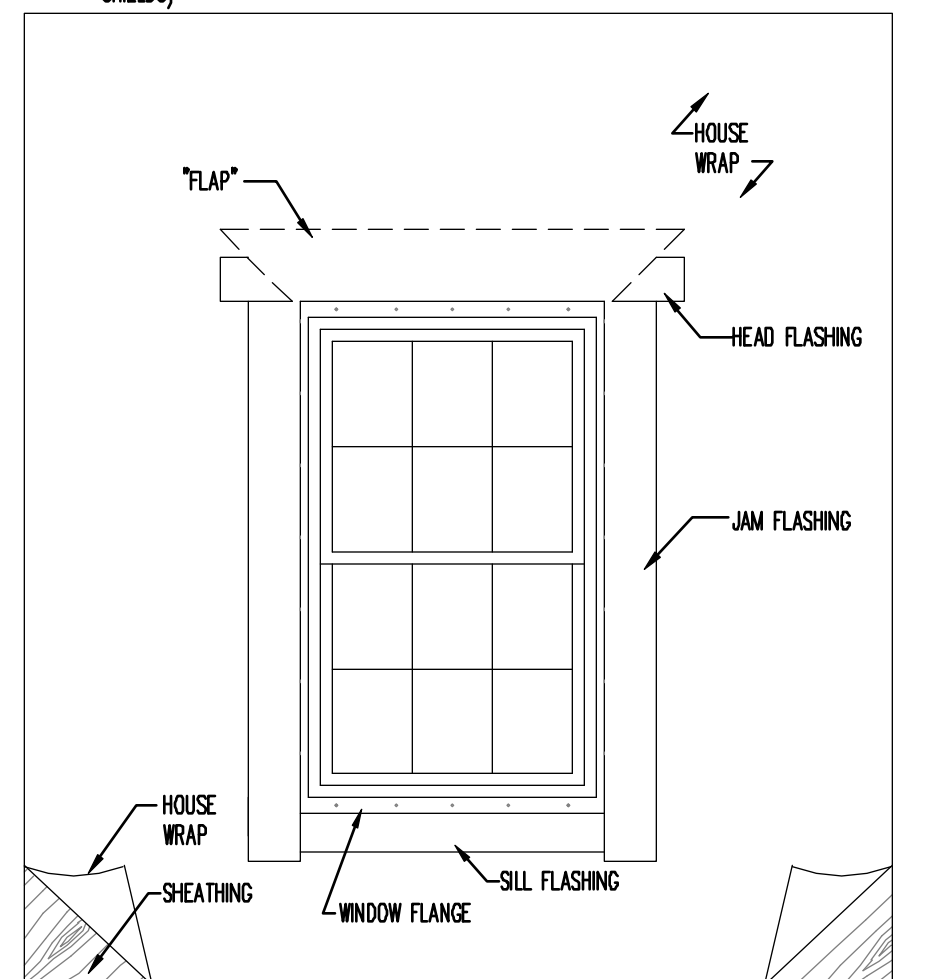


WINDOW FLASHING METHOD "A-1"

6 A. ALLOW THE BUILDING PAPER "FLAP" TO DRAPE OVER THE HEAD FLASHING.

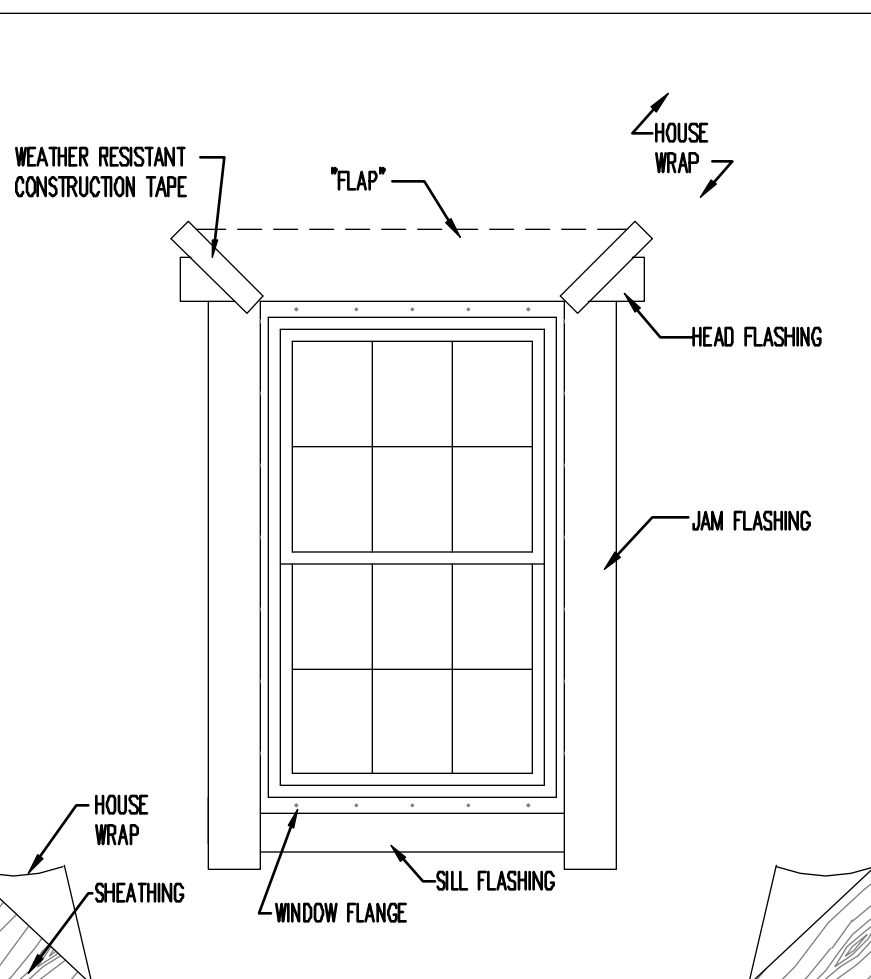

WINDOW FLASHING METHOD "A-1"

7 A. APPLY WEATHER RESISTANT TAPE OVER THE 45° ANGLE CUT ON THE BUILDING PAPER.  
B. ON INSIDE PERIMETER OF WINDOW APPLY CONTINUOUS BEAD OF SEALANT OR EXPANDABLE FOAM

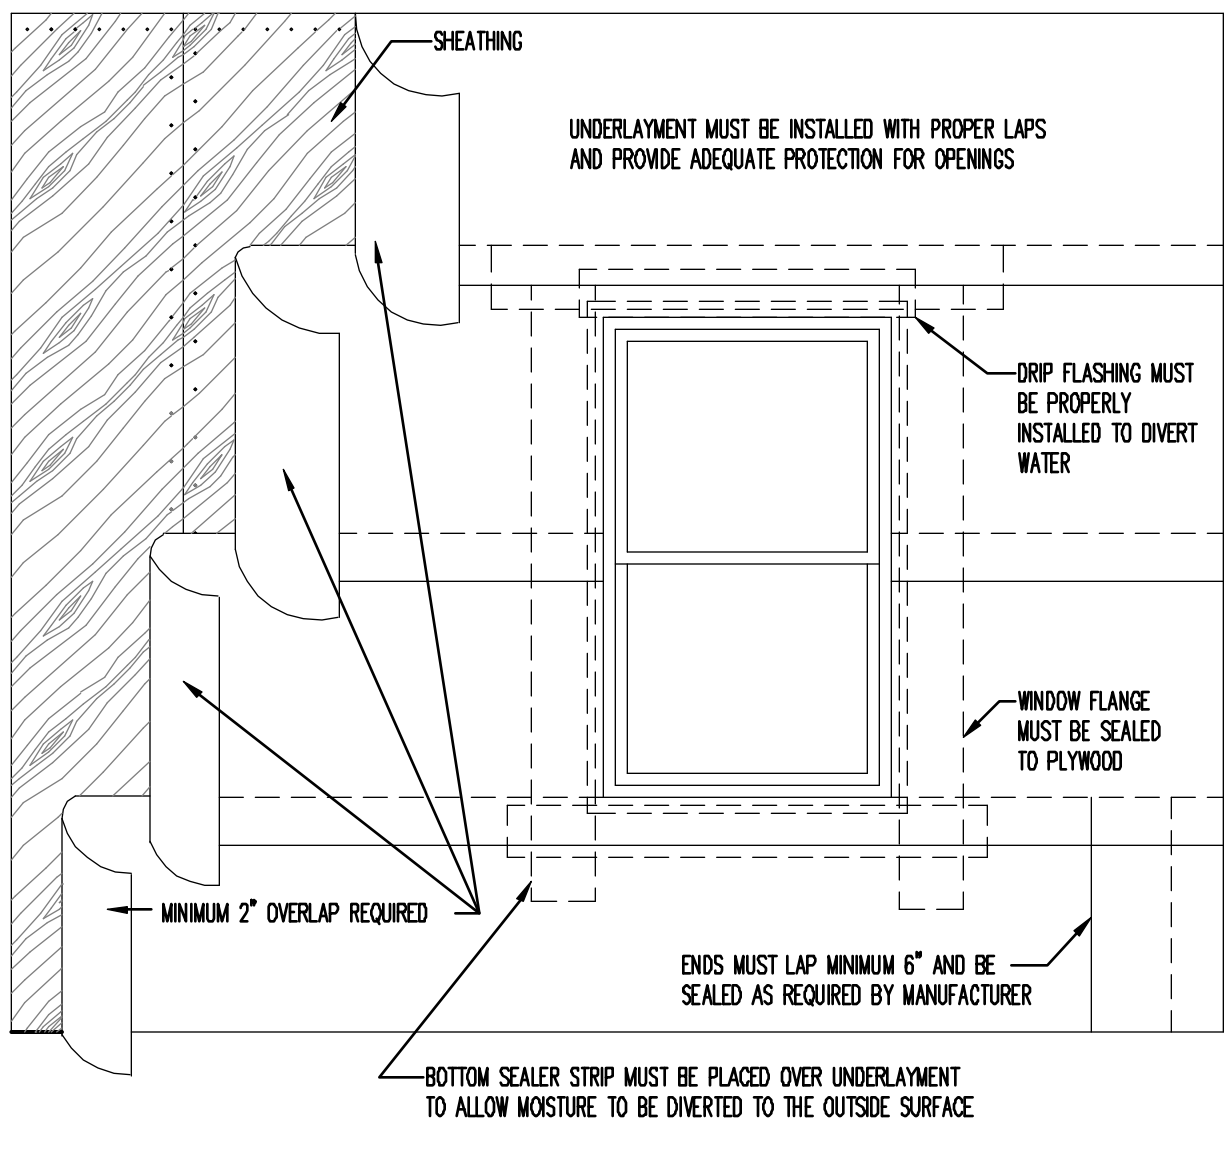


WINDOW FLASHING AND WRAP DETAILS

DISCLAIMER

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CONSTRUCTION DETAILS

03-23-12

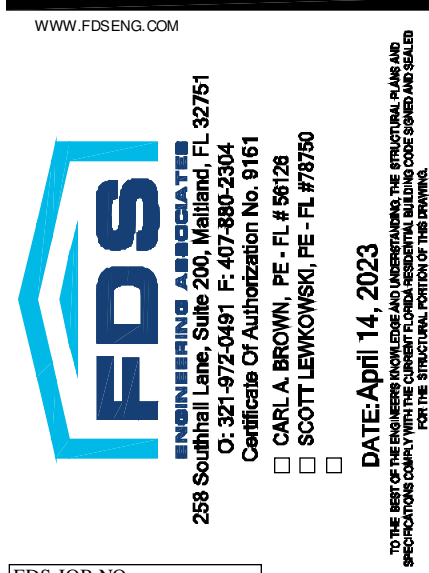

FDS JOB NO.:

PARK SQUARE  
HORIZONS WEST  
BABCOCK RANCH BLDG 6 (LOTS 6092-6099) 4 UNIT

title:  
FLASHING DTLS

project no. 2023083  
checked:  
drawn: BA  
date: 04-12-23  
scale: AS SHOWN

DT1

NOTE: DRAWINGS ON 11"x17" SHEET WILL BE ONE HALF THE SCALE NOTED


**2020 FBCR**  
**SECTION R703 EXTERIOR COVERING**

### R703.1.1 WATER RESISTANCE


### **R703.2 WATER-RESISTIVE BARRIER**

### **R703.4 FLASHING**


The structural design of this building is in accordance with the FLORIDA BUILDING CODE 7TH EDITION (2020) RESIDENTIAL and is certified as such.

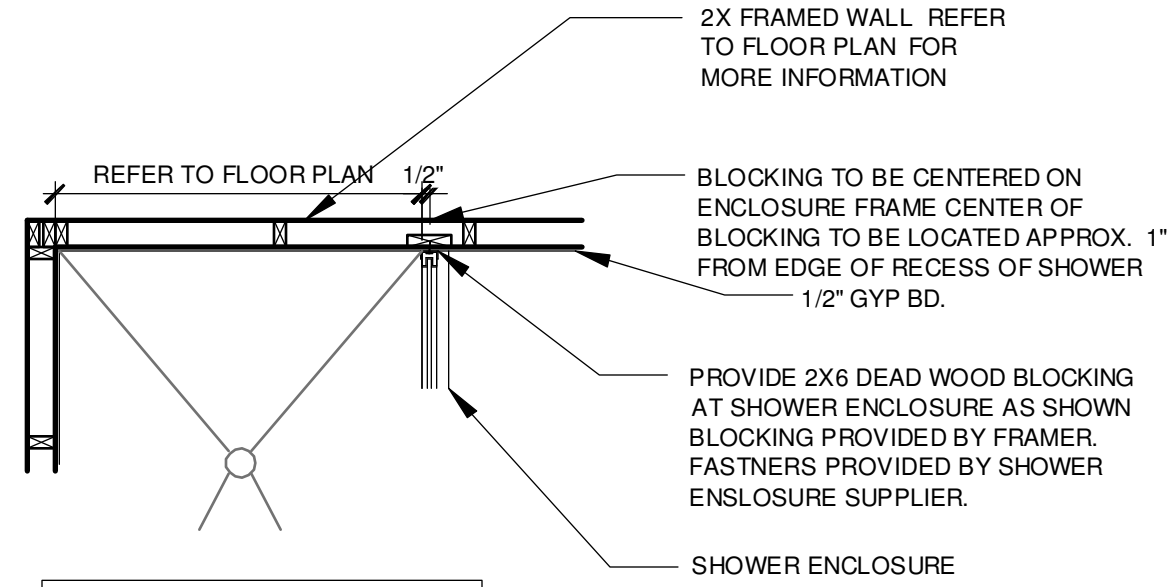


## SHOWER ENCLOSURE AT FRAME WALL

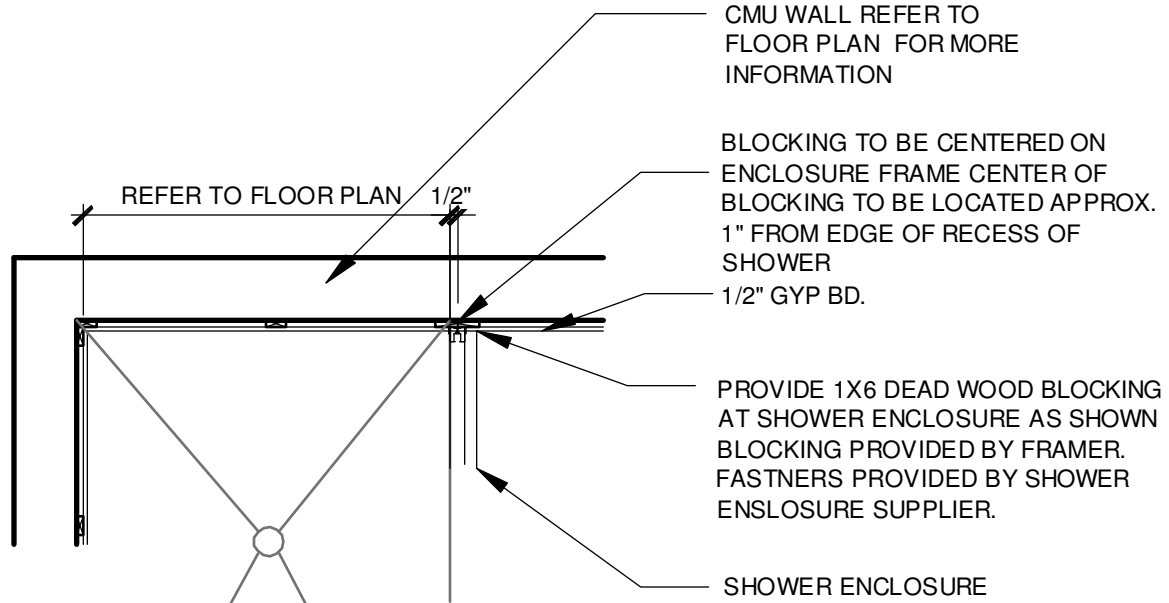

## SHOWER ENCLOSURE AT CMU WALL

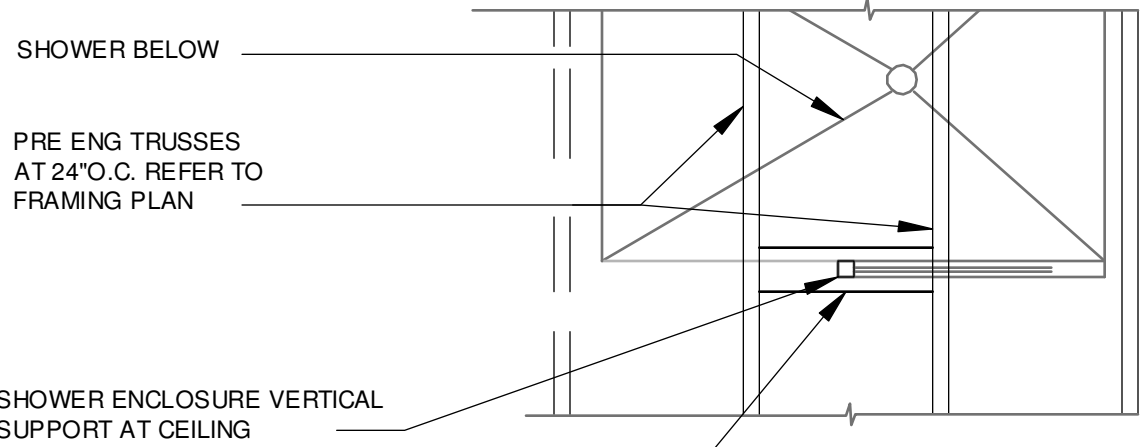

## PLAN VIEW

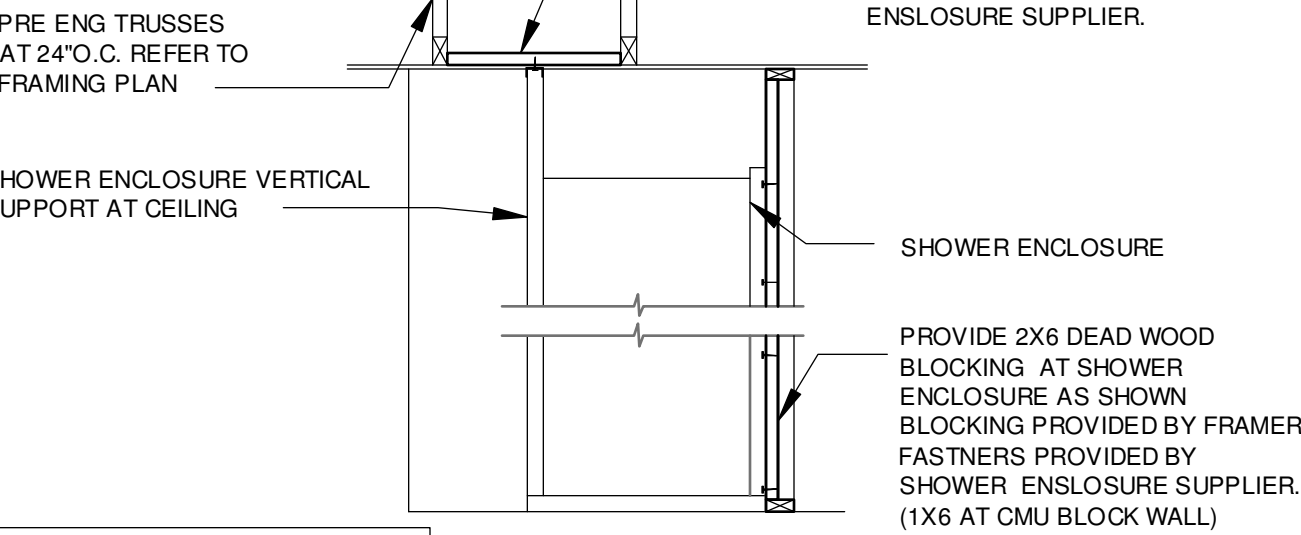

## ELEVATION SHOWER ENCLOSURE AT VERTICAL SUPPORT

### DISCLAIMER

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**B&A Design Studio, Inc.**

4017 W. 1st Street  
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ph 407 829 8900  
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www.badesignstudios.com

**N.C.B.D.C.**

**AL**

**AMERICAN**

**BUILDING DESIGN**

**FDS**

258 Southall Lane, Suite 201, Maitland, FL 32751  
C: 321-472-0491 F: 407-580-2304  
CAROL A. BROWN, PE, FL # 87128  
SCOTT LEWICKI, PE, FL # 71750

DATE: April 14, 2023

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**PARK SQUARE**

**HORIZONS WEST**


**BABCOCK RANCH BLDG 6 (LOTS 6082-6089) 4 UNIT**

title:  
**TUB ENCLOSURE DTLS**


project no. 2023083  
checked:  
drawn: BA  
date: 04-12-23  
scale: AS SHOWN

**DT3.1**


NOTE: DRAWINGS ON 11"x17" SHEET WILL BE ONE HALF THE SCALE NOTED

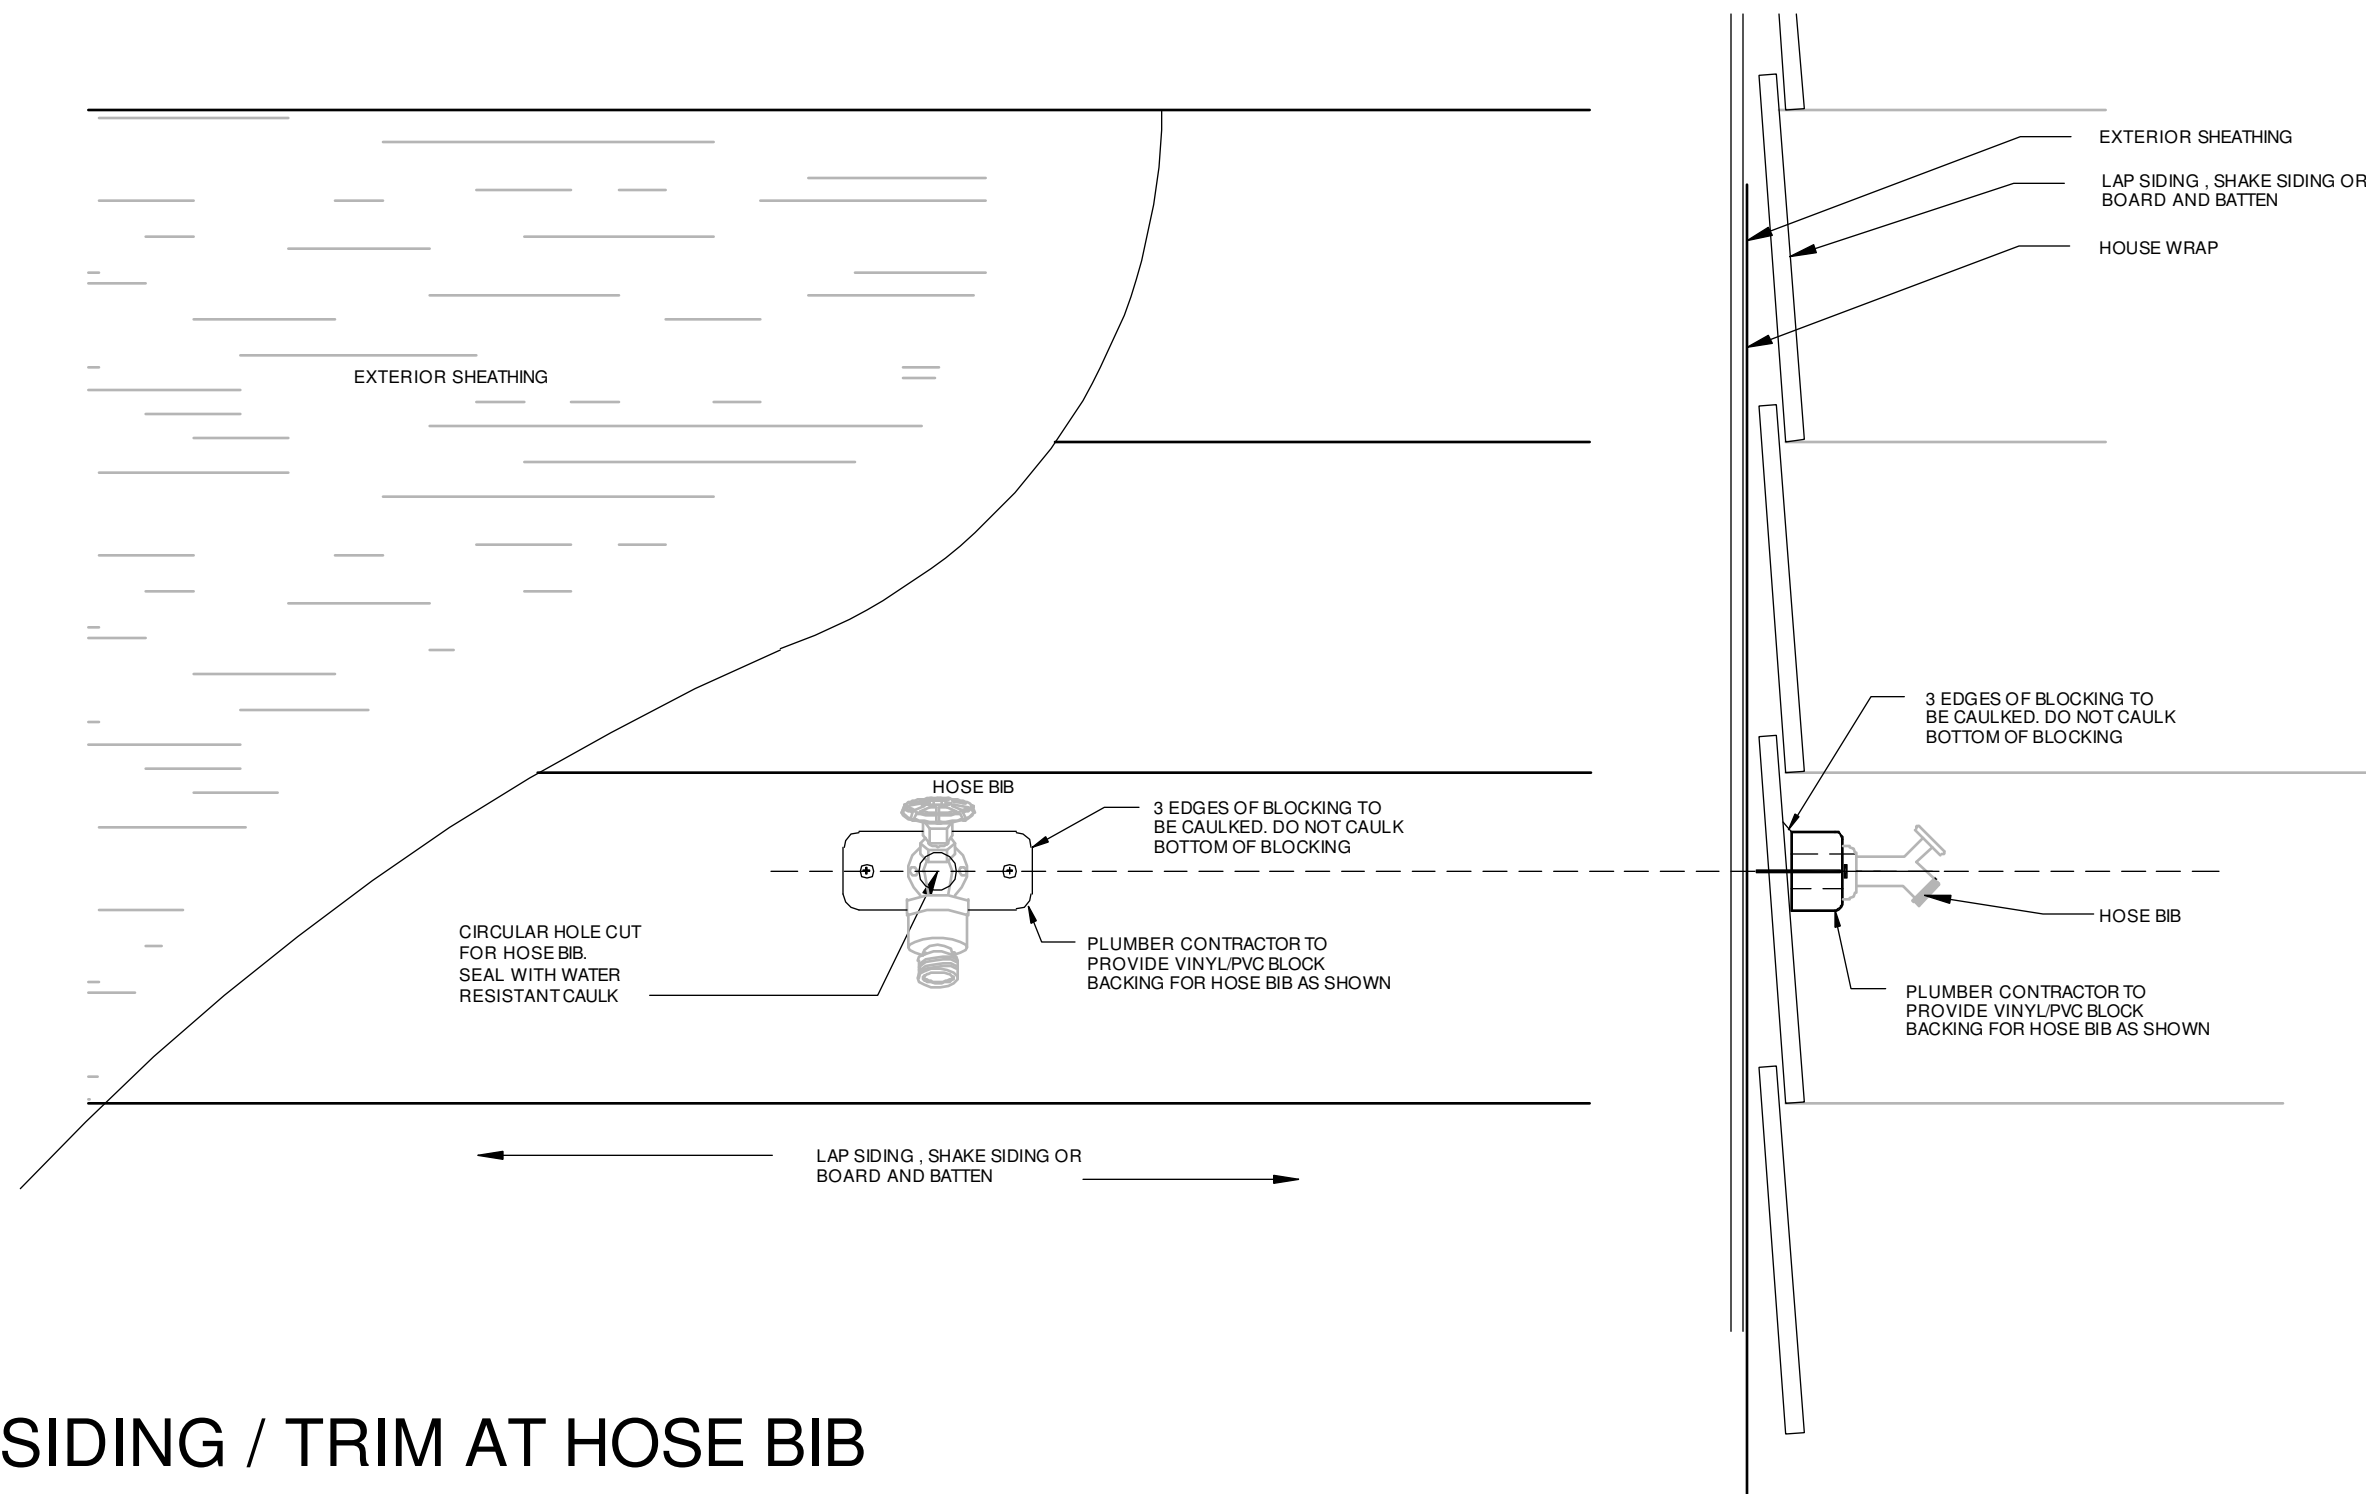

SIDING / TRIM AT HOSE BIB

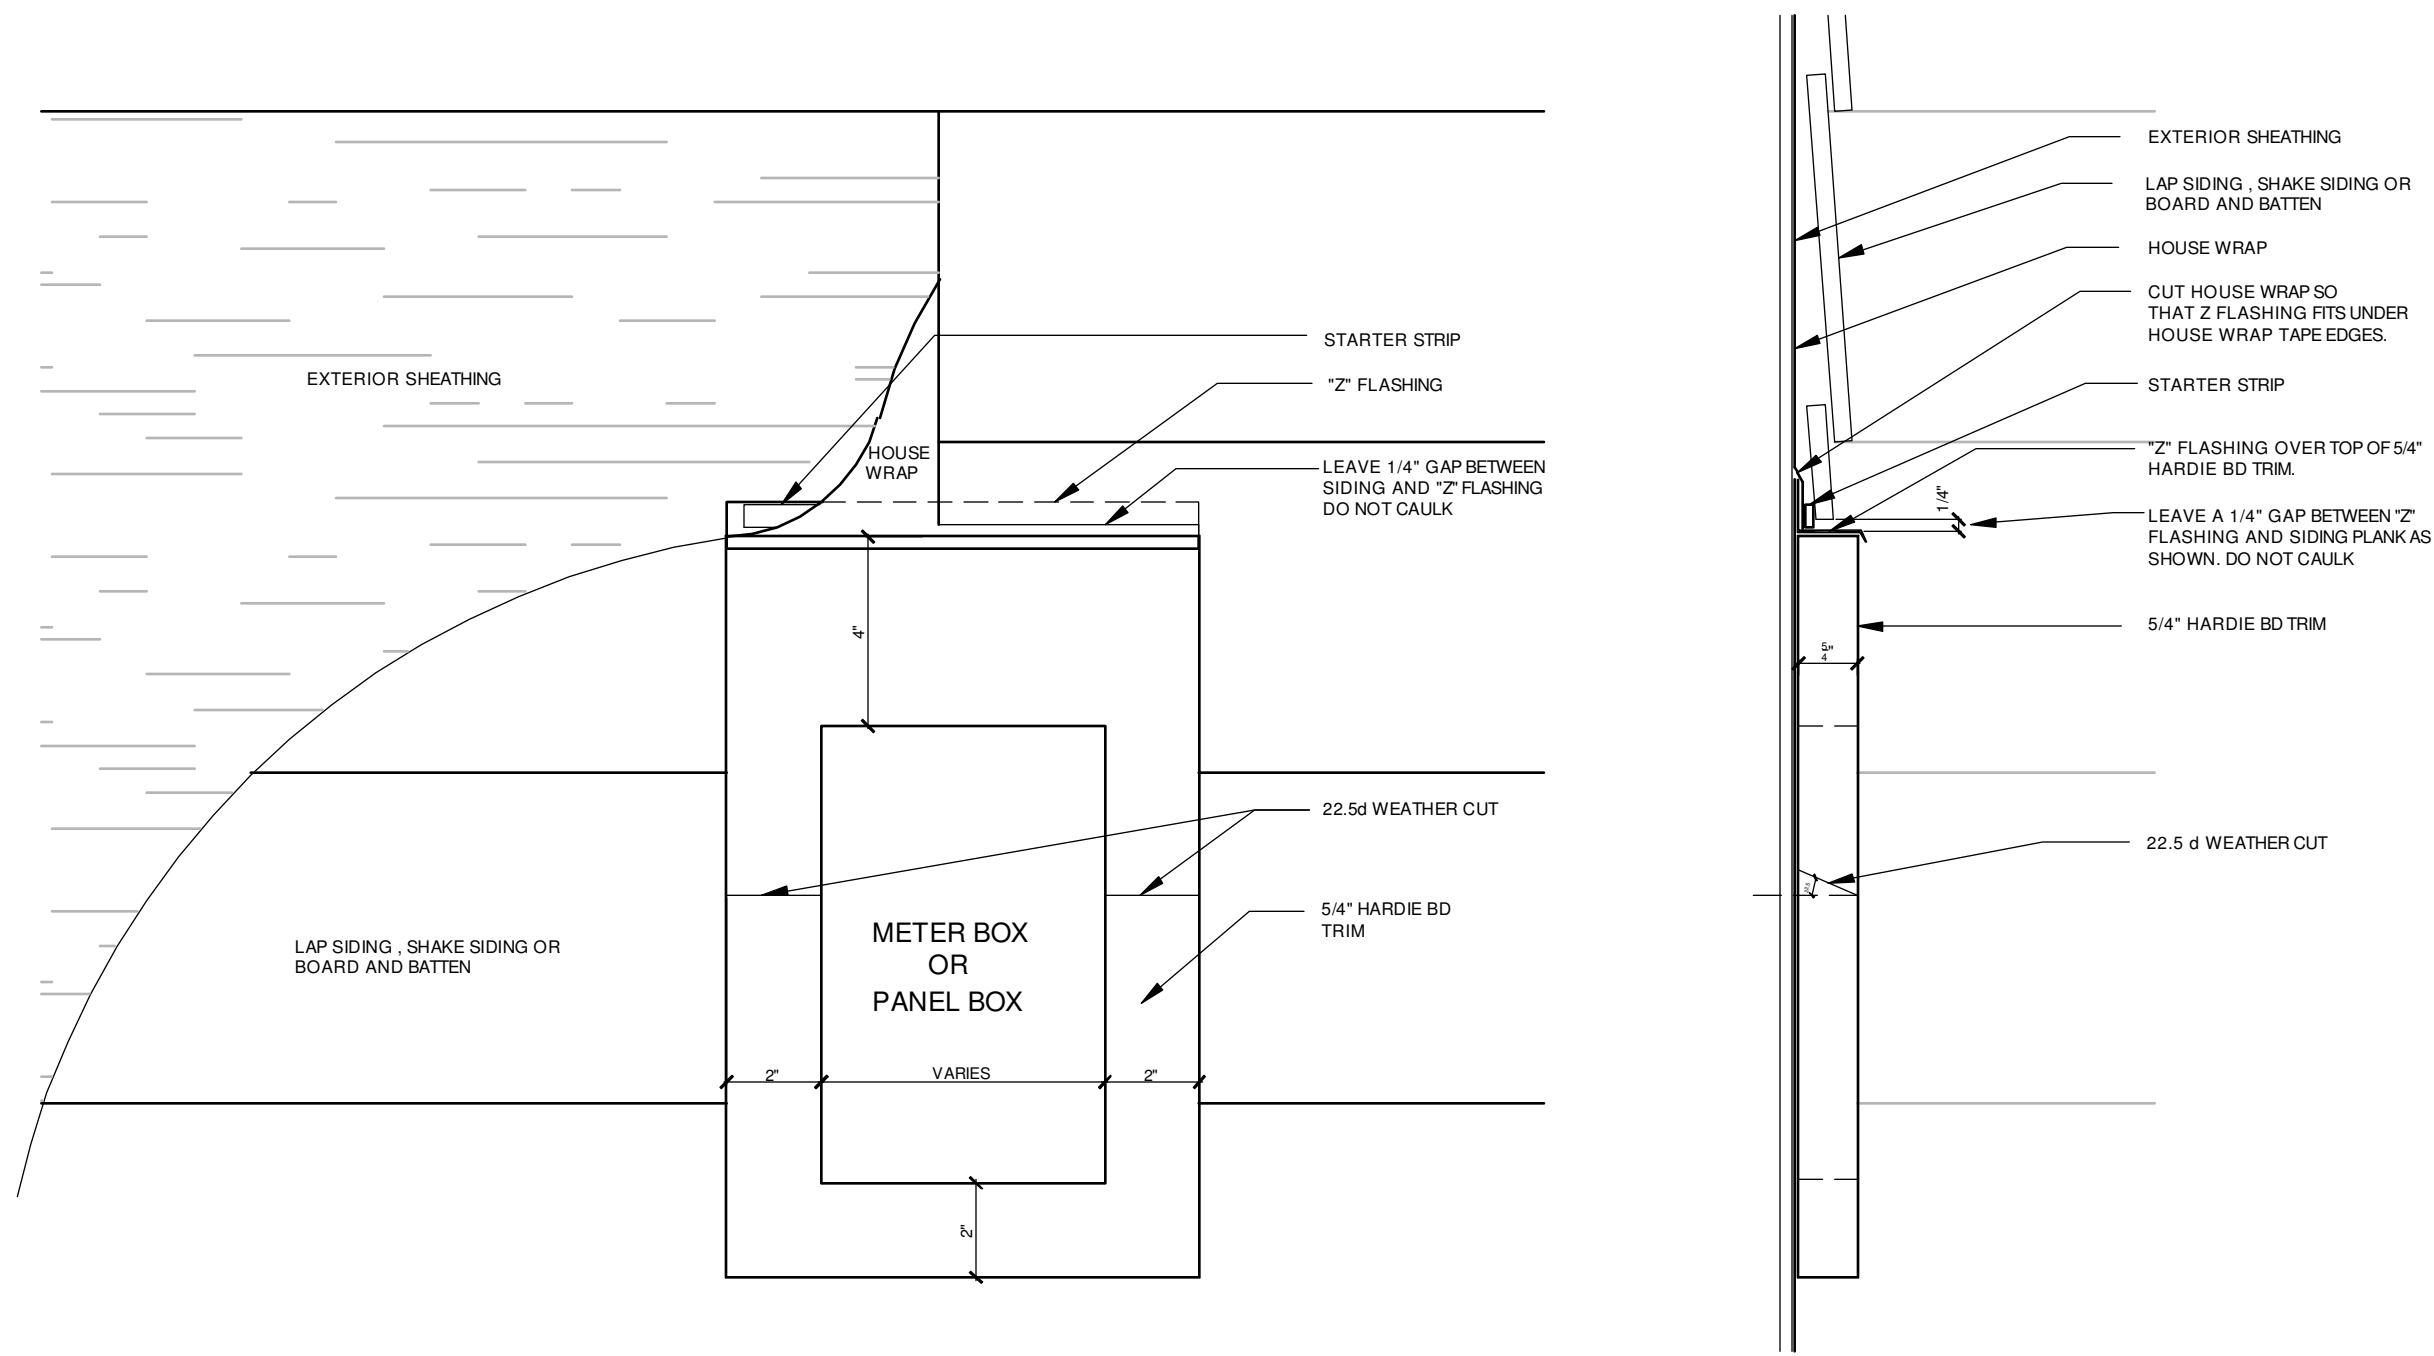

SIDING / TRIM AT ELECTRIC METER BOX


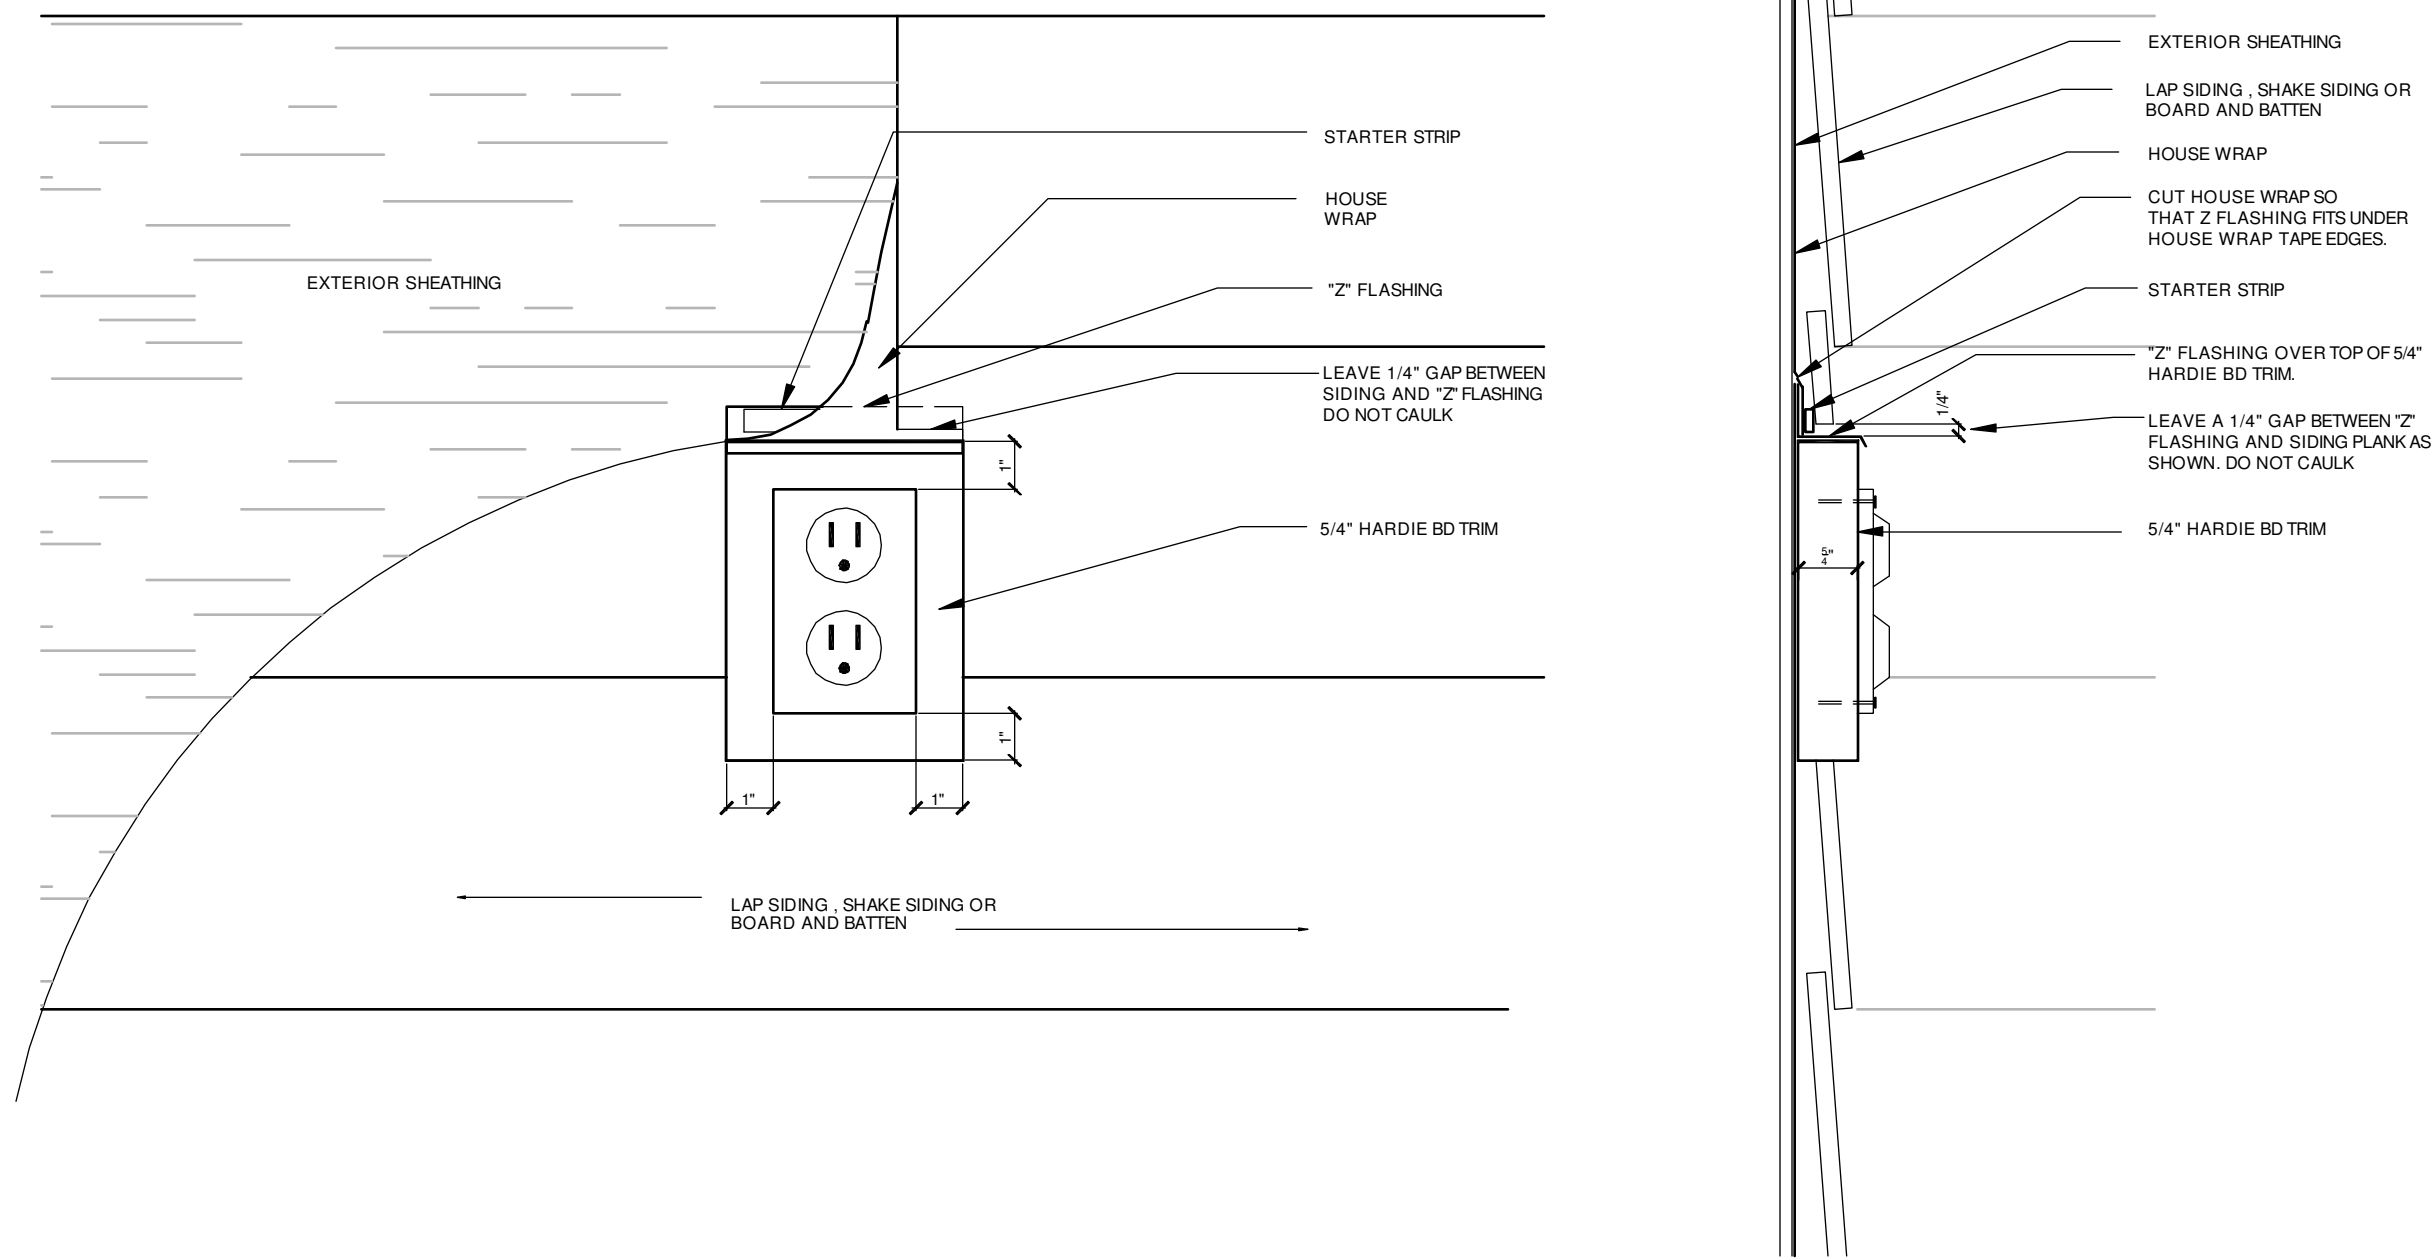


SIDING / TRIM AT ELECTRICAL OUTLET

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NOTE: DRAWINGS ON 11"x17" SHEET WILL BE ONE HALF THE SCALE NOTED



PARK SQUARE  
HORIZONS WEST  
BABCOCK RANCH BLDG 6 (LOTS 6062-6089) 4 UNIT

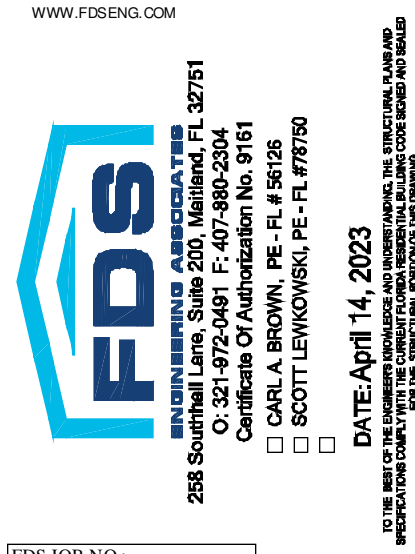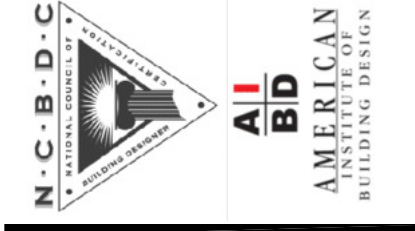title:  
TRIM DETAILS, HB  
METER, HVAC, ELEC


project no. 2023083  
checked:  
drawn: BA  
date: 04-12-23  
scale: AS SHOWN

DT4

NOTE: DRAWINGS ON 11"x17" SHEET WILL BE ONE HALF THE SCALE NOTED





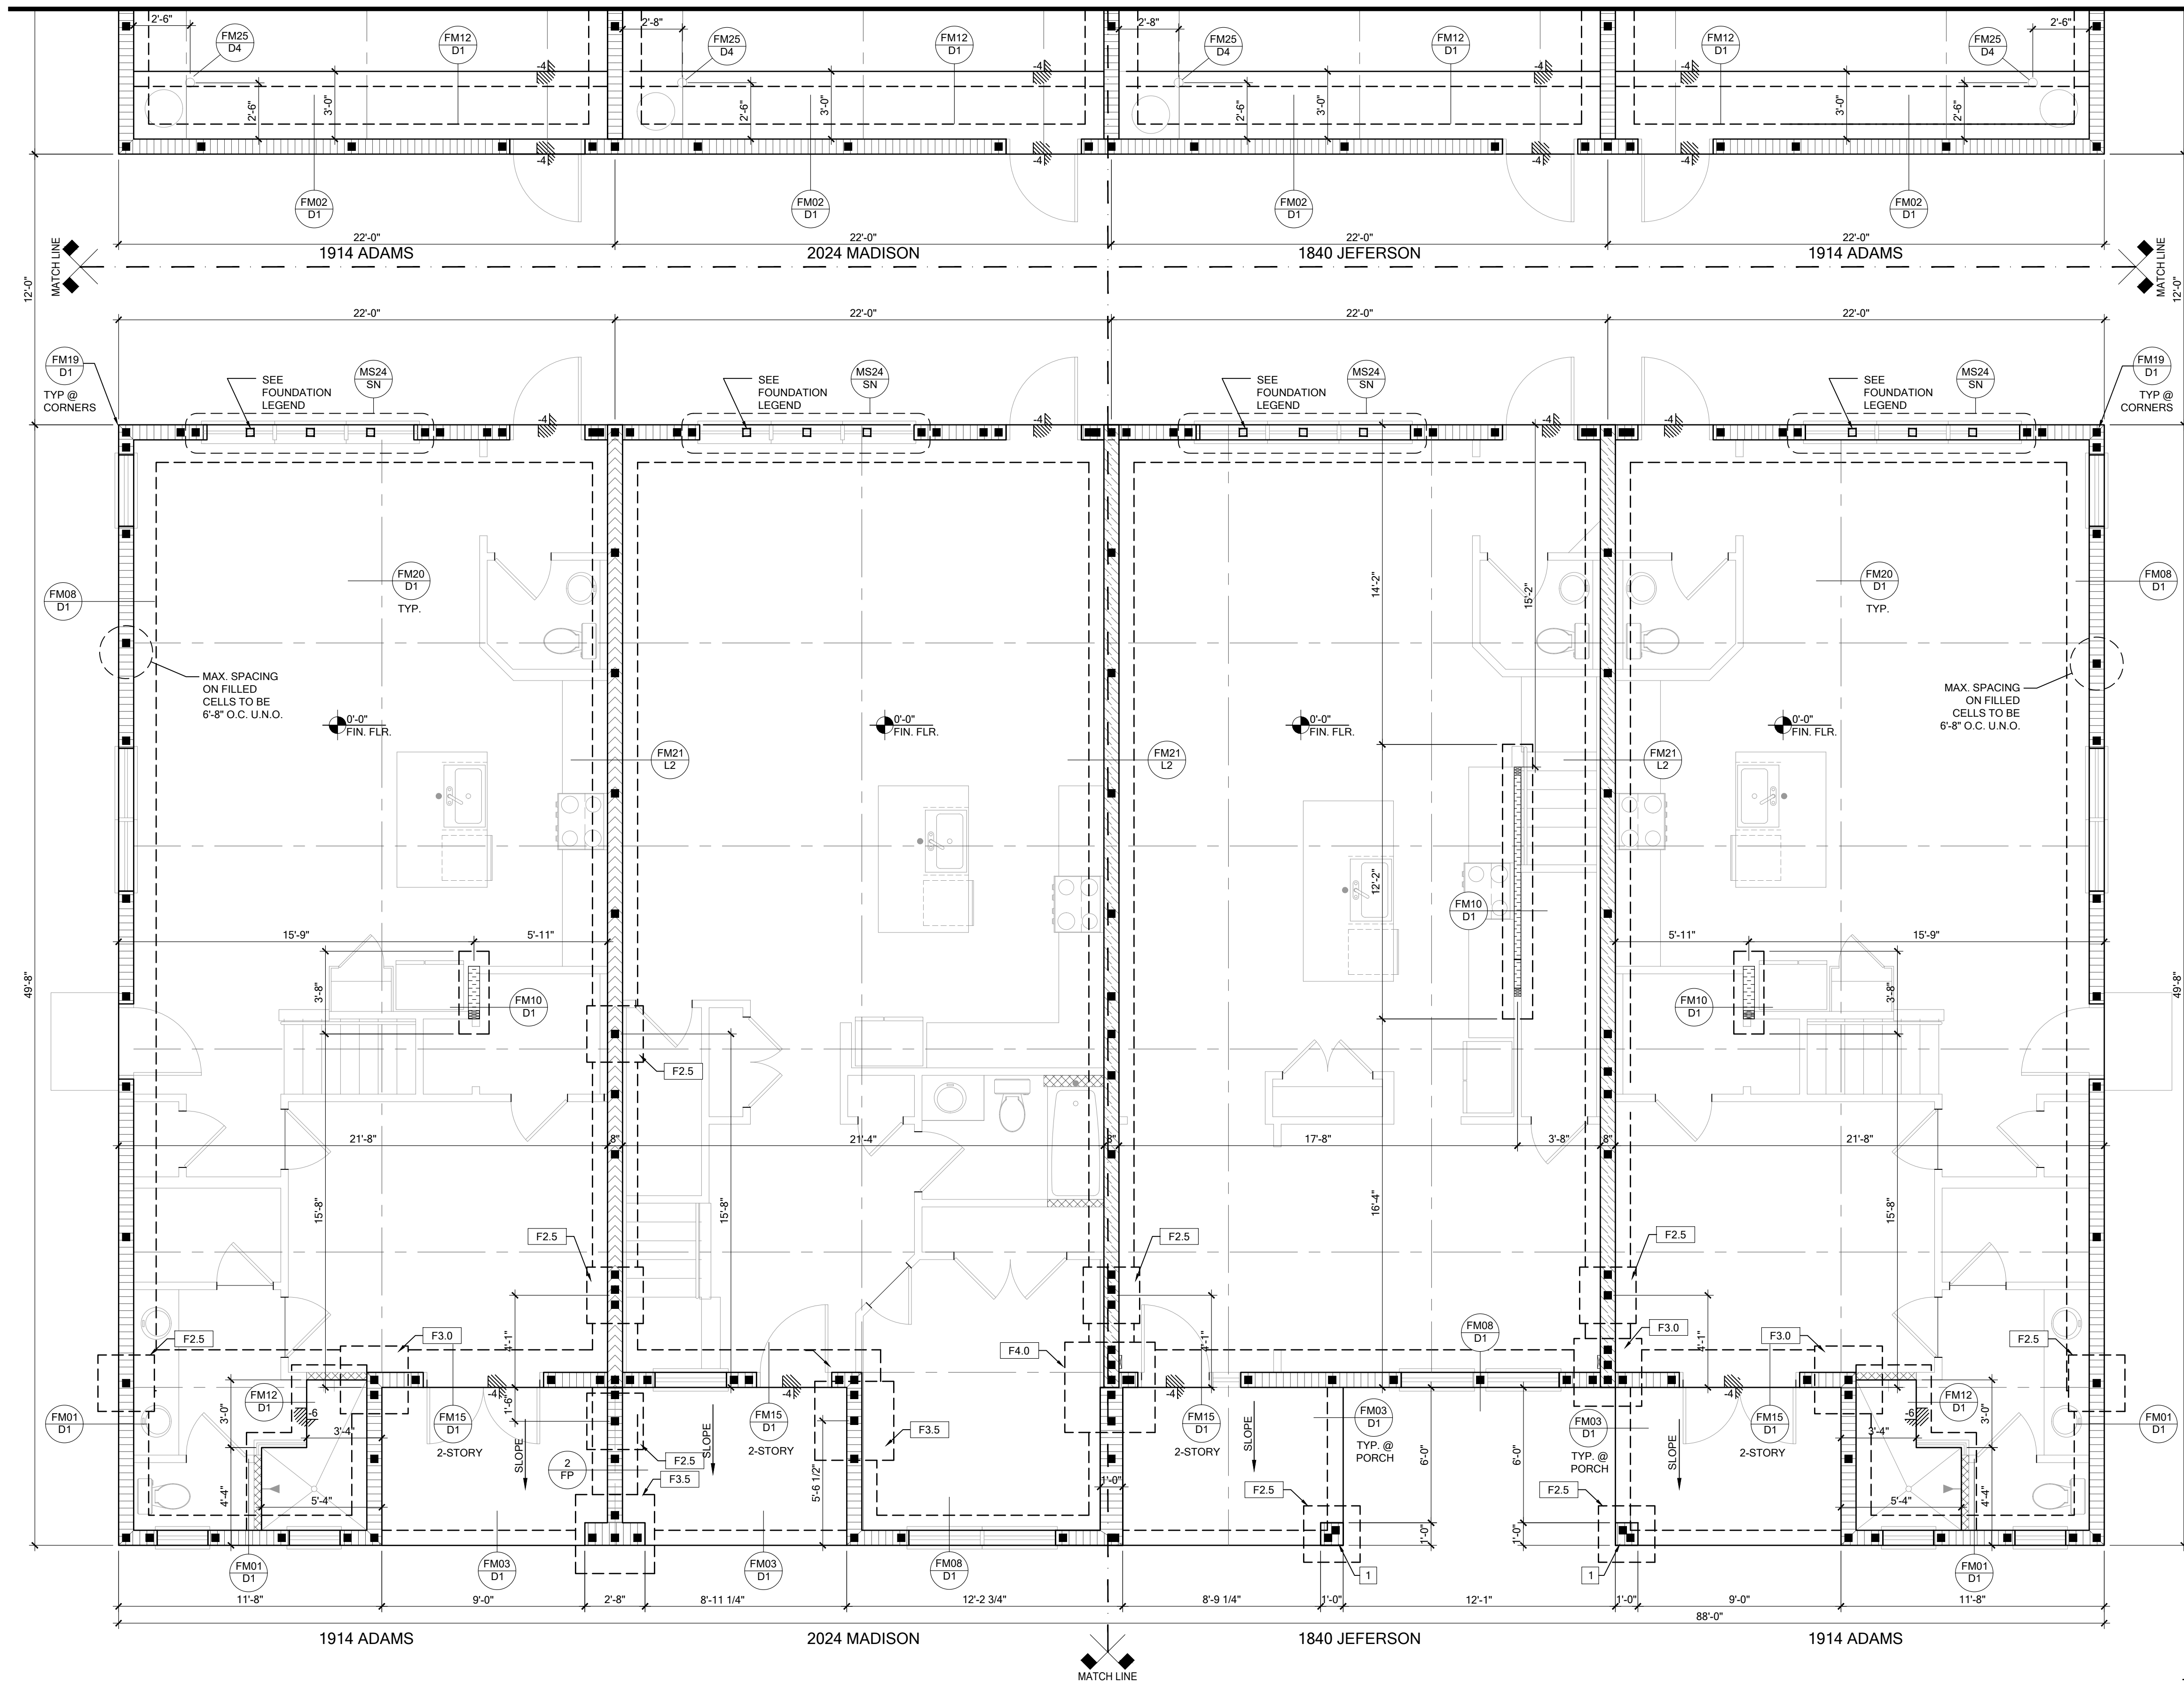

FOUNDATION LEGEND

SYMBOL	DESIGN DESCRIPTION
	INDICATES FILLED CELL w/3000 PSI CONCRETE CONSTRUCTED PER DETAIL MS01/SN AND SPACED PER PLAN
	INDICATES FILLED CELL BELOW WINDOWS w/3000 PSI CONCRETE CONSTRUCTED PER DETAIL MS01/SN AND SPACED PER PLAN
	INDICATES CONCRETE FOOTING w/ MINIMUM SOIL BEARING CAPACITY OF 2000 PSF. REINFORCE PER GENERAL FOUNDATIONS SCHEDULE ON SHEET SN FOR DESIGN SPECIFICATIONS.
	INDICATES CONSTRUCTION JOINT (IF SHOWN) SHALL BE 1/2" x 1" SAW CUTS FILLED WITH APPROVED SLAB JOINT MATERIAL COVERING A 12x12" SQUARE MAXIMUM
	INDICATES STEP IN FOUNDATION, VERIFY PER ARCHITECTURAL PLANS CONSTRUCT PER PLAN SECTION CUT AND DETAIL SHEET D1
	4" 2500 PSI CONC. SLAB W/ REINF. PER S0 w/6 MIL VISQUEEN VAPOR BARRIER & TREATED FOR TERMITES. SEE FOUNDATION SCHEDULE ON SN
	INDICATES BUILT UP COLUMN, SEE FRAMING PLAN FOR SIZE, DETAIL WF37/SN FOR PLY ATTACHMENT, AND UPLIFT CONNECTION SCHEDULE ON SN FOR CONNECTION TO SLAB

GENERAL NOTES:  
1. TYPICAL CORNER FRAMING PER DETAIL FM19/D1  
2. SEE ARCHITECTURAL PLANS FOR ALL SLAB STEP DEPTHS IF SHOW SHOWN WITHIN THESE DOCUMENTS.


FILLED CELL NOTES:  
1. SEE PLAN FOR ZONE MIDDLE AND END DESIGNATIONS  
2. PLACE FILLED CELLS AT ALL BUILDING CORNER, UNDER GIRDERS, BOTH ENDS OF EXTERIOR WALL OPENING, AND WHERE INTERIOR BEARING WALLS ARE PERPENDICULAR TO EXTERIOR MASONRY WALL.  
3. PLACE 1-#5 IN FIRST TWO CELLS ADJACENT TO GARAGE DOOR OPENING & ALL OPENINGS 8'-0" & LARGER. FILL CELLS SOLID.  
4. PLACE 1-#5 WHERE WOOD BEAMS CONNECT TO MASONRY WALL  
5. NO NOT PLACE FILLED CELLS DIRECTLY IN LINE w/ STOVE VENT

PLAN KEY NOTES

1 12" x 12" CMU COL. w/ (2) #5 - T/COL. EL. 9'-4" A.F.F.

**BUILDER NOTE:**  
ANY DISCREPANCY OR ERROR IN DIMENSIONS OR NOTES SHALL BE BROUGHT TO THE ATTENTION OF THE DESIGN PROFESSIONAL FOR CLARIFICATION PRIOR TO COMMENCEMENT OF CONSTRUCTION

WALL TYPE	
SYMBOL	DESIGN DESCRIPTION
	2x INTERIOR BEARING SHEARWALL - SEE BEARING WALL SCHEDULE ON SHEET SN FOR REQUIREMENTS.
	INDICATES BEARING WALL SEE BEARING WOOD BEARING SCHEDULE ON SN
	MASONRY WALL TOP @ 9'-4"
	MASONRY WALL TOP @ 10'-8" ABV. GRADE
	MASONRY WALL TOP @ 10'-8" ABV. GRADE

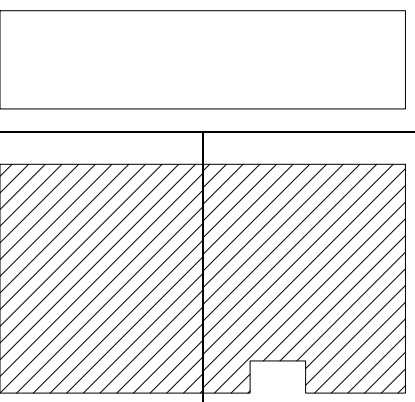

KEY PLAN

FOUNDATION PLAN  
SCALE: 1/4" = 1'-0"

B&A Design Studio, Inc.

4017 W. 1st Street  
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ph 407 829 8900  
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www.badesignstudios.com

SCOTT LEWKOWSKI  
PE-FL #9161  
DATE: April 28, 2023

www.FDSBENG.COM

ENGINEERING ASSOCIATES  
288 Southhall Lane, Suite 200, Maitland, FL 32751  
(407) 829-8900  
Certificate of Authorization No. 9161  
□ CARLA A. BROWN, PE-FL #45628  
□ SCOTT LEWKOWSKI, PE-FL #9161  
DATE: April 28, 2023

THE SEAL OF THE PROFESSIONAL ENGINEER AND ARCHITECT IDENTIFYING THE STRUCTURAL ENGINEER AND ARCHITECT IS REQUIRED FOR ALL PROJECTS. THE SEAL OF THE PROFESSIONAL ENGINEER AND ARCHITECT IS REQUIRED FOR ALL PROJECTS.


PARK SQUARE  
HORIZONS WEST  
BABCOCK RANCH BLDG 6 (LOTS 6092-6099) 4 UNIT

title:

project no. 2023083  
checked:  
drawn: BA  
date: 04-12-23  
scale:

S1.1

NOTE: DRAWINGS ON 11"x17" SHEET WILL BE ONE HALF THE SCALE NOTED

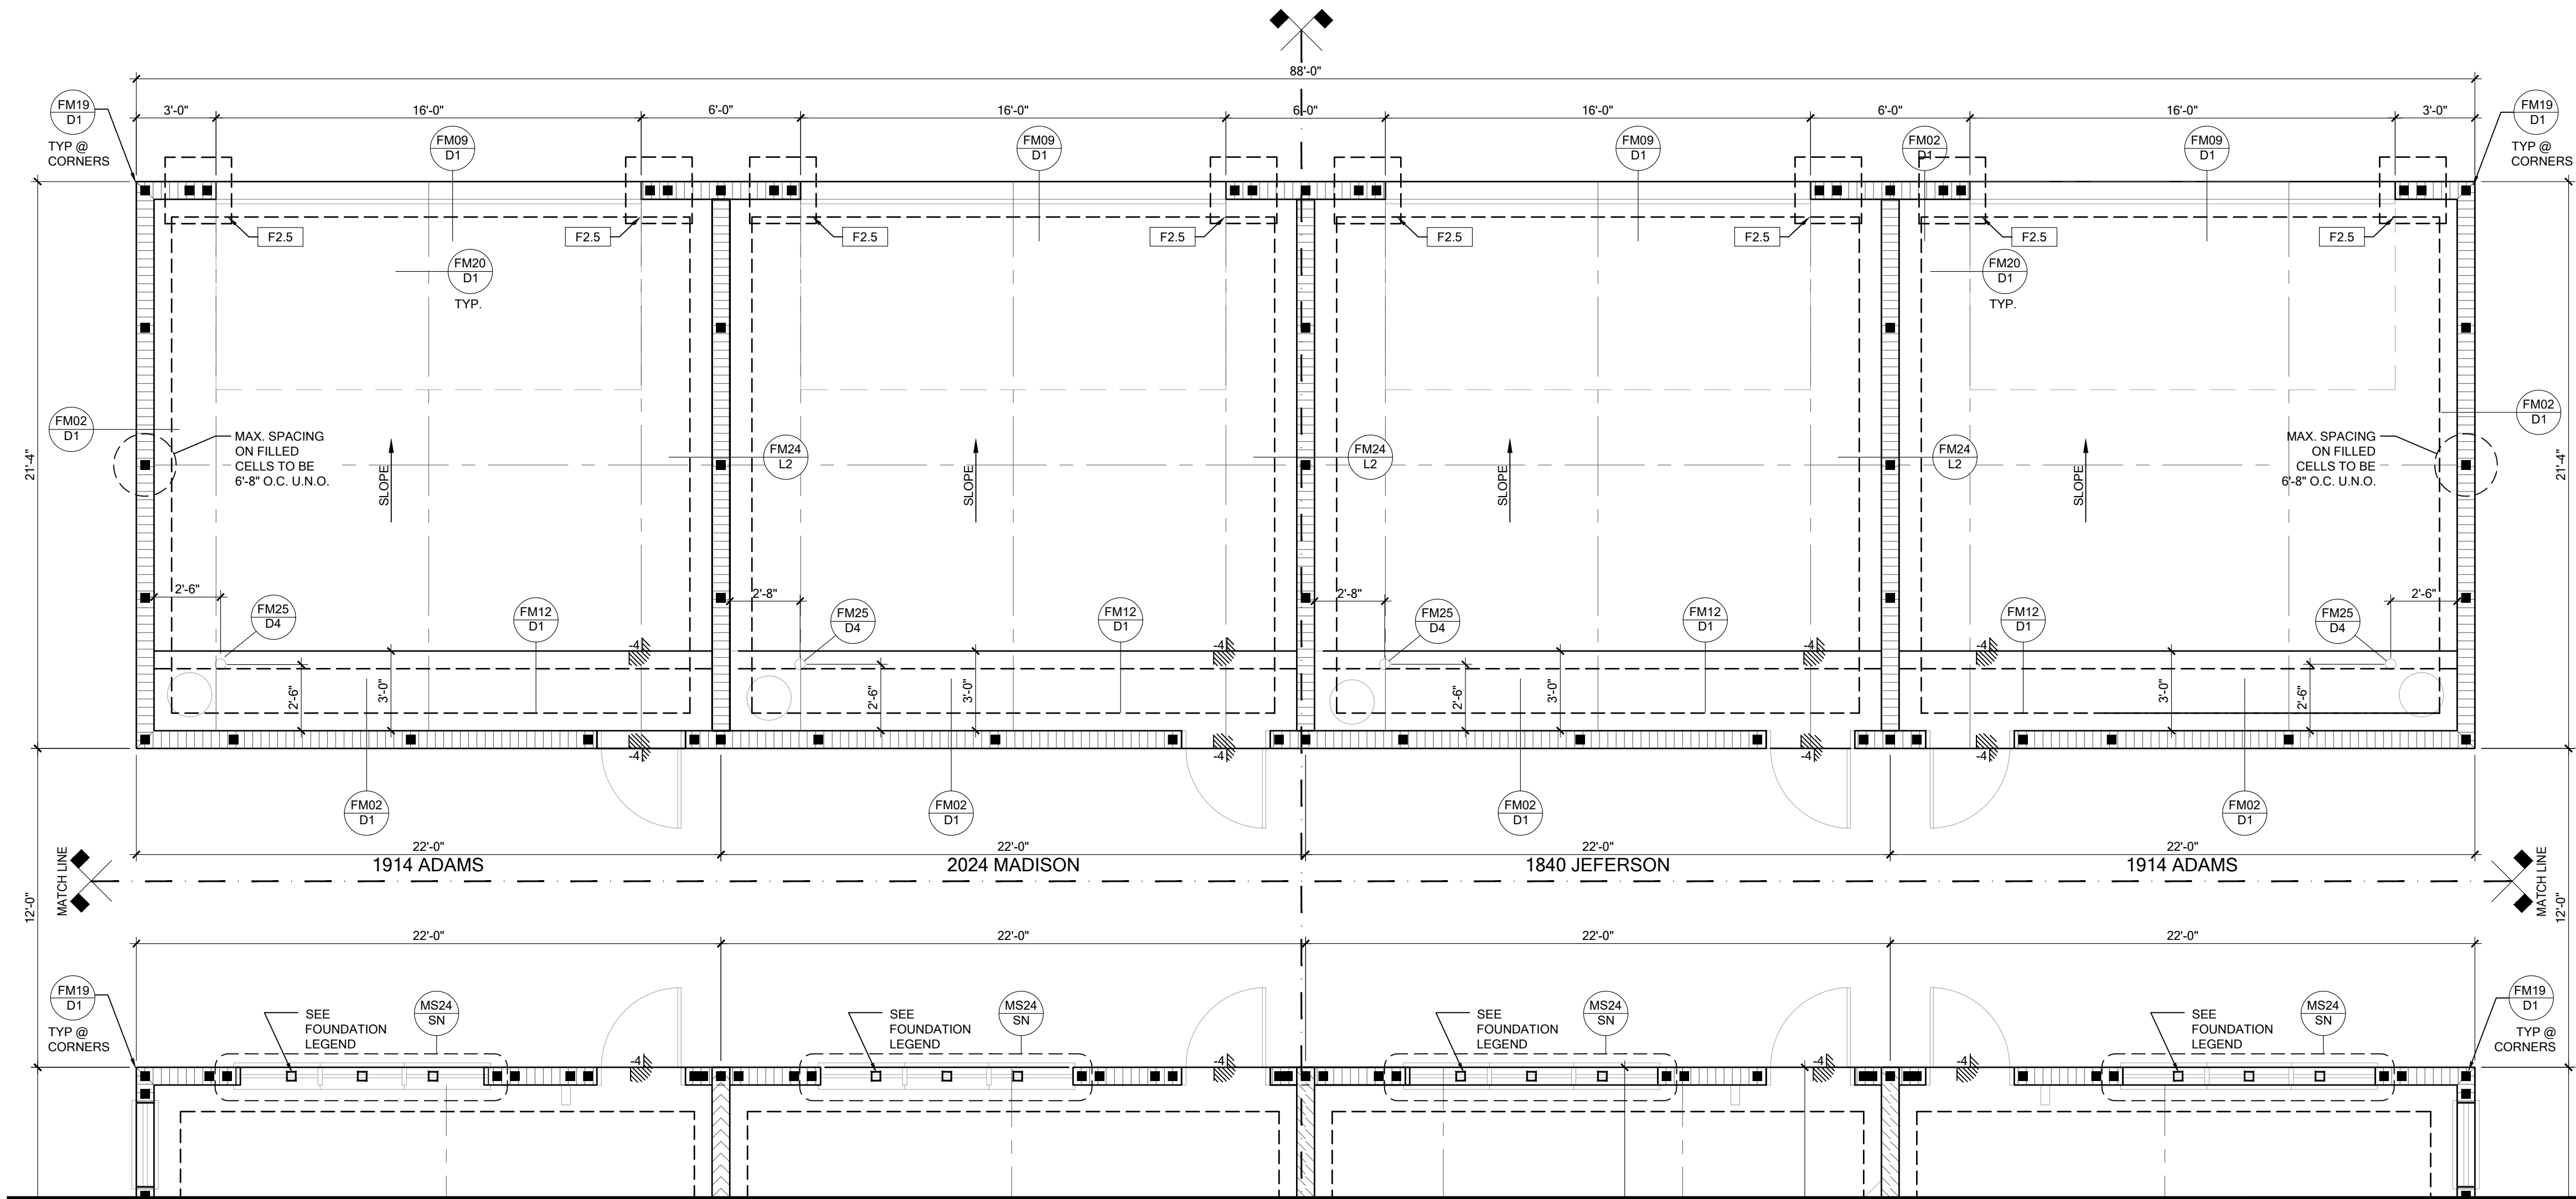

## FOUNDATION LEGEND

SYMBOL	DESIGN DESCRIPTION
	INDICATES FILLED CELL w/3000 PSI CONCRETE CONSTRUCTED PER DETAIL MS01/SN AND SPACED PER PLAN
	INDICATES FILLED CELL BELOW WINDOWS w/3000 PSI CONCRETE CONSTRUCTED PER DETAIL MS01/SN AND SPACED PER PLAN
	INDICATES CONCRETE FOOTING w/ MINIMUM SOIL BEARING CAPACITY OF 2000 PSF. REINFORCE PER GENERAL FOUNDATIONS SCHEDULE ON SHEET SN FOR DESIGN SPECIFICATIONS.
	INDICATES CONSTRUCTION JOINT (IF SHOWN) SHALL BE 1/2" x 1" SAW CUTS FILLED WITH APPROVED SLAB JOINT MATERIAL COVERING A 12x12 SQUARE MAXIMUM
	INDICATES STEP IN FOUNDATION, VERIFY PER ARCHITECTURAL PLANS CONSTRUCT PER PLAN SECTION CUT AND DETAIL SHEET D1
	4" 2500 PSI CONC. SLAB W/ REINF. PER S0 w/6 MIL VISQUEEN VAPOR BARRIER & TREATED FOR TERMITES. SEE FOUNDATION SCHEDULE ON SN
	INDICATES BUILT UP COLUMN, SEE FRAMING PLAN FOR SIZE, DETAIL WF37/SN FOR PLY ATTACHMENT, AND UPLIFT CONNECTION SCHEDULE ON SN FOR CONNECTION TO SLAB

GENERAL NOTES:  
1. TYPICAL CORNER FRAMING PER DETAIL FM19/D1  
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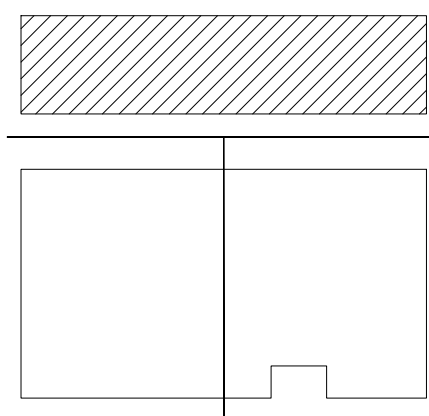
FILLED CELL NOTES:  
1. SEE PLAN FOR ZONE MIDDLE AND END DESIGNATIONS  
2. PLACE FILLED CELLS AT ALL BUILDING CORNER, UNDER GIRDERS, BOTH ENDS OF EXTERIOR WALL OPENING, AND WHERE INTERIOR BEARING WALLS ARE PERPENDICULAR TO EXTERIOR MASONRY WALL.  
3. PLACE 1-#5 IN FIRST TWO CELLS ADJACENT TO GARAGE DOOR OPENING & ALL OPENINGS 8'-0" & LARGER. FILL CELLS SOLID.  
4. PLACE 1-#5 WHERE WOOD BEAMS CONNECT TO MASONRY WALL  
5. NO NOT PLACE FILLED CELLS DIRECTLY IN LINE w/ STOVE VENT

## PLAN KEY NOTES

BUILDER NOTE:  
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## WALL TYPE


SYMBOL	DESIGN DESCRIPTION
	2x INTERIOR BEARING SHEARWALL - SEE BEARING WALL SCHEDULE ON SHEET SN FOR REQUIREMENTS.
	INDICATES BEARING WALL SEE BEARING WOOD BEARING SCHEDULE ON SN
	MASONRY WALL TOP @ 9'-4"
	MASONRY WALL TOP @ 10'-8" ABV. GRADE
	MASONRY WALL TOP @ 10'-8" ABV. GRADE



## KEY PLAN

## FOUNDATION PLAN

SCALE: 1/4" = 1'-0"

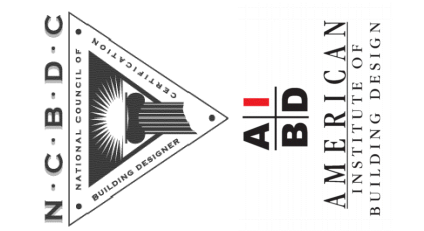

FDS JOB NO.:

PARK SQUARE  
HORIZONS WEST  
BABCOCK RANCH BLDG 6 (LOTS 6092-6099) 4 UNIT

title:

project no. 2023083  
checked:  
drawn: BA  
date: 04-12-23  
scale:

S1.2

NOTE: DRAWINGS ON 11"x17" SHEET WILL BE ONE HALF THE SCALE NOTED

RSH

ENGINEERED ROOF PER ASCE 7-16 ROOF DESIGN ALLOWABLE COMPONENTS AND CLADDING WIND PRESSURES AND SUCTIONS FOR MEAN ROOF HEIGHT ≤ 25 ft

WIND SPEED (ULTIMATE)

WIND SPEED (ALLOWABLE)

EXPOSURE CATEGORY

150.0 MPH

116.2 MPH

C


EFFECTIVE WIND AREA (50 FEET)


WIND PRESSURE AND SUCTION (PSF)



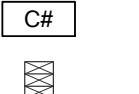

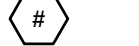


(+) VALUE DENOTES PRESSURE

(-) VALUE DENOTES SUCTION

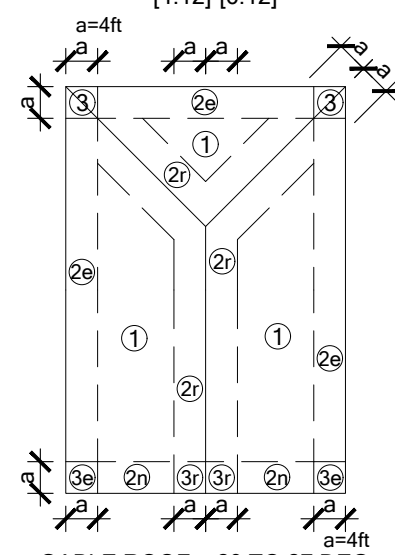AREA	ROOF	1	2a	2n	2r	3	3a	3r
10	HIP	-43.90	-60.59		-60.59	-60.59		
	GABLE	-43.86	-43.86	-69.97	-69.97		-69.97	-90.23

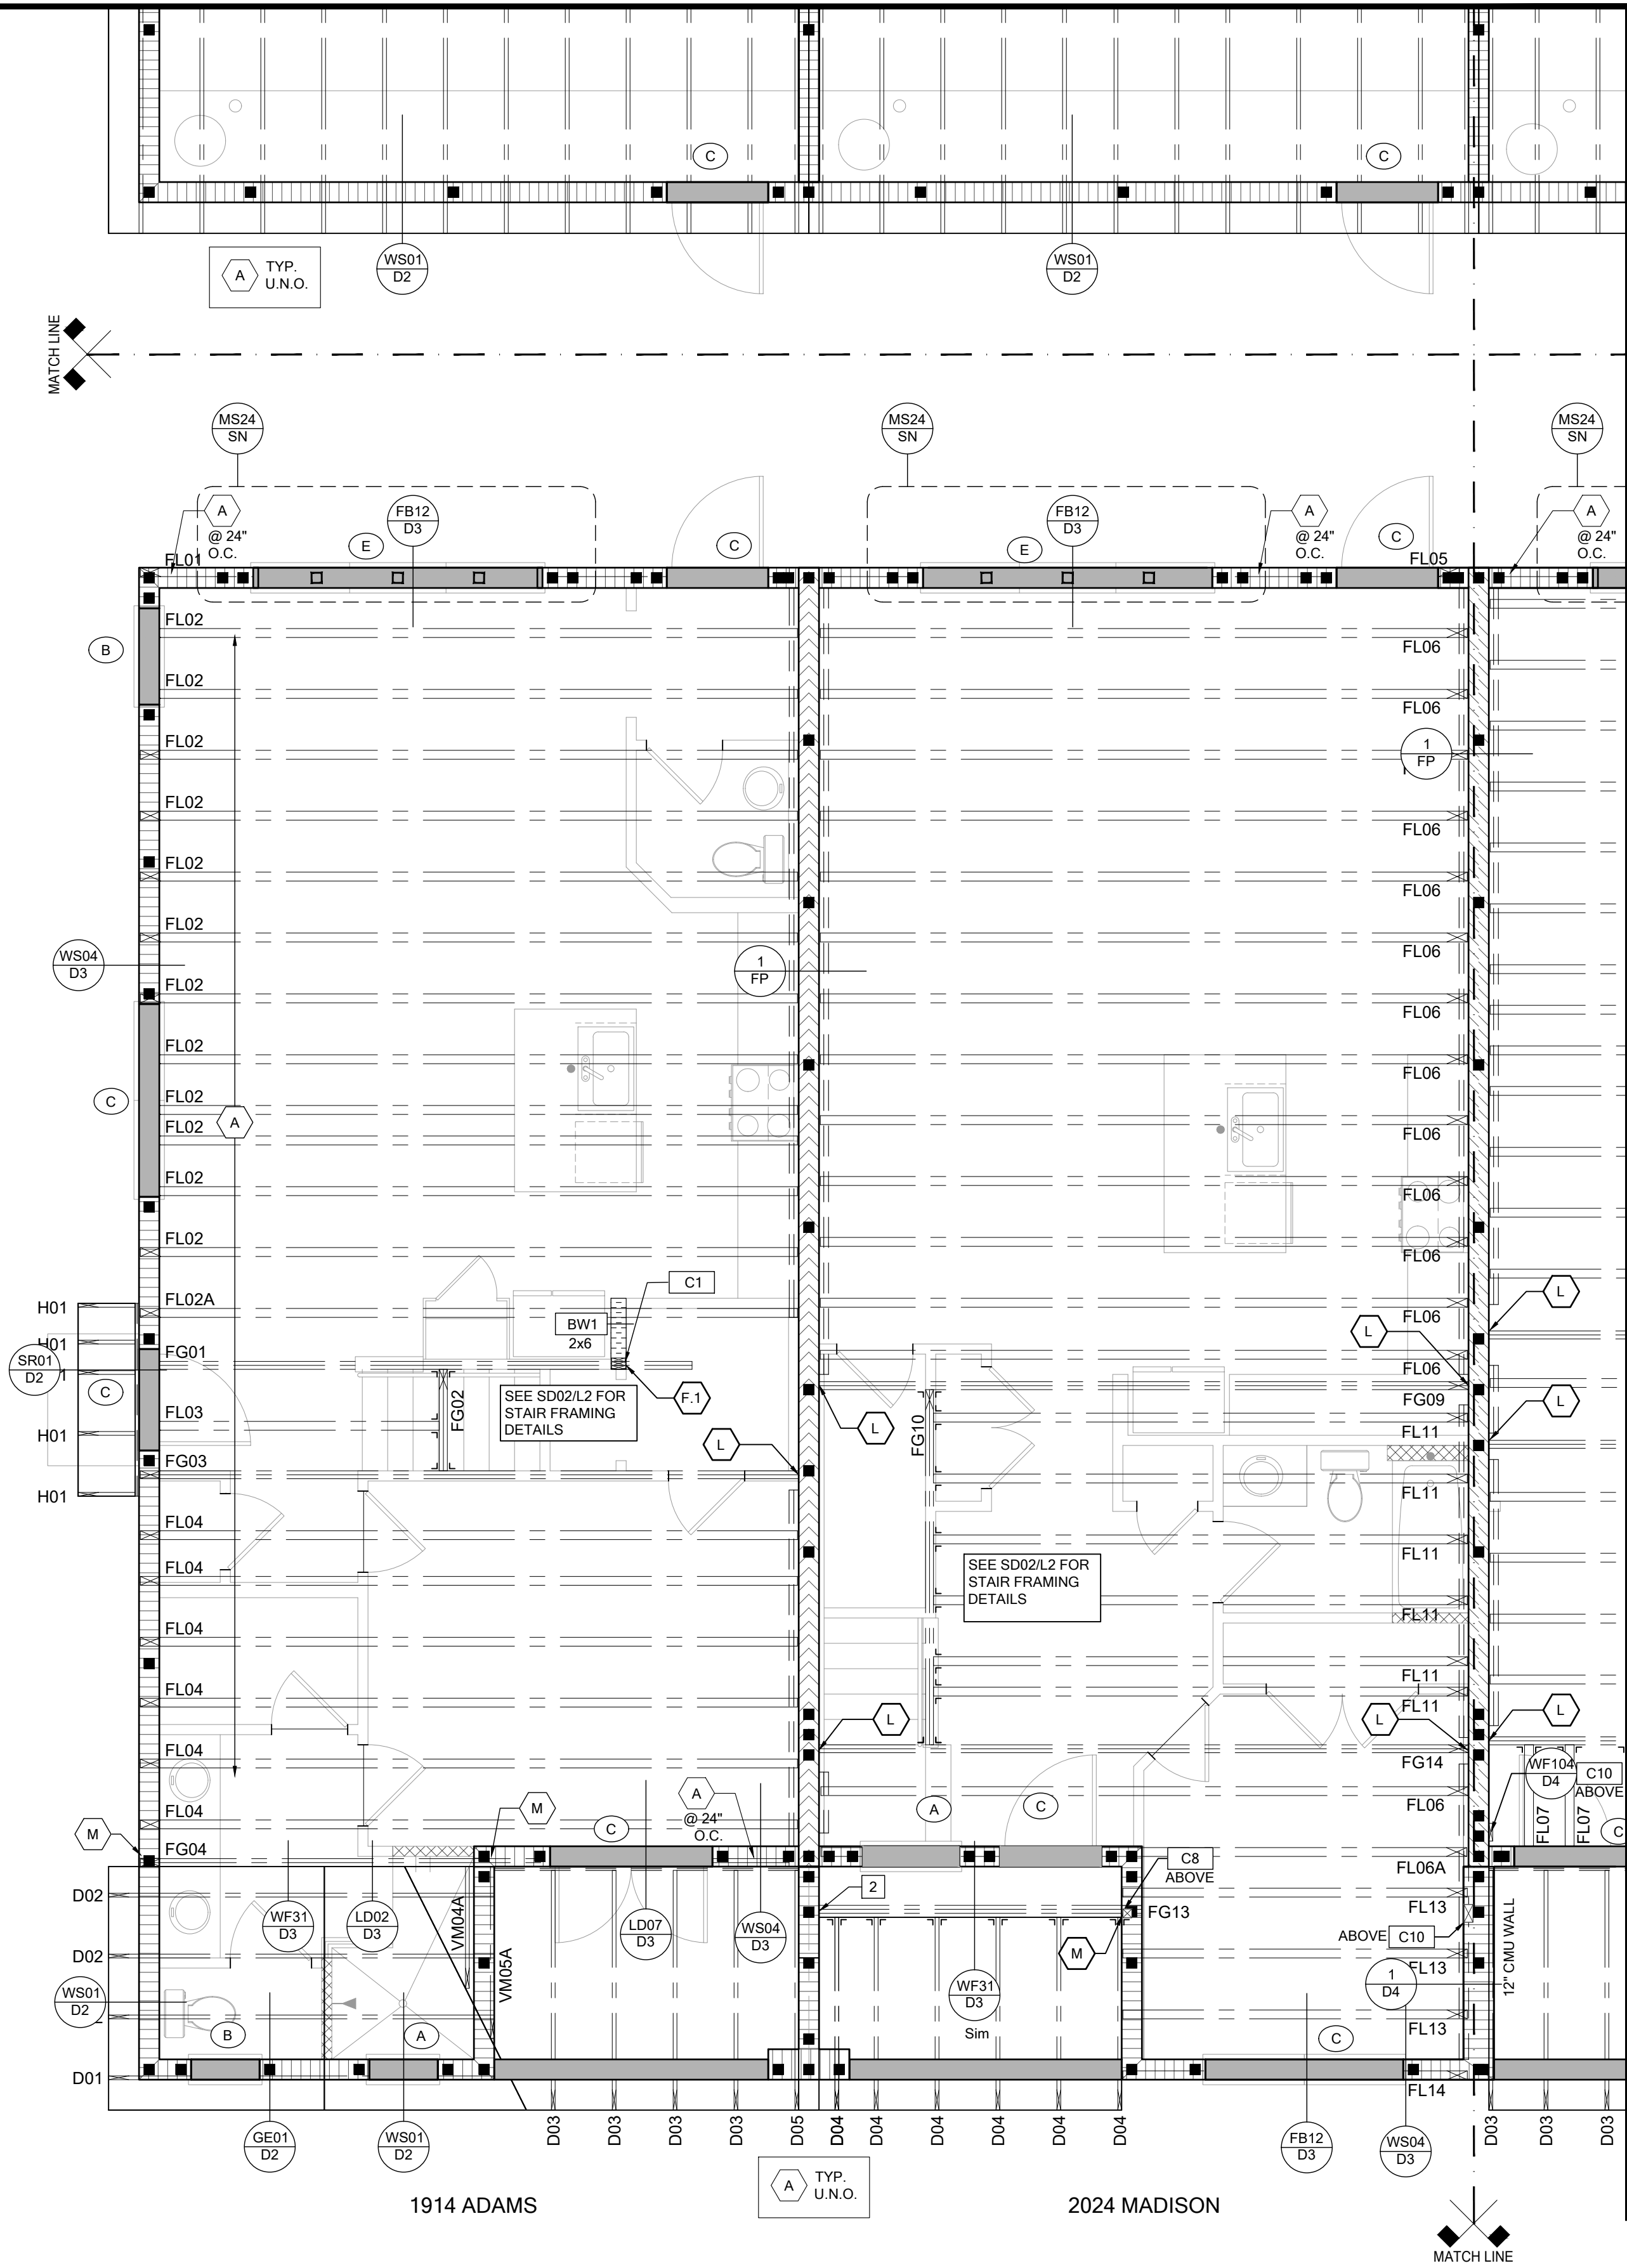ROOF NAILING SCHEDULE/ NAILING ZONES (SHINGLE AND TILE):  
ZONE 1: ASTM F1667 RSR-01 (8d) NAILS @ 6" O.C. ON EDGE AND 6" O.C. IN FIELD  
ZONE 2a, 2n, 2r: ASTM F1667 RSR-01 (8d) NAILS @ 4" O.C. ON EDGE AND 4" O.C. IN FIELD  
ZONE 3, 3a, 3r: ASTM F1667 RSR-01 (8d) NAILS @ 4" O.C. ON EDGE AND 4" O.C. IN FIELD  
ROOF SHEATHING:  
SHINGLE: 7/16" EXP. 1 (E<sub>2</sub>) or 1 1/2" EXP. 1 (E<sub>2</sub>)  
TILE: 1 1/2" EXP. 1 (E<sub>2</sub>)  
NOTE:  
1. PER CODE ASTM F1667 RSR-01 REFERENCE TO 8d (2 3/4" x 0.113") NAILS  
2. WHERE THE SHEATHING THICKNESS IS GREATER THAN 1 1/2", SHEATHING SHALL BE FASTENED WITH ASTM F1667 RSR-03 10d (2 1/2" x 0.131") NAILS OR ASTM F1667 RSR-04 (3" x 120") NAILS  
3. GABLES- DROP GABLE END & (1) ADDITIONAL DROPPED TRUSS 2x4 #2 SYP OUTLOOKER RAFTER W/ BLOCKING @ 16" O.C. IF NO DROPPED GABLE END. ATTACH 2x4 #2 SYP BLOCKING @ 16" O.C. FIRST 4 BAYS WITH (2) 12d NAILS EA. END. ATTACH ROOF SHEATHING TO RAFTERS W/ BLOCKING PER NAILING SCHEDULE.  
HIP ROOF >20 TO 27 DEG.  
[4:12]-[6:12]  
  
GABLE ROOF > 20 TO 27 DEG.  
[4:12]-[6:12]

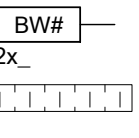



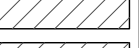


SYMBOL	DESIGN DESCRIPTION
	INDICATES BEARING WALL SEE BEARING WOOD BEARING SCHEDULE ON SN, SEE ARCHITECTURAL PLANS FOR WALL WIDTH, 2x4 MINIMUM U.O.N.
	INDICATES PERFORATED SHEAR WALL, SEE ARCHITECTURAL PLANS FOR WALL WIDTH, 2x4 MINIMUM U.O.N.
	INDICATES BUILT UP COLUMN, SEE FRAMING PLAN FOR SIZE, DETAIL WF37/SN FOR PLY ATTACHMENT AND UPLIFT CONNECTION SCHEDULE ON SN FOR CONNECTION TO SLAB
	INDICATES NO BOTTOM CONNECTOR REQUIRED
	INDICATES UPLIFT CONNECTION CONSTRUCTED PER DETAIL UPLIFT CONNECTOR SCHEDULE ON SHEET SN
	INDICATES WINDOW PRESSURE - SEE S0 FOR MORE INFORMATION.
	INDICATES LINTEL PER LINTEL PLAN

- FRAMING NOTES:
- SEE WIND SPEED CHART ON S0 FOR WINDOW PRESSURES
  - AT SECOND FLOOR FOR TYPICAL CORNER FRAMING SEE DETAIL FB06/D3
- GENERAL NOTES:
- THE FRAMING PLAN SHOWN INDICATES THE "TRUSS SYSTEM" AND IS THE RESPONSIBILITY OF THE TRUSS SYSTEM ENGINEER (DESIGN PROFESSIONAL OF RECORD). THE TRUSS DESIGN ENGINEER (DELEGATED ENGINEER) HAS FINAL, RESONSIBILITY FOR EACH INDIVIDUAL TRUSS AND TRUSS PROFILE, AND IS TO SUBMIT A FINAL SET OF TRUSS ENGINEERING SIGNED AND SEALED TRUSS DRAWINGS TO DESIGN PROFESSIONAL OF RECORD FOR REVIEW PRIOR TO FABRICATION
  - ANY DISCREPANCY OR ERROR IN DIMENSIONS OR NOTES WITH IN THIS PLAN SHALL BE BROUGHT TO THE ATTENTION OF THE DESIGN PROFESSIONAL FOR CLARIFICATION PRIOR TO CONSTRUCTION.
  - SEE SHEET SN FOR DESIGN SCHEDULES AND NOTES: FOUNDATION SCHEDULE / COLUMN SCHEDULE / BEARING WALL SCHEDULE / BEAM SCHEDULE / HEADER SCHEDULE / CONNECTION SCHEDULE / FLOOR AND ROOF NOTES.

- PLAN KEY NOTES
- 12" SQ CMU COLUMN W/(2)#5 FULLY GROUTED
  - LGUM28-3-SDS CONNECTOR BY SIMPSON STRONG TIE w/(6) 3/8"x4" TITEN HD ANCHORS TO MASONRY AND (6) 1/4"x2-1/2" STRONG DRIVE SDS SCREWS

BUILDER NOTE:  
TRUSS LAYOUT, CONNECTORS & ENGINEERING BASED ON TRUSSES PROVIDED BY A-1 INDUSTRIES. PROJECT NAME CP5MU4 w/ TRUSS DESIGN DATED 4/24/23 IF THE TRUSS LAYOUT SHOWN DOES NOT MATCH THE TRUSS MANUFACTURERS LAYOUT AND DATE ABOVE

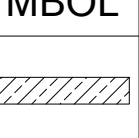-----STOP-----  
AND CALL THE ENGINEER OF RECORD PRIOR TO PLACEMENT OF ANY TRUSSES.

SYMBOL	DESIGN DESCRIPTION
	2x INTERIOR BEARING SHEARWALL - SEE BEARING WALL SCHEDULE ON SHEET SN FOR REQUIREMENTS.
	INDICATES BEARING WALL SEE BEARING WOOD BEARING SCHEDULE ON SN
	MASONRY WALL TOP @ 9'-4"
	MASONRY WALL TOP @ 10'-8" ABV. GRADE
	MASONRY WALL TOP @ 10'-8" ABV. GRADE

KEY PLAN

LOW ROOF & FLOOR FRAMING PLAN

SCALE: 1/4" = 1'-0"

title:

project no. 2023083

checked:

drawn: BA

date: 04-12-23

scale:

S2.1

B&A Design Studio, Inc.

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ph 407 829 8900  
fax 407 829 2040  
www.badesignstudios.com

N.C.B.D.C.

AL

AMERICAN INSTITUTE OF BUILDING DESIGN

www.FDSBENG.COM

FDS

ENGINEERING ASSOCIATES

288 Southhall Lane, Suite 200, Maitland, FL 32751  
Phone: 407-829-8900  
Fax: 407-829-2040  
Certificate of Authorization No. 9161  
□ CARL A. BROWN, PE, FL #45628  
□ SCOTT LEWIS, PE, FL #78790  
DATE: April 28, 2023

FDS JOB NO.:


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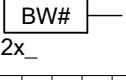
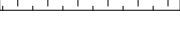
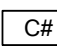
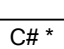



HORIZONS WEST

BABCOCK RANCH BLDG 6 (LOTS 6092-6099) 4 UNIT

NOTE: DRAWINGS ON 11"x17" SHEET WILL BE ONE HALF THE SCALE NOTED

The structural design of this building is in accordance with the FLORIDA BUILDING CODE 7TH EDITION (2020) RESIDENTIAL and is certified as such.

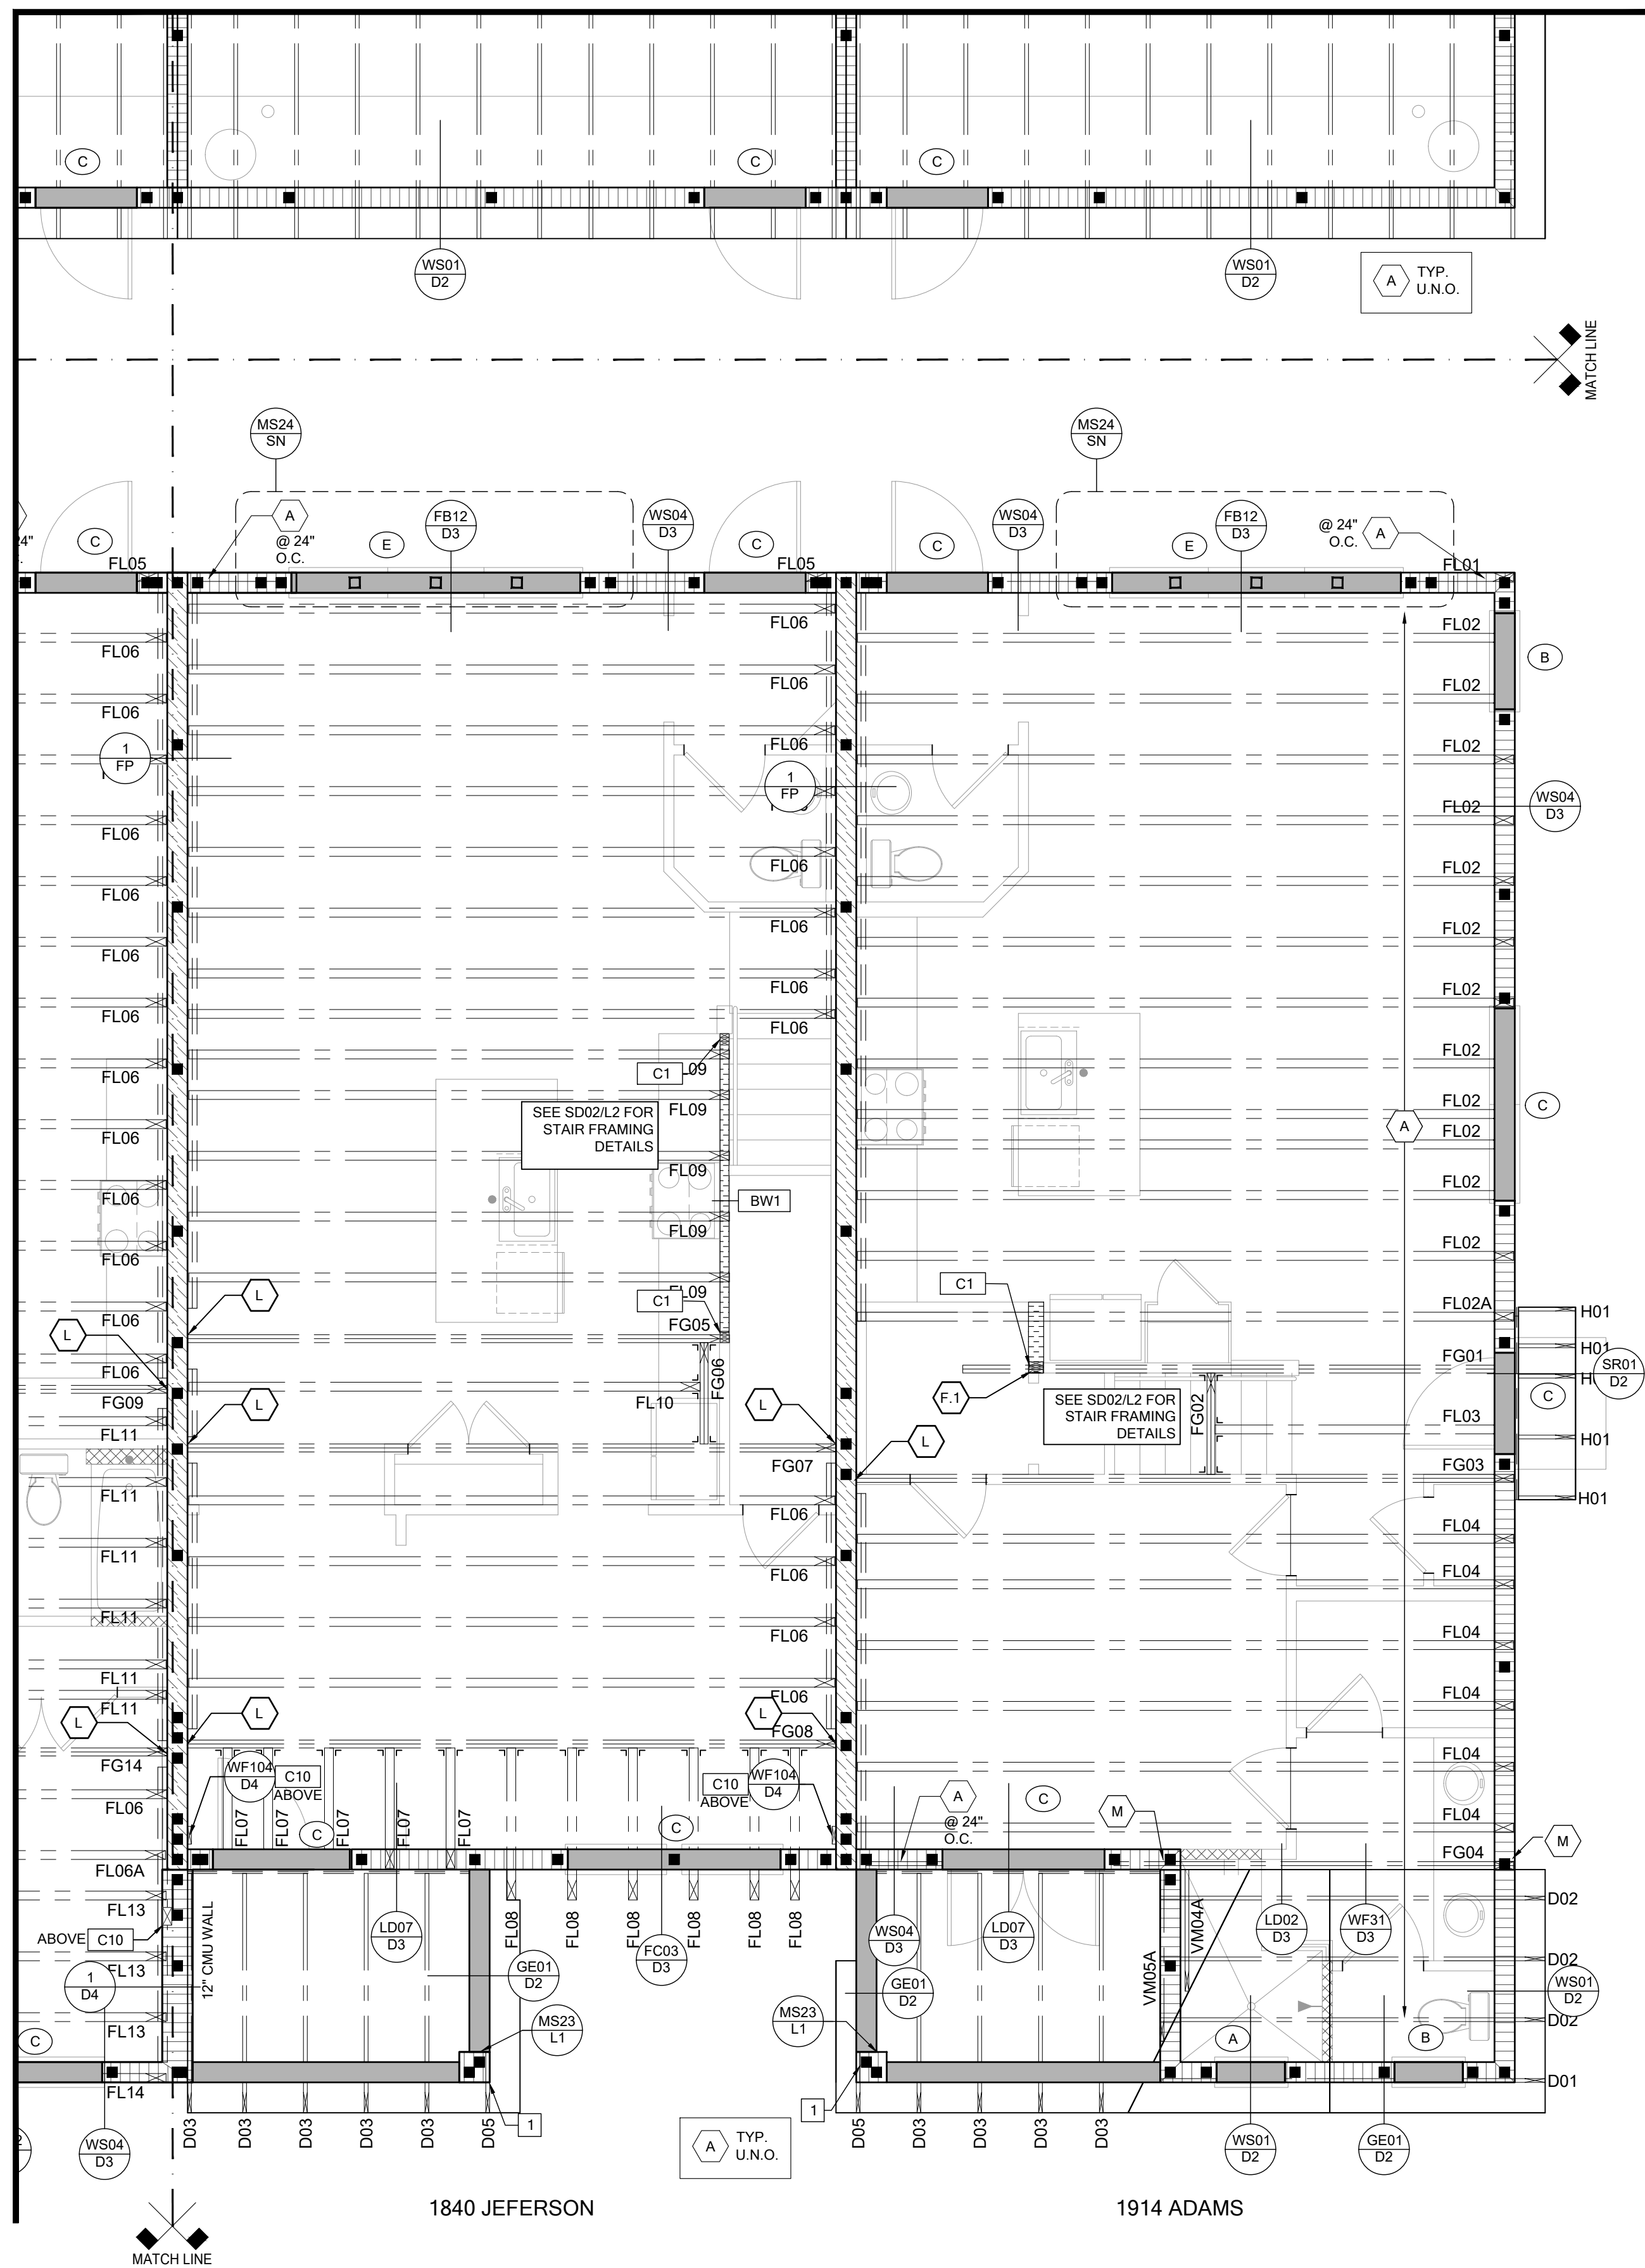[illegible]

SYMBOL	DESIGN DESCRIPTION
	INDICATES BEARING WALL. SEE BEARING WOOD BEARING SCHEDULE ON SN. SEE ARCHITECTURAL PLANS FOR WALL WIDTH, 2x4 MINIMUM U.O.N.
	INDICATES PERFORATED SHEAR WALL. SEE ARCHITECTURAL PLANS FOR WALL WIDTH, 2x4 MINIMUM U.O.N.
	INDICATES BUILT UP COLUMN. SEE FRAMING PLAN FOR SIZE. DETAIL WF37/SN FOR PLY ATTACHMENT AND UPLIFT CONNECTION SCHEDULE ON SN FOR CONNECTION TO SLAB
	INDICATES NO BOTTOM CONNECTOR REQUIRED
	INDICATES UPLIFT CONNECTION CONSTRUCTED PER DETAIL UPLIFT CONNECTOR SCHEDULE ON SHEET <b>SN</b>
	INDICATES WINDOW PRESSURE - SEE S0 FOR MORE INFORMATION.
	INDICATES LINTEL PER LINTEL PLAN

- FRAMING NOTES:**
1. SEE WIND SPEED CHART ON S0 FOR WINDOW PRESSURES
  2. AT SECOND FLOOR FOR TYPICAL CORNER FRAMING SEE DETAIL **FB06/D3**
- GENERAL NOTES:**
1. THE FRAMING PLAN SHOWN INDICATES THE "TRUSS SYSTEM" AND IS THE RESPONSIBILITY OF THE TRUSS SYSTEM ENGINEER (DESIGN PROFESSIONAL OF RECORD). THE TRUSS DESIGN ENGINEER (DELEGATED ENGINEER) HAS FINAL RESPONSIBILITY FOR EACH INDIVIDUAL TRUSS AND TRUSS PROFILE, AND IS TO SUBMIT A FINAL SET OF TRUSS ENGINEERING SIGNED AND SEALED TRUSS DETAILS TO DESIGN PROFESSIONAL OF RECORD FOR REVIEW PRIOR TO FABRICATION.
  2. ANY DISCREPANCY OR ERROR IN DIMENSIONS OR NOTES WITH IN THIS PLAN SHALL BE BROUGHT TO THE ATTENTION OF THE DESIGN PROFESSIONAL FOR CLARIFICATION PRIOR TO CONSTRUCTION.
  3. SEE SHEET SN FOR DESIGN SCHEDULES AND NOTES: FOR CONNECTION SCHEDULE / COLUMN SCHEDULE / BEARING WALL SCHEDULE / BEAM SCHEDULE / HEADER SCHEDULE / CONNECTION SCHEDULE / FLOOR AND ROOF NOTES.

## PLAN KEY NOTES

- 1 12" SQ CMU COLUMN W/(2)#5 FULLY GROUTED
- 2 LGUM28-3-SDS CONNECTOR BY SIMPSON STRONG TIE w/(6) 3/8"x4" TITEN HD ANCHORS TO MASONRY AND (6) 1/4"x2-1/2" STRONG DRIVE SDS SCREWS


BUILDER NOTE:

TRUSS LAYOUT, CONNECTORS & ENGINEERING BASED ON  
TRUSSES PROVIDED BY A-1 INDUSTRIES, PROJECT NAME  
CPSMU4 w/ TRUSS DESIGN DATED 4/24/23 IF THE TRUSS  
LAYOUT SHOWN DOES NOT MATCH THE TRUSS  
MANUFACTURERS LAYOUT AND DATE ABOVE

---STOP---

AND CALL THE ENGINEER OF RECORD PRIOR TO  
PLACEMENT OF ANY TRUSSES.

WALL TYPE	
SYMBOL	DESIGN DESCRIPTION
	2x. INTERIOR BEARING SHEARWALL - SEE BEARING WALL SCHEDULE ON SHEET SN FOR REQUIREMENTS.
	INDICATES BEARING WALL SEE BEARING WOOD BEARING SCHEDULE ON SN
	MASONRY WALL TOP @ 9'-4"
	MASONRY WALL TOP @ 10'-8" ABV. GRADE
	MASONRY WALL TOP @ 10'-8" ABV. GRADE

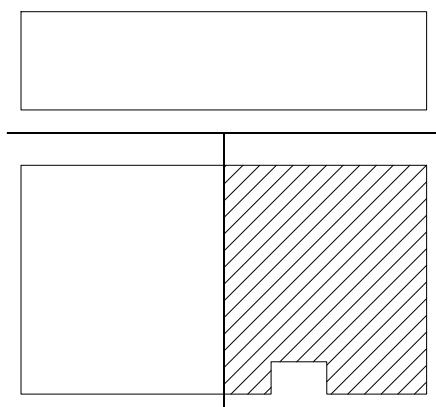

## KEY PLAN

## LOW ROOF & FLOOR FRAMING PLAN

SCALE: 1/4" = 1'-0"



**B&A Design  
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WWW.FDSSENG.COM

**FDS**  
ENGINEERING ASSOCIATES

258 Southhall Lane, Suite 200, Maitland, FL 32751  
O: 321-972-0491 F: 407-880-2304  
Certificate of Authorization No. 9161

☐ CARL A. BROWN, PE - FL # 56128  
☐ SCOTT LEWIKOWSKI, PE - FL # 971750  
☐

DATE: April 28, 2023

TO THE BEST OF MY KNOWLEDGE AND BELIEF, THE INFORMATION CONTAINED HEREIN IS TRUE AND CORRECT. I AM NOT PROVIDING ANY GUARANTEE, WARRANTY, OR REPRESENTATION THAT THE INFORMATION CONTAINED HEREIN IS TRUE AND CORRECT. I AM NOT PROVIDING ANY GUARANTEE, WARRANTY, OR REPRESENTATION THAT THE INFORMATION CONTAINED HEREIN IS TRUE AND CORRECT.


PARK SQUARE  
HORIZONS WEST  
BARBCKOCK RANCH BLDG 6 (LOTS 6092-6089) 4 UNIT








title:

project no. 2023083  
checked:  
drawn: BA  
date: 04-12-23  
scale:

## S2.2

NOTE: DRAWINGS ON 11"x17" SHEET WILL BE ONE HALF THE SCALE NOTED

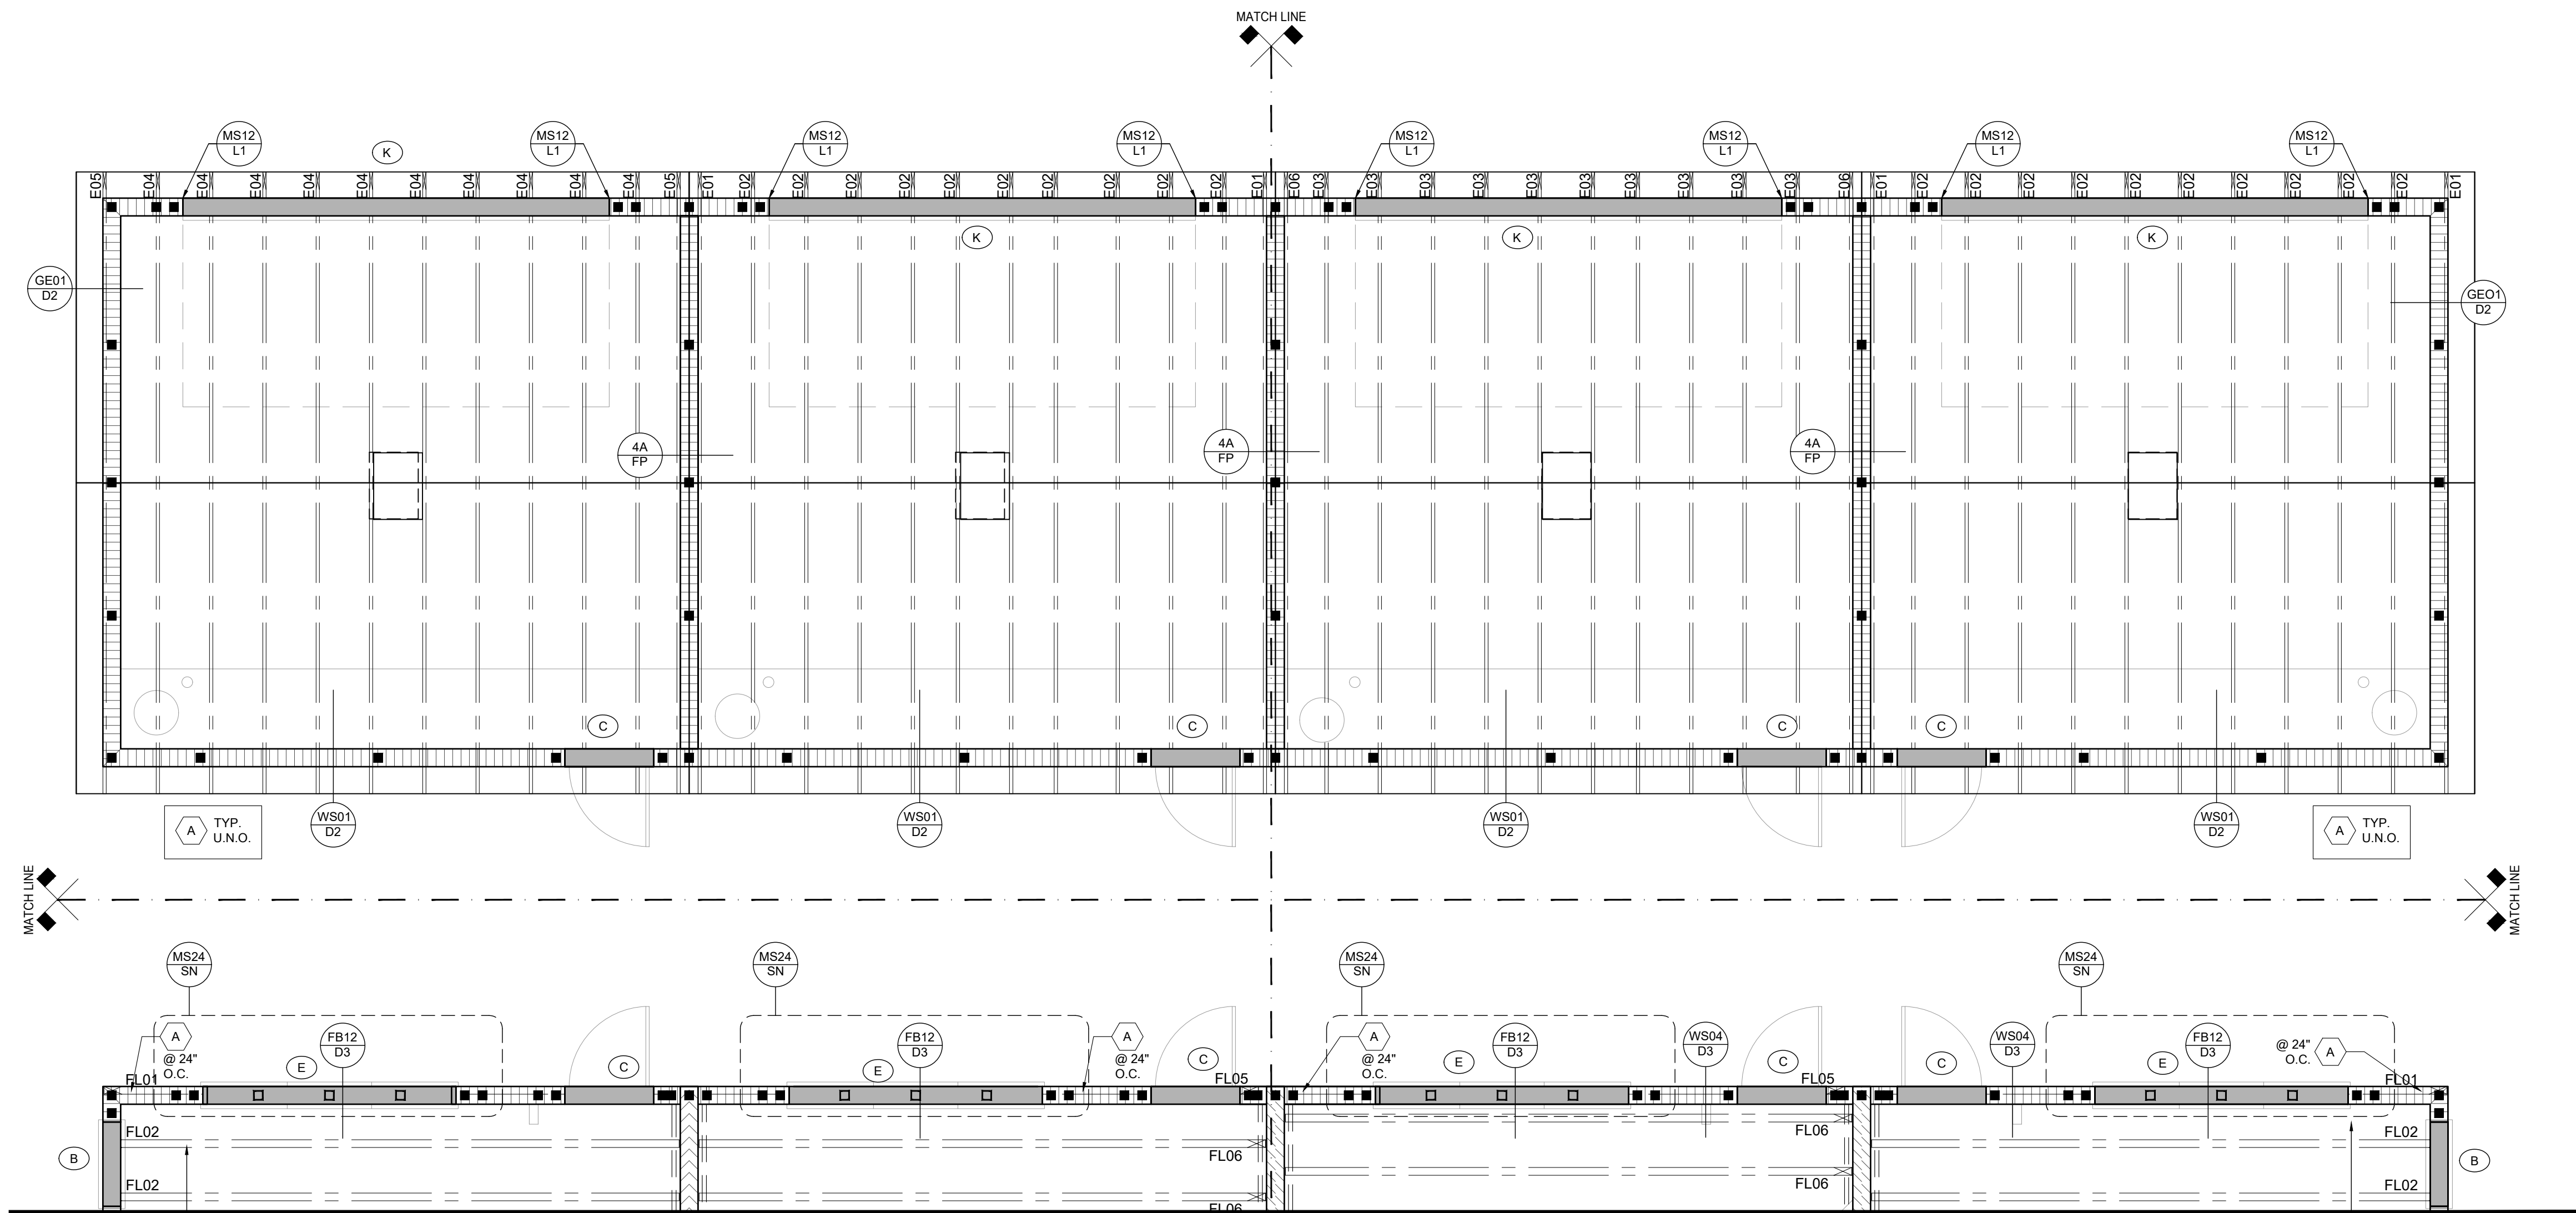

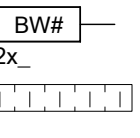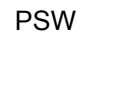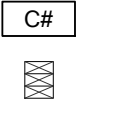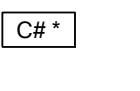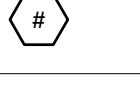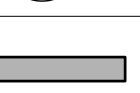SYMBOL	DESIGN DESCRIPTION
	INDICATES BEARING WALL SEE BEARING WOOD BEARING SCHEDULE ON SN, SEE ARCHITECTURAL PLANS FOR WALL WIDTH, 2x4 MINIMUM U.O.N.
	INDICATES PERFORATED SHEAR WALL, SEE ARCHITECTURAL PLANS FOR WALL WIDTH, 2x4 MINIMUM U.O.N.
	INDICATES BUILT UP COLUMN, SEE FRAMING PLAN FOR SIZE, DETAIL WF37/SN FOR PLY ATTACHMENT AND UPLIFT CONNECTION SCHEDULE ON SN FOR CONNECTION TO SLAB
	INDICATES NO BOTTOM CONNECTOR REQUIRED
	INDICATES UPLIFT CONNECTION CONSTRUCTED PER DETAIL UPLIFT CONNECTOR SCHEDULE ON SHEET SN
	INDICATES WINDOW PRESSURE - SEE S0 FOR MORE INFORMATION.
	INDICATES LINTEL PER LINTEL PLAN

- FRAMING NOTES:
- SEE WIND SPEED CHART ON S0 FOR WINDOW PRESSURES
  - AT SECOND FLOOR FOR TYPICAL CORNER FRAMING SEE DETAIL FB06/D3

- GENERAL NOTES:
- THE FRAMING PLAN SHOWN INDICATES THE "TRUSS SYSTEM" AND IS THE RESPONSIBILITY OF THE TRUSS SYSTEM ENGINEER (DESIGN PROFESSIONAL OF RECORD), THE TRUSS DESIGN ENGINEER (DELEGATED ENGINEER) HAS FINAL, RESPONSIBILITY FOR EACH INDIVIDUAL TRUSS AND TRUSS PROFILE, AND IS TO SUBMIT A FINAL SET OF TRUSS ENGINEERING SIGNED AND SEALED TRUSS DRAWINGS TO DESIGN PROFESSIONAL OF RECORD FOR REVIEW PRIOR TO FABRICATION
  - ANY DISCREPANCY OR ERROR IN DIMENSIONS OR NOTES WITH IN THIS PLAN SHALL BE BROUGHT TO THE ATTENTION OF THE DESIGN PROFESSIONAL FOR CLARIFICATION PRIOR TO CONSTRUCTION.
  - SEE SHEET SN FOR DESIGN SCHEDULES AND NOTES: FOUNDATION SCHEDULE / COLUMN SCHEDULE / BEARING WALL SCHEDULE / BEAM SCHEDULE / HEADER SCHEDULE / CONNECTION SCHEDULE / FLOOR AND ROOF NOTES.



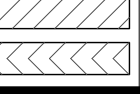


#### PLAN KEY NOTES


- 1 12" SQ CMU COLUMN W(2)#5 FULLY GROUTED

**BUILDER NOTE:**  
TRUSS LAYOUT, CONNECTORS & ENGINEERING BASED ON TRUSSES PROVIDED BY A-1 INDUSTRIES. PROJECT NAME CP5MU4 w/ TRUSS DESIGN DATED 4/24/23 IF THE TRUSS LAYOUT SHOWN DOES NOT MATCH THE TRUSS MANUFACTURERS LAYOUT AND DATE ABOVE

**---STOP---**

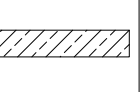AND CALL THE ENGINEER OF RECORD PRIOR TO PLACEMENT OF ANY TRUSSES.


SYMBOL	DESIGN DESCRIPTION
	2x_ INTERIOR BEARING SHEARWALL - SEE BEARING WALL SCHEDULE ON SHEET SN FOR REQUIREMENTS.
	INDICATES BEARING WALL SEE BEARING WOOD BEARING SCHEDULE ON SN
	MASONRY WALL TOP @ 9'-4"
	MASONRY WALL TOP @ 10'-8" ABV. GRADE
	MASONRY WALL TOP @ 10'-8" ABV. GRADE

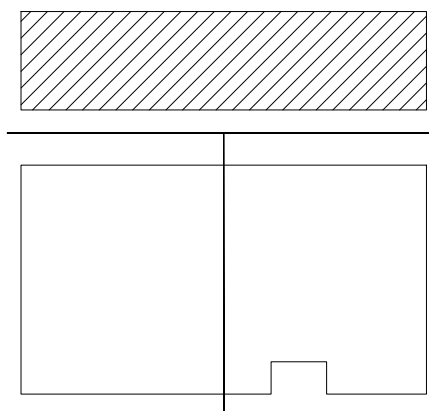


## KEY PLAN LOW ROOF & FLOOR FRAMING PLAN

SCALE: 1/4" = 1'-0"

RSH	ENGINEERED ROOF PER ASCE 7-16 ROOF DESIGN ALLOWABLE COMPONENTS AND CLADDING WIND PRESSURES AND SUCTIONS FOR MEAN ROOF HEIGHT ≤ 25 ft
WIND SPEED (ULTIMATE) WIND SPEED (ALLOWABLE) EXPOSURE CATEGORY	150.0 MPH 116.2 MPH C
EFFECTIVE WIND AREA (SQ FEET)	WIND PRESSURE AND SUCTION (PSF) (+) VALUE DENOTES PRESSURE (-) VALUE DENOTES SUCTION
AREA	ROOF 1 2e 2n 2r 3 3e 3r
10	HIP -43.90 -60.59 -60.59 -60.59 GABLE -43.86 -43.86 -69.97 -69.97 -69.97 -90.23
ROOF NAILING SCHEDULE/ NAILING ZONES (SHINGLE AND TILE):	
ZONE 1: ASTM F1667 RSR-01 (8d) NAILS @ 6" O.C. ON EDGE AND 6" O.C. IN FIELD	
ZONE 2e, 2n, 2r: ASTM F1667 RSR-01 (8d) NAILS @ 4" O.C. ON EDGE AND 4" O.C. IN FIELD	
ZONE 3, 3e, 3r: ASTM F1667 RSR-01 (8d) NAILS @ 4" O.C. ON EDGE AND 4" O.C. IN FIELD	
ROOF SHEATHING: SHINGLE: 7/16" EXP. 1 (2% <sub>16</sub> ) or 15/32" EXP. 1 (2% <sub>16</sub> )	
TILE: 15/32" EXP. 1 (2% <sub>16</sub> )	
NOTE: 1. PER CODE ASTM F1667 RSR-01 REFERENCE TO 8d (2 3/4" x 0.113") NAILS 2. WHERE THE SHEATHING THICKNESS IS GREATER THAN 15/32", SHEATHING SHALL BE FASTENED WITH ASTM F1667 RSR-03 10d (2 1/2" x 0.131") NAILS OR ASTM F1667 RSR-04 (3" x 0.120") NAILS 3. GABLES- DROP GABLE END & (1) ADDITIONAL DROPPED TRUSS 2x4 #2 SYP OUTLOOKER RAFTER W/ BLOCKING @ 16" O.C. IF NO DROPPED GABLE END, ATTACH 2x4 #2 SYP BLOCKING @ 16" O.C. FIRST 4 BAYS WITH (2) 12d NAILS EA. END, ATTACH ROOF SHEATHING TO RAFTERS W/ BLOCKING PER NAILING SCHEDULE.	

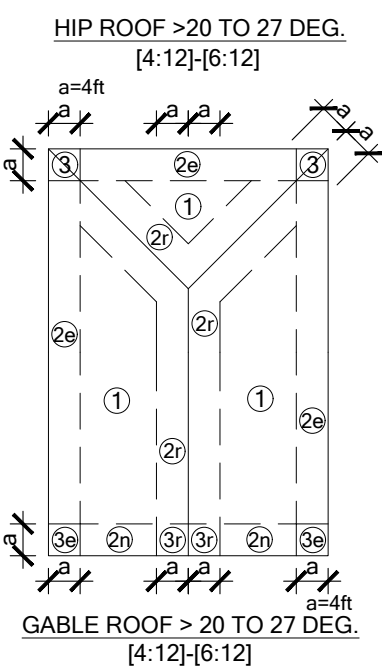

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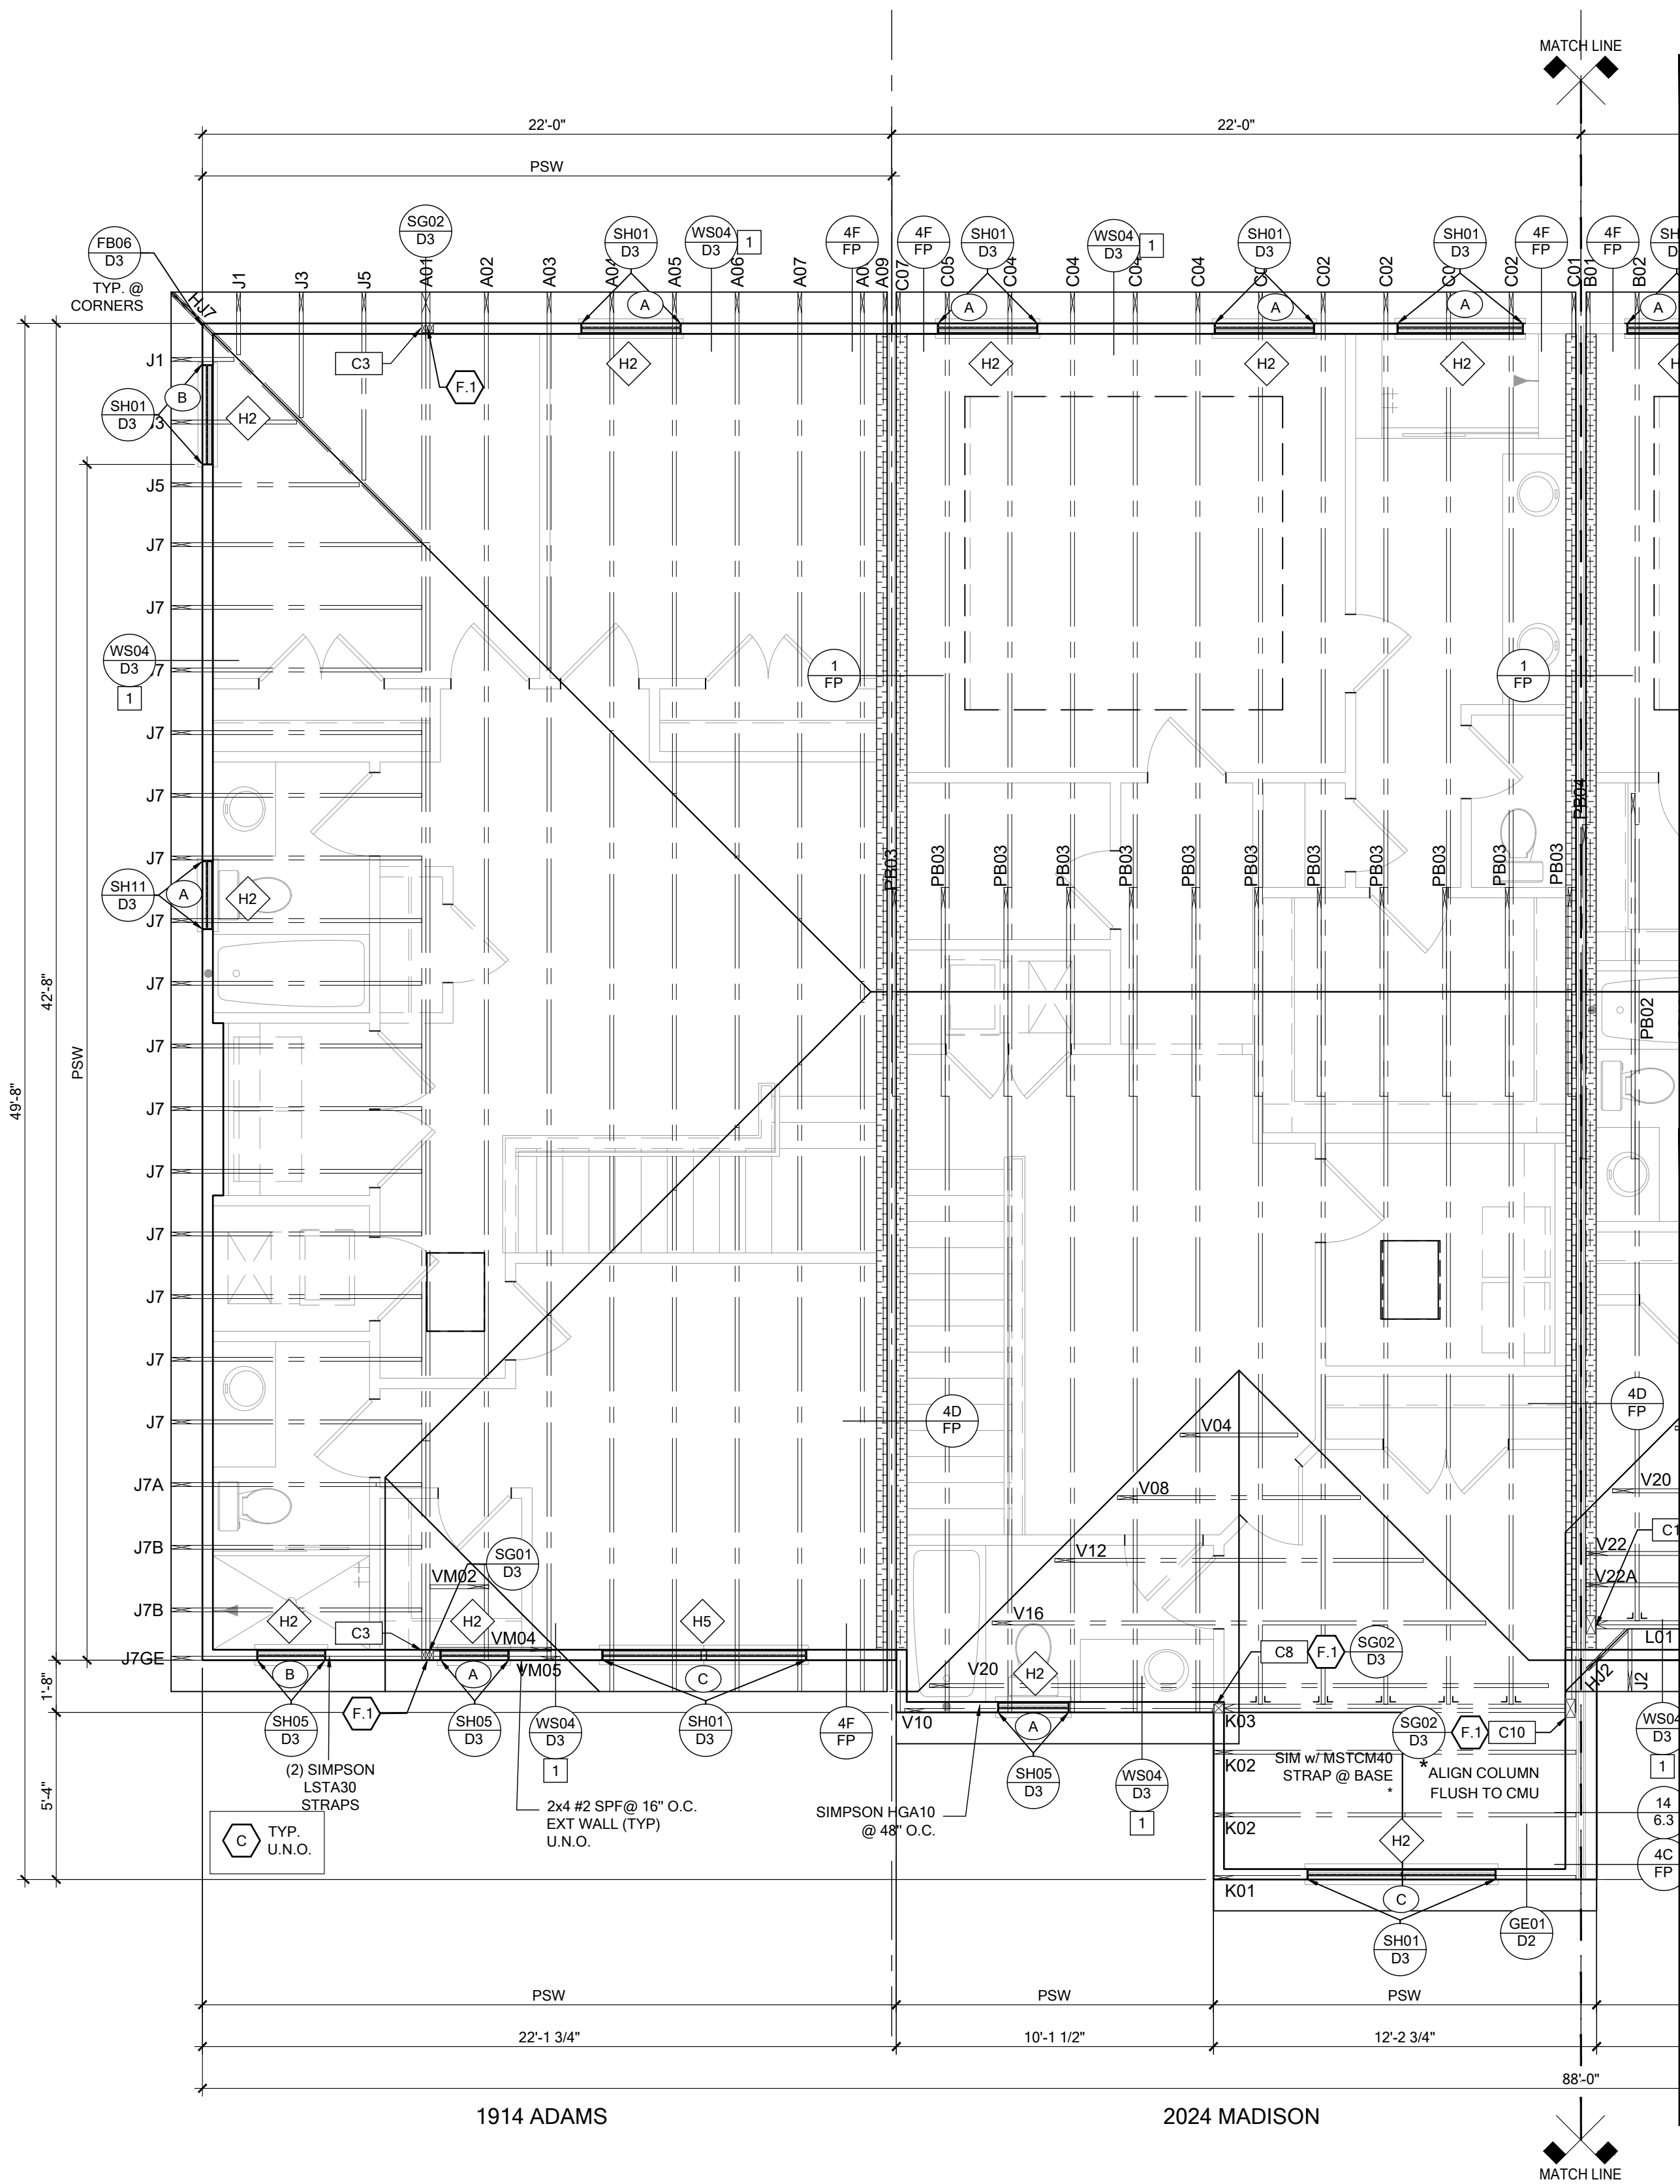
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258 Southhall Lane, Suite 200, Maitland, FL 32751  
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Certificate of Authorization No. 9191  
□ CARL A. BROWN, PE, FL #5628  
□ SCOTT LEWIS, PE, FL #78790  
DATE: April 28, 2023  
TO THE BEST OF THE ENGINEER'S KNOWLEDGE AND BELIEF, THE DESIGN, PLANS AND SPECIFICATIONS SHOWN ON THESE DRAWINGS COMPLY WITH THE STRUCTURAL REQUIREMENTS OF THE DRAWING.


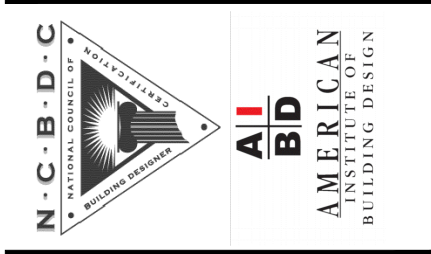

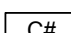
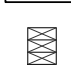
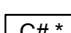
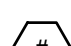


**PARK SQUARE  
HORIZONS WEST  
BABCOCK RANCH BLDG 6 (LOTS 6092-6099) 4 UNIT**

title:  
project no. 2023083  
checked:  
drawn: BA  
date: 04-12-23  
scale:

**S2.3**

NOTE: DRAWINGS ON 11"x17" SHEET WILL BE ONE HALF THE SCALE NOTED

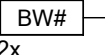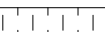[illegible]

SYMBOL	DESIGN DESCRIPTION
 	INDICATES BEARING WALL. SEE <u>BEARING WOOD BEARING SCHEDULE</u> ON <u>SN</u> , SEE ARCHITECTURAL PLANS FOR WALL WIDTH, 2x4 MINIMUM U.O.N.
	INDICATES PERFORATED SHEAR WALL, SEE ARCHITECTURAL PLANS FOR WALL WIDTH, 2x4 MINIMUM U.O.N.
 	INDICATES BUILT UP COLUMN, SEE FRAMING PLAN FOR SIZE, DETAIL WF37/SN FOR PLY ATTACHMENT AND UPLIFT CONNECTION SCHEDULE ON SN FOR CONNECTION TO SLAB
	INDICATES NO BOTTOM CONNECTOR REQUIRED
	INDICATES UPLIFT CONNECTION CONSTRUCTED PER DETAIL, UPLIFT CONNECTOR SCHEDULE ON SHEET <b>SN</b>
	INDICATES WINDOW PRESSURE - SEE S0 FOR MORE INFORMATION.
	INDICATES LINTEL PER LINTEL PLAN

- FRAMING NOTES:**
1. SEE WIND SPEED CHART ON 50 FOR WINDOW PRESSURES
  2. AT SECOND FLOOR FOR TYPICAL CORNER FRAMING SEE DETAIL **FB06/03**
- GENERAL NOTES:**
1. THE FRAMING PLAN SHOWN INDICATES THE "TRUSS SYSTEM ENGINEER" AND THE RESPONSIBILITY OF THE TRUSS SYSTEM ENGINEER (DESIGN PROFESSIONAL OF RECORD), THE TRUSS DESIGN ENGINEER (DELEGATED ENGINEER) HAS FINAL RESPONSIBILITY FOR EACH INDIVIDUAL TRUSS AND TRUSS PROFILE, AND IS TO SUBMIT A FINAL SET OF TRUSS ENGINEERING SIGNED AND SEALED TRUSS DRAWINGS TO THE DESIGN PROFESSIONAL OF RECORD FOR REVIEW PRIOR TO FABRICATION.
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- SEE SHEET SN FOR DESIGN SCHEDULES AND NOTES:  
FOUNDER/IRON TO SCHEDULE / BEAM SCHEDULE / BEARING WALL SCHEDULE / BEAM SCHEDULE / HEADER SCHEDULE / CONNECTION SCHEDULE / FLOOR AND ROOF NOTES.

## PLAN KEY NOTES




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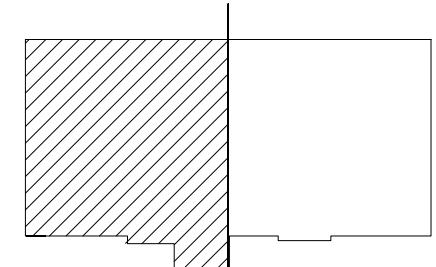
BUILDER NOTE:

TRUSS LAYOUT, CONNECTORS & ENGINEERING BASED ON  
TRUSSES PROVIDED BY A-1 INDUSTRIES, PROJECT NAME  
CPSMU4 w/ TRUSS DESIGN DATED 4/24/23 IF THE TRUSS  
LAYOUT SHOWN DOES NOT MATCH THE TRUSS  
MANUFACTURERS LAYOUT AND DATE ABOVE

---STOP---

AND CALL THE ENGINEER OF RECORD PRIOR TO  
PLACEMENT OF ANY TRUSSES.

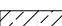WALL TYPE	
SYMBOL	DESIGN DESCRIPTION
	2x INTERIOR BEARING SHEARWALL - SEE <u>BEARING WALL SCHEDULE</u> ON SHEET SN FOR REQUIREMENTS.
	INDICATES BEARING WALL SEE <u>BEARING WOOD BEARING SCHEDULE</u> ON SN
	2x WOOD FRAME WALL @ 9'-0"



## KEY PLAN

# ROOF FRAMING PLAN

SCALE: 1/4" = 1'-0"



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Certificate of Authorization No. 9160

☐ CARL A. BROWN, PE - FL # 55126  
☐ SCOTT LEWOWSKI, PE - FL #78150  
☐

DATE: April 28, 2023

TO THE BEST OF THE ENGINEER'S KNOWLEDGE AND UNDERSTANDING, THE STRUCTURAL PLANS AND SPECIFICATIONS CONTAINED HEREIN WERE PREPARED BY OR UNDER THE CLOSE PERSONAL SUPERVISION AND TO THE BEST OF HIS KNOWLEDGE AND UNDERSTANDING, THE ENGINEER IS A LICENSED PROFESSIONAL ENGINEER IN THE STATE OF FLORIDA.


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HORIZONS WEST  
BABCOCK RANCH BLDG 6 (LOTS 6092-6089) 4 UNIT





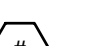


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project no. 2023083  
checked:  
drawn: BA  
date: 04-12-23  
scale:

# S3.1

NOTE: DRAWINGS ON 11"x17" SHEET WILL BE ONE HALF THE SCALE NOTED

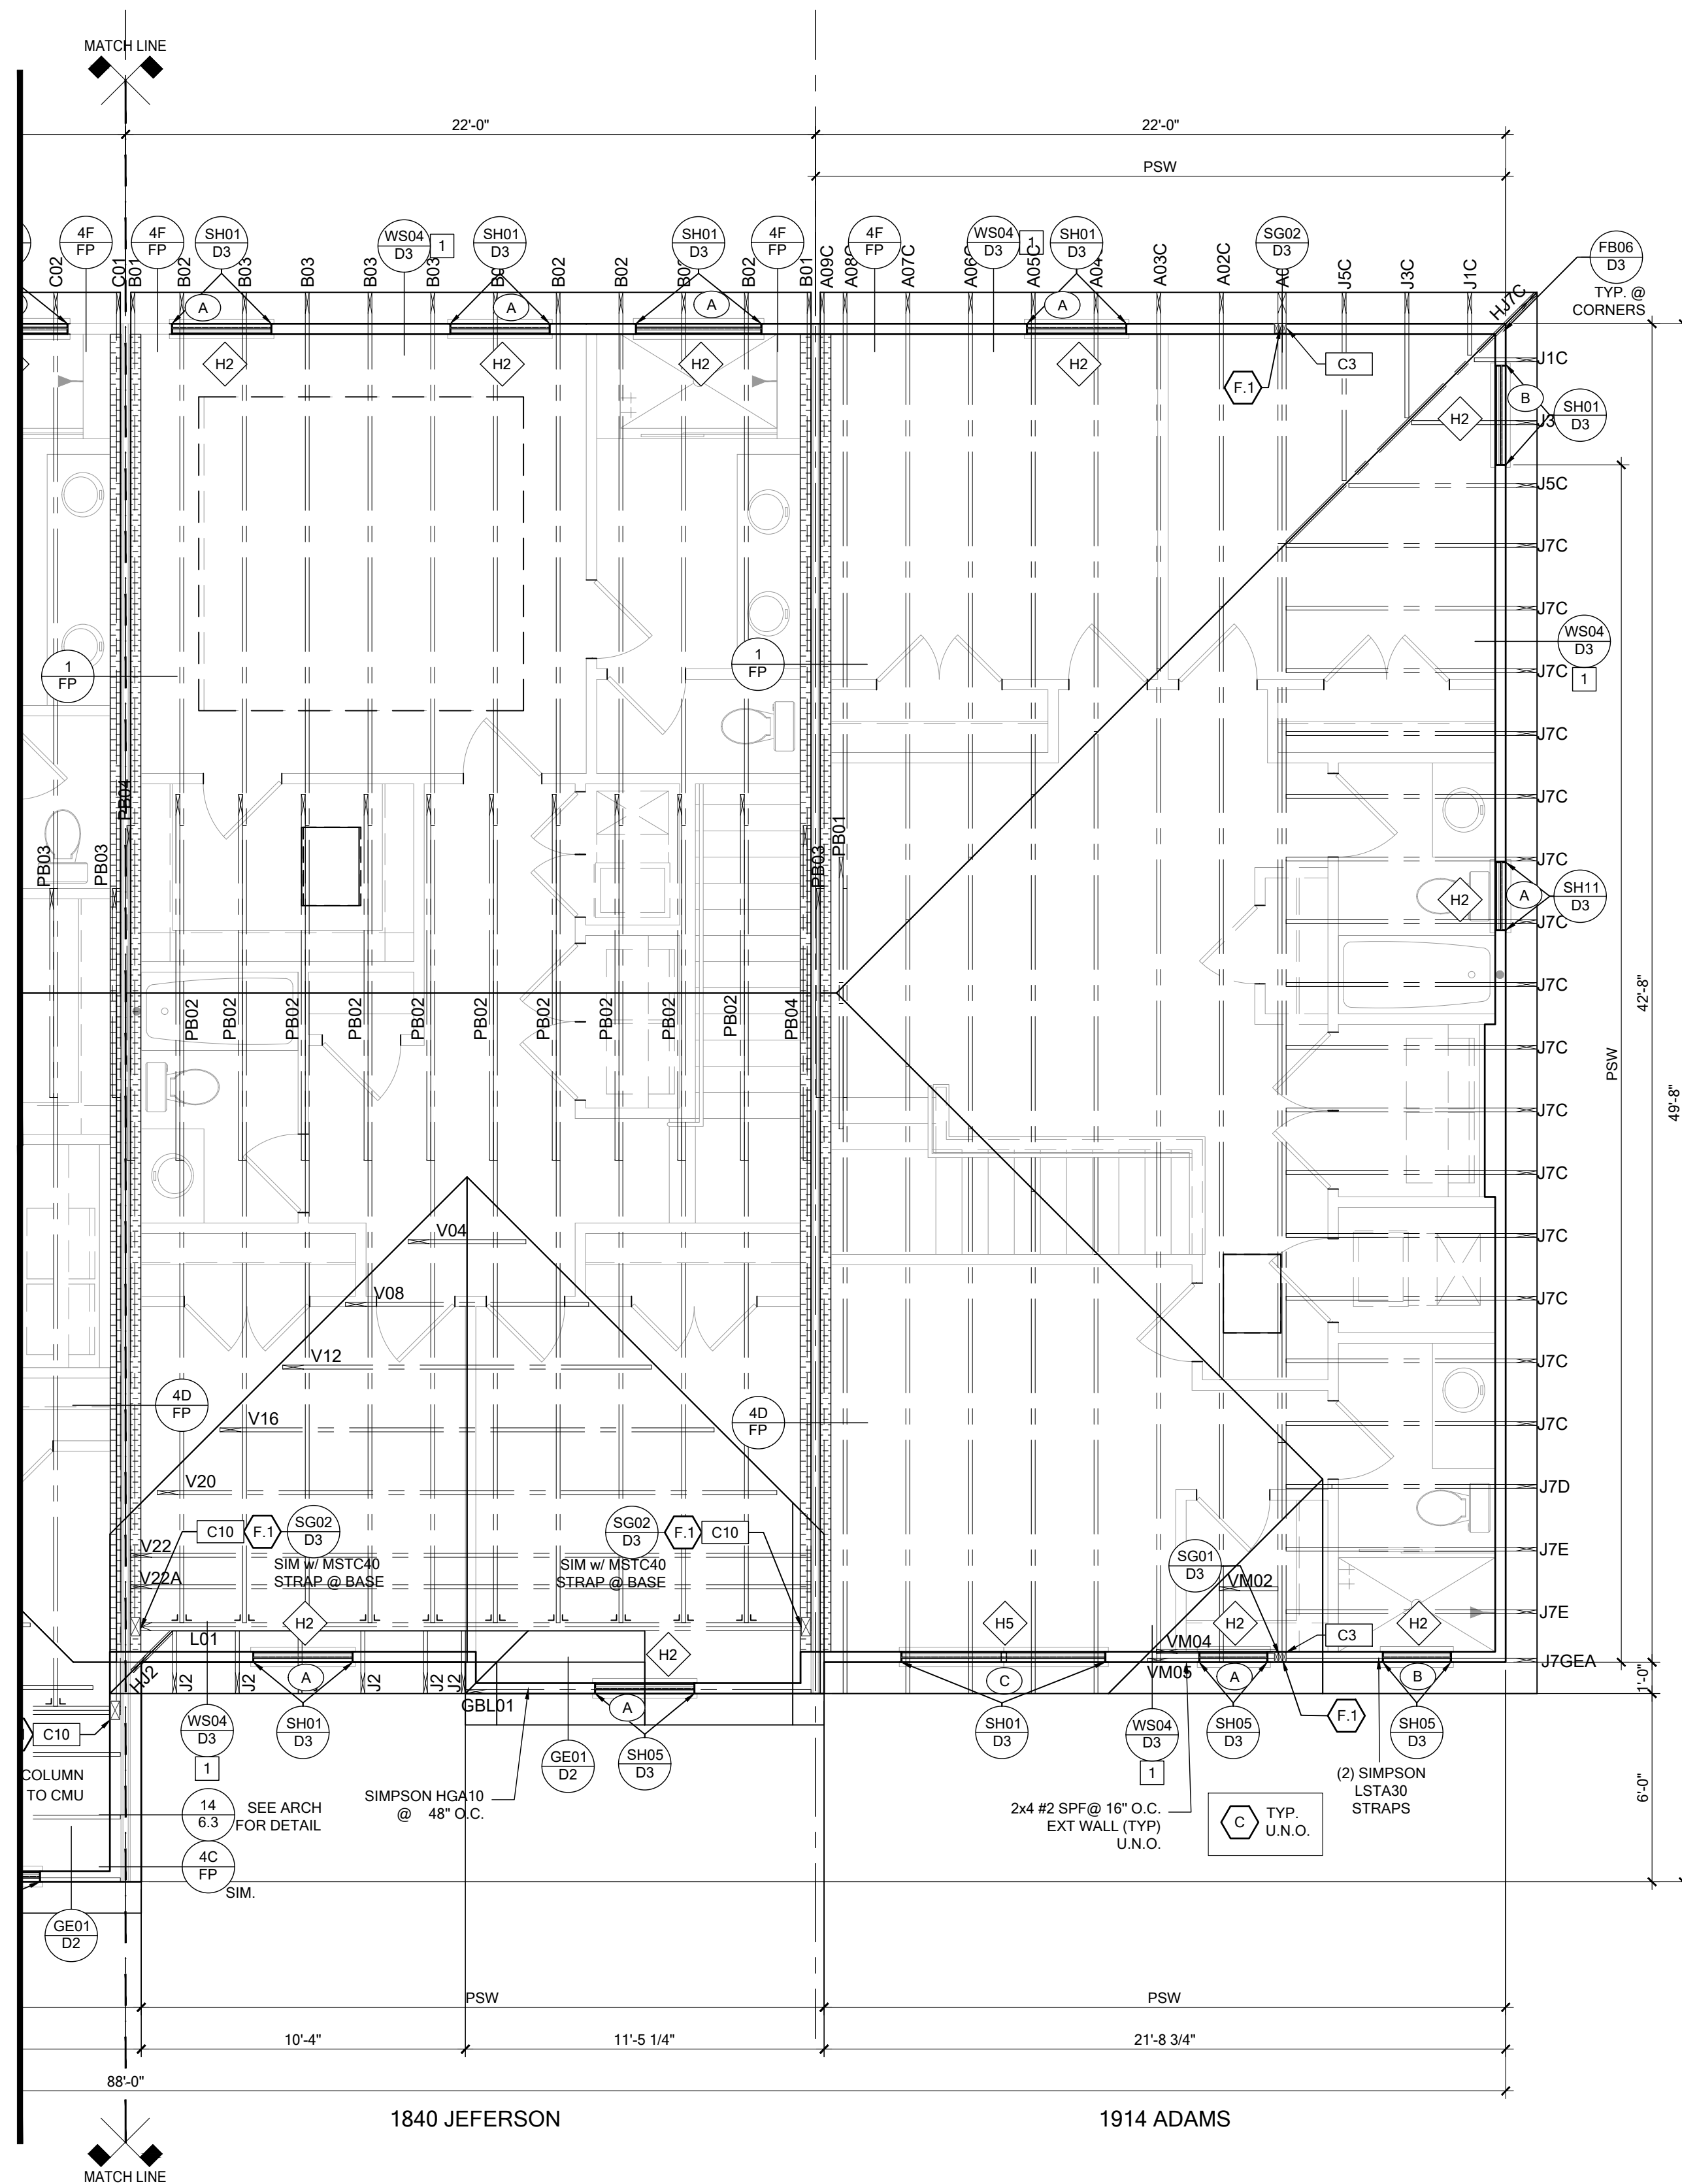[illegible]

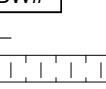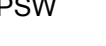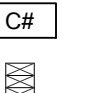SYMBOL	DESIGN DESCRIPTION
	INDICATES BEARING WALL. SEE BEARING WALL BEARING SCHEDULE ON SN. SEE ARCHITECTURAL PLANS FOR WALL WIDTH, 2x4 MINIMUM U.O.N.
	INDICATES PERFORATED SHEAR WALL. SEE ARCHITECTURAL PLANS FOR WALL WIDTH, 2x4 MINIMUM U.O.N.
	INDICATES BUILT UP COLUMN. SEE FRAMING PLAN FOR SIZE. DETAIL WF37/SN FOR PLY ATTACHMENT AND UPLIFT CONNECTION SCHEDULE ON SN FOR CONNECTION TO SLAB
	INDICATES NO BOTTOM CONNECTOR REQUIRED
	INDICATES UPLIFT CONNECTION CONSTRUCTED PER DETAIL UPLIFT CONNECTOR SCHEDULE ON SHEET <b>SN</b>
	INDICATES WINDOW PRESSURE - SEE S0 FOR MORE INFORMATION.
	INDICATES LINTEL PER LINTEL PLAN

- FRAMING NOTES:**
1. SEE WIND SPEED CHART ON S00 FOR WINDOW PRESSURES
  2. AT SECOND FLOOR FOR TYPICAL CORNER FRAMING SEE DETAIL **FB06/D3**
- GENERAL NOTES:**
1. THE FRAMING PLAN SHOWN INDICATES THE "TRUSS SYSTEM" AND IS THE RESPONSIBILITY OF THE TRUSS SYSTEM ENGINEER (DESIGN PROFESSIONAL OF RECORD), THE TRUSS DESIGN ENGINEER (DELEGATED ENGINEER) HAS FINAL RESPONSIBILITY FOR EACH INDIVIDUAL TRUSS AND TRUSS PROFILE, AND IS TO SUBMIT A FINAL SET OF TRUSS ENGINEERING SIGNED AND SEALED TRUSS DRAWINGS TO QUALIFY FOR A FINAL OF RECORD FOR REVIEW PRIOR TO FABRICATION.
  2. ANY DISCREPANCY OR ERROR IN DIMENSIONS OR NOTES WITH IN THIS PLAN SHALL BE BROUGHT TO THE ATTENTION OF THE DESIGN PROFESSIONAL FOR CLARIFICATION PRIOR TO CONSTRUCTION.
  3. SEE SHEET SN FOR DESIGN SCHEDULES AND NOTES:  
FOURTH FLOOR SCHEDULE / ROOF SCHEDULE / BEARING WALL SCHEDULE / BEAM SCHEDULE / HEADER SCHEDULE / CONNECTION SCHEDULE / FLOOR AND ROOF NOTES.

## PLAN KEY NOTES


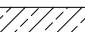
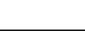
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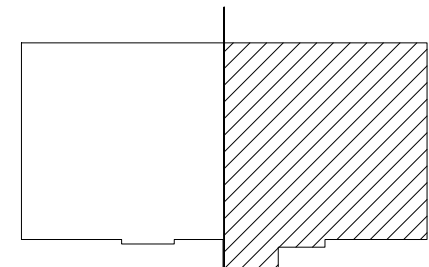
BUILDER NOTE:

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CPSMU4 w/ TRUSS DESIGN DATED 4/24/23 IF THE TRUSS  
LAYOUT SHOWN DOES NOT MATCH THE TRUSS  
MANUFACTURERS LAYOUT AND DATE ABOVE

---STOP---

AND CALL THE ENGINEER OF RECORD PRIOR TO  
PLACEMENT OF ANY TRUSSES.

WALL TYPE	
SYMBOL	DESIGN DESCRIPTION
	2x. INTERIOR BEARING SHEARWALL - SEE <u>WOOD BEARING SCHEDULE</u> ON SHEET SN FOR REQUIREMENTS.
	INDICATES BEARING WALL SEE <u>BEARING WOOD BEARING SCHEDULE</u> ON SN
	2x WOOD FRAME WALL @ 9'-0"



# KEY PLAN

# ROOF FRAMING PLAN

SCALE: 1/4" = 1'-0'



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☐ CARL A. BROWN, PE - FL #56126  
☐ SCOTT LEWKOWSKI, PE - FL #79150  
☐

**DATE:** April 28, 2023


TO THE BEST OF THE UNDERSIGNED ENGINEER'S KNOWLEDGE, THE STRUCTURAL PLANS AND SPECIFICATIONS ACCOMPANYING THESE PLANS COMPLY WITH THE CURRENT FLORIDA BUILDING CODE, AND THE ENGINEER HAS NO AWARENESS OF ANY FACTS OR CIRCUMSTANCES THAT WOULD CAUSE SUCH COMPLIANCE TO BE DECEITFUL OR MISLEADING.

PARK SQUARE  
HORIZONS WEST  
BABCOCK RANCH BLDG 6 (LOTS 6092-6089) 4 UNIT

project no.	2023083
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drawn:	BA
date:	04-12-23
scale:	

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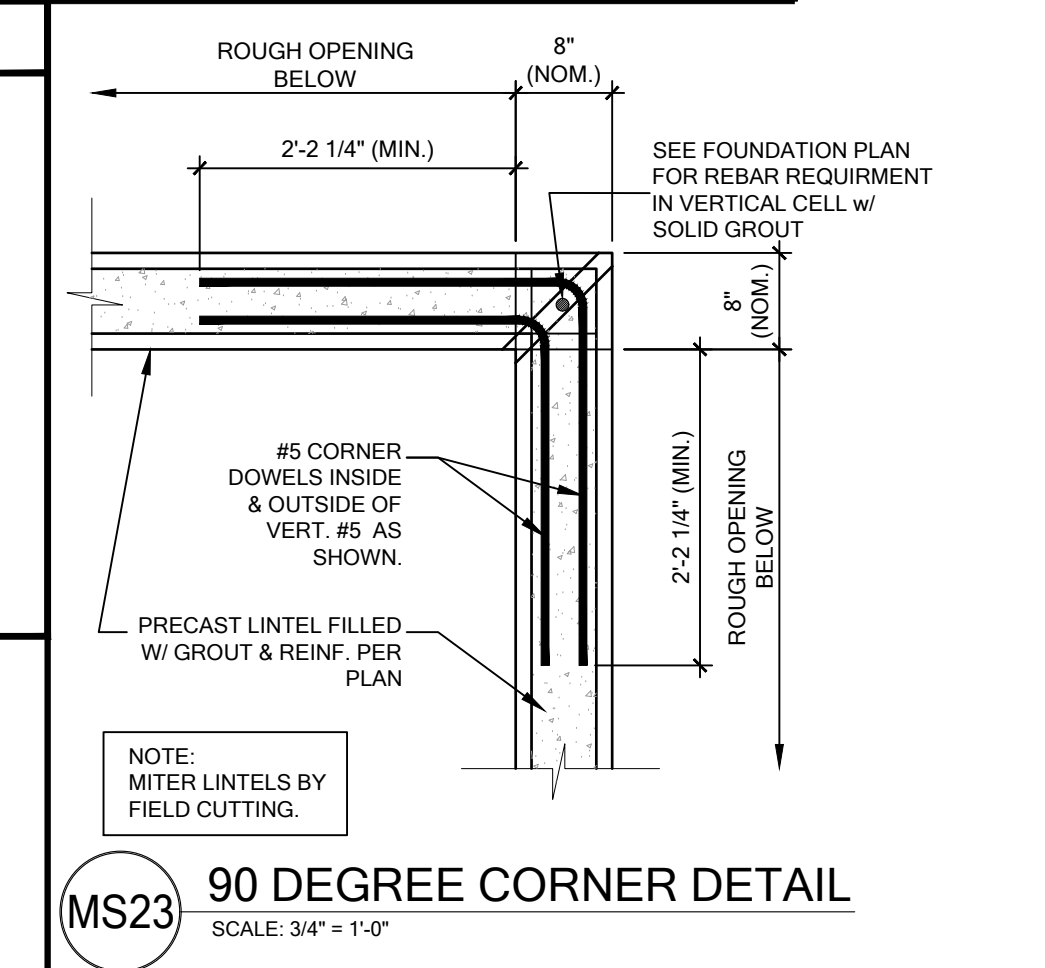
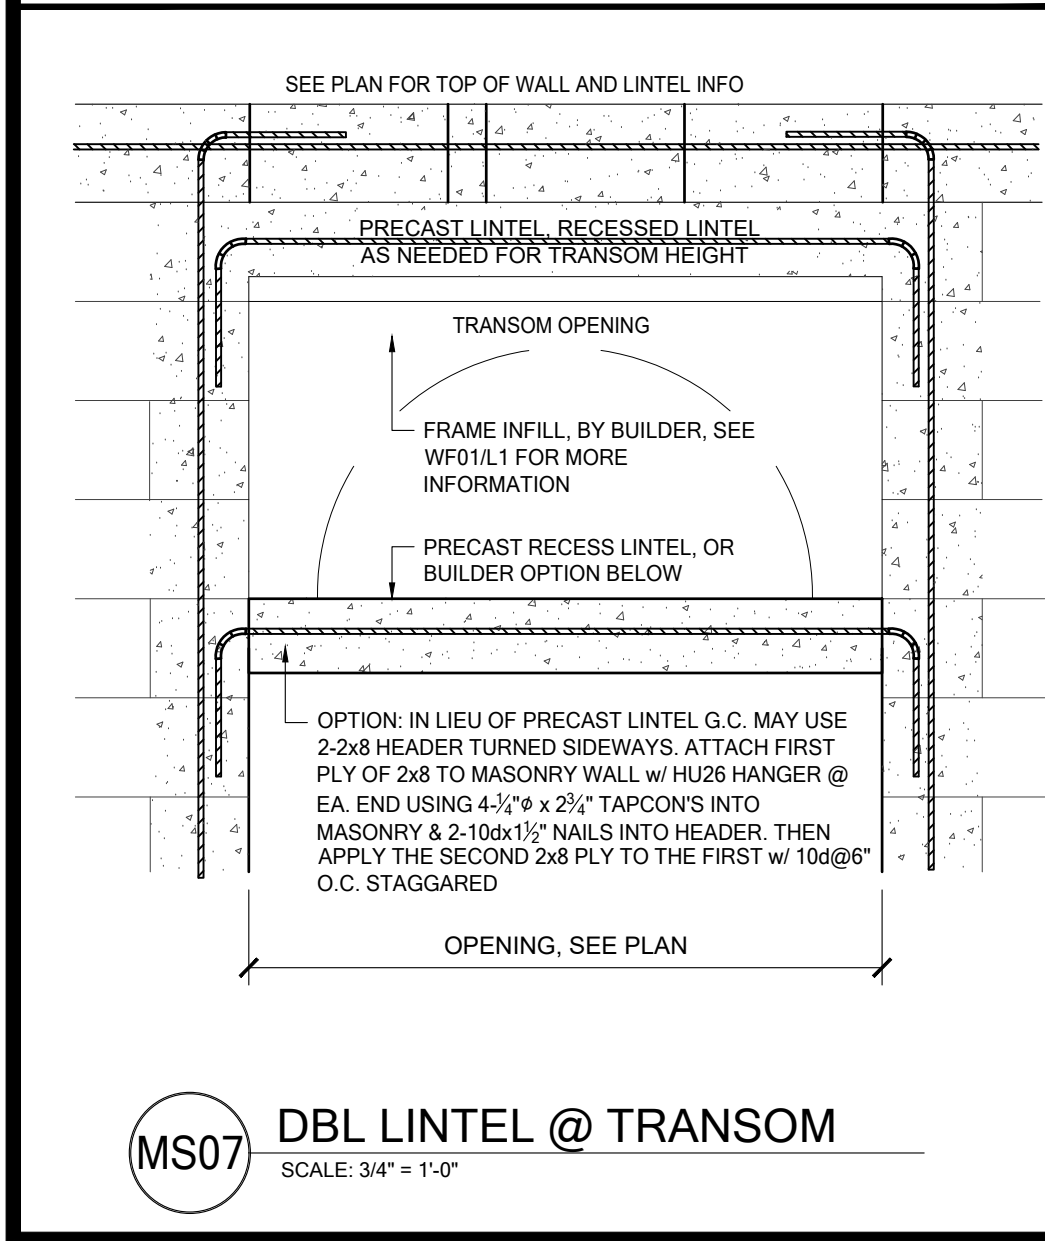
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**LINTEL DESIGNATION SCHEDULE**







MARK	LINTEL DESIGN	MARK	LINTEL DESIGN	MARK	LINTEL DESIGN
A	8RF6-0B/1T	H	8RF30-1B/1T	Q	8RF30-0B/1T
B	8F8-0B/1T	J	8F32-1B/1T	R	8F32-0B/1T
C	8RF14-1B/1T	K	8RF14-0B/1T	S	8F28-1B/1T
D	8F16-1B/1T	L	8F16-0B/1T	T	8F40-1B/1T
E	8F20-1B/1T	M	8F20-0B/1T	U	8F16-2B/2T
F	8RF22-1B/1T	N	8RF22-0B/1T	V	8F12-1B/1T
G	8F24-1B/1T	P	8F24-0B/1T		

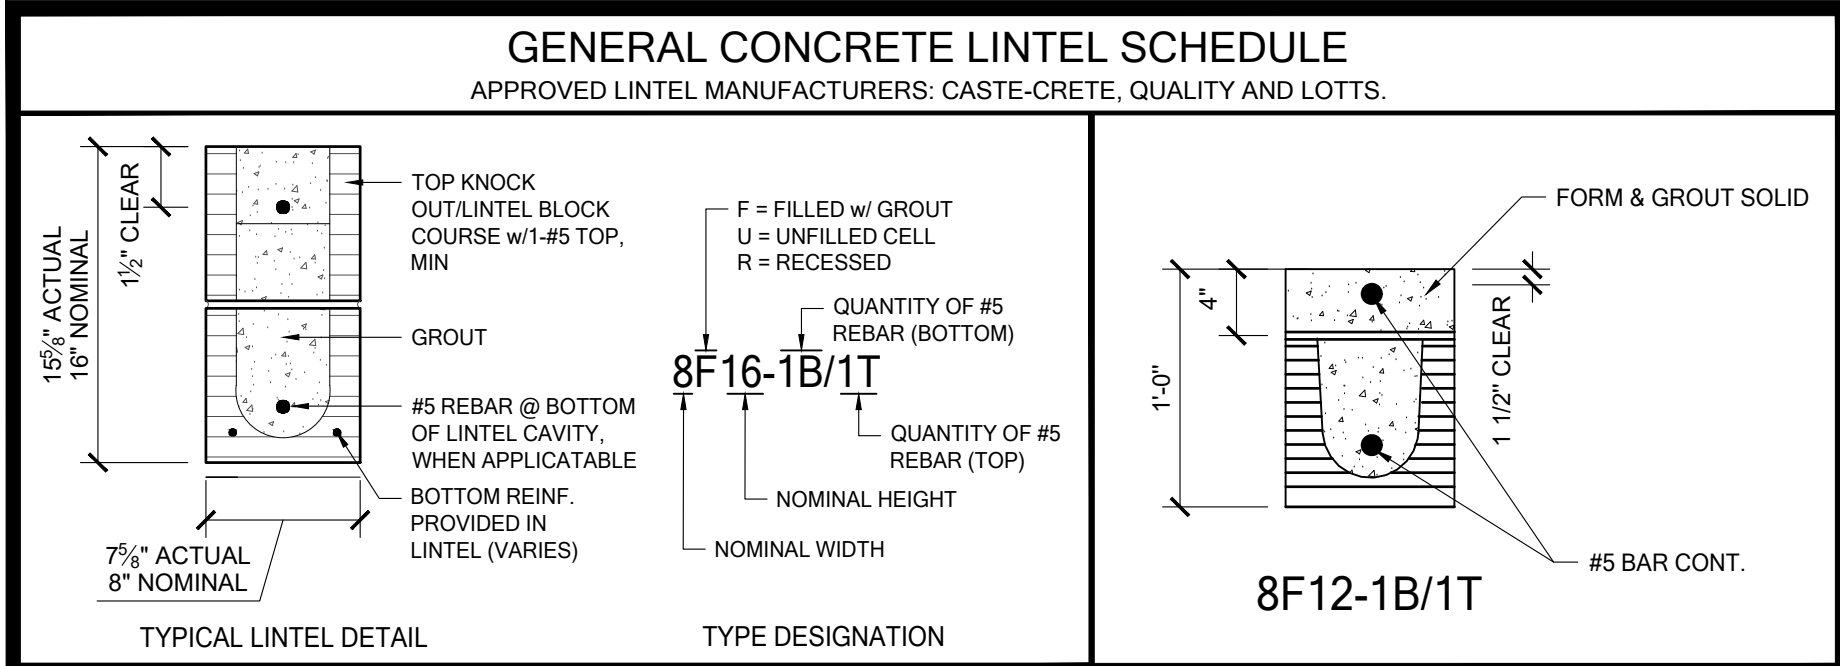- GENERAL INSTALLATION NOTES:**
1. PROVIDE FULL MORTAR HEAD AND BED JOINTS.
  2. SHARE FILLED LINTELS ARE REQUIRED
  3. INSTALLATION OF LINTEL MUST COMPLY w/ THE ARCHITECTURAL AND STRUCTURAL DRAWINGS
  4. LINTELS ARE LOCATED MANUFACTURED w/ 5/8" LONG NOTCHES AT THE END TO ACCOMMODATE VERTICAL CELL REINFORCING AND GROUTING.
  5. ALL LINTELS MEET OR EXCEED L360 VERTICAL DEFLECTION, EXCEPT LINTELS 17'-4" AND LONGER w/ NOMINAL HEIGHT OF 8" MEET OR EXCEED L180
  6. BOTTOM FIELD ADDED REBAR TO BE LOCATED AT THE BOTTOM OF THE LINTEL CAVITY
  7. 1/2" Ø WIRE STIRRUPS ARE WELDED TO THE BOTTOM STEEL FOR MECHANICAL ANCHORAGE
  8. CAST-IN-PLACE CONC. MAY BE PROVIDED IN COMPOSITE LINTELS IN LIEU OF CMU
  9. SAFE LOAD RATING BASED ON RATIONAL DESIGN ANALYSIS PER ACI 318 AND ACI 530
  10. FLORIDA APPROVAL NUMBER 158.1
  11. THE EXTERIOR SURFACE OF LINTELS INSTALLED IN EXTERIOR CONCRETE MASONRY WALLS SHALL HAVE A COATING OF STUCCO APPLIED IN ACCORDANCE WITH ASTM C-926 OR OTHER APPROVED COATING
  12. LINTELS LOADED SIMULTANEOUSLY w/ VERTICAL (GRAVITY AND UPLIFT) AND HORIZONTAL (LATERAL) LOADS SHOULD BE FOR COMBINE LOADING WITH THE FOLLOWING EQUATIONS:  
$$\frac{\text{APPLIED VERTICAL LOAD}}{\text{SAFE VERTICAL LOAD}} + \frac{\text{APPLIED HORIZONTAL LOAD}}{\text{SAFE HORIZONTAL LOAD}} \leq 1.0$$
- GENERAL MATERIAL NOTES:**
1. 7c PRECAST LINTEL = 3500 P.S.I.
  2. 7c PRESTRESSED LINTEL = 6000 P.S.I.
  3. GROUTED PER ASCM C476 Fg = 3000 P.S.I. w/ MAX 3/4" AGGREGATE AND 8" TO 11" SUMP
  4. CMU PER ASTM C90 w/ MIN NET AREA COMPRESSION STRENGTH = 2000 P.S.I
  5. REBAR PER ASTM A615 GRADE 60
  6. 270 LOW RELAXATION 1/2" WIRE PER ASTM A510
  7. MORTAR PER ASTM C270 TYPE M OR S
- GENERAL LINTEL NOTES:**
1. AREAS OF BLOCK ABV. MASONRY OPENINGS ARE TO BE GROUTED SOLID TO TIE BEAM.
  2. 1-#5 REBAR IN TIE BEAM IS TO BE CONT. THROUGH OUT INCLUDING ABV. MASONRY OPENINGS, U.N.O.
  3. ALL STANDARD LINTELS TO HAVE MIN. 4" BEARING EACH END BASED ON CAST CRETE, LOTT'S, AND QUALITY LINTEL SPECS.
  4. LINTEL MINIMUM DEPTHS ARE CALLED OUT ON LINTEL PLAN. IF CONTRACTOR INSTALLS A DEEPER LINTEL THAN INDICATED ON THE PLAN, DOING THIS INCREASES THE STRENGTH OF THE LINTEL AND IS APPROVED WITHOUT ENGINEERING LETTER. IF A SMALLER LINTEL IS INSTALLED CONTACT EOR FOR APPROVAL.
  5. (\*) ANY LINTEL DEEPER THAN 32" HAS BEEN VERIFIED TO WORK AS A MIN. 32" FOR THE LOAD CONDITIONS. ANY LINTEL GREATER THAN 32" HAS A GREATER CAPACITY AND THEREFORE IS ADEQUATE FOR THE LOADS
  6. G.C. TO VERIFY ALL LINTEL DIMENSIONS IN FIELD. DIMENSIONS SHOWN ARE CLEAR SPAN ONLY



**WALL TYPE**

SYMBOL	DESIGN DESCRIPTION
	2x INTERIOR BEARING SHEARWALL - SEE BEARING WALL SCHEDULE ON SHEET SN FOR REQUIREMENTS.
	INDICATES BEARING WALL SEE BEARING WOOD BEARING SCHEDULE ON SN
	MASONRY WALL TOP @ 9'-4"
	MASONRY WALL TOP @ 10'-8" ABV. GRADE
	MASONRY WALL TOP @ 10'-8" ABV. GRADE

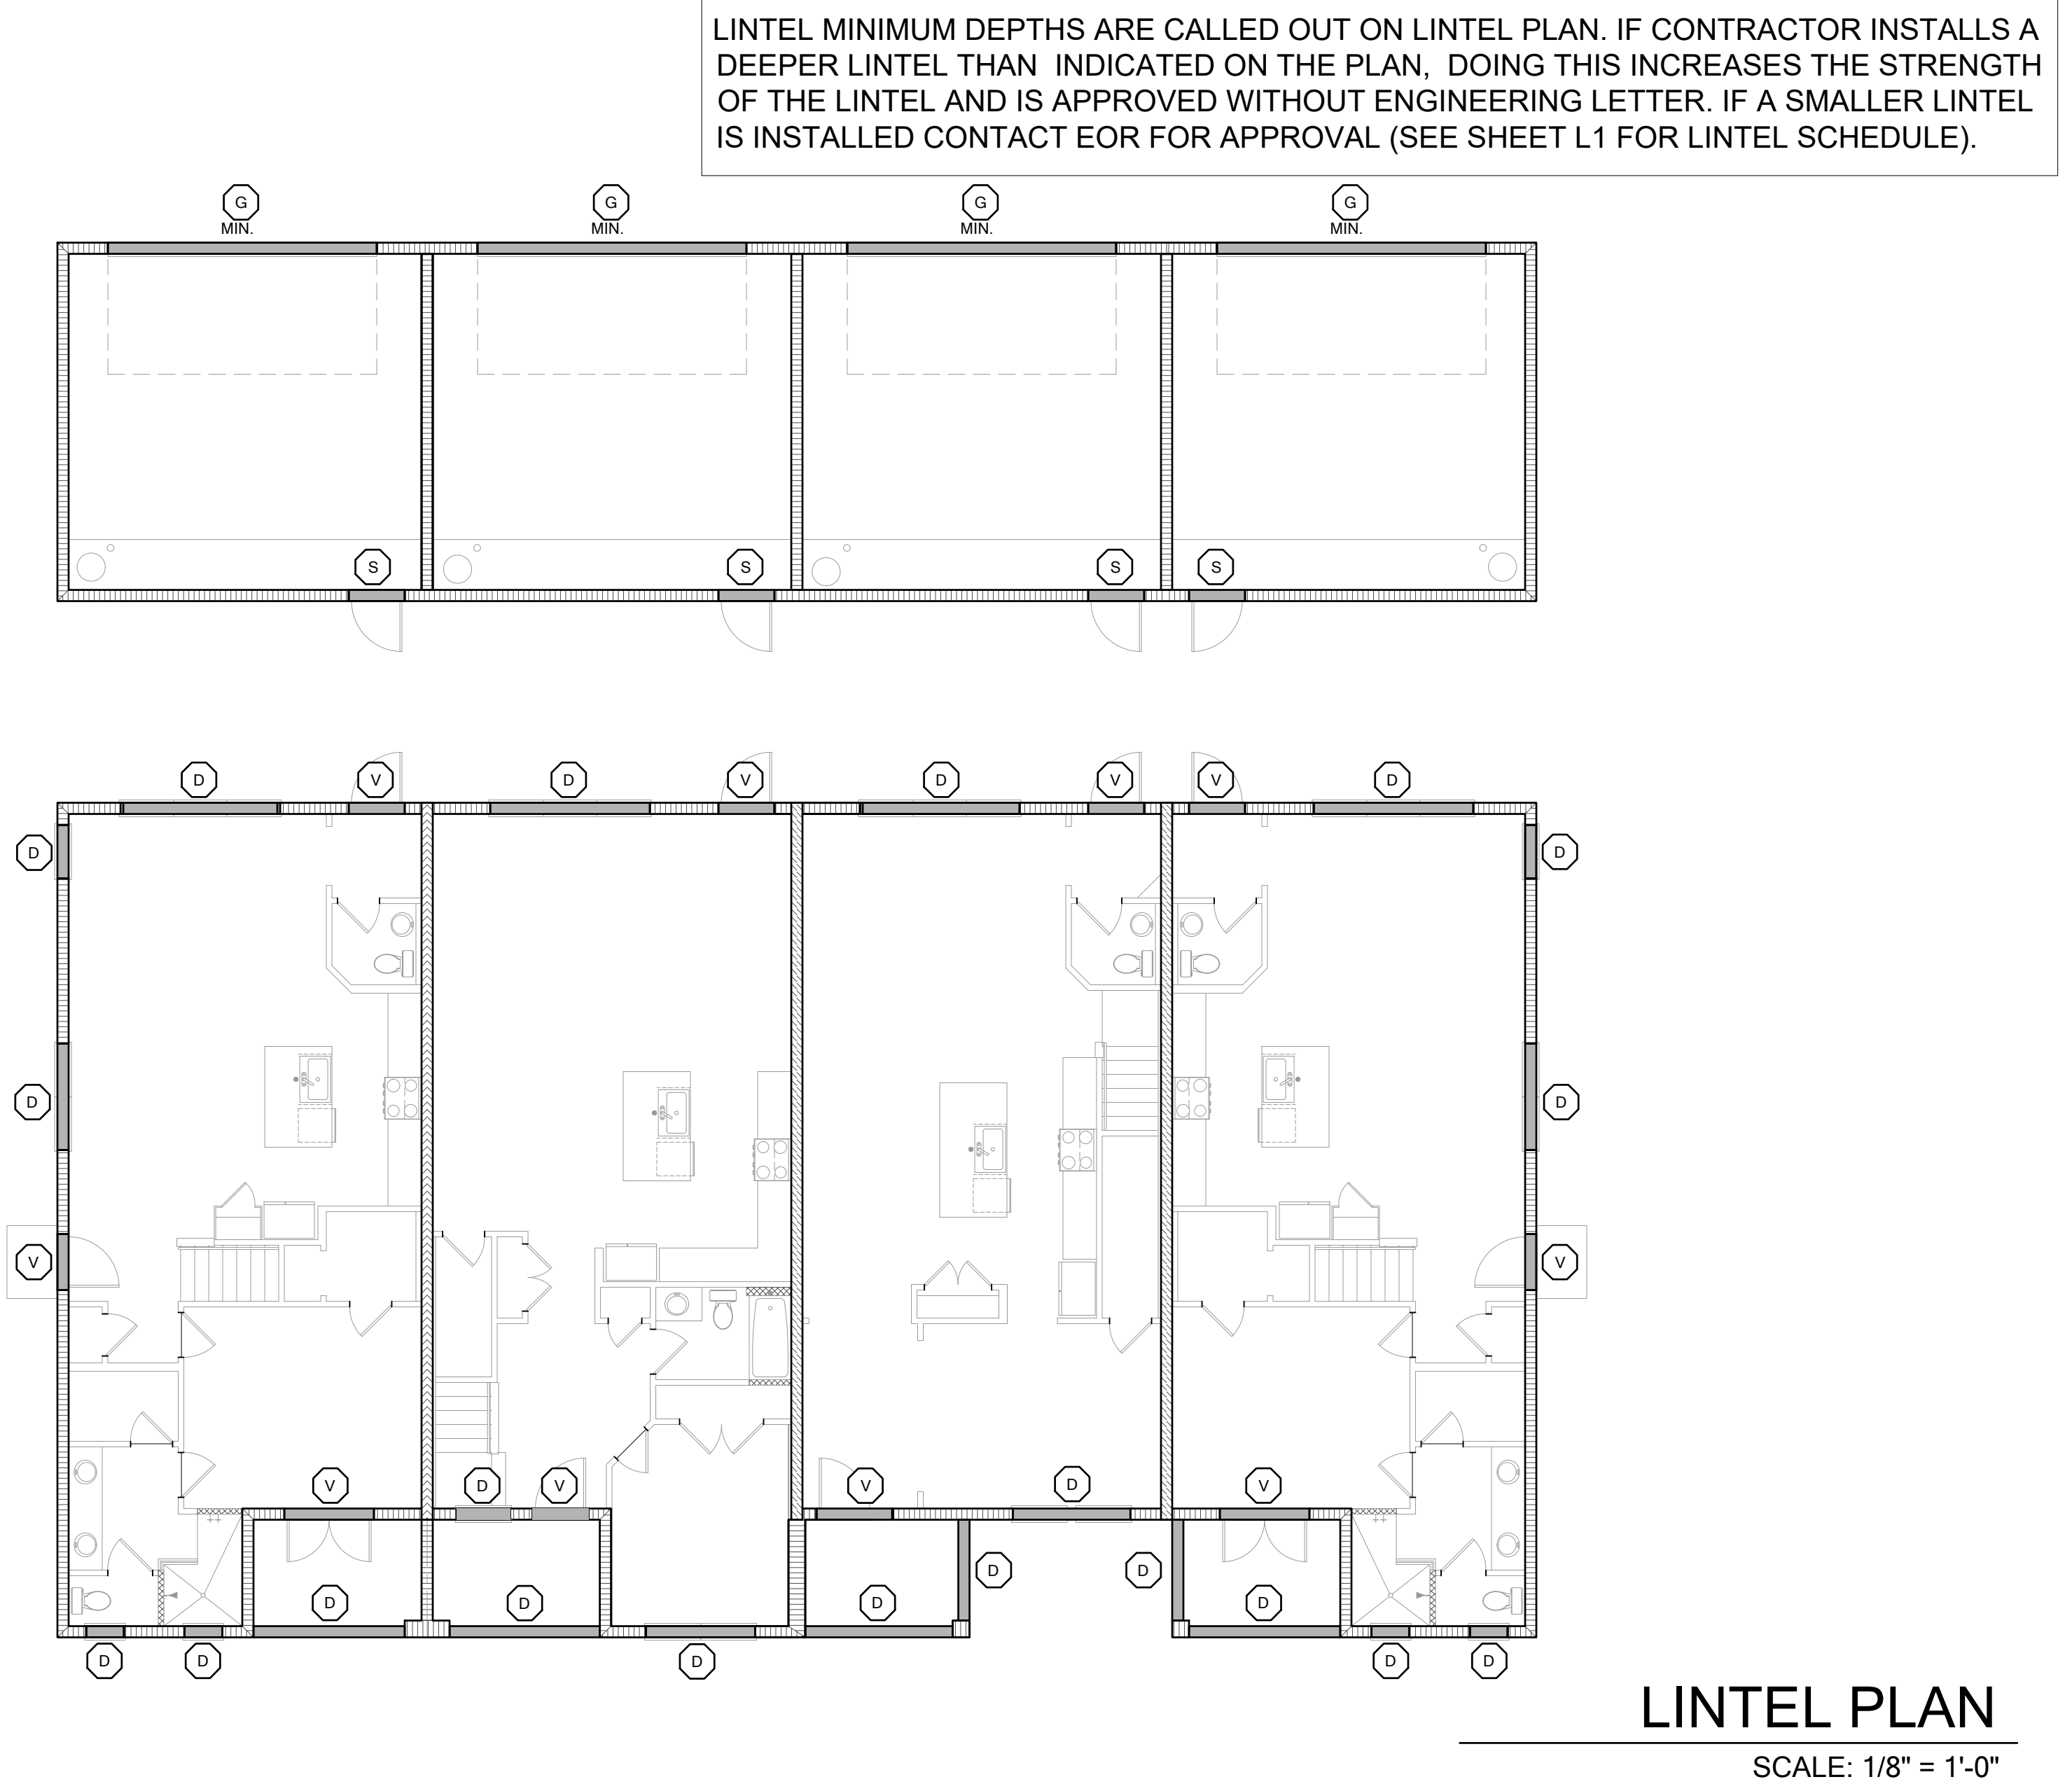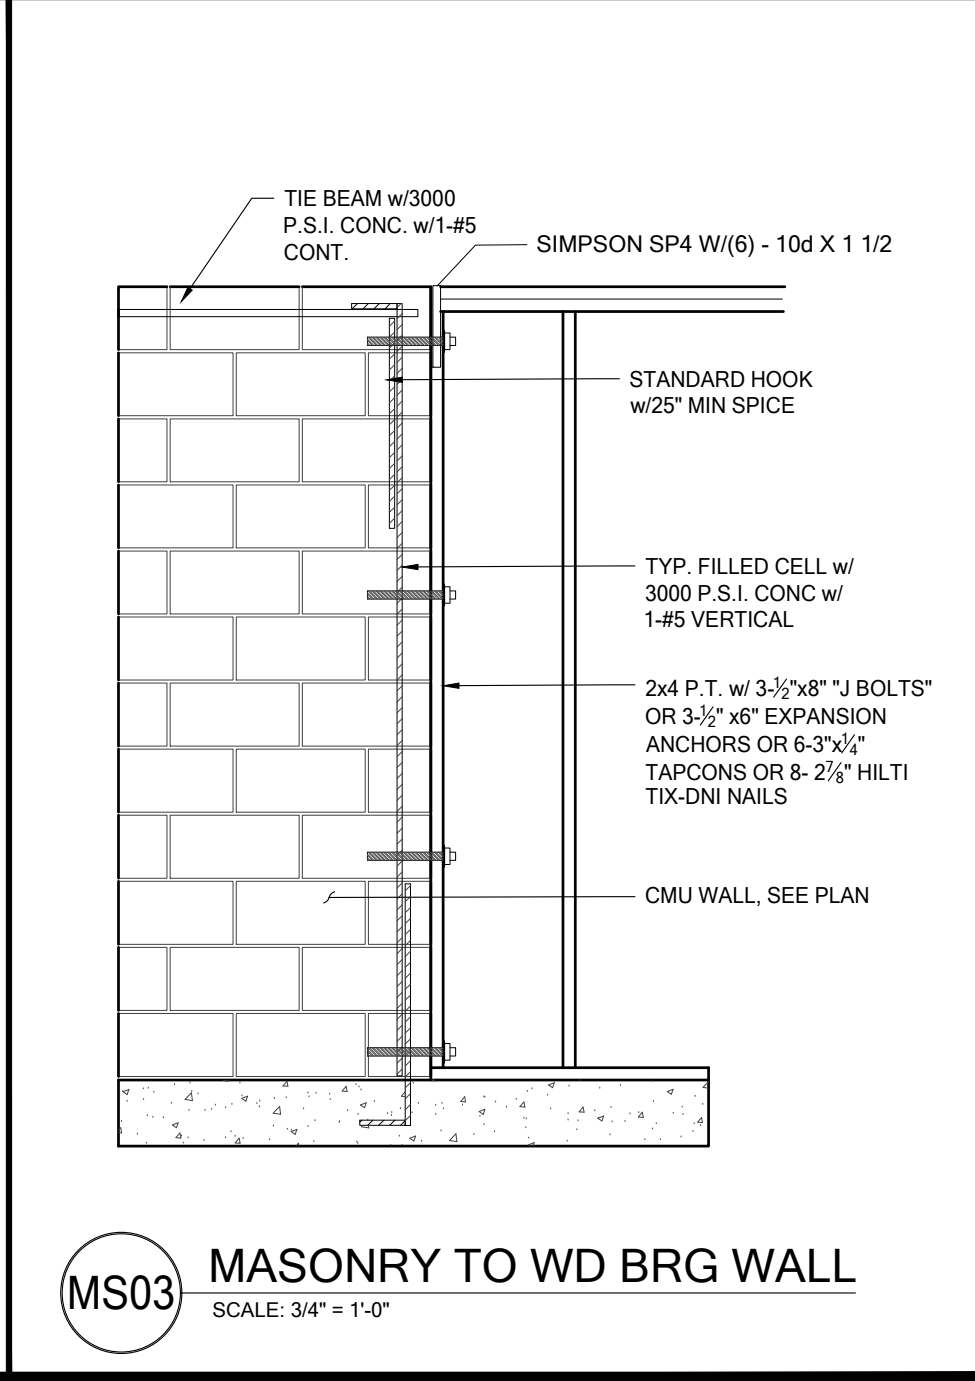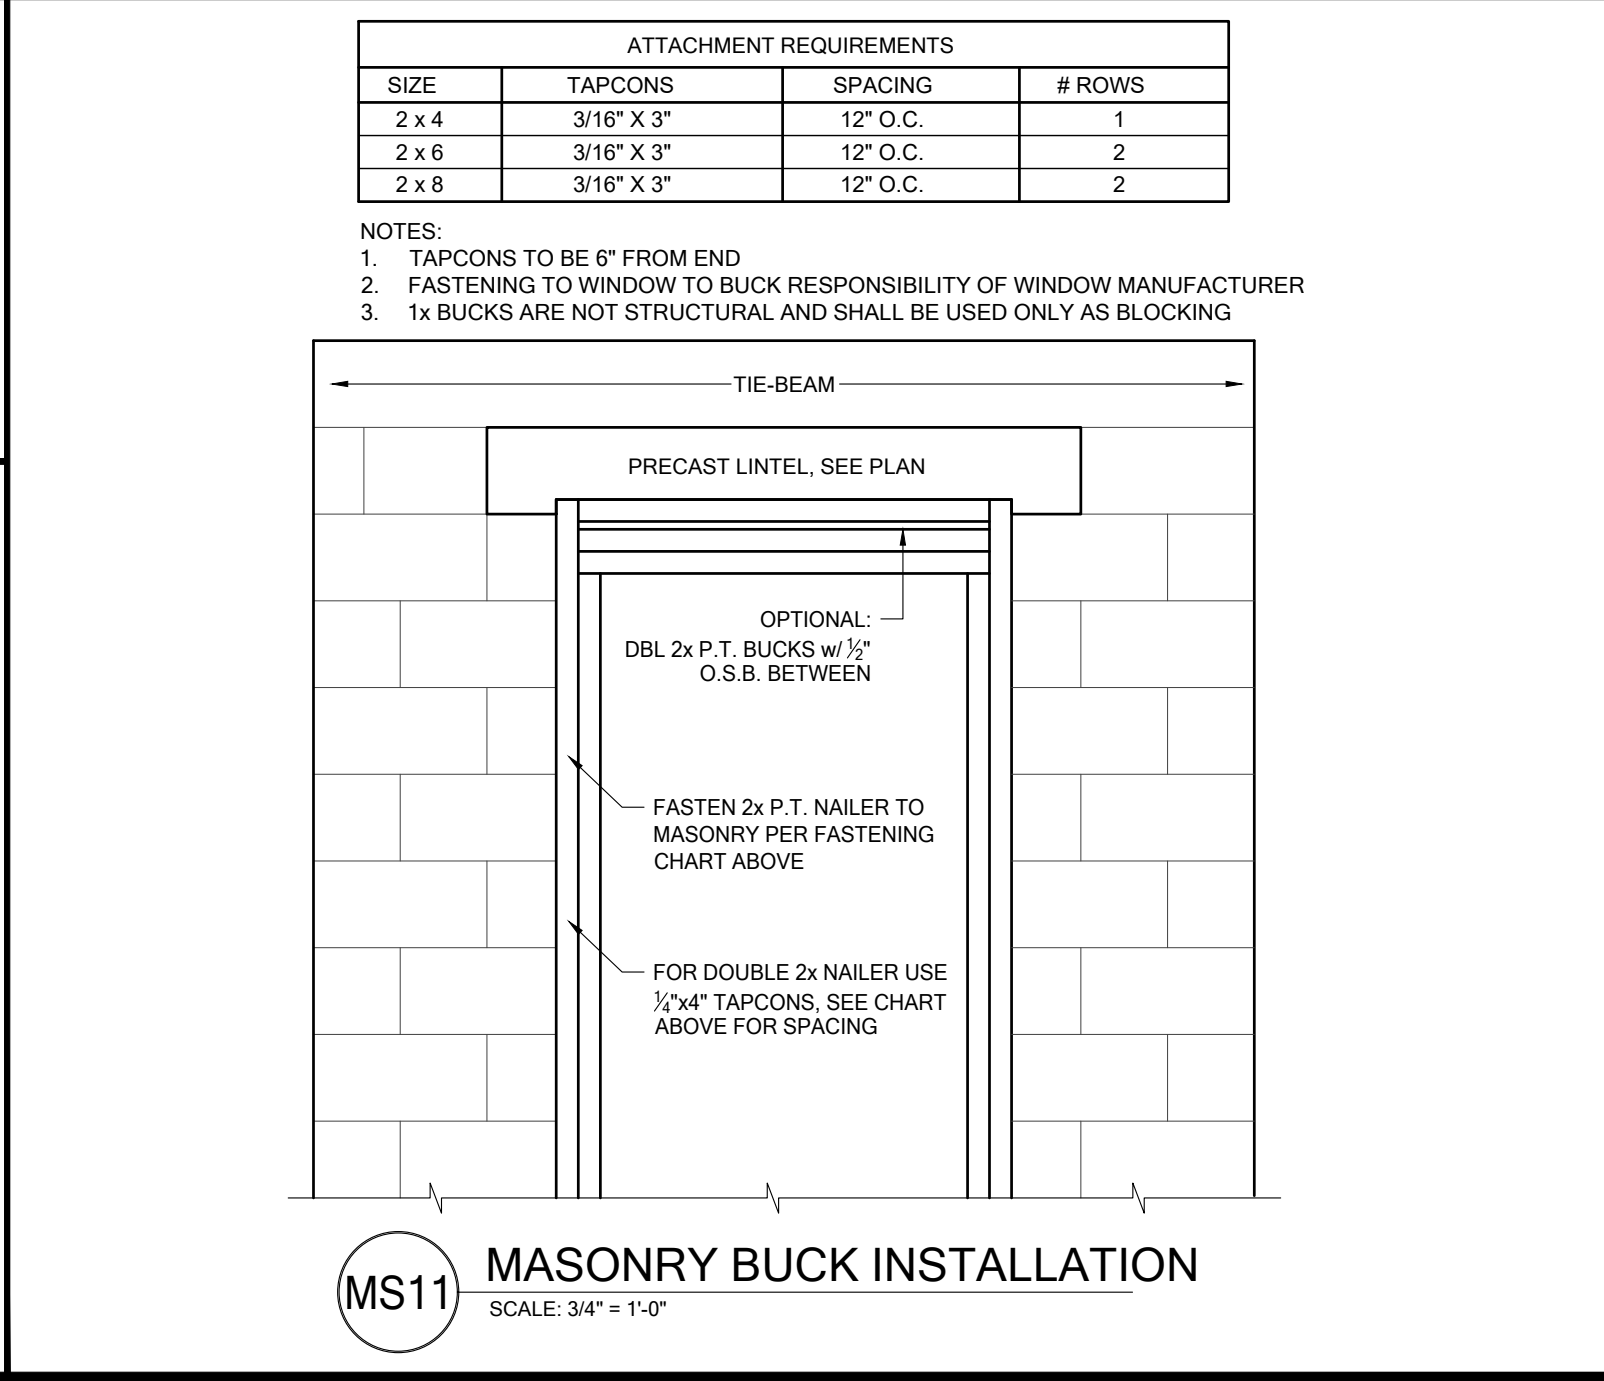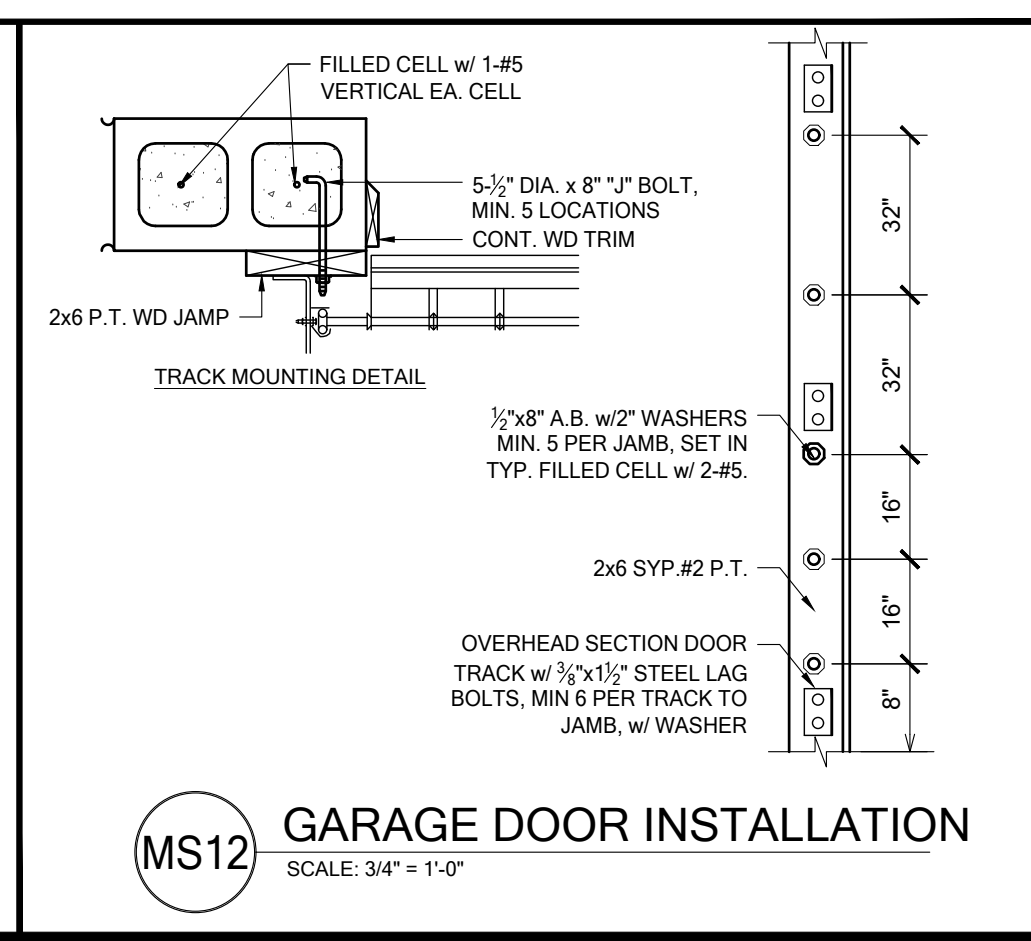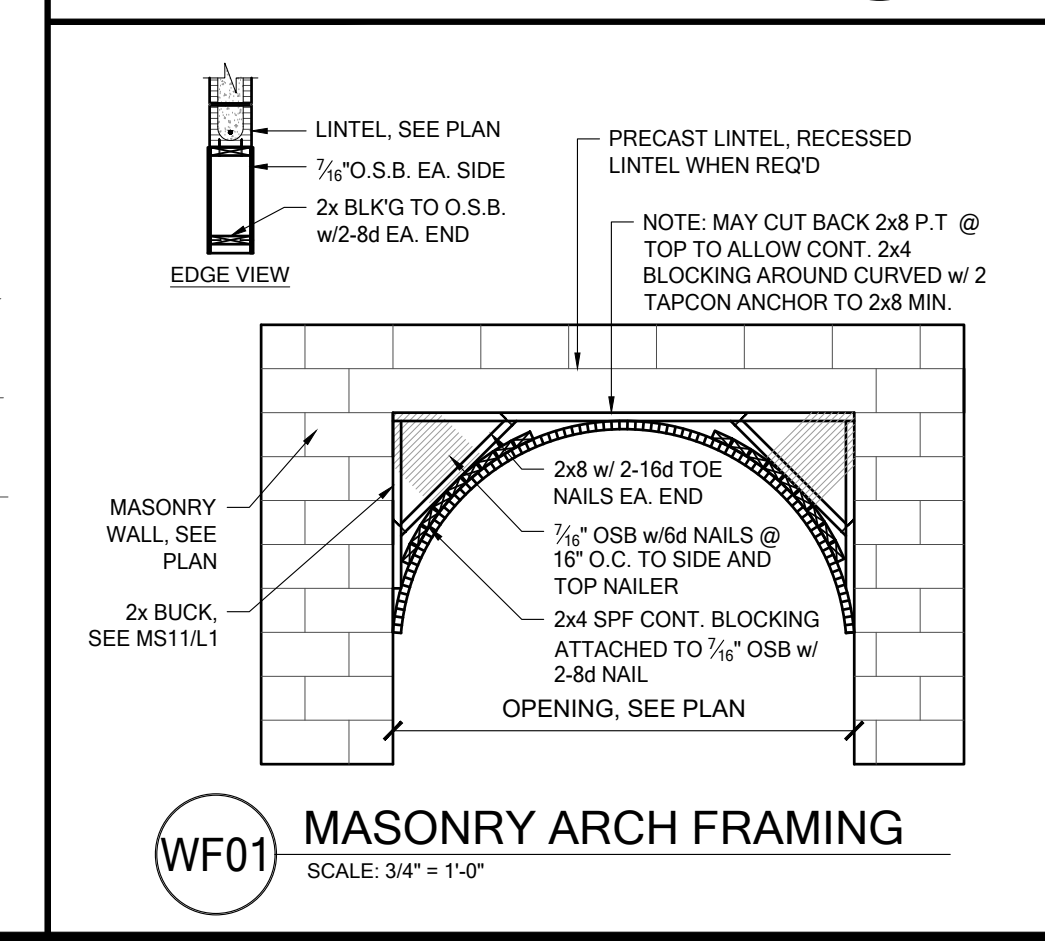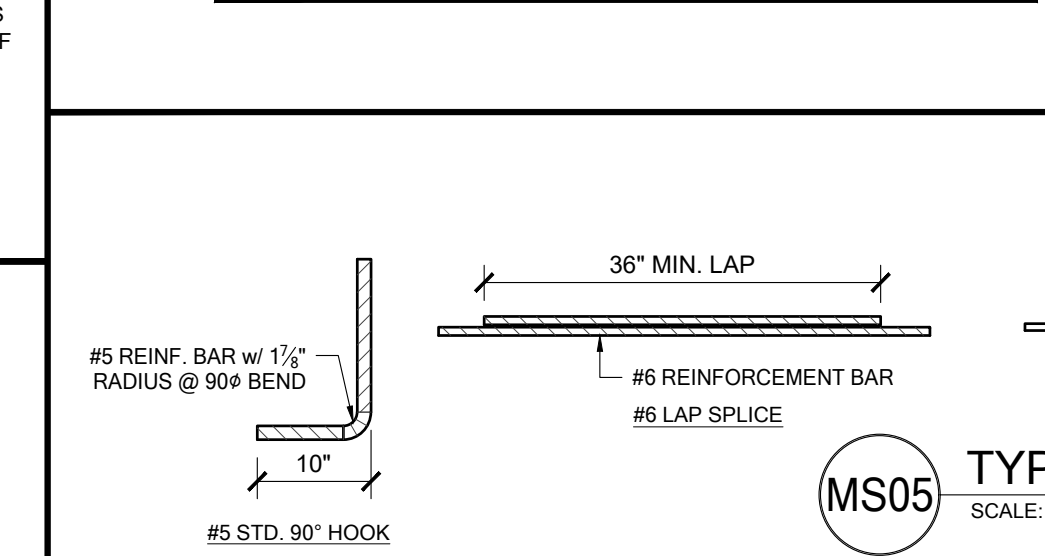

**B&A Design Studio, Inc.**

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**ENGINEERING ASSOCIATES**

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Phone: 407-829-8900  
Fax: 407-829-2040  
Certificate of Authorization No. 9161  
□ CARL A. BROWN, PE - FL #45628  
□ SCOTT LEWIS, PE - FL #28780  
DATE: April 28, 2023

TO THE BEST OF THE ENGINEER'S KNOWLEDGE AND BELIEF, THE STRUCTURAL DESIGN AND SPECIFICATIONS SHOWN ON THESE DRAWINGS COMPLY WITH THE STRUCTURAL REQUIREMENTS OF THE DRAWINGS.

**PARK SQUARE**  
**HORIZONS WEST**  
BABCOCK RANCH BLDG 6 (LOTS 6092-6099) 4 UNIT



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**SD02 GENERAL STAIR SECTIONS & PLAN**  
SCALE: 3/4"=1'-0"

## CAST CRETE OR QUALITY/ LOTTS LINTEL LOAD SPECIFICATIONS

### SAFE GRAVITY LOADS FOR 8" PRECAST & PRESTRESSED U-LINTELS

LENG.T.H	TYPE	SAFE LOAD - POUNDS PER LINEAR FOOT	SAFE GRAVITY LOADS FOR 8" PRECAST & PRESTRESSED U-LINTELS									
			8F8-0B	8F12-0B	8F16-0B	8F20-0B	8F24-0B	8F28-0B	8F32-0B	8F36-0B	8F40-0B	8F44-0B
2'-10" (34")	PRECAST	2231	3069	4605	6113	7547	8974	10394	11809	13224	14639	16054
3'-6" (42")	PRECAST	2231	3069	4605	6113	7547	8974	10394	11809	13224	14639	16054
4'-0" (48")	PRECAST	1966	2561	2751	3820	4890	5961	7034	8107	9180	10253	11326
4'-6" (54")	PRECAST	1599	2189	2379	3448	4518	5589	6661	7734	8807	9880	10953
5'-4" (64")	PRECAST	1217	1349	1438	1999	2560	3123	3686	4249	4812	5375	5938
5'-10" (70")	PRECAST	1062	1105	1173	1631	2090	2549	3009	3470	3931	4392	4853
6'-6" (78")	PRECAST	908	1238	2177	3480	5381	8360	10394	12428	14462	16496	18530
7'-6" (90")	PRECAST	743	1011	1729	2632	2205	2698	3191	3685	4178	4671	5164
9'-4" (112")	PRECAST	554	699	1160	1625	2564	3486	2818	3302	3786	4270	4754
10'-6" (126")	PRECAST	475	535	890	1247	2093	2777	2163	2536	2910	3284	3658
11'-4" (136")	PRECAST	362	442	706	1002	1326	1697	2127	2630	3133	3636	4139
12'-0" (144")	PRECAST	337	424	706	1002	1326	1697	2127	2630	3133	3636	4139
13'-4" (160")	PRECAST	296	424	706	1002	1326	1697	2127	2630	3133	3636	4139
14'-0" (168")	PRECAST	279	424	706	1002	1326	1697	2127	2630	3133	3636	4139
14'-8" (176")	PRESTRESSED	N.R.	NR	NR	NR	NR	NR	NR	NR	NR	NR	NR
15'-4" (184")	PRESTRESSED	N.R.	NR	NR	NR	NR	NR	NR	NR	NR	NR	NR
17'-4" (208")	PRESTRESSED	N.R.	NR	NR	NR	NR	NR	NR	NR	NR	NR	NR
19'-4" (232")	PRESTRESSED	N.R.	NR	NR	NR	NR	NR	NR	NR	NR	NR	NR
21'-4" (256")	PRESTRESSED	N.R.	NR	NR	NR	NR	NR	NR	NR	NR	NR	NR
22'-0" (264")	PRESTRESSED	N.R.	NR	NR	NR	NR	NR	NR	NR	NR	NR	NR
24'-0" (288")	PRESTRESSED	N.R.	NR	NR	NR	NR	NR	NR	NR	NR	NR	NR

(#) THE NUMBERS IN PARENTHESIS ARE PERCENT REDUCTIONS FOR GR40 FIELD ADDED REBAR.
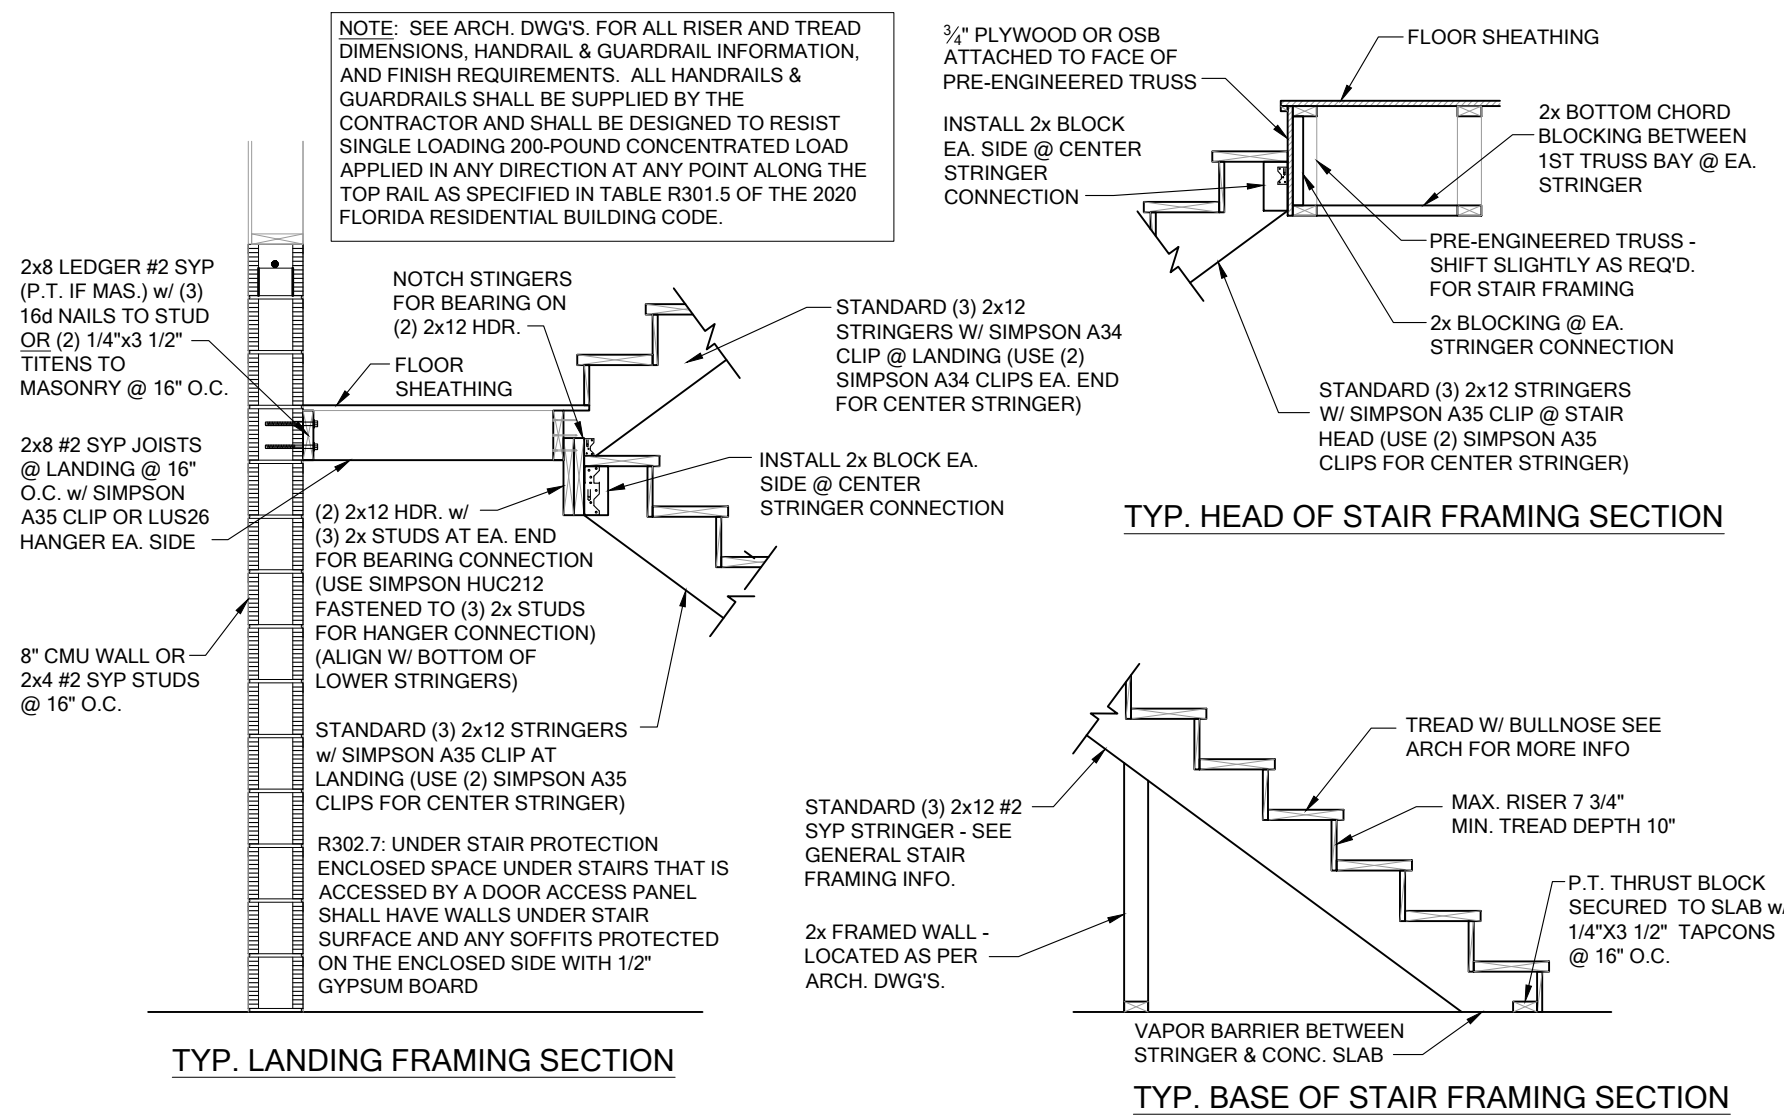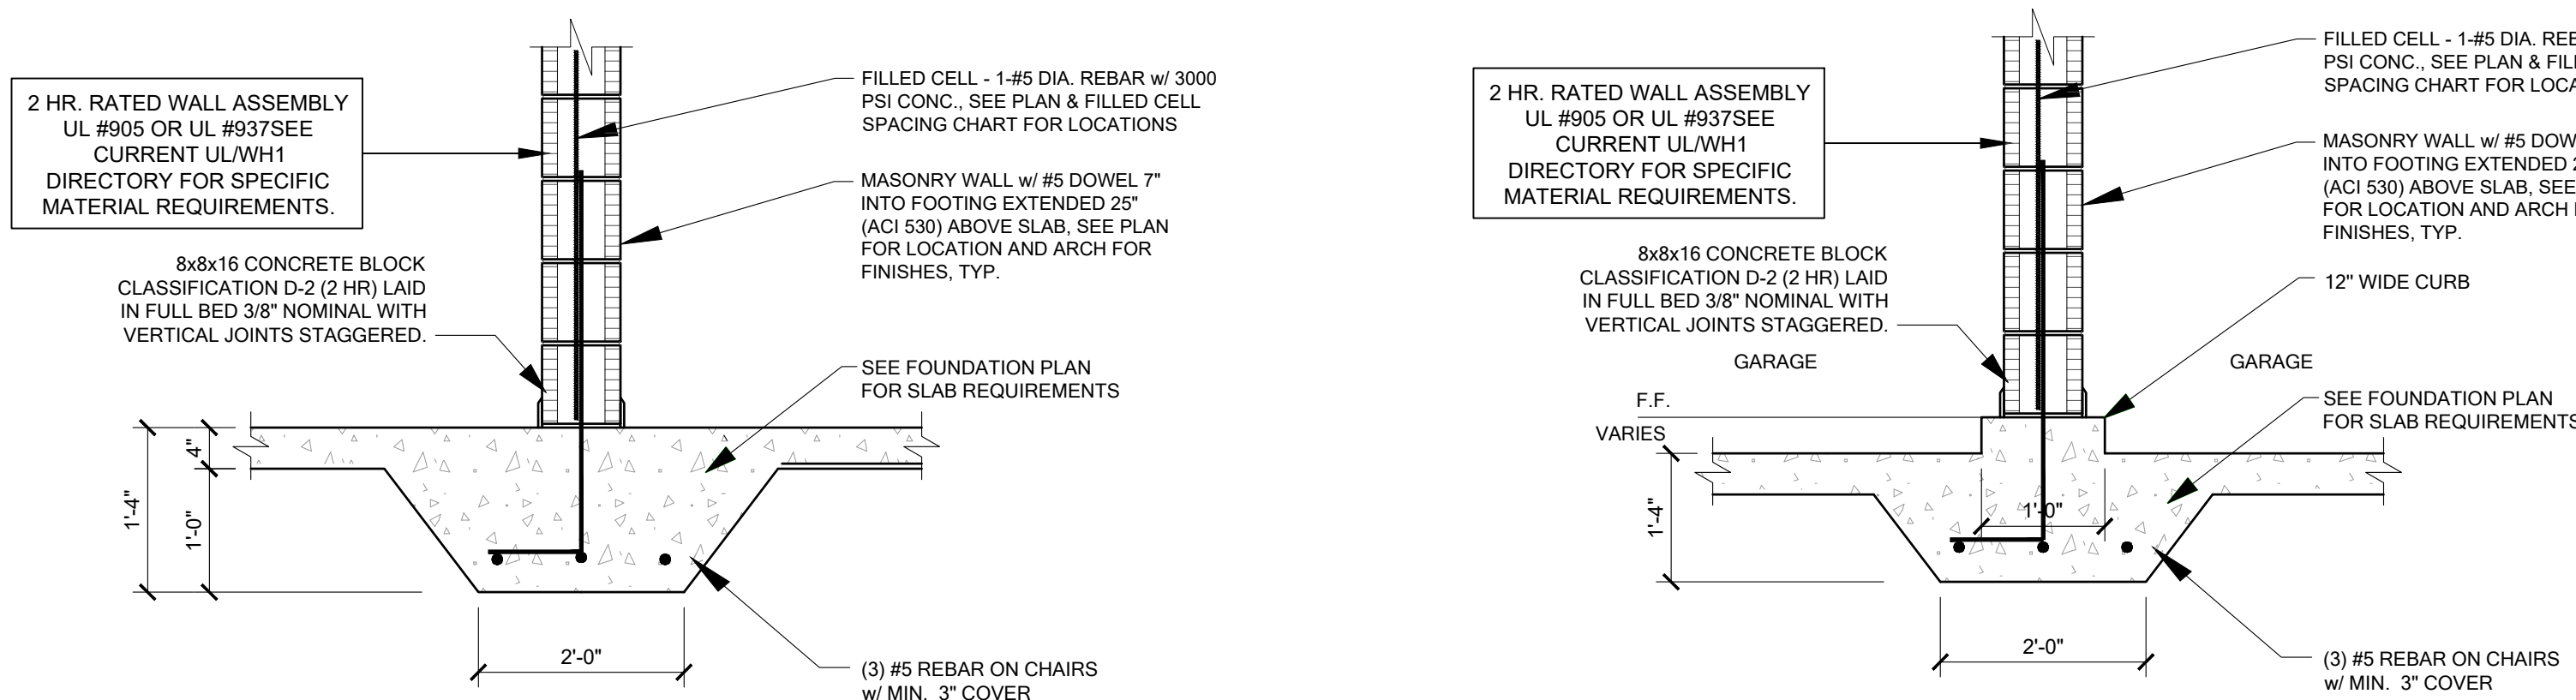
### SAFE UPLIFT LOADS FOR 8" PRECAST & PRESTRESSED U-LINTELS

LENG.T.H	TYPE	SAFE LOAD - POUNDS PER LINEAR FOOT	SAFE UPLIFT LOADS FOR 8" PRECAST & PRESTRESSED U-LINTELS									
			8F8-1T	8F12-1T	8F16-1T	8F20-1T	8F24-1T	8F28-1T	8F32-1T	8F36-1T	8F40-1T	8F44-1T
2'-10" (34")	PRECAST	1972	3173	4460	5747	7034	8321	9608	10895	12182	13469	14756
3'-6" (42")	PRECAST	1569	2524	3547	4569	5591	6613	7636	8658	9680	10703	11725
4'-0" (48")	PRECAST	1363	2192	3079	3966	4853	5740	6627	7514	8401	9288	10175
4'-6" (54")	PRECAST	1207	1940	2724	3508	4292	5077	5861	6646	7430	8215	9000
5'-4" (64")	PRECAST	1016	1632	2290	2949	3607	4265	4924	5582	6241	6899	7558
5'-10" (70")	PRECAST	929	1492	2093	2694	3295	3897	4498	5099	5699	6299	6899
6'-6" (78")	PRECAST	835	1340	1880	2419	2959	3498	4038	4578	5118	5658	6198
7'-6" (90")	PRECAST	727	1166	1634	2102	2571	3039	3508	3977	4446	4915	5384
9'-4" (112")	PRECAST	591	851	1326	1705	2084	2463	2842	3221	3600	3979	4358
10'-6" (126")	PRECAST	530	686	1183	1526	1865	2204	2544	2883	3222	3561	3900
11'-4" (136")	PRECAST	494	599	1028	1422	1738	2053	2369	2684	3000	3315	3631
12'-0" (144")	PRECAST	470	543	928	1349	1649	1948	2247	2546	2845	3144	3443
13'-4" (160")	PRECAST	428	455	770	1145	1444	1718	1993	2268	2543	2818	3093
14'-0" (168")	PRECAST	384	323	519	671	823	975	1127	1279	1431	1583	1735
14'-8" (176")	PRESTRESSED	246	390	655	968	1324	1680	2036	2392	2748	3104	3460
15'-4" (184")	PRESTRESSED	224	302	485	626	767	909	1050	1191	1332	1473	1614
17'-4" (208")	PRESTRESSED	187	255	404	520	637	754	872	989	1106	1223	1340
19'-4" (232")	PRESTRESSED	162	222	347	446	546	646	746	846	946	1046	1146
21'-4" (256")	PRESTRESSED	142	198	306	393	480	567	654	741	828	915	1002
22'-0" (264")	PRESTRESSED	137	192	295	378	461	545	629	713	797	881	965
24'-0" (288")	PRESTRESSED	124	175	267	341	416	491	566	641	716	791	866

(#) THE NUMBERS IN PARENTHESIS ARE PERCENT REDUCTIONS FOR GR40 FIELD ADDED REBAR.

**B&A Design Studio, Inc.**

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(407) 829-8900  
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Certificate of Authorization No. 0161  
CARLA A. BROWN, P.E. FL #5028  
SCOTT LEWIS, P.E. FL #7870  
DATE: April 28, 2023

**PARK SQUARE  
HORIZONS WEST  
BABCOCK RANCH BLDG 6 (LOTS 6092-6099) 4 UNIT**

title:

project no. 2023083  
checked:  
drawn: BA  
date: 04-12-23  
scale:

**L2**

NOTE: DRAWINGS ON 11"x17" SHEET WILL BE ONE HALF THE SCALE NOTED


FOUNDATION SCHEDULE				
MARK	SIZE	DEPTH	REINFORCING	GRAVITY CAP. [lbs]
F1.5	1'-6" x 1'-6"	1'-0"	(2) #5 E.W. BOT.	3500
F2.0	2'-0" x 2'-0"	1'-0"	(3) #5 E.W. BOT.	7200
F2.5	2'-6" x 2'-6"	1'-0"	(3) #5 E.W. BOT.	11000
F3.0	3'-0" x 3'-0"	1'-0"	(4) #5 E.W. BOT.	15600
F3.5	3'-6" x 3'-6"	1'-0"	(4) #5 E.W. BOT.	21500
F4.0	4'-0" x 4'-0"	1'-0"	(5) #5 E.W. BOT.	28000
F4.5	4'-6" x 4'-6"	1'-4"	(5) #5 E.W. BOT.	34500
F5.0	5'-0" x 5'-0"	1'-4"	(6) #5 E.W. BOT.	42500
F6.0	6'-0" x 6'-0"	1'-6"	(6) #5 E.W. BOT.	

FOUNDATION DETAIL NOTE:  
 • INTERIOR PAD DEPTHS AS LISTED IN THE SCHEDULE ARE THE TOTAL DEPTH AND MEASURED FROM THE TOP OF THE SLAB.  
 • EXTERIOR PAD DEPTHS AS LISTED IN THE SCHEDULE ARE TOTAL DEPTH WITH THE BOTTOM OF THE FOOTING TO MATCH THE BOTTOM OF THE CONTINUOUS MONOLITHIC POUR WHICH RUNS THROUGH IT.

GENERAL FOUNDATION NOTES:  
 1. PROVIDE MIN. 6 MIL. APPROX. VAPOR BARRIER. ALL JOINTS TO BE LAPPED MIN. 6" AND SEALED.  
 2. 4" 2500 PSI CONC. SLAB WITH W1:4XW1.4 OVER 6 MIL. VISQUEEN VAPOR BARRIER & TREATED FOR TERMITES.  
 3. GC/BUILDER, SEE ARCH PLANS FOR ROUGH OPENING LOCATIONS AND ADDITIONAL INFORMATION RECD FOR DOOR/WINDOW.  
 4. INSTALLATION ALONG W/ DIMENSIONS NOT SHOWN ON FOUNDATION CONSULT W/ MANUFACTURER SPECIFICATIONS PRIOR TO POURING OR RECESSING DOOR SILLS OR SLIDING GLASS DOOR SILLS.  
 5. NO WOOD STAKES PERMITTED IN FOUNDATION.  
 6. PENDING SITE CONDITIONS, FOUNDATION MAY HAVE TO BE STEPPED DOWN. SEE **FM1801** FOR ADDITIONAL INFORMATION. G.C. TO DETERMINE STEP LOCATIONS, IF REQUIRED.  
 7. STEEL BENDS AND LAP SPICE SEE **FM1801** AND **FM19D1**.  
 8. ALL EQUIPMENT AND/OR APPLIANCES HAVING AN IGNITION SOURCE SHALL BE ELEVATED A MIN OF 18". CONTRACTOR TO PROVIDE SUCH PLATFORM W/ EITHER MASONRY OR WOOD CONSTRUCTION.  
 9. ASSUMED ALLOWABLE SOIL BEARING PRESSURE AFTER COMPACTION: 2000 PSF (SEE SOILS REPORT AND SPECIFICATIONS FOR COMPACTION REQUIREMENTS). IF SOIL CONDITIONS ON THE PROJECT DO NOT MEET OR EXCEED THE CAPACITY, THE GENERAL CONTRACTOR SHALL CONTACT THE ENGINEER PRIOR TO FOUNDATION POUR FOR VERIFICATION OF FOUNDATION DESIGN. SOIL TO BE FREE OF ORGANIC MATERIAL AND COHESIVE SOILS. COMPACTION IN 12" LIFTS TO AT LEAST 95% OF MAX. DRY DENSITY AS DETERMINED BY ASTM D 1557 (MODIFIED PROCTOR).  
 10. R-403 1/4 MINIMUM DEPTH EXTERIOR FOOTINGS SHALL BE PLACED NOT LESS THAN 12 INCHES (305mm) BELOW THE FINISHED GRADE OF GROUND SURFACE.





COLUMN SCHEDULE				
MARK	COLUMN SIZE	FIRST FLOOR BASE CONNECTIONS, SEE PLAN FOR SECOND FLOOR CONNECTIONS	UPLIFT(lb)	
C1	(3) 2x #2 SPF	(4) 12d TOENAILS	NO UPLIFT	
C2	(3) 2x #2 SPF	DTT22 W/ 1/2" ATR & (8) 3/4" x 1 1/2" SDS SCREWS	1835	
C3	(3) 2x #2 SPF	(4) 12d TOENAILS	NO UPLIFT	
C4	(3) 2x #2 SPF	DTT22 W/ 1/2" ATR & (8) 3/4" x 1 1/2" SDS SCREWS	1835	
C5	4x4 P.T. #2 SYP POST	ABU44 w/ 3/4" ATR & (12) 16d NAILS FIRST/SECOND FLOOR CONN.	G = 6665 U = 1782	
C6	6x6 P.T. #2 SYP POST	ABU66 w/ 3/4" ATR & (12) 16d NAILS FIRST/SECOND FLOOR CONN.	G = 12000 U = 2070	
C7	8x8 P.T. #2 SYP POST	ABU88 w/ 2 1/4" ATR & (18) 16d NAILS FIRST/SECOND FLOOR CONN.	G = 24335 U = 2088	
C8	3.5" x 3.5" P.L. 1.8E Fb=2400 PSI (W/ MANAGED W/ EXT.)	HDU5-SDS2.5 w/ 7/8" ATR AND (14) 1/2"x2 1/2" SDS WOOD SCREWS	5080	
C9	3.5" x 3.5" P.L. 1.8E Fb=2400 PSI (W/ MANAGED W/ EXT.)	HDU5-SDS2.5 w/ 7/8" ATR AND (14) 1/2"x2 1/2" SDS WOOD SCREWS	5080	
C10	3.5" x 3.5" P.L. 1.8E Fb=2400 PSI (W/ MANAGED W/ EXT.)	HDU8-SDS2.5 w/ 7/8" ATR AND (20) 1/2"x2 1/2" SDS WOOD SCREWS	6372	
C11	5.25" x 5.25" P.L. 1.8E Fb=2400 PSI (W/ MANAGED W/ EXT.)	HDU8-SDS2.5 w/ 7/8" ATR AND (20) 1/2"x2 1/2" SDS WOOD SCREWS	7082	

GENERAL COLUMN NOTES:  
 1. ALL STRUCTURAL LUMBER TO BE SYP#2 OR SPF#2 UNO ON PLAN.  
 2. MINIMUM BOLT EMBEDMENT: 5" EMBEDMENT FOR 1/2" ATR. 6" EMBEDMENT FOR 3/8" ATR. 8" EMBEDMENT FOR 7/8" ATR.  
 3. P.L. COL. TO BRG DIRECTLY ON FOUNDATION. CUT BASE PLATE AS REQD. G.C. TO PROVIDE MOISTURE BARRIER.  
 4. IF COL. IS CALLED OUT ON 2ND FLOOR, THE BASE CONNECTION IS NOT REQD. SEE PLANS FOR BASE CONNECTION.  
 5. VALUES HAVE BEEN REDUCED FOR NARROW FACE APPLICATION. CONNECTIONS SHALL BE INSTALLED ON NARROW OR WIDE FACE PER SIMPSON TC-SCLCLM

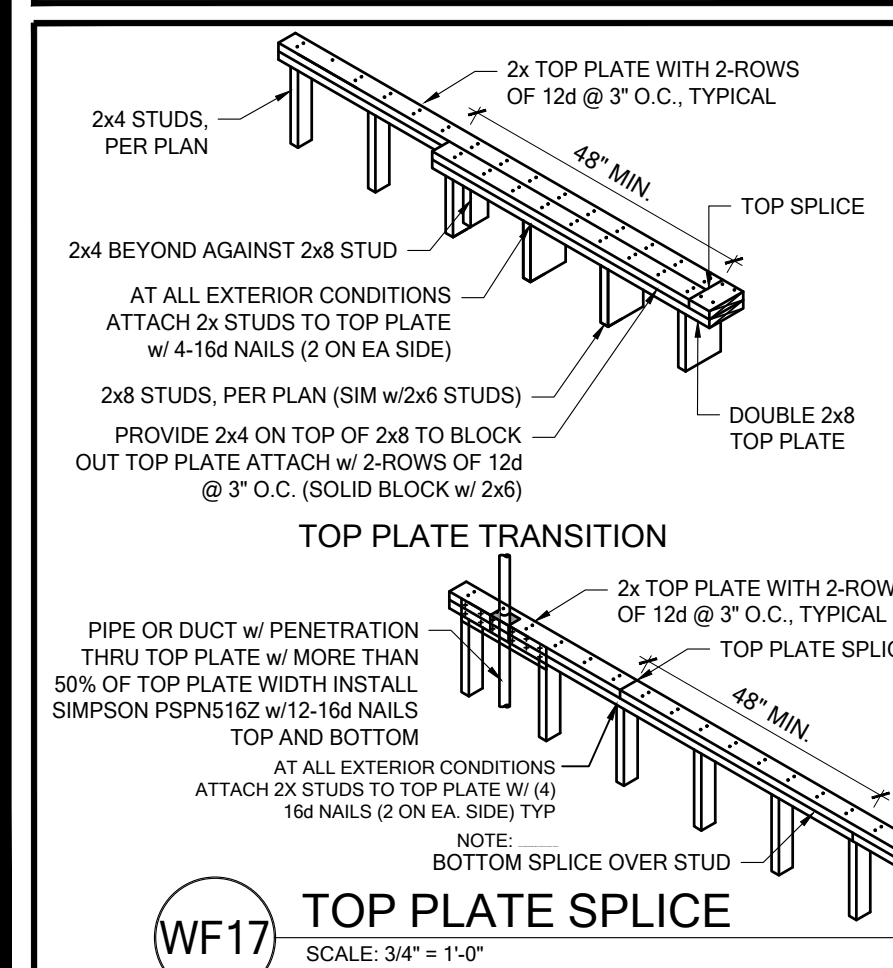


WOOD BEARING WALL SCHEDULE				
MARK	STUD SPACING	CONNECTION & FASTENERS	LUMBER SPECIES	UPLIFT CAP. [lb]
BW1	16"	(2) 16d TOENAILS OR (2) 12d END OR BOX NAILS	#2 SPF	NO UPLIFT
BW2	16"	SP2 w/ (6) 10d NAILS	#2 SPF	402
BW3	16"	SP2 w/ (6) 10d NAILS	#2 SPF	804
BW4	16"	(2) 16d TOENAILS OR (2) 12d END OR BOX NAILS	#2 SYP	NO UPLIFT
BW5	16"	SP2 w/ (6) 10d NAILS	#2 SYP	439
BW6	16"	SP2 w/ (6) 10d NAILS	#2 SYP	878
BW7	12"	(2) 16d TOENAILS OR (2) 12d END OR BOX NAILS	#2 SPF	NO UPLIFT
BW8	12"	SP2 w/ (6) 10d NAILS	#2 SPF	535
BW9	12"	(2) SP2 w/ (6) 10d NAILS	#2 SYP	1070
BW10	12"	(2) 16d TOENAILS OR (2) 12d END OR BOX NAILS	#2 SYP	NO UPLIFT
BW11	12"	SP2 w/ (6) 10d NAILS	#2 SYP	585
BW12	12"	(2) SP2 w/ (6) 10d NAILS	#2 SYP	1170

CROSS REFERENCE CHART  
 SIMPSON SP1 / USP SP22 SIMPSON SP2 / USP SPT24  
 (2) 2x HEADER (U.N.O.) SEE FLOOR PLAN FOR MIN. SIZE. SEE HD/SN FOR CONNECTION INFO. IF HEADER IS WITHIN A WALL, NO UPLIFT AS INDICATED IN THE WOOD BEARING WALL SCHEDULE, THE CONNECTORS INDICATED IN WF09 & HD CAN BE IGNORED.  
 2x TOP PLATE SEE, WF17/SN FOR ADDITIONAL INFO.  
 2x MID-SPAN BLOCKING w/ (2) 12d TOENAIL @ EA. END ONLY FOR WALLS TALLER THAN 8'-0".  
 CONNECTOR TOP AND BOTTOM PER WOOD BEARING WALL SCHEDULE BEARING WALL DETAIL.  
 ANCHOR BOLT(S): 1/2" A.B. OR A.T.R. w/ SIMPSON SET @ 32" O.C. w/ EMBEDMENT OF 7" MIN. OR 1/2" TITEN HD w/ 4 1/2" MIN. EMBEDMENT (IF AT STEP, 7" MIN PAST LOWER SLAB, ONLY IF INDICATED WOOD BEARING WALL OR SHEAR WALL. SEE PLAN FOR BEARING WALL / SHEAR WALL LOCATION.  
 GENERAL BEARING WALL NOTES:  
 1. ALL STRUCTURAL LUMBER DESIGNATED AS SYP SHALL BE SYP #2 AND ALL STRUCTURAL LUMBER DESIGNATED AS SPF SHALL BE SPF #2 U.N.O.  
 2. SEE FLOOR PLAN FOR WALL SIZE. ASSUME 2x4 STUDS USED UNO.  
 3. CONNECTIONS TO BE INSTALLED TO EACH STUD AS INDICATED.  
 4. CONTACT E.O.R. IF SP#8 CONNECTORS ARE SUBSTITUTED, TO VERIFY THEY MEET THE STRUCTURAL REQUIREMENTS.  
 5. IF "BW" IS INDICATED ON SECOND FLOOR BASE CONNECTION TO BE IGNORED. SEE WF06 AND FB06 OR INDICATED FOR PROPER CONNECTIONS FOR 2ND FLOOR TO FIRST FLOOR CONNECTIONS. (NOTE: THIS IS FOR 2 STORY PROJECTS ONLY)  
 6. IF "BW" IS INDICATED ON PLAN THE WALL IS CONSIDERED A SHEAR WALL AND REQUIRES MIN. 7/16" OSB / PLYWOOD W/ 8d NAILS @ 4" O.C. IN FIELD AND EDGE TO ONE SIDE OF WALL. U.N.O. ON PLANS.  
 7. ALL 2x EXTERIOR WALLS w/ SHEATHING ATTACHED PER NAILING SCHEDULE TB13/SN ACTS AS SHEAR WALLS. SEE PLAN AND WALL SECTIONS FOR STUD SPACING AND GRADE.  
 8. ALL TOP PLATES AND SILL PLATES SHALL BE THE SAME SPECIES AS THE WOOD STUDS.  
 9. IF THE BEARING WALL IS INDICATED WITH THE BW1, BW4, BW7, BW10, THESE WALLS ARE ONLY SUPPORTING THE FLOOR LOAD AND DO NOT HAVE UPLIFT, THE STUDS ARE TOE NAILED TO THE PLATE AND THE 2x PLATE CAN BE ATTACHED WITH HARD CASED NAILS (GUN NAILS) AND WILL NOT REQUIRE THE ANCHOR BOLT ATTACHMENT INDICATED IN THE BEARING WALL SCHEDULE.

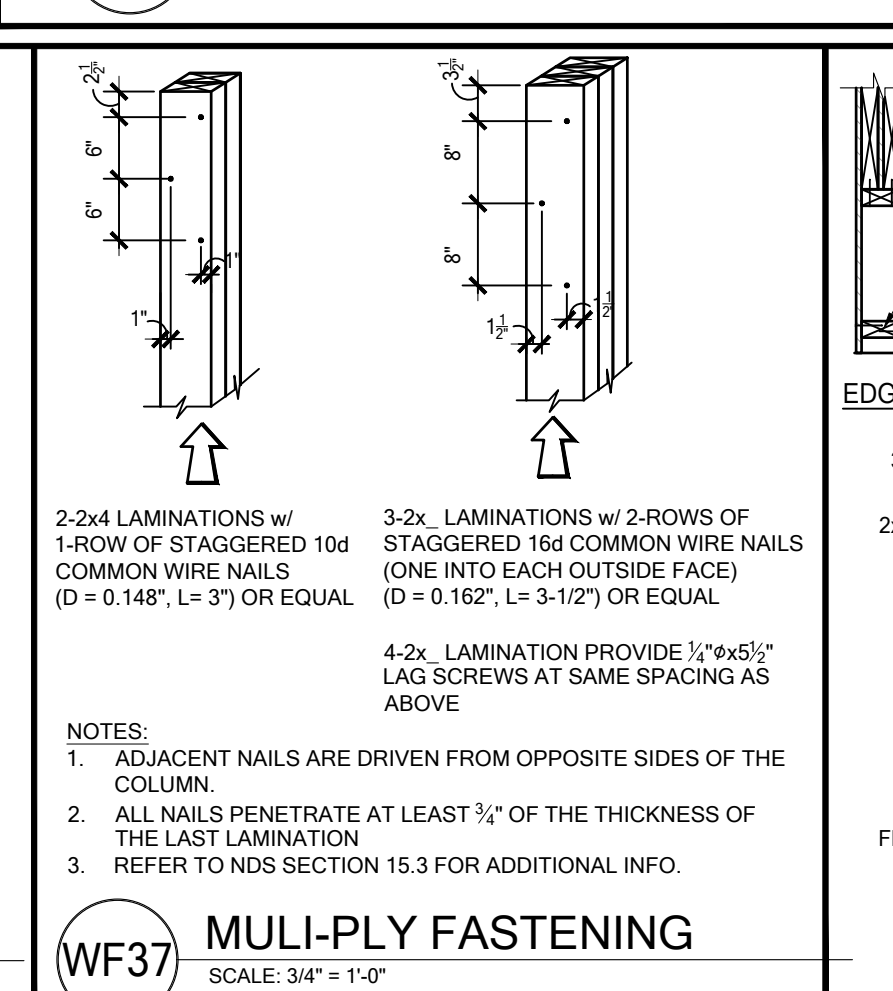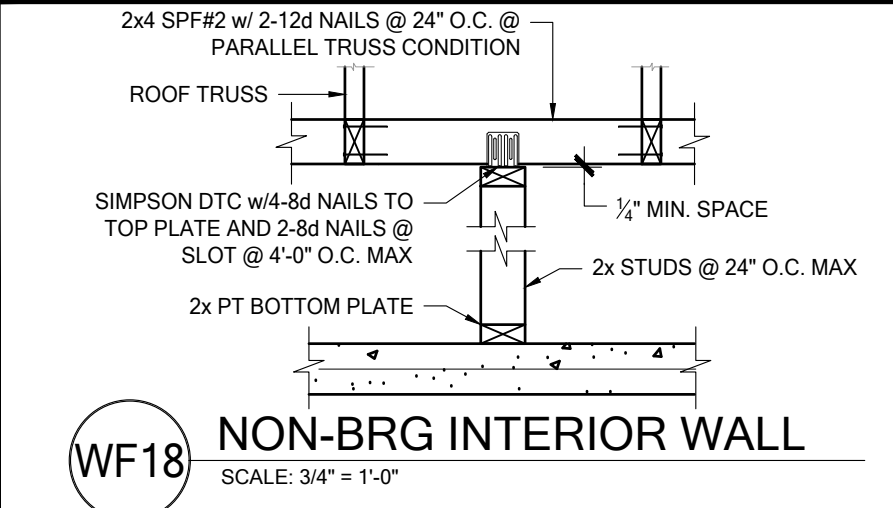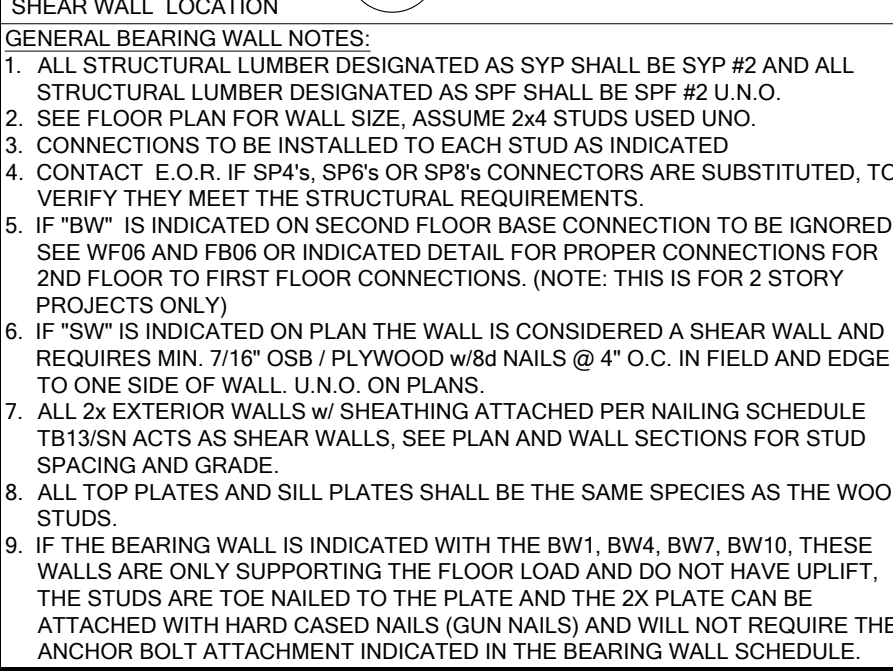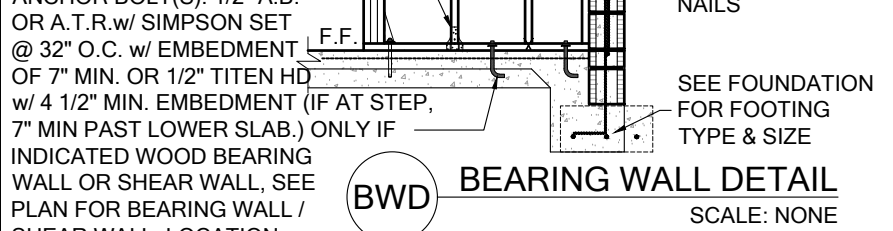

HEADER SCHEDULE		
MARK	HEADER SIZE	HEADER NOTES
(H1)	(2) 2x6 #2 SYP w/ 7/16" FLUTCH PLATE	1. VERIFY w/ PLAN CORRECT LENGTH OF HEADER REQUIRED.
(H2)	(2) 2x8 #2 SYP w/ 7/16" FLUTCH PLATE	2. IF HEADER IS ON THE 1ST FLOOR SEE PLAN FOR BEARING WALL TYPE AND FOLLOW INSTRUCTIONS WITHIN BEARING WALL SCHEDULE FOR REQUIRED CORRECTIONS U.O. ON PLAN.
(H3)	(2) 2x10 #2 SYP w/ 7/16" FLUTCH PLATE	3. IF HEADER IS ON THE 2ND FLOOR SEE PLAN FOR INDICATED HEADER CONNECTION FOR REQUIRED CONNECTIONS.
(H4)	(2) 2x12 #2 SYP w/ 7/16" FLUTCH PLATE	4. ALL HEADER JACK AND KING STUDS SHALL BE FASTENED TO EACH PER DETAIL W#3739N
(H5)	(2) 3/4" x 11 1/4" LVL 2.0E F#E=2600	5. FASTEN ALL MULTI-PLY JOIST TOEGERS WITH (2) ROWS 12d COMMON NAILS AT 2' O.C. OR (3) ROWS IF 2x10 OR LARGER TYP. EACH SIDE OR (2) ROWS 14d x 3 1/2" SDS WOOD SCREWS @ 16" O.C. TYP. EACH SIDE.
(H6)	(2) 3/4" x 9 1/4" LVL 2.0E F#E=2600	6. FASTEN ALL HEADERS TO KING STUDS w/ (3) 10d TOENAILS PER SIDE.
(H7)	(3) 2x10 #2 SYP w/ 1" FLUTCH PLATE	7. IF HEADER IS NOT SPECIFIED CONTACT E.O.14
(H8)		


HEADER SUPPORT - NUMBER OF JACKS & STUDS REQUIRED AT OPENINGS				
OPENING SIZE	2x4 WALL		2x6 OR 2x8 WALL	
	JACKS EA END	KINGS EA END	JACKS EA END	KINGS EA END
1'-0" - 3'-11"	(1)	(2)	(1)	(2)
4'-0" - 8'-11"	(2)	(3)	(2)	(3)
10'-0" - 16'-0"	(3)	(4)	(3)	(4)

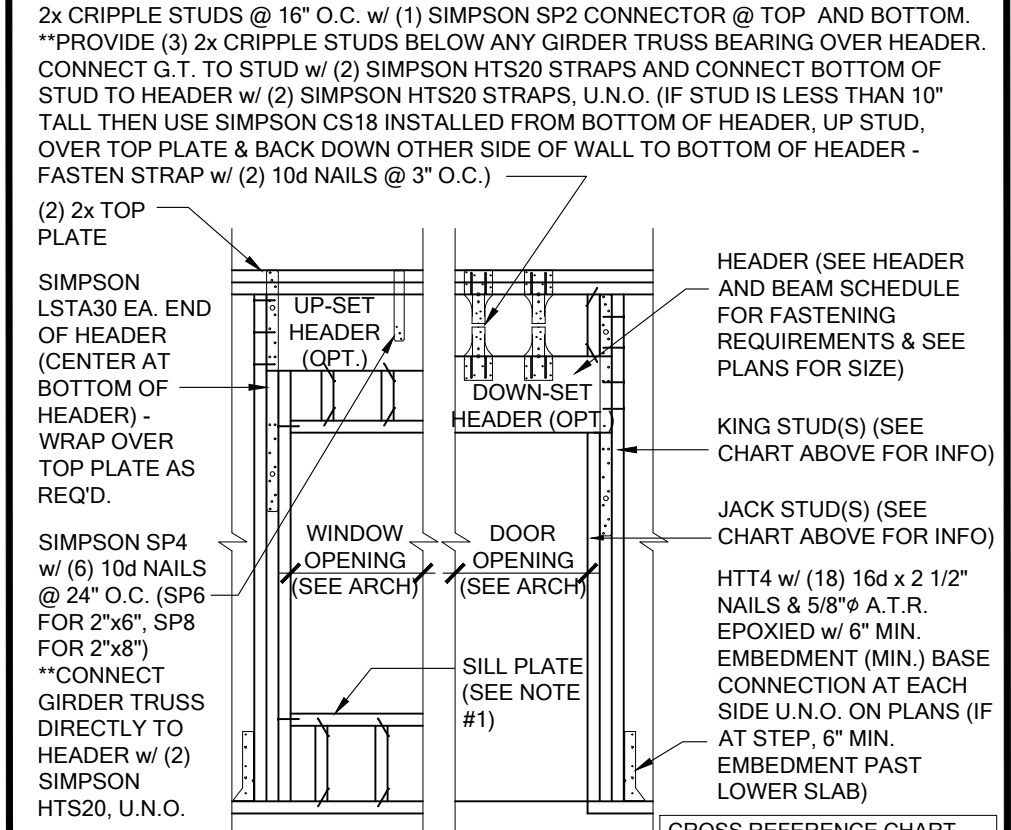

NOTES:  
 1. OPENINGS GREATER THAN 4'-0" PROVIDE (2) 2x SILL PLATE w/ A35 CLIPS EACH SIDE.  
 2. NO TOP PLATE SPLICES SHALL OCCUR OVER OR WITHIN 2 FEET OF HEADER.  
 3. HOLD DOWN CONNECTIONS NOT REQUIRED AT BEARING WALLS WITHOUT UPLIFT.  
 CROSS REFERENCE CHART  
 SIMPSON LSTA30 / USP LSTA30  
 SIMPSON SP4 / USP SPT4  
 SIMPSON SP6 / USP SPT6  
 SIMPSON SP8 / USP SPT8  
 SIMPSON HTS20 / USP HTW20  
 SIMPSON SP2 / USP SPT2  
 SIMPSON AS3 / USP MPA1  
 SIMPSON HTT4 / USP HTT45

BEAM SCHEDULE			
MARK	BEAM SIZE	SIMPSON - CONNECTIONS	USP - CONNECTIONS
BM1	(2) 2x8 #2 SYP w/ 3/4" OSB FLITCH PLATE	WOOD POST (2) HTS20 CMU COLUMN (2) HETA16 U.N.O. ON FRAMING PLATE	WOOD POST (2) HTS20 CMU COLUMN (2) HETA16 U.N.O. ON FRAMING PLATE
BM2	(2) 2x10 #2 SYP w/ 3/4" OSB FLITCH PLATE	FASTEN BEAM PLYS: 2- ROWS OF 12d @ 12" O.C. EACH SIDE, TYPICAL	FASTEN BEAM PLYS: 2- ROWS OF 12d @ 12" O.C. EACH SIDE, TYPICAL
BM3	(2) 2x12 #2 SYP w/ 3/4" OSB FLITCH PLATE	FASTEN BEAM PLYS: 2- ROWS OF 12d @ 12" O.C. EACH SIDE, TYPICAL	FASTEN BEAM PLYS: 2- ROWS OF 12d @ 12" O.C. EACH SIDE, TYPICAL
BM4	(2) 1½"x11" LVL 2.0E Fb=2600 PSI	CMU COLUMN (2) HTS20 CMU COLUMN (2) HETA16 U.N.O. ON FRAMING PLATE	WOOD POST (2) HTS20 CMU COLUMN (2) HETA16 U.N.O. ON FRAMING PLATE
BM5	(2) 1½"x11½" LVL 2.0E Fb=2600 PSI	FASTEN BEAM PLYS: 2- ROWS OF 16"x3½" SDS WD SCREWS @ 16" O.C. TYP. EA. SIDE	FASTEN BEAM PLYS: 2- ROWS OF 16"x3½" SDS WD SCREWS @ 16" O.C. TYP. EA. SIDE
BM6	(2) 1½"x16" LVL 2.0E Fb=2600 PSI	FASTEN BEAM PLYS: 2- ROWS OF 12d @ 12" O.C. EACH SIDE, TYPICAL	FASTEN BEAM PLYS: 2- ROWS OF 12d @ 12" O.C. EACH SIDE, TYPICAL
BM7	(2) 2x10 #2 SYP w/ 1" FLITCH PLATE	FASTEN BEAM PLYS: 2- ROWS OF 12d @ 12" O.C. EACH SIDE, TYPICAL	FASTEN BEAM PLYS: 2- ROWS OF 12d @ 12" O.C. EACH SIDE, TYPICAL
BM8	(3) 1½"x9 ½" LVL 2.0E Fb=2600 PSI x/12" OSB FLITCH PLATE	FASTEN BEAM PLYS: 2- ROWS OF 16"x3½" SDS WD SCREWS @ 16" O.C. TYP. EA.	FASTEN BEAM PLYS: 2- ROWS OF 16"x3½" SDS WD SCREWS @ 16" O.C. TYP. EA.



GENERAL BEAM NOTES:  
 1. VERIFY WITH PLAN CORRECT LENGTH OF BEAMS REQUIRED (MIN 4" BEARING EACH END)  
 2. SEE PLAN FOR TOP OR BOTTOM OF BEAM INDICATIONS  
 3. BEAMS ARE NOT TO BE DRILLED OR NOTCHED IN ANY WAY WITHOUT WRITTEN APPROVAL FROM THE E.O.R.

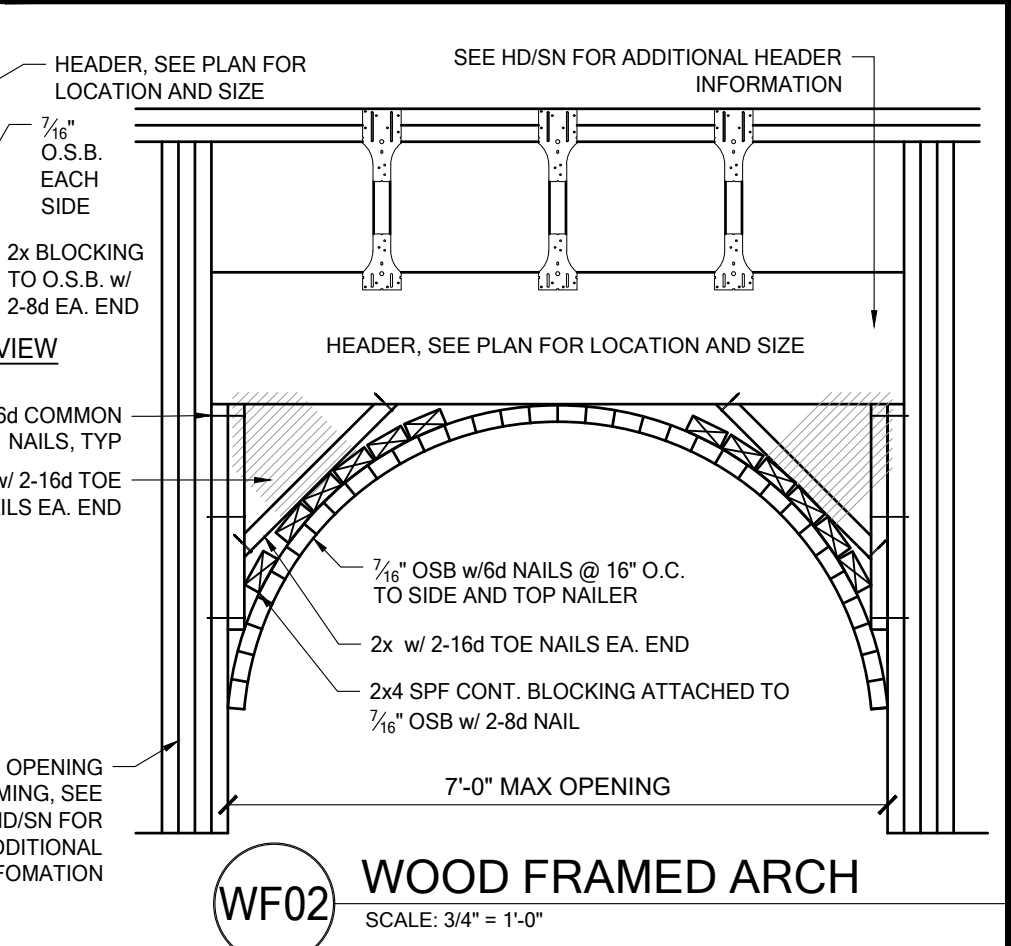


SIMPSON STRONG TIE (C-C-2021)					USP MANUF, INC. (60TH EDITION)				
MARK	TYPE	CONNECTOR & FASTENERS	SYP	SPF	CONNECTOR & FASTENERS	SYP	SPF		
A	FRAME TO MASONRY	HETA16 w/ (9)10d x 1 1/2" OR HETA20 w/ (9)10d x 1 1/2"	1810		HTA16 w/ (9)10d x 1 1/2" OR HTA20 w/ (9)10d x 1 1/2"	1870	1730		
B	FRAME TO FRAME	H24 w/ (10)8 x 1 1/2" NAILS	700	615	RT74 w/ (10)8 x 1 1/2" NAILS	630	510		
C	FRAME TO FRAME	H10A w/ (10)10d x 1 1/2" OR H10A-2 w/ (10)8 x 1 1/2" AT PLY TRUSSES	1040	1015	RT164 w/ (10)10d x 1 1/2" & 8-10d RT 16-2 w/ (10)8 & 8d AT PLY TRUSSES	1025	900		
D	FRAME TO FRAME	MTS12 w/ (14)10d x 1 1/2" (AT EXTERIOR LOCATION INCLUDE (6)12A TONENALS)	990	850	MTG15 w/ (14)10d x 1 1/2" (AT EXTERIOR LOCATION INCLUDE (6)12A TONENALS)	965	810		
E	FRAME TO MASONRY	MG7 w/ (2)10d NALS AND 5/8" A.T. w/ 12" EMBEDMENT w/ SIMPSON "SET" EPOXY	3965	3330	MU215 w/ (2)10d NALS AND 5/8" A.T. w/ 12" EMBEDMENT w/ SIMPSON "SET" EPOXY	4240	3710		
F	FRAME TO FRAME	HTS20 w/ (16)10d x 1 1/2" (AT EXTERIOR LOCATION INCLUDE (6)12A TONENALS)	1415	1225	HTW20 w/ (16)10d x 1 1/2" (AT EXTERIOR LOCATION INCLUDE (6)12A TONENALS)	1355	1140		
F1	FRAME TO FRAME	(2) HTS20 w/ (36)10d x 1 1/2" (AT EXTERIOR LOCATION INCLUDE (6)12A TONENALS)	2830	2430	(2) HTW20 w/ (40)10d x 1 1/2" (AT EXTERIOR LOCATION INCLUDE (6)12A TONENALS)	2710	2280		
G	FRAME TO MASONRY	HGT-7 w/ (16)10d NALS AND (2) 3/4" A.T. w/ 12" EMBEDMENT w/ SIMPSON "SET" EPOXY (HGT-3 FOR 3-PLY)	10690	10590	HUC72 w/ (16)10d NALS AND (2) 3/8" T.R. w/ 12" EMBEDMENT w/ SIMPSON "SET" EPOXY (HUG73 FOR 3-PLY)	9575	6925		
H	FRAME TO MASONRY	FGTR w/ (18) 1/4" x 3 SDS WOOD SCREWS AND (12) 1/2" x 3" TAPSCREWS (TO M.S.)	4725	3400	REFUS w/ (12) WSS WOOD SCREWS AND (4) 3/4" x 4" WEDGE-BOLT	7100			
I	FRAME TO MASONRY / FRAME	(2) LGT2 x (2) 1/4" x 32D SINKERS & (14) 1/4" x 2 1/4" TITEN TURBO (2 PLY TRUSS)	4060-M / 4060-F	3500-M / 3510-F	(2) LGUT2 x (2) 1/4" x 32D SINKERS & (10) 1/4" x 3" WEDGE-BOLT (2 PLY TRUSS) OR (2) LGT2 x (2) 1/4" x 32D SINKERS & (10) 1/4" x 3" WEDGE-BOLT (FOR FRAME EA)	3100-M / 3060-F	2925-M / 2880-F		
J3	FRAME TO MASONRY / FRAME	(2) LGT3 x (24) 1/4" x 32D SINKERS & (8) 5/8" x 5" TITEN (2 PLY TRUSS) OR (28) 1/4" x 32D SINKERS FOR FRAME (EA)	6570-M / 6960-F	5700-M / 6100-F	(2) LGUT3 x (24) 1/4" x 32D SINKERS & (8) 5/8" x 5" WB (3 PLY TRUSS) OR (28) 1/4" x 32D SINKERS FOR FRAME (EA)	6760-M / 7000-F	6180-M / 6760-F		
K	BEAM TO MASONRY	H4U10 OPT HUC40 w/ (18) 16d TITEN TURBO 1/4" x 2 1/4" & (10) 10d NALS	GK4520 / GR1795	GK2550 / GR2850	HD410 OPT HD410F w/ (20) 16d & (10) 10d NALS	GK4800 / GR1950	GK5850 / GR2150		
L	BEAM TO MASONRY / FRAME	(2) HETA16 OPT HUC40 w/ (6) 10d NALS & (12) 1/4" x 3" TITEN TURBO (TO M.S.) OR (12) HETA16 & 6 10d (FOR FRAME)	GK4500 / GR1800	GK2465 / GR1135 SYP-M	HD46 OPT HUC40 w/ (6) 10d NALS & (12) 3/16" x 1 3/4" TAPSCREWS (TO M.S.) OR (12) HETA16 & 6 10d (FOR FRAME)	GK4900 / GR1170 SYP-M	GK1850 / GR1170 SYP-F		
M	FRAME TO MASONRY	(2) HETA16 (2) HTA20 1-PLY w/ (16)10d NALS & 1/2" PLY w/ (12) 16d	1920	2365	(2) HTA16 (2) HTA20 1-PLY w/ (16)10d NALS & 1/2" PLY w/ (12) 16d	2430	-		
N	FRAME TO MASONRY	HTSM16 w/ (8)10d NALS AND (4) 1/4" x 1/4" TITEN TURBO	910	955	HTWM16 w/ (8)10d NALS AND (4) 1/4" x 1/4" WEDGE-BOLT	1230	1145		
P	FRAME TO MASONRY	HTSM20 w/ (10)10d NALS AND (4) 1/4" x 1/4" TITEN TURBO	1110	955	HTWM20 w/ (10)10d NALS AND (4) 1/4" x 1/4" WEDGE-BOLT	1225	1145		
Q	FRAME TO MASONRY	HTH5 w/ (8) 8d x 1 1/2" NAILS AND (2) 3/8" x 4" TITEN	910	785	LUGT1 w/ (8) 8d x 1 1/2" NAILS AND (2) 3/8" x 4" TITEN	1045	920		
R	FRAME TO MASONRY	HTT2 w/ (8) 1/4" x 1 1/2" SDS WOOD SCREWS AND (1) 1/2" x 4" A.T. EPOXIED W/ SIMPSON "SET" (SEE NOTE #4 BELOW)	2145	1835	DTB-72 w/ (8) 1/4" x 1 1/2" WSS10 WOOD SCREWS AND (1) 1/2" x 4" A.T. EPOXIED W/ SIMPSON "SET" (SEE NOTE #4 BELOW)	1835	1510		
S	FRAME TO MASONRY	HTT5 w/ (26) 10d x 1 1/2" NALS AND (1) 5/8" x 4" A.T. EPOXIED W/ SIMPSON "SET" (SEE NOTE #4 BELOW)	4350	3740	HTT5 w/ (26) 10d x 1 1/2" NALS AND (1) 5/8" x 4" A.T. EPOXIED W/ SIMPSON "SET" (SEE NOTE #4 BELOW)	5005			
T	FRAME TO MASONRY	HTT4 w/ (18) 16d x 1/2" NALS AND (1) 5/8" x 4" A.T. EPOXIED W/ SIMPSON "SET" (SEE NOTE #4 BELOW)	4235	3640	HTT4 w/ (18) 16d x 1/2" NALS AND (1) 5/8" x 4" A.T. EPOXIED W/ SIMPSON "SET" (SEE NOTE #4 BELOW)	4160	-		
U	FRAME TO FRAME	HMRK w/ (24) 10d x 1 1/2" NALS	910	785	LUGT1 w/ (23) 8d x 1 1/2" NALS	1045	920		
V	FRAME TO MASONRY	HMRK w/ (4) 1/4" x 1 1/2" SDS WOOD SCREWS & (5) 10d x 1 1/2" TAPSCREWS	760	760	RT6M w/ (9) 10d x 1 1/2" NALS & (4) 1/4" x 1 3/4" TAPSCREWS	1395	1225		
V	FRAME TO MASONRY	YGT w/ (16) 1/4" x 3/4" SDS WOOD SCREWS & (1) 5/8" x 4" A.T. EPOXIED W/ SIMPSON "SET" w/ 12" MIN. EMBEDMENT	4940	3555					
W	FRAME TO MASONRY	(2) YGT w/ (30) 1/4" x 3/4" SDS WOOD SCREWS & (2) 5/8" x 4" A.T. EPOXIED W/ SIMPSON "SET" w/ 12" MIN. EMBEDMENT	7185	5170					
X	FRAME TO MASONRY	YGT w/ (16) 1/4" x 3/4" SDS WOOD SCREWS & HD4-SDS2 w/ (10) 1/4" x 1 1/2" SDS WOOD SCREWS & (1) 5/8" x 4" A.T.	4940	3555	MUGT15 w/ (28) 10d NALS & HTT45 w/ (18) 10d NALS & (1) 5/8" x 4" A.T.	4215			
Y	FRAME TO FRAME	(2) HTT5 w/ (26) 16d x 1/2" NALS & (2) 5/8" x 4" A.T. (SEE NOTE #4)	10180	8750	(2) HTT45 w/ (26) 16d x 1/2" NALS & (1) 5/8" x 4" A.T. (SEE NOTE #4)	5005			

GENERAL CONNECTOR NOTES:  
 1. CONNECT ALL FLOOR TRUSSES TO INTERIOR BEARING WOOD WALLS / BEAMS w/ (2) 12d TOENAILS.  
 2. ALL TRUSS TO TRUSS CONNECTIONS ARE PROVIDED BY TRUSS MANUFACTURER, U.N.O. ON PLAN.  
 3. G.C. MAY USE EITHER SIMPSON OR USP CONNECTIONS. SEE FRAMING PLAN FOR CONNECTOR CALL OUT.  
 4. FOR SINGLE PLY TRUSSES, SCALE ON FULL HEIGHT @ 1/2" x 24" TO TRUSS MANUFACTURER FOR 10d NAILS @ 3" O.C. STAGGERED.  
 5. MINIMUM A.T.R. EMBEDMENT: 5" EMBEDMENT FOR 1/2" A.T.R. 6" EMBEDMENT FOR 3/8" A.T.R. 8" EMBEDMENT FOR 7/8" A.T.R. (IF AT STEP, DEPTH IS FROM LOWER SLAB).

MINIMAL CONNECTOR UNO ON FRAMING PLAN		
1.	CONNECTION FOR ALL ROOF / FLOOR TRUSSES TO MASONRY WALLS / ICF WALLS UNO ON PLAN	
2.	CONNECTION AT 24" OR 32" O.C. PENDING VERICALS FOR ALL FLOOR TRUSSES PARALLEL TO MASONRY WALLS SEE DETAIL FB1203 FOR MORE INFORMATION	
3.	CONNECTION FOR ALL HIP JACK (CORNER JACK) TO MASONRY WALLS / ICF WALLS / LINTELS	
4.	CONNECTION FOR ALL CONTINUOUS RH BOARD TO TOP OF MASONRY AT 32" O.C. MAX. w/ (2) AT EACH CORNER G.C. TO VERIFY LOCATION DOES NOT COINCIDE W/ ICF (IF APPLICABLE) LAYOUT	
5.	CONNECT ALL FLOOR TRUSSES TO INTERIOR BEARING WOOD WALLS / BEAMS w/ (2) 12d TOENAILS	
MINIMAL CONNECTOR UNO ON FRAMING PLAN		
1.	CONNECTION FOR JACK TRUSS TO WOOD WALL OR BEAM	
2.	CONNECTION FOR ALL TRUSSES TO INTERIOR/EXTERIOR BEARING WOOD WALLS AND/OR BEAMS	

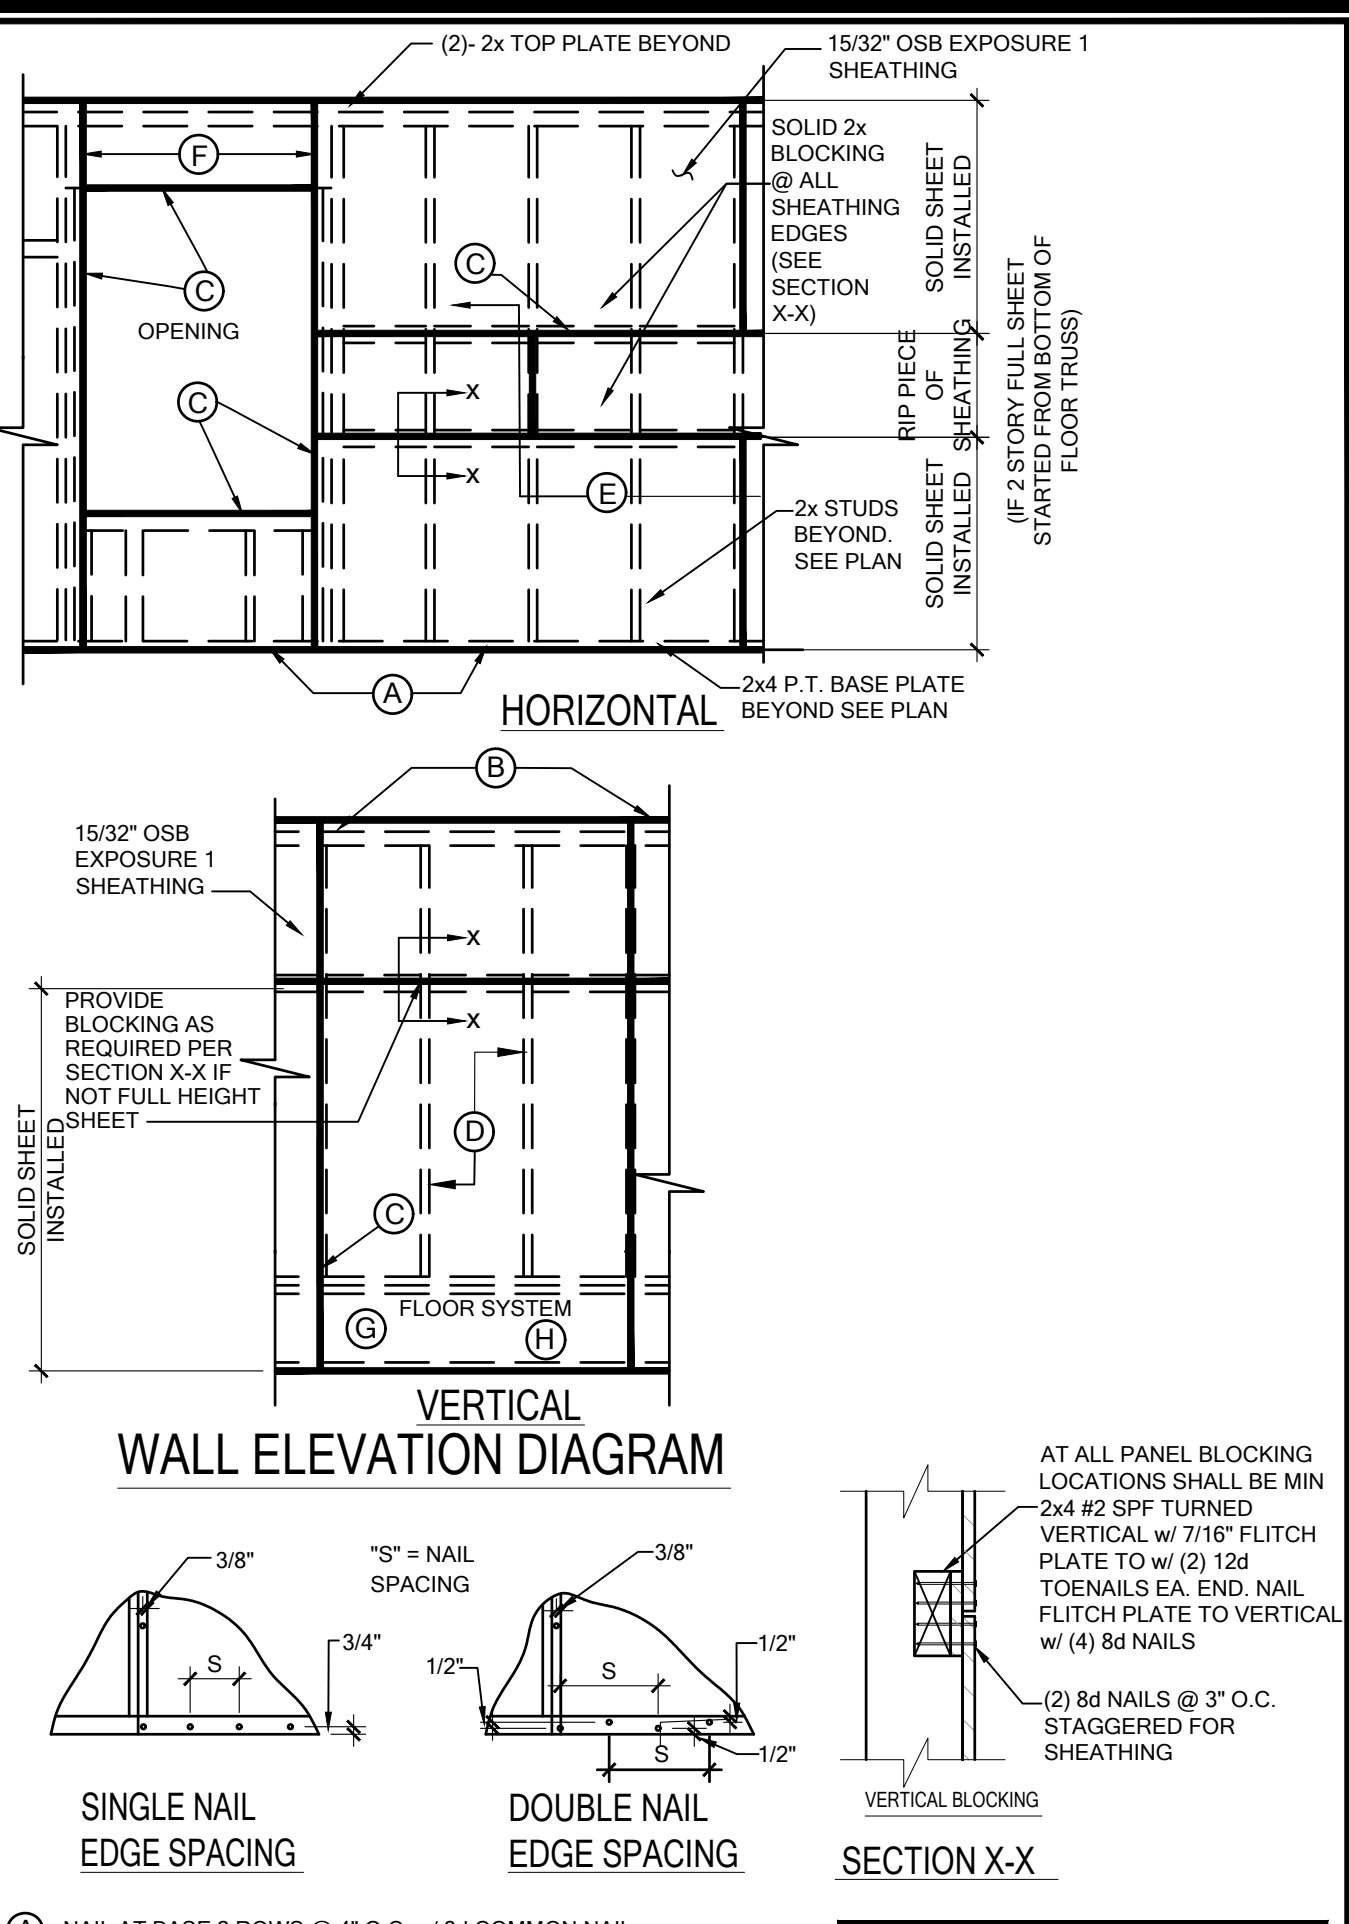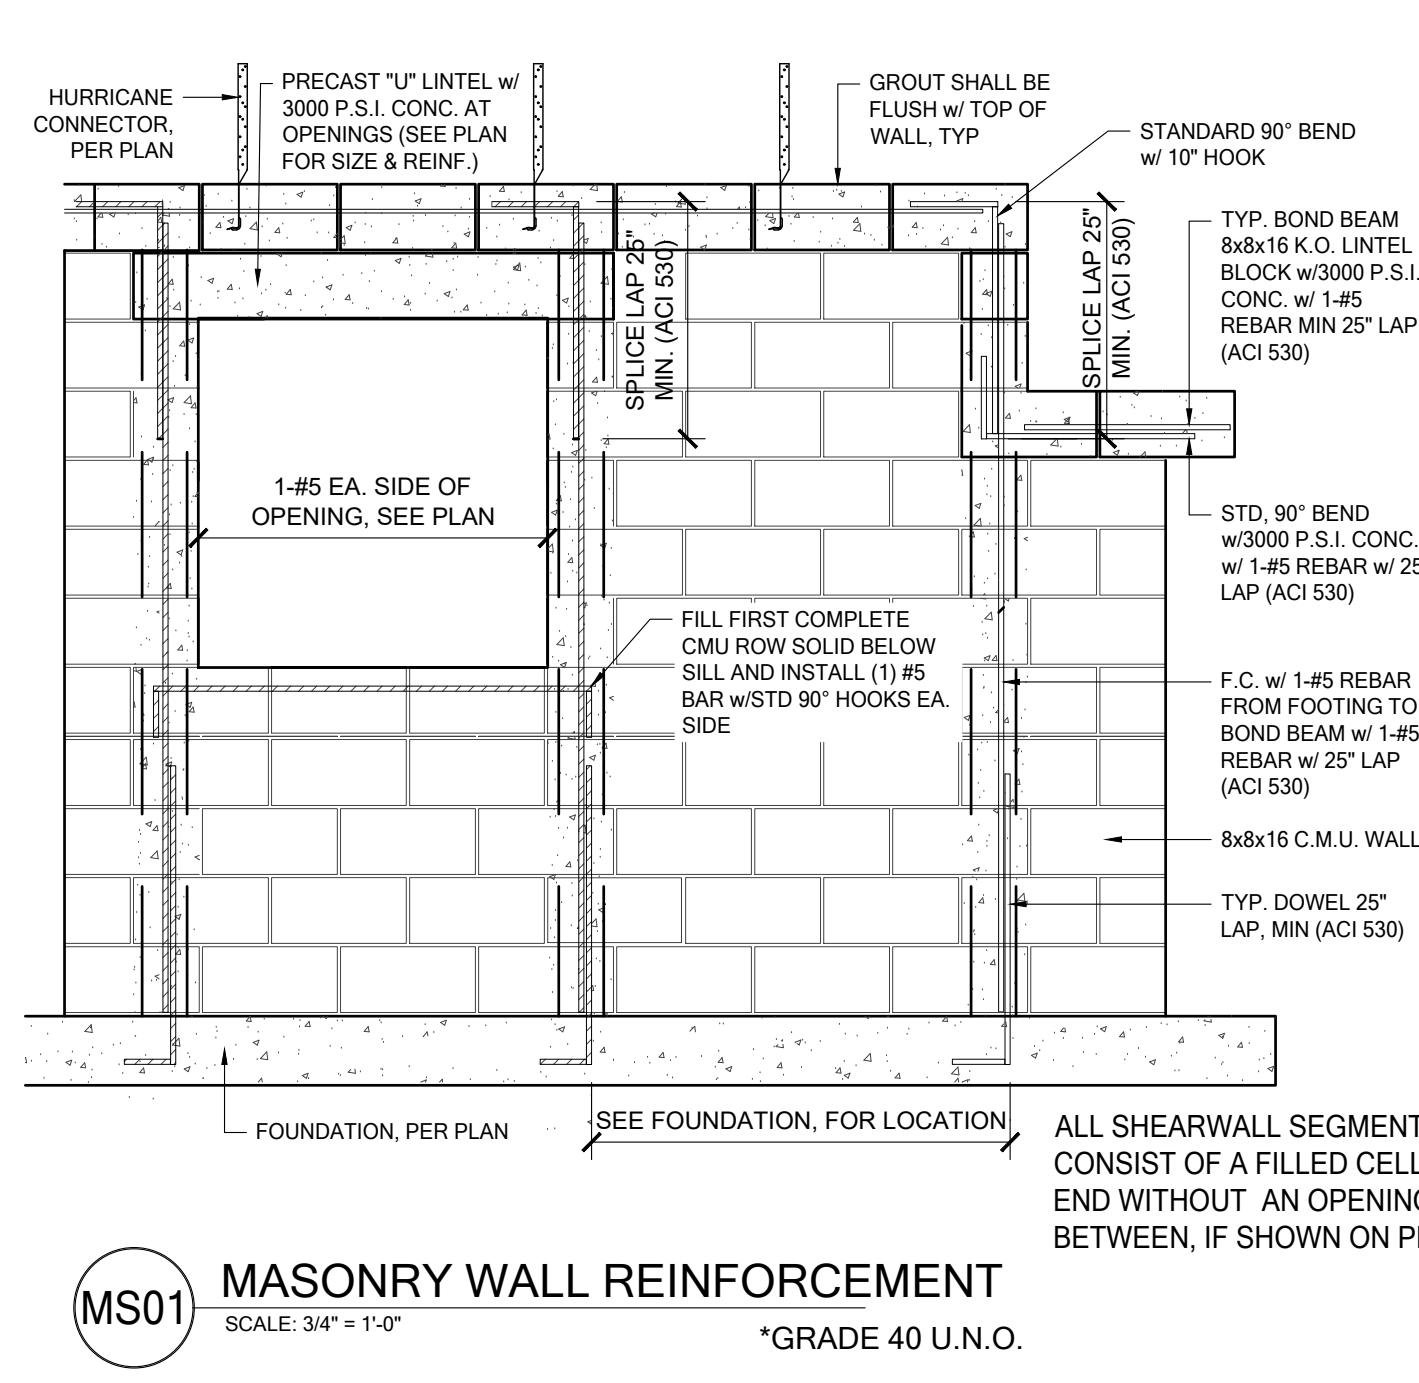

GENERAL CONNECTOR NOTES:  
 1. CONNECT ALL FLOOR TRUSSES TO INTERIOR BEARING WOOD WALLS / BEAMS w/ (2) 12d TOENAILS.  
 2. ALL TRUSS TO TRUSS CONNECTIONS ARE PROVIDED BY TRUSS MANUFACTURER, U.N.O. ON PLAN.  
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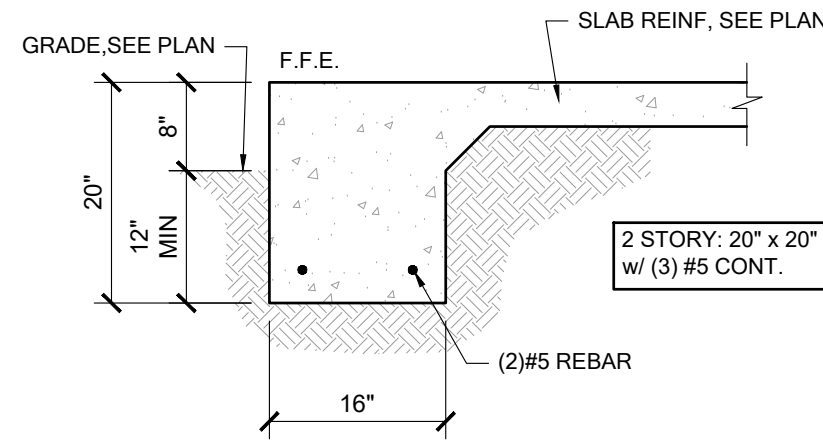
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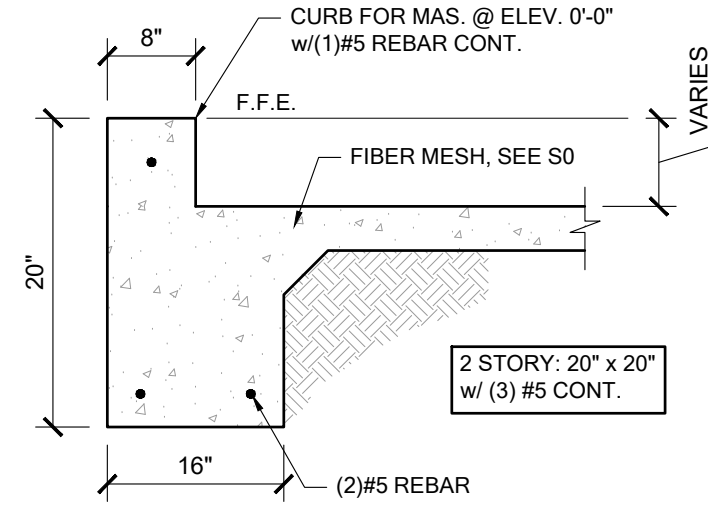
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 BABCOCK RANCH BLDG 6 (LOTS 6092-6099) 4 UNIT
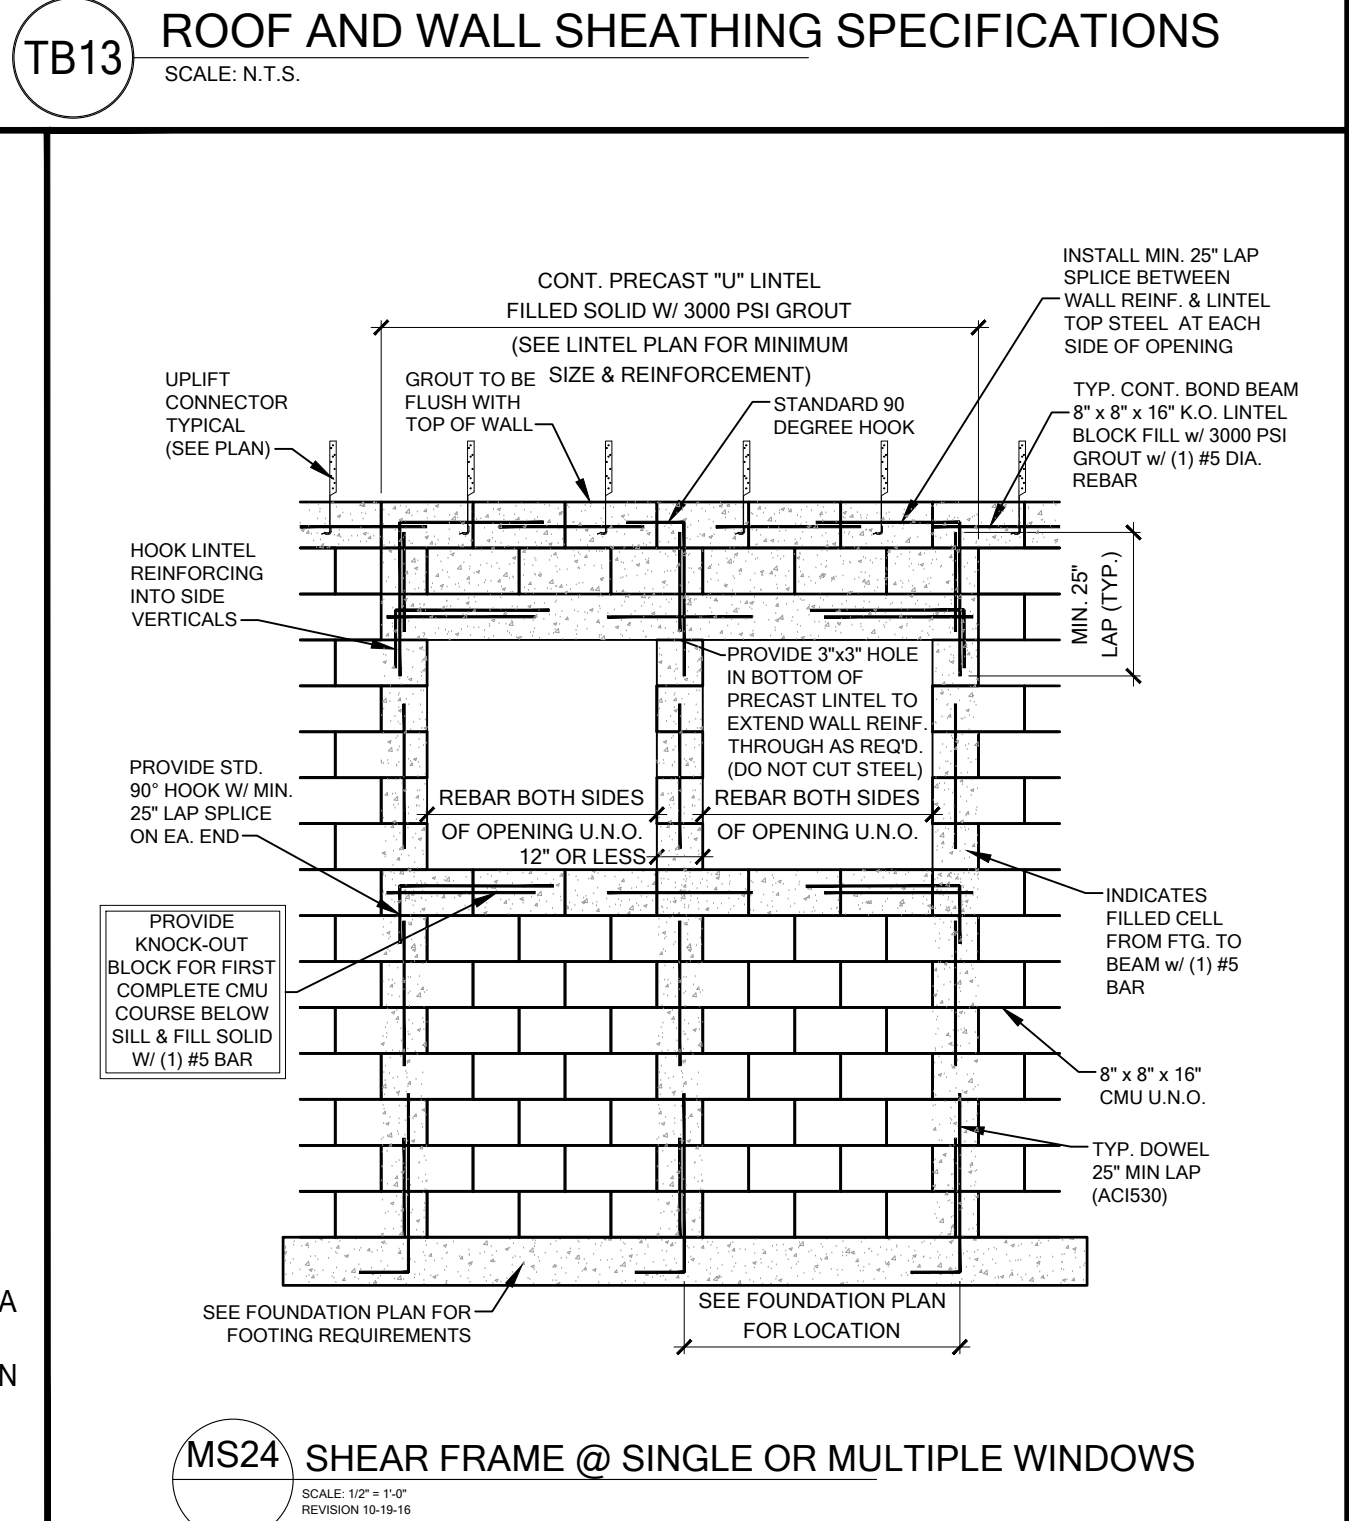
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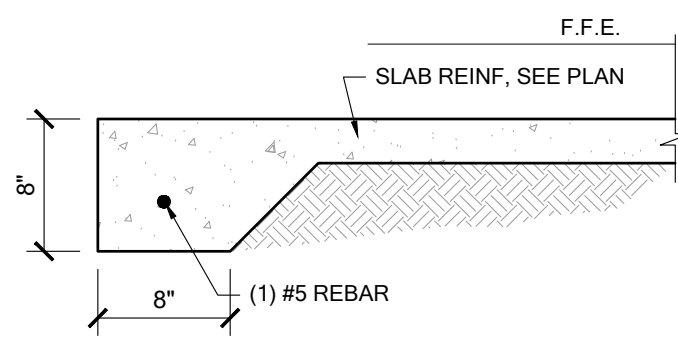
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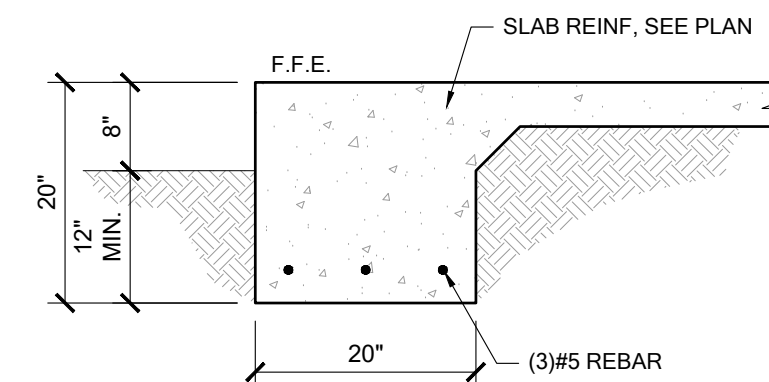
**FM01** SINGLE STORY FTG  
SCALE: 3/4" = 1'-0"




**FM02** SECTION @ GARAGE  
SCALE: 3/4" = 1'-0"




**FM03** THICKENED EDGE  
SCALE: 3/4" = 1'-0"




**FM08** 2-STORY FOOTING  
SCALE: 3/4" = 1'-0"

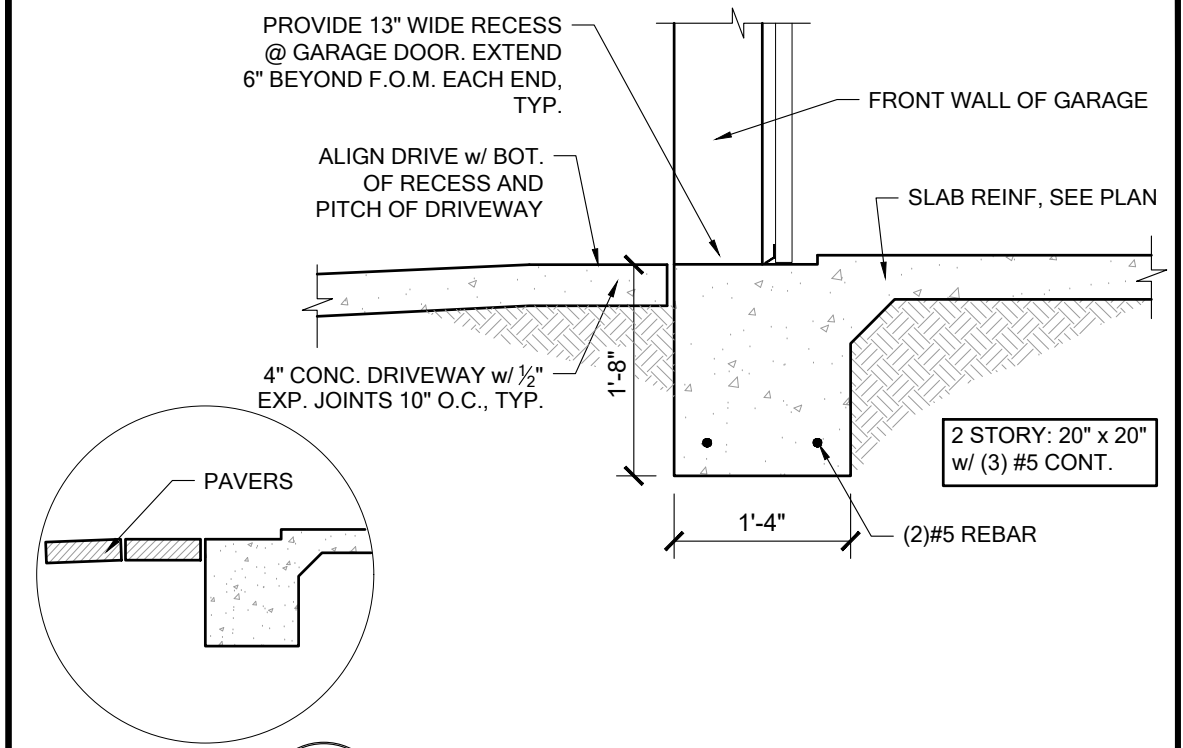


**FM09** SECTION @ GARAGE DOOR  
SCALE: 3/4" = 1'-0"

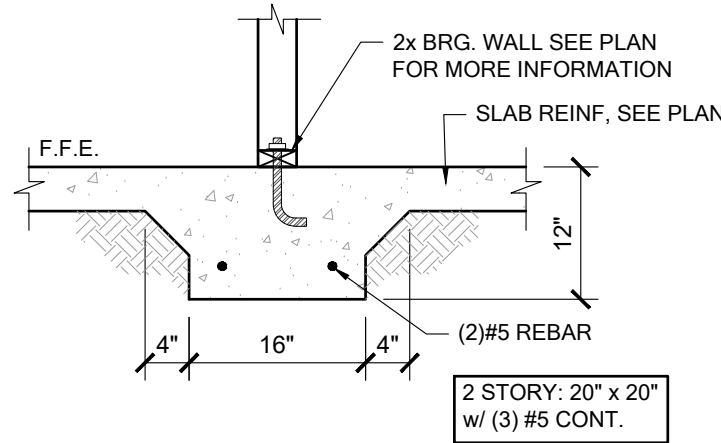


**FM10** INTERIOR BEARING WALL  
SCALE: 3/4" = 1'-0"

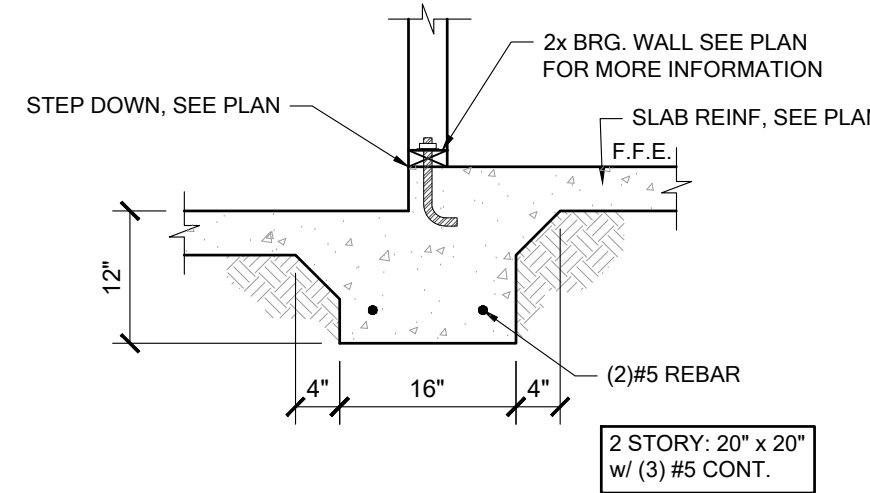


**FM11** STEP DOWN BEARING  
SCALE: 3/4" = 1'-0"

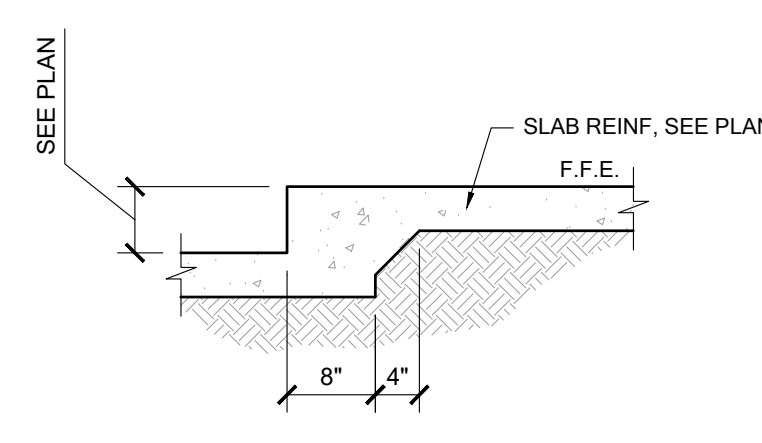


**FM12** STEP DOWN NON-BEARING  
SCALE: 3/4" = 1'-0"

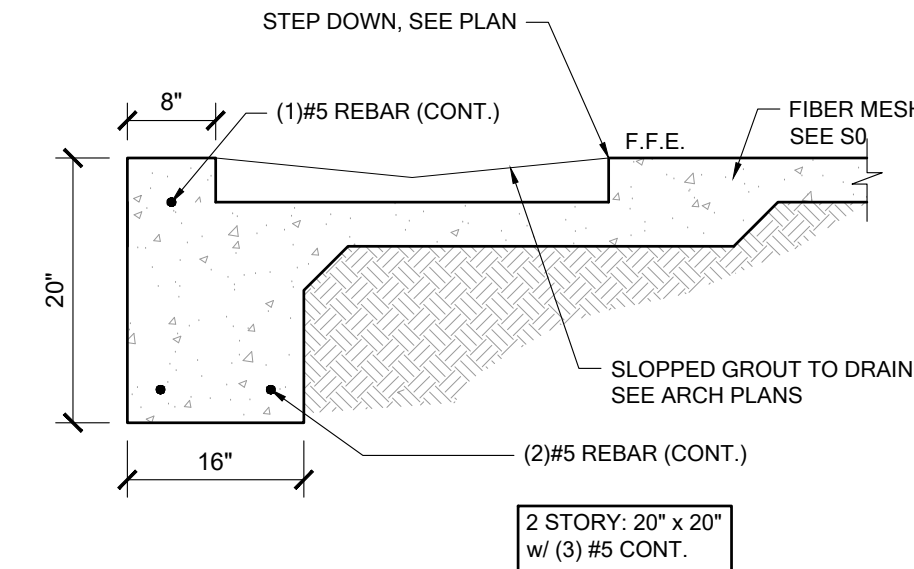


**FM14** SECTION @ SHOWER  
SCALE: 3/4" = 1'-0"

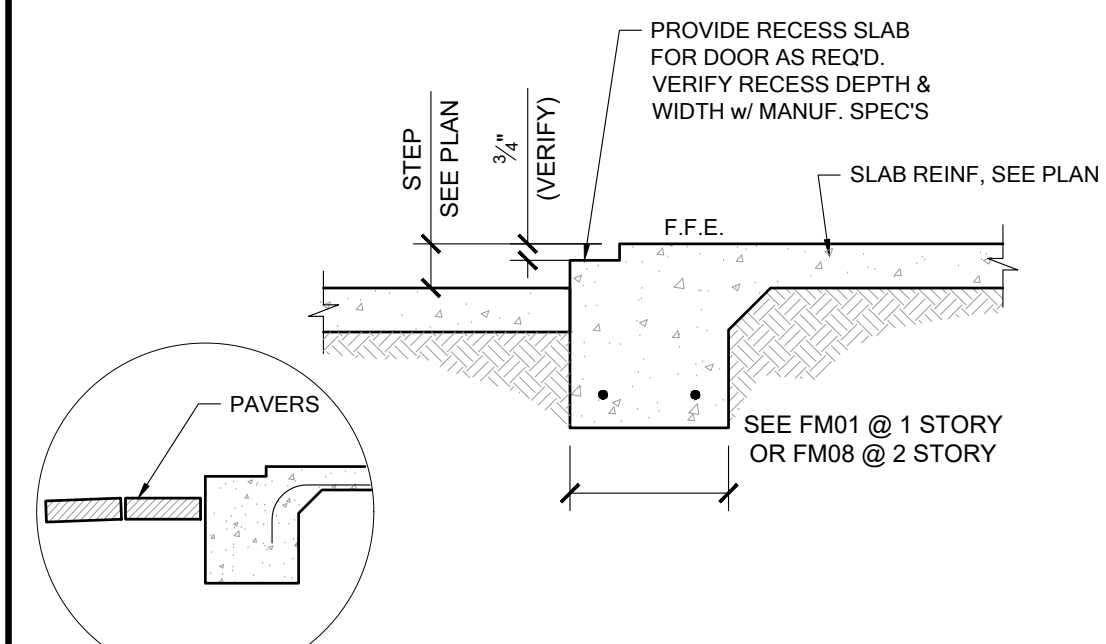


**FM15** EXTERIOR BEARING @ RECESS  
SCALE: 3/4" = 1'-0"

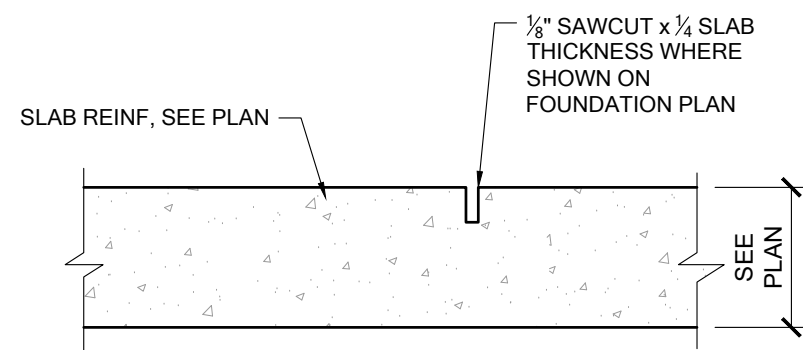


**FM20** CONTROL JOINT  
SCALE: 3/4" = 1'-0"

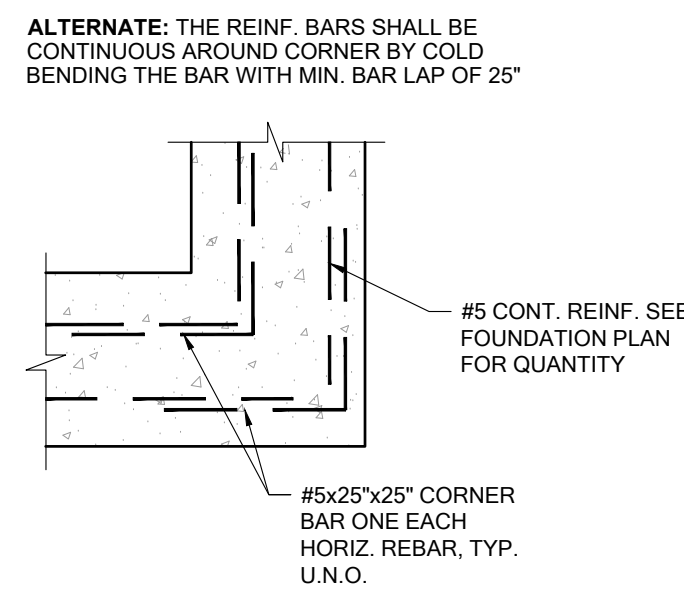


**FM19** TYP. CORNER BAR DETAIL  
SCALE: 3/4" = 1'-0"

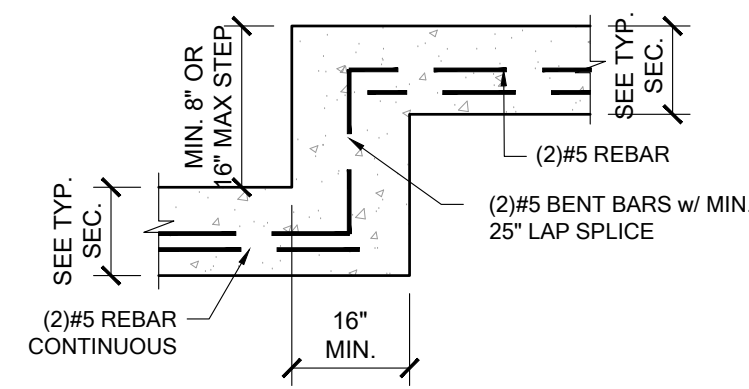

**FM18** TYP. STEP FOOTING DETAIL  
SCALE: 3/4" = 1'-0"

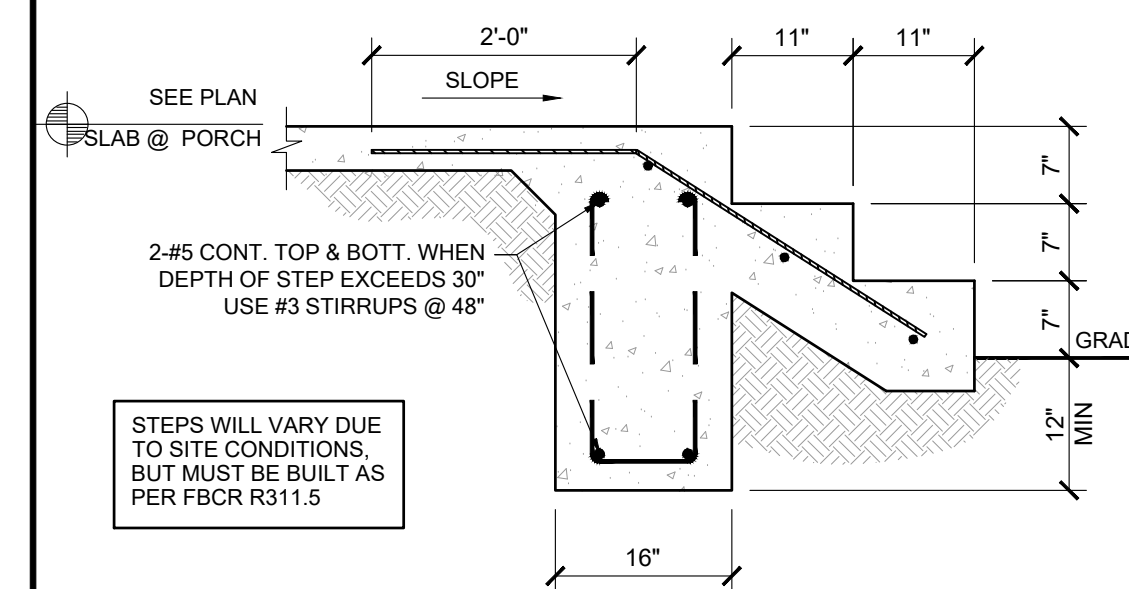


**FM22** PORCH STEP  
SCALE: 3/4" = 1'-0"

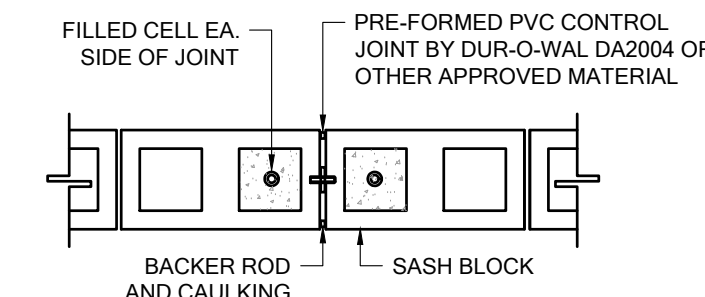


**FS12** SITE WALL DETAIL  
SCALE: 3/4" = 1'-0"


SITE WALL SCHEDULE				
SITE WALL HEIGHT (ft)	FOOTING SIZE WIDTH	FOOTING SIZE DEPTH	NUMBER/SIZE OF BARS	MAXIMUM DOWEL SPACING
0'-0" - 2'-8"	2'-0"	1'-0"	w/ (3) #5 CONT.	#5 @ 72" O.C.
>2'-8" - 5'-0"	3'-0"	1'-0"	w/ (3) #5 CONT.	#5 @ 48" O.C.
>5'-0" - 7'-0"	3'-4"	1'-0"	w/ (5) #5 CONT.	#5 @ 24" O.C.
>7'-0" - 8'-0"	4'-0"	1'-4"	w/ (5) #5 CONT. & #5 @ 32" O.C. TRANSV.	#6 @ 24" O.C.

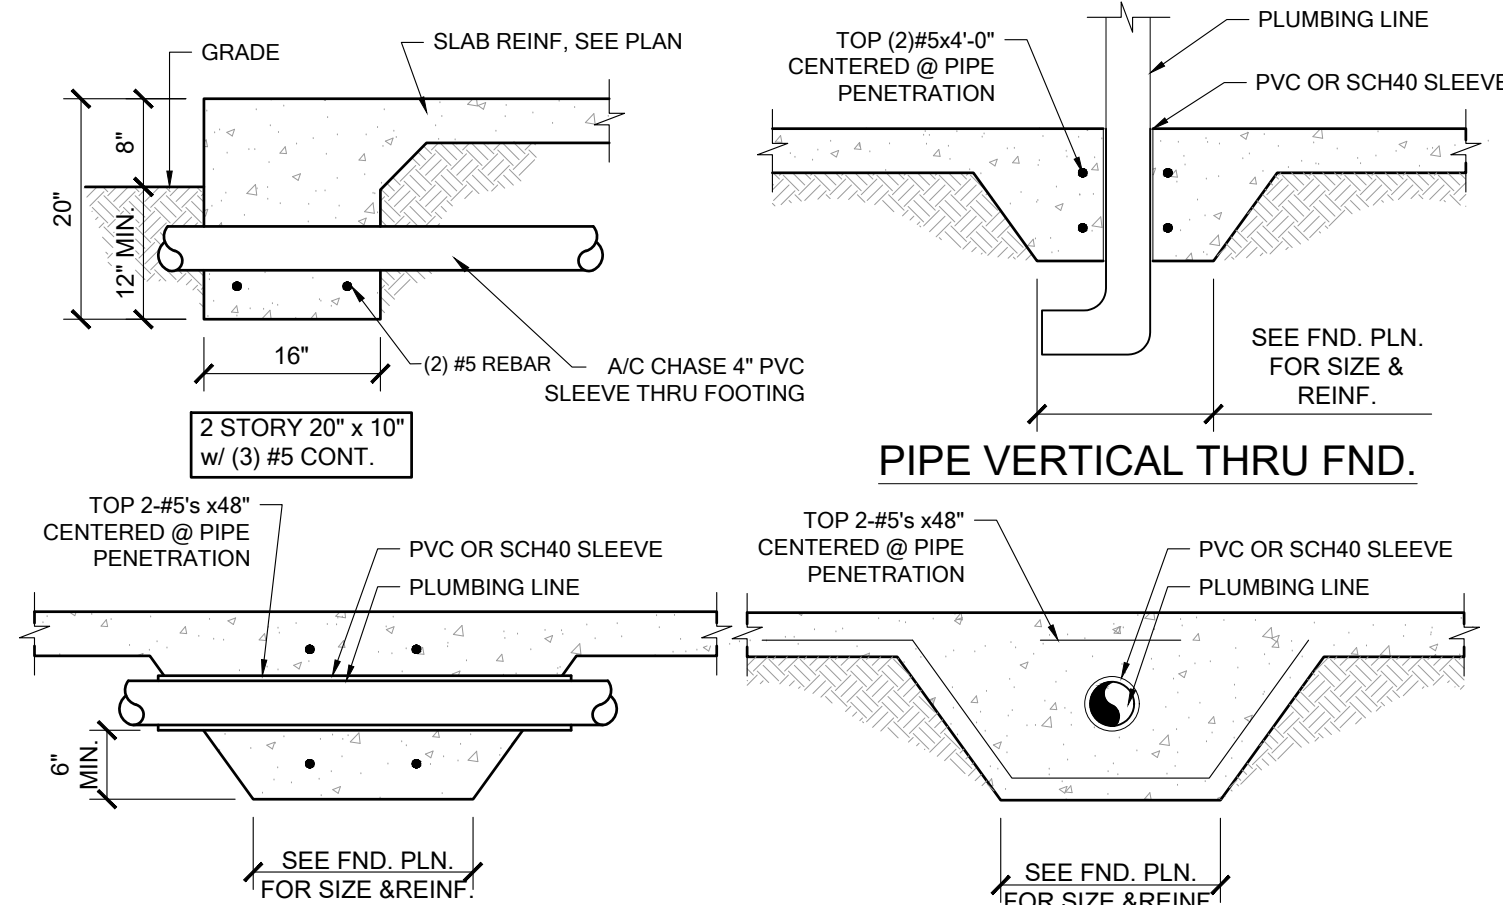

**FM23** FOUNDATION PENETRATIONS, TYPICAL  
SCALE: 3/4" = 1'-0"

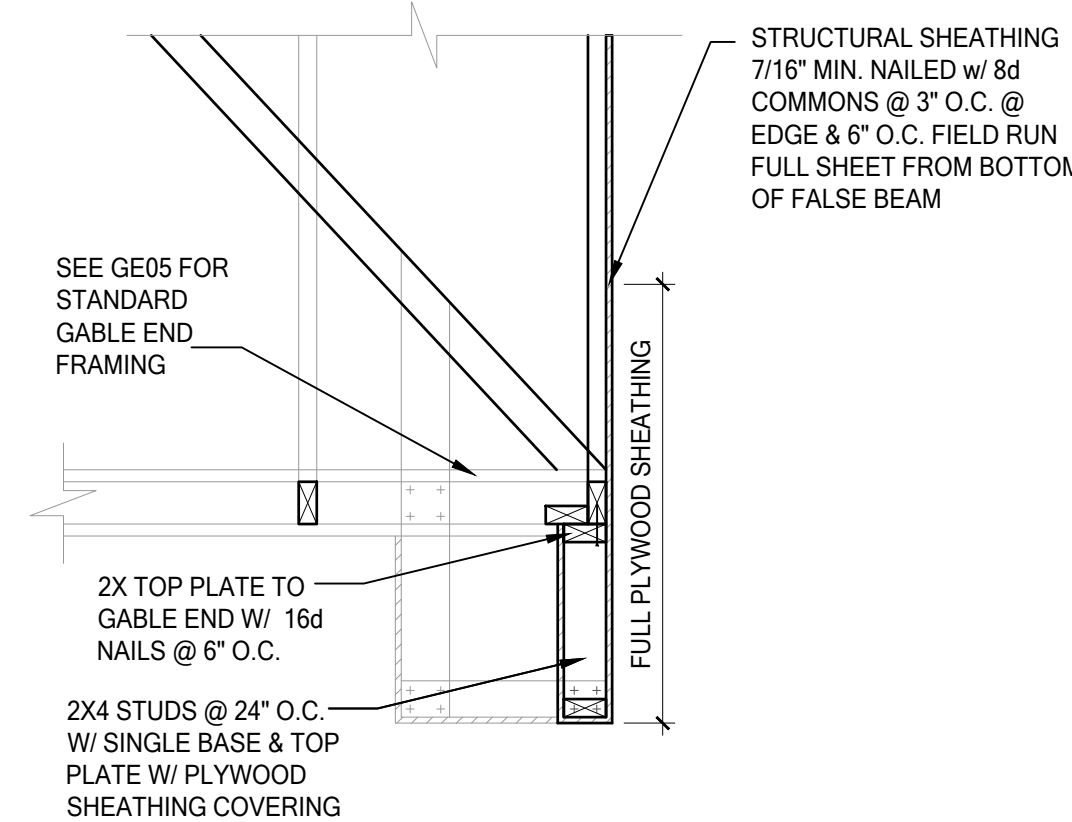

**GE15** FALSE BEAM @ GABLE END  
SCALE: 3/4" = 1'-0"

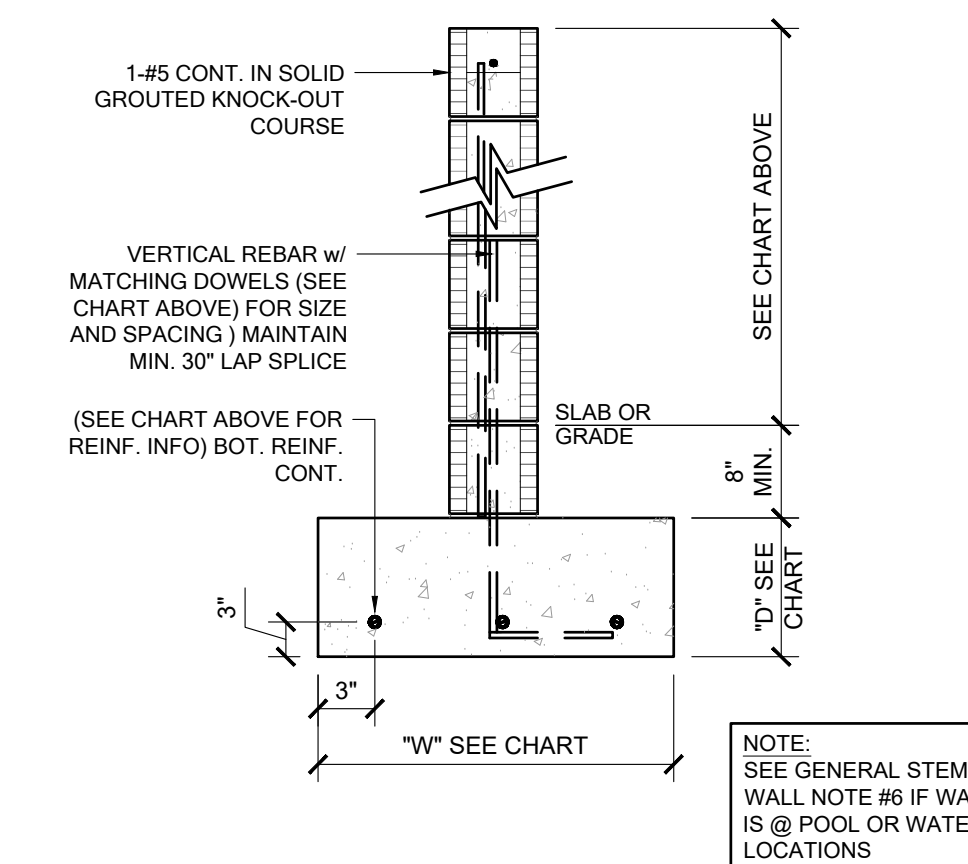

- CONTROL JOINTS TO BE LOCATED AT 20' O.C. MAX AND @
- G.C. TO COORDINATE ALL UTILITIES IN EASEMENT

**FS12** SITE WALL DETAIL  
SCALE: 3/4" = 1'-0"

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N.B.C.D.C. AMERICAN INSTITUTE OF BUILDING DESIGN







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ENGINEERING ASSOCIATES  
288 Southall Lane, Suite 200, Maitland, FL 32751  
(407) 829-8900  
Carla A. Brown, PE, FL #5628  
Scott Lewkowski, PE, FL #78790  
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**PARK SQUARE  
HORIZONS WEST  
BABCOCK RANCH BLDG 6 (LOTS 6092-6099) 4 UNIT**

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checked:  
drawn: BA  
date: 04-12-23  
scale:

**D1**




















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D2

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FDS JOB NO.:  
DATE: April 28, 2023

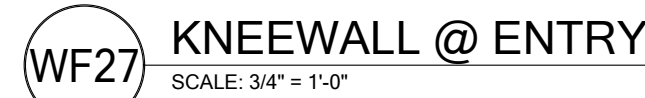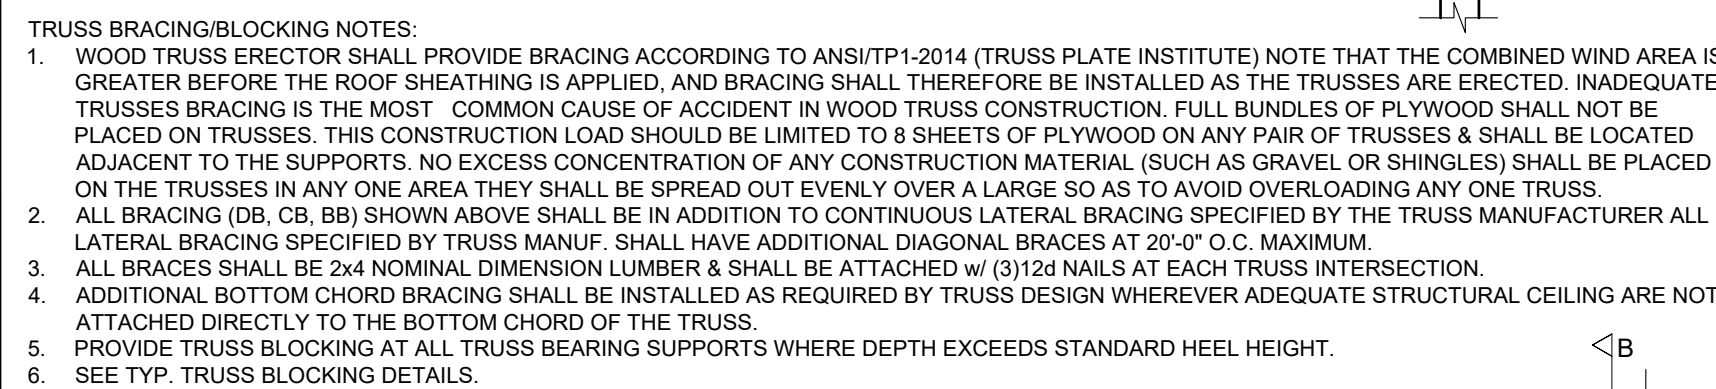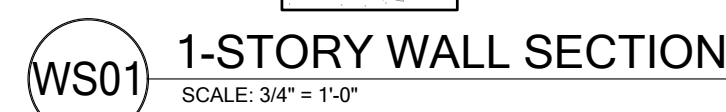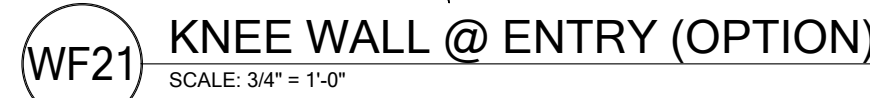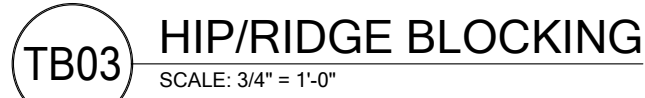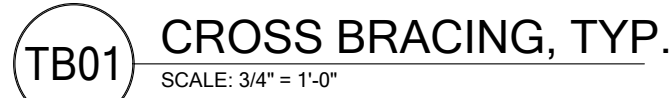**PARK SQUARE HORIZONS WEST**



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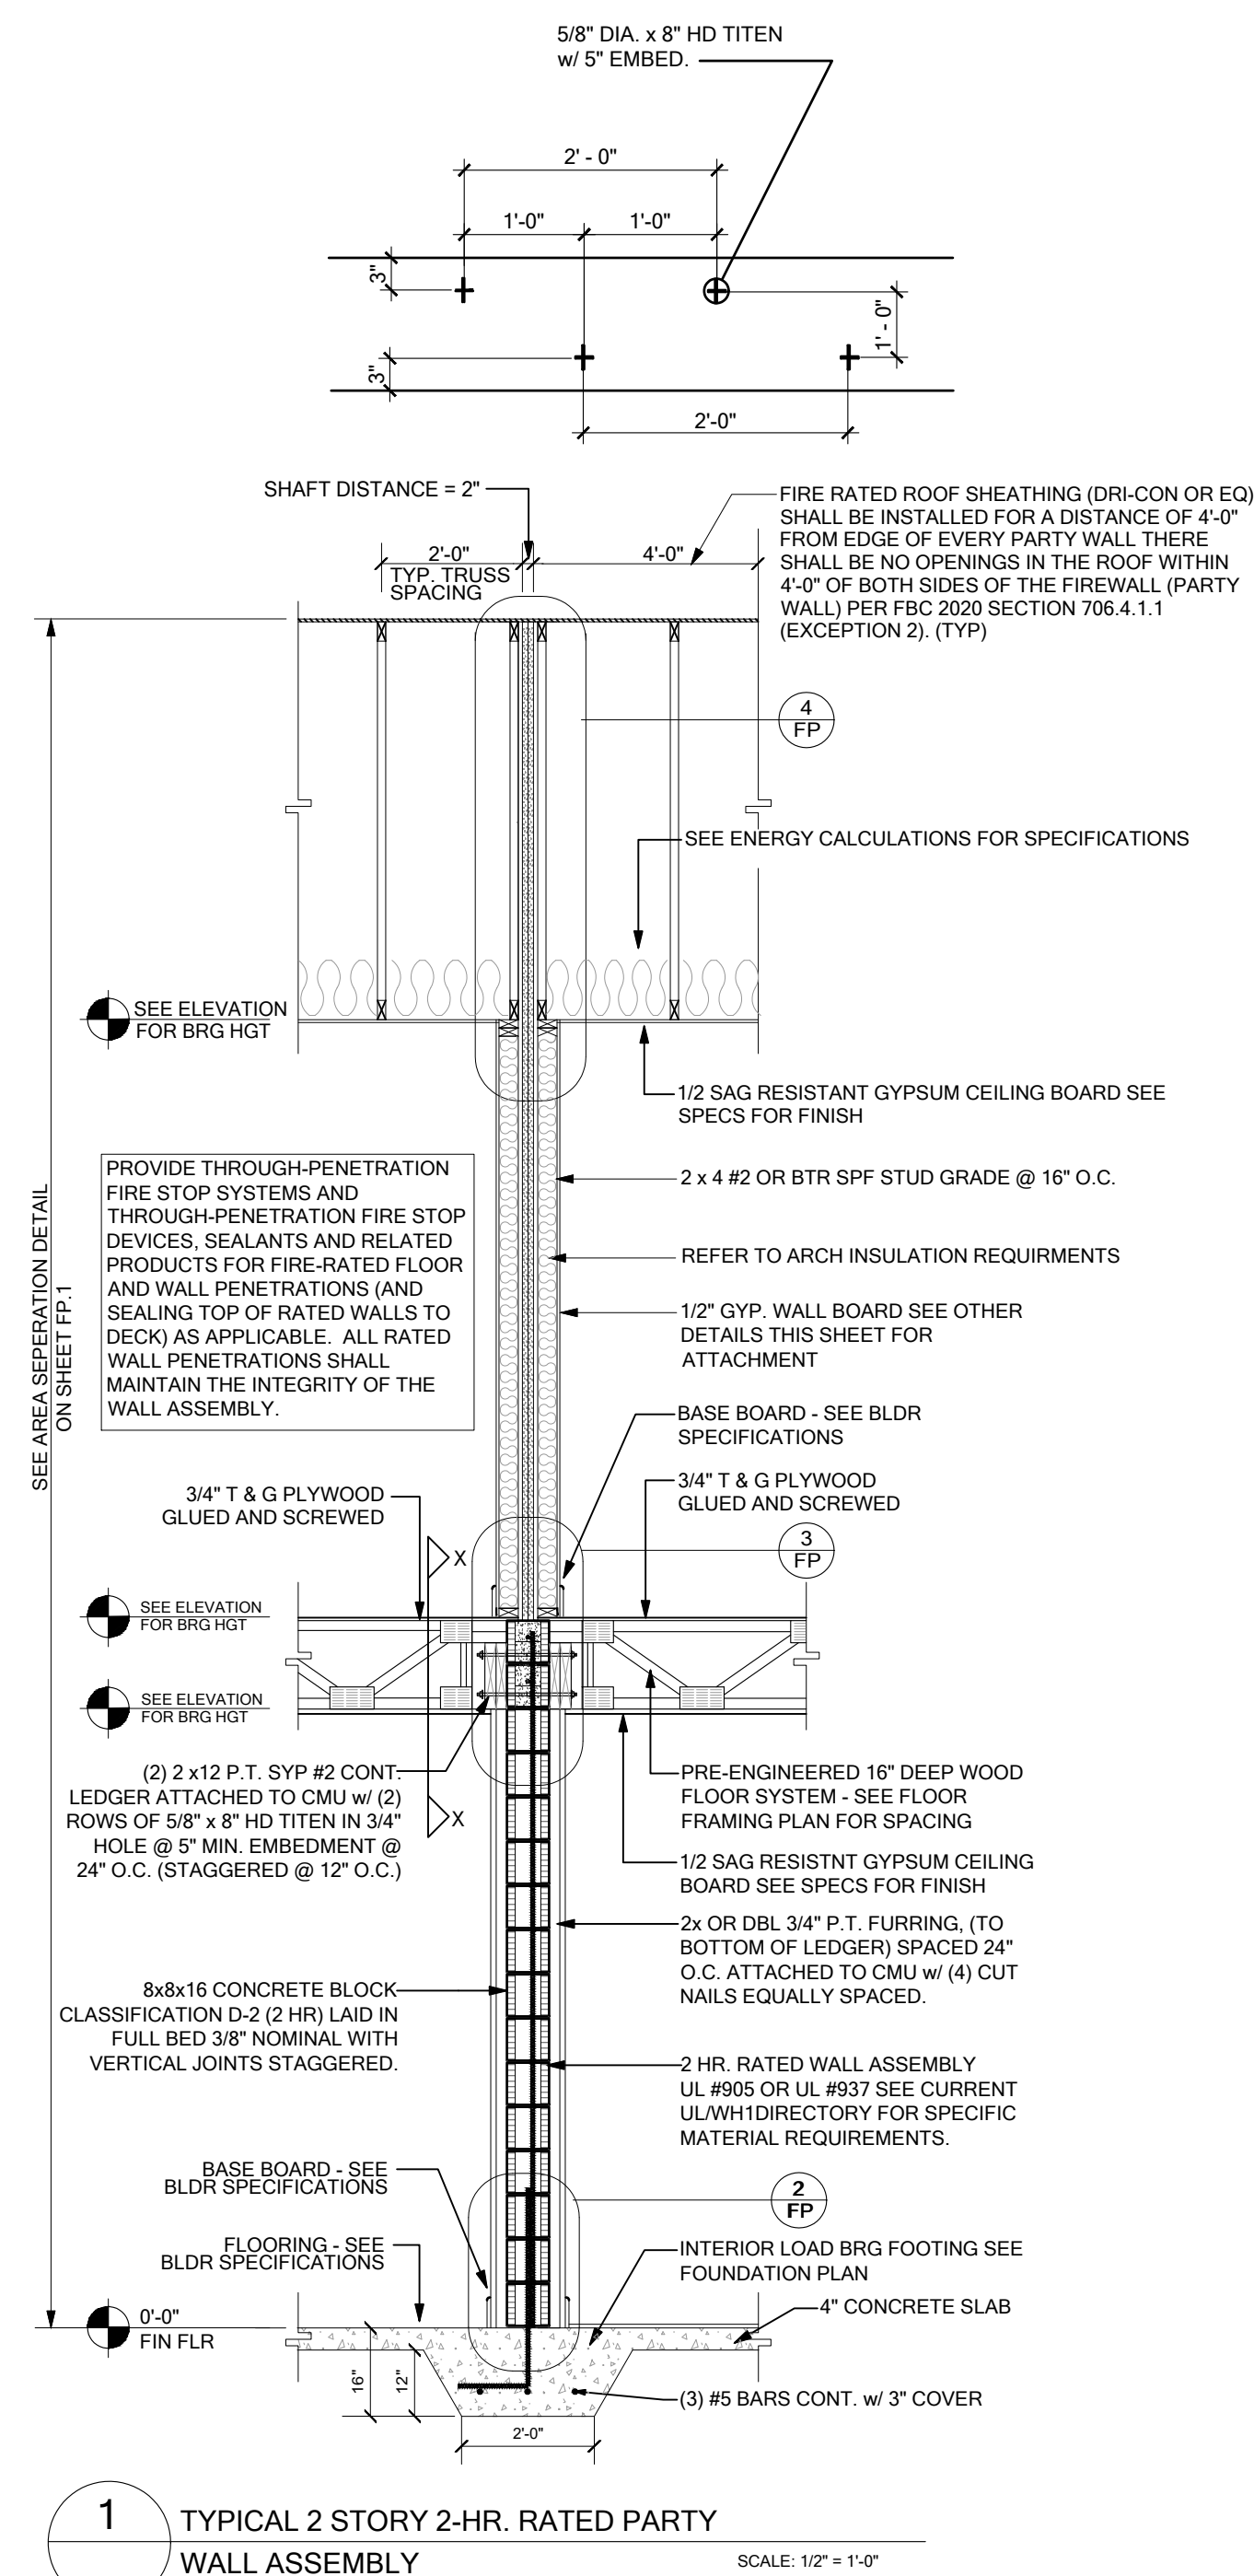
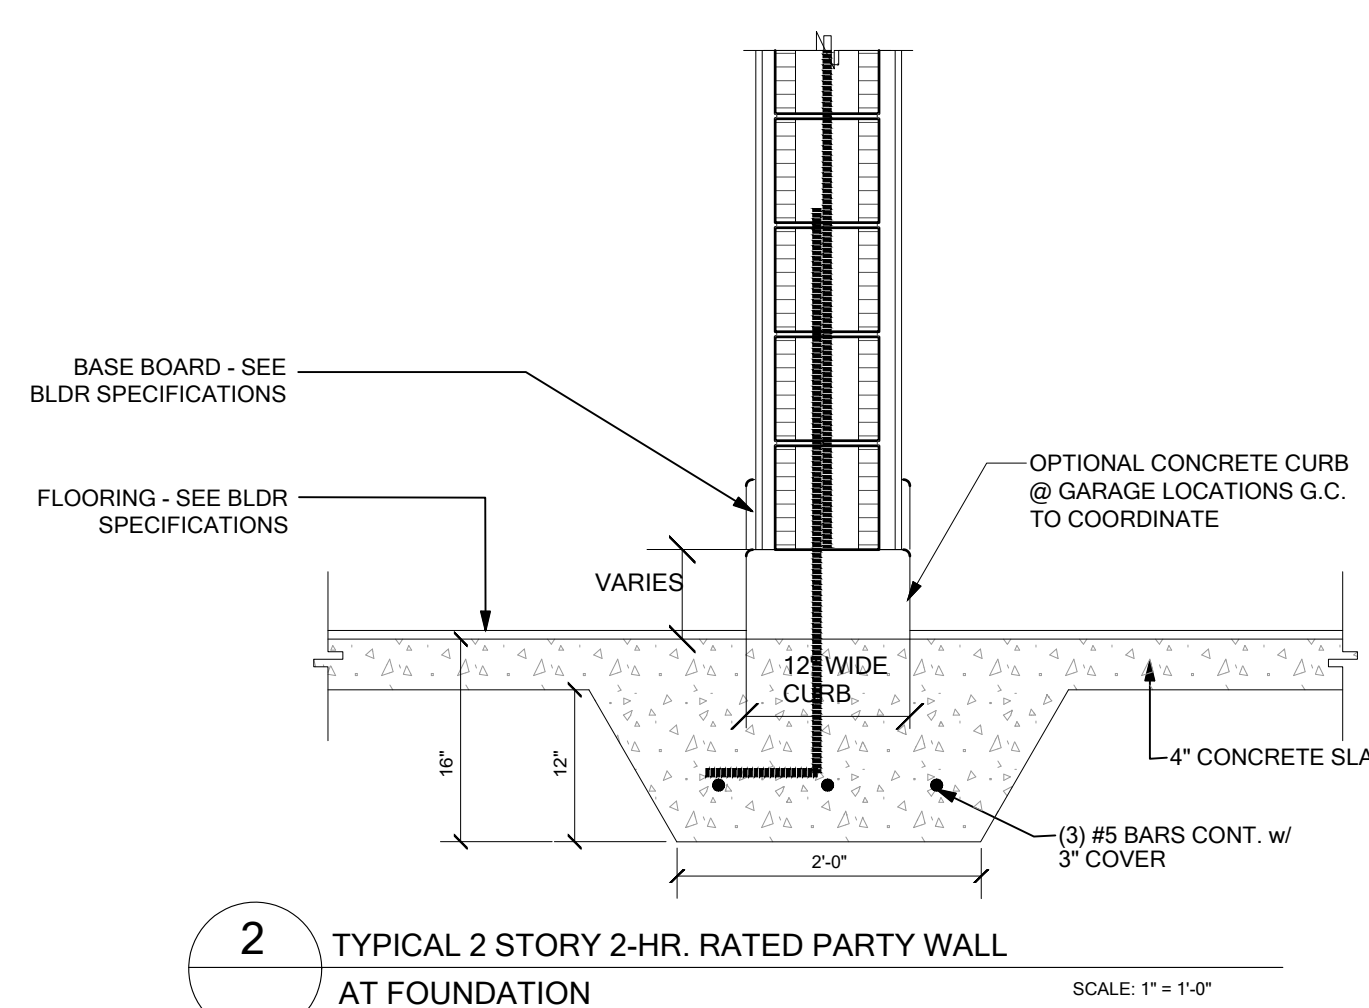
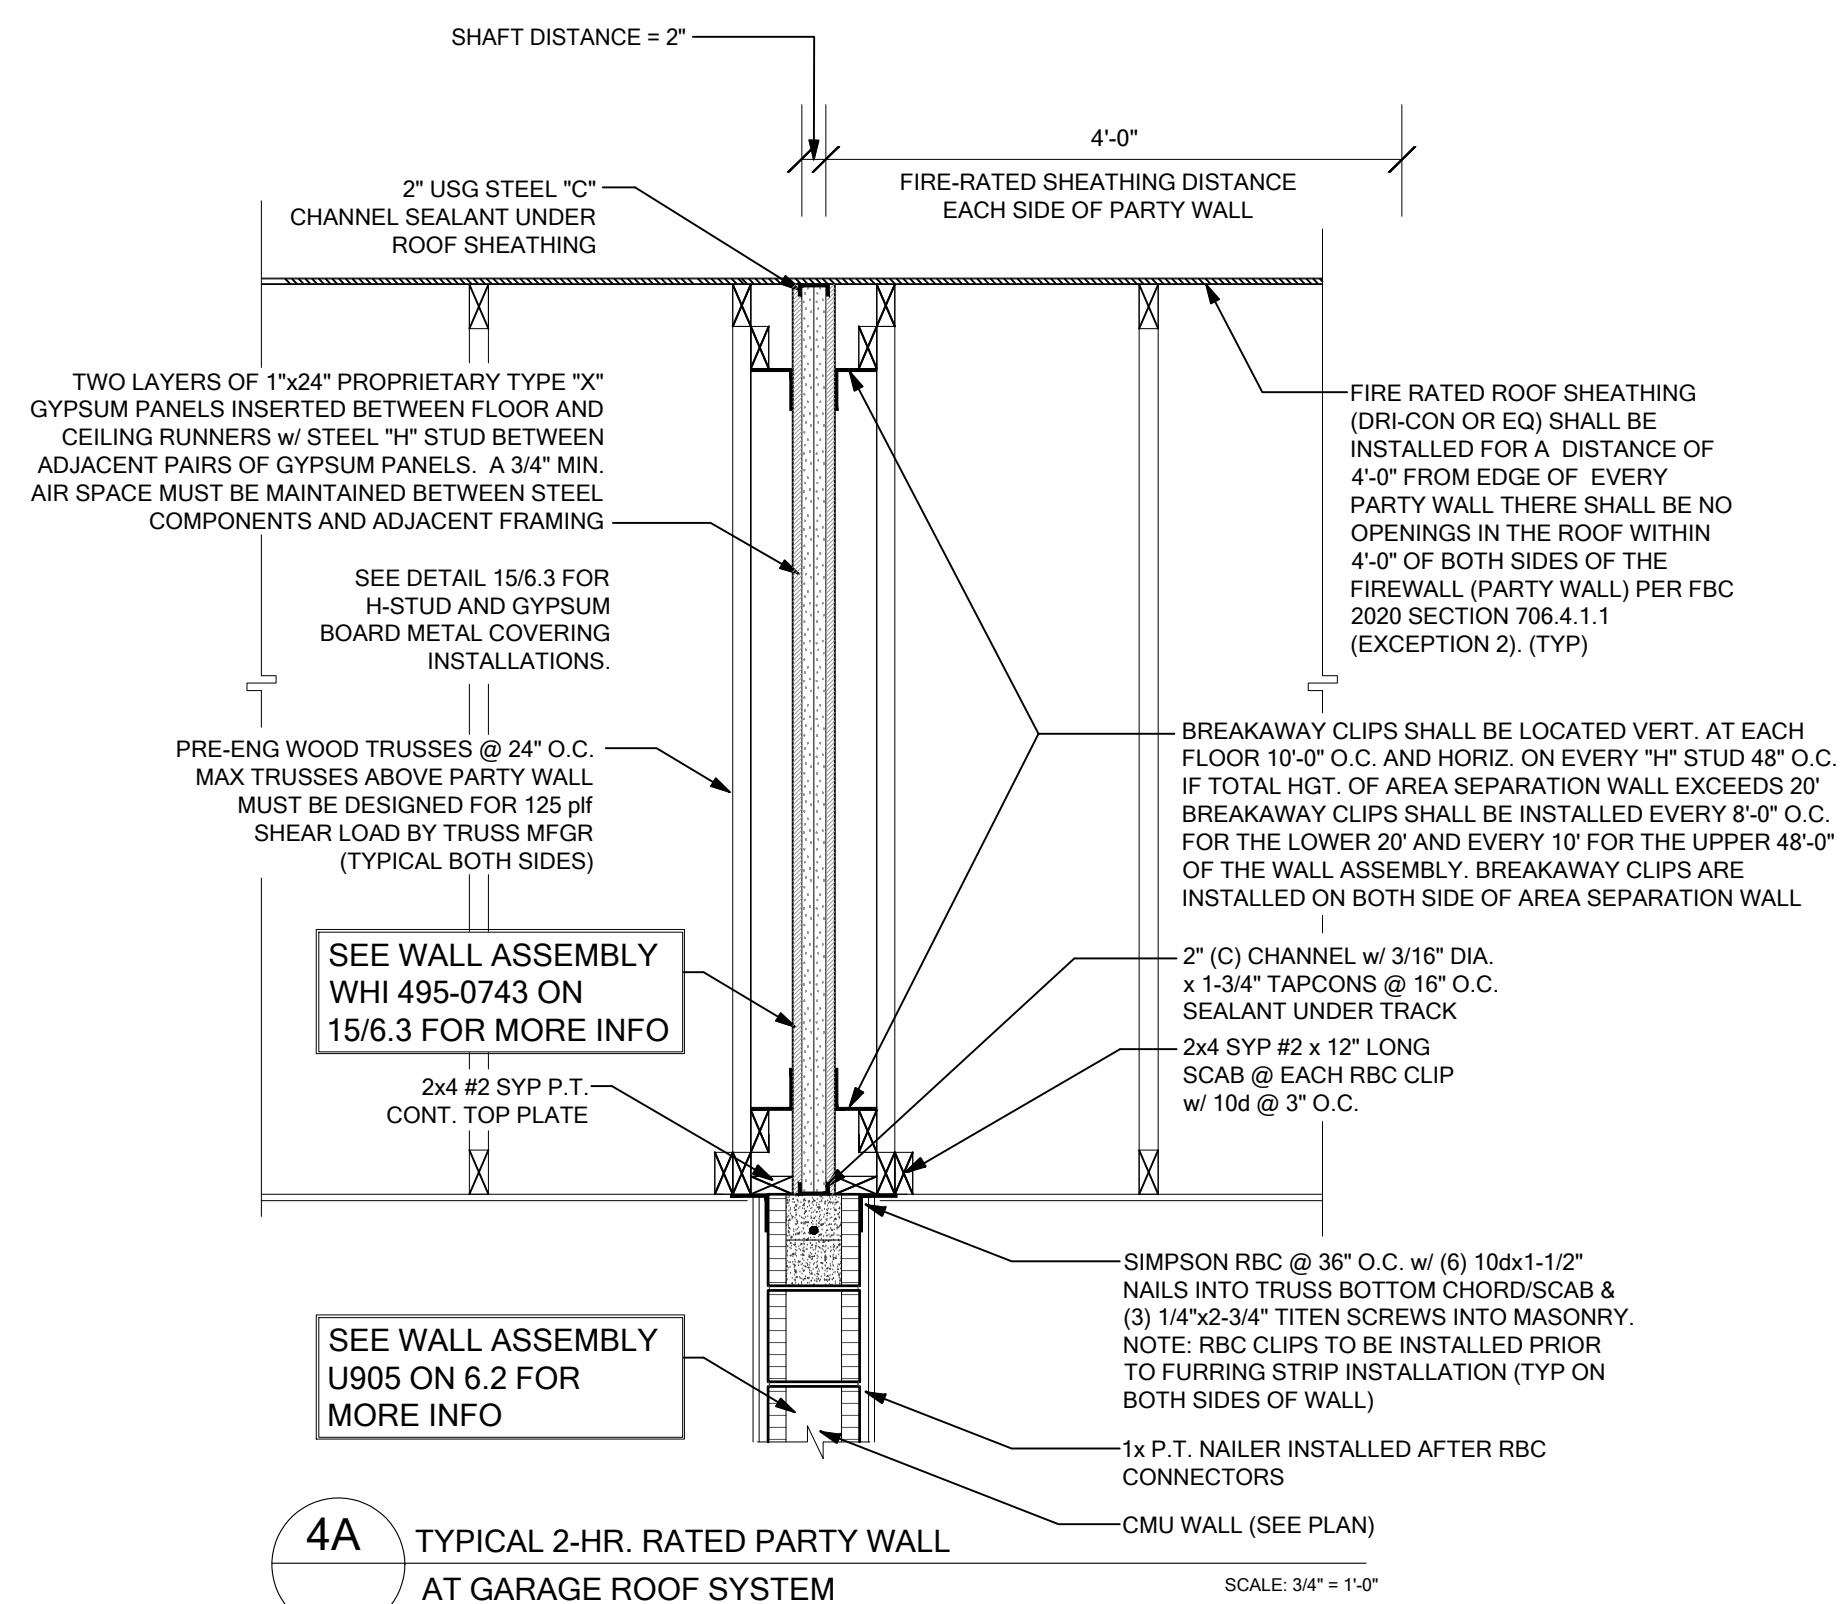
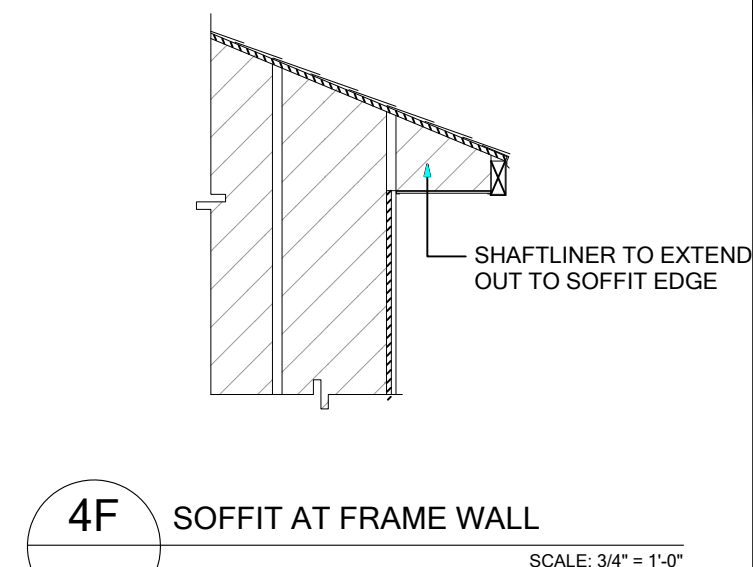
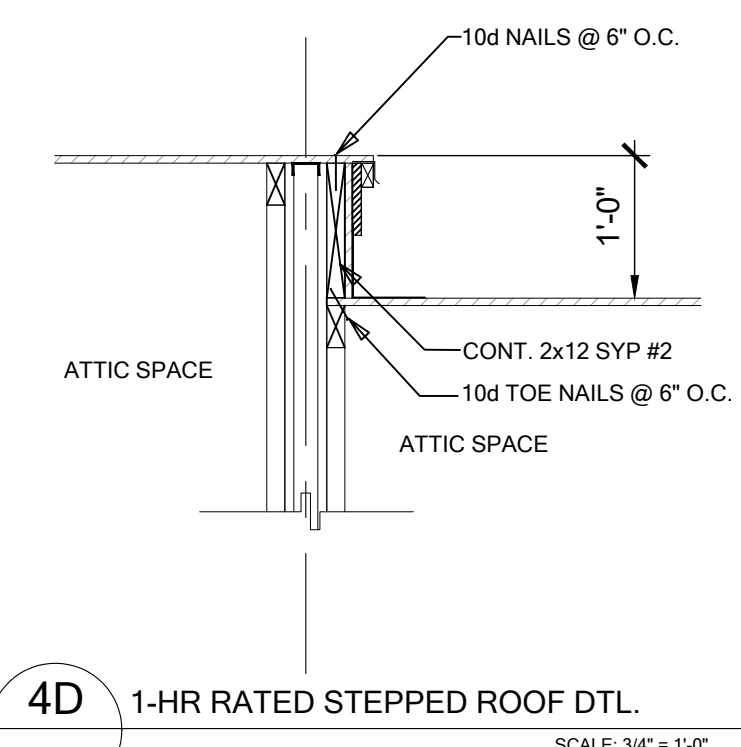
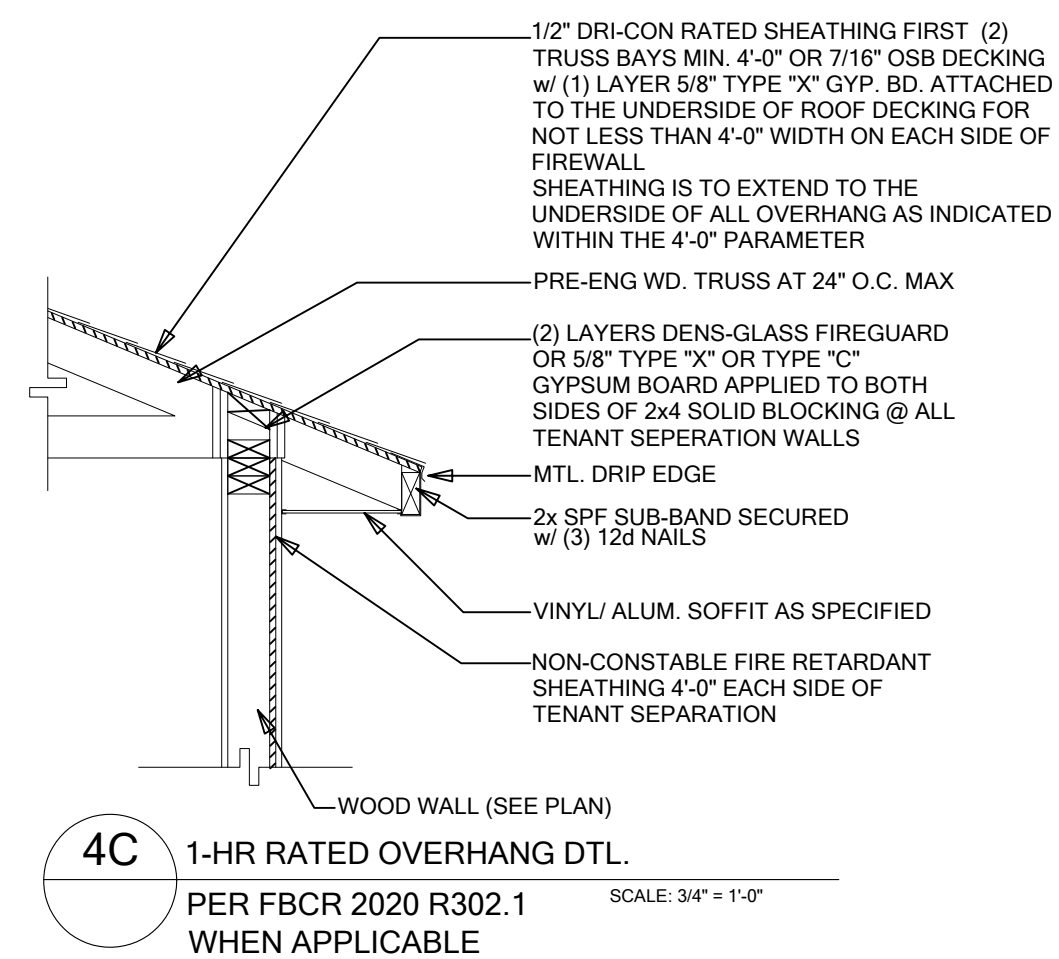
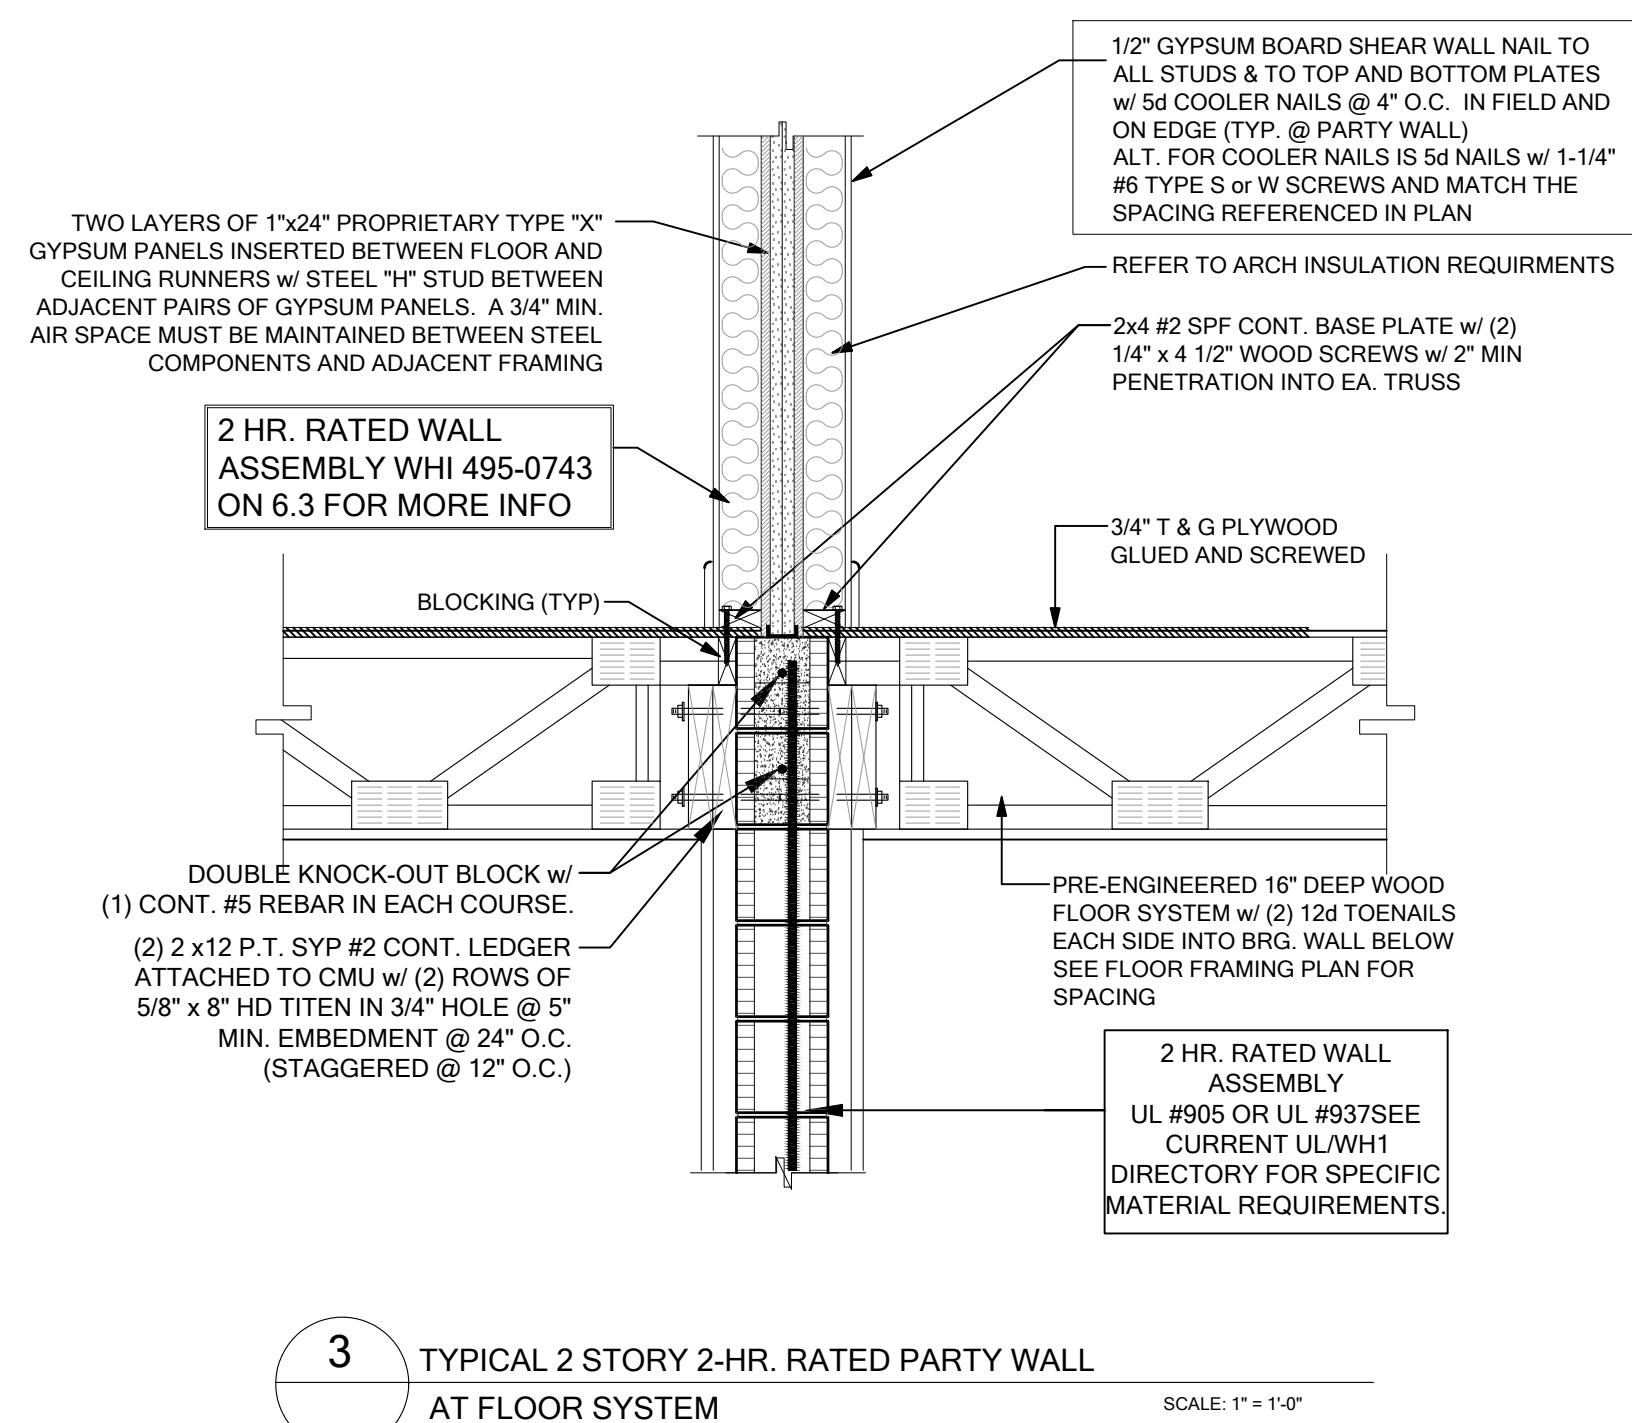
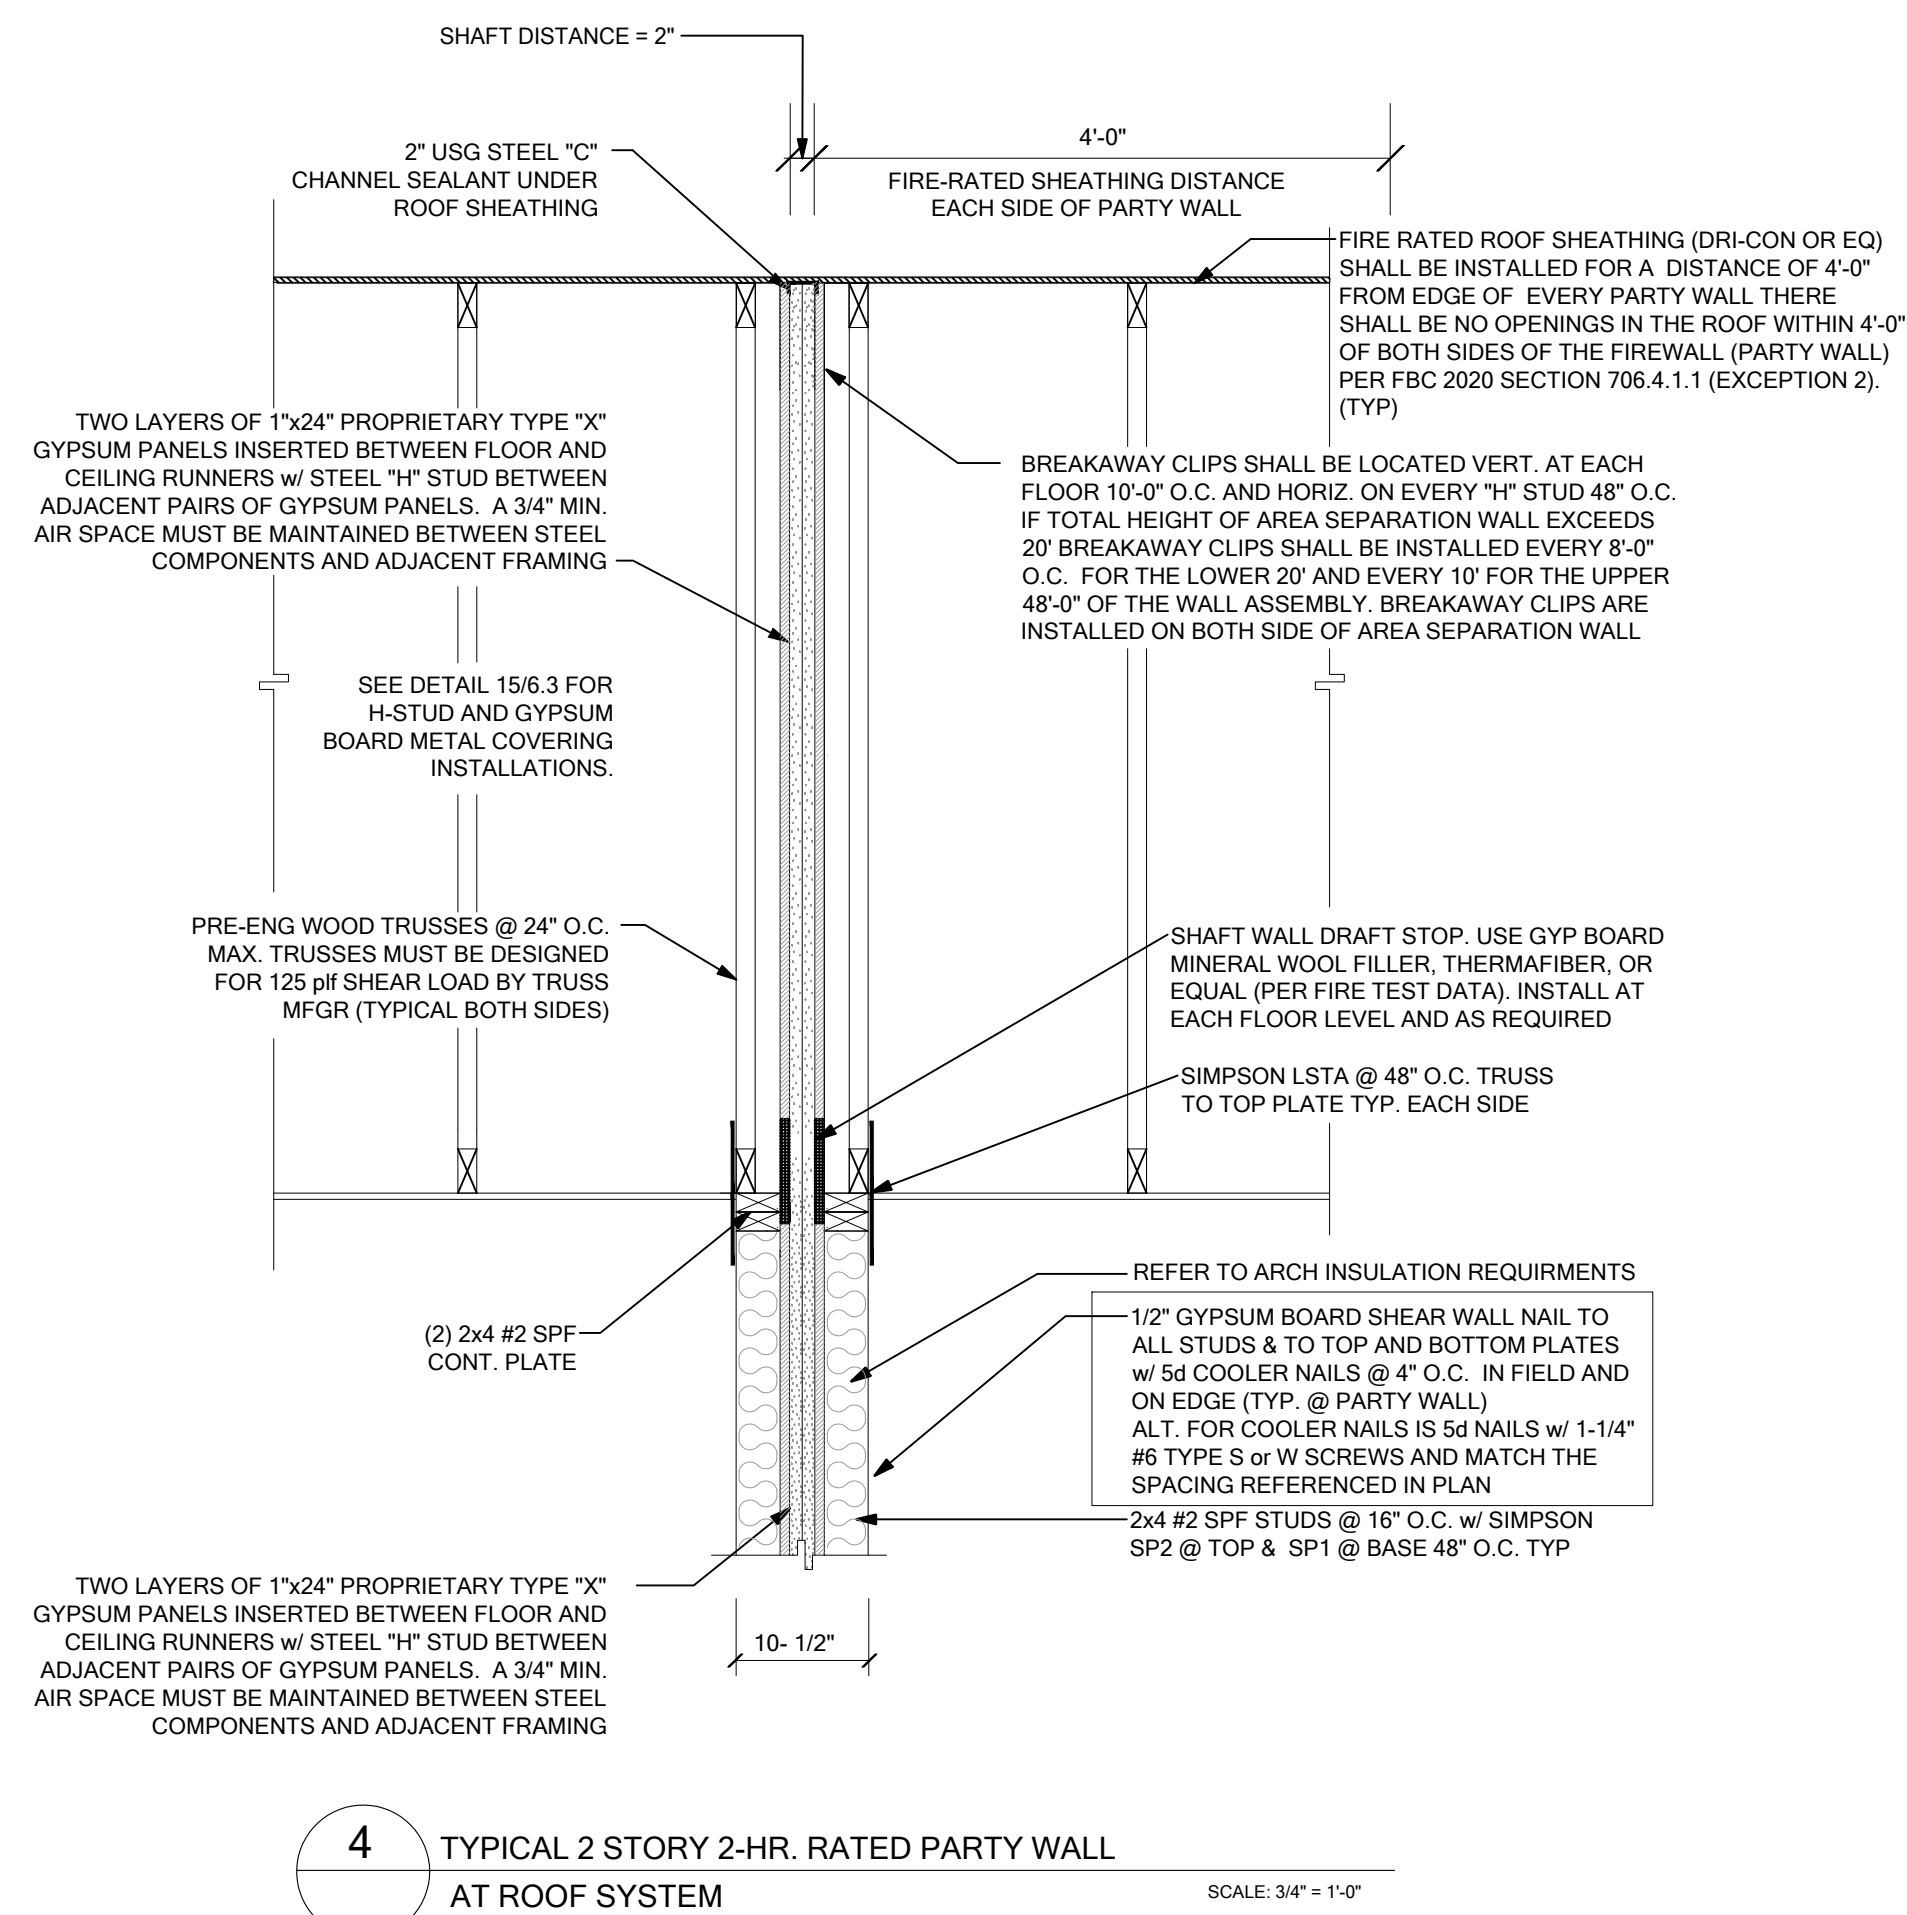
TO THE BEST OF THE ENGINEER'S KNOWLEDGE AND UNDERSTANDING, THE STRUCTURAL PLANS AND SPECIFICATIONS COMPLY WITH THE CURRENT FLORIDA RESIDENTIAL BUILDING CODE SIGNED AND SEALED FOR THE STRUCTURAL PORTION OF THIS DRAWING.

PARK SQUARE  
HORIZONS WEST  
BARBACOCK RANCH BLDG 6 (LOTS 6092-6099) 4 UNIT

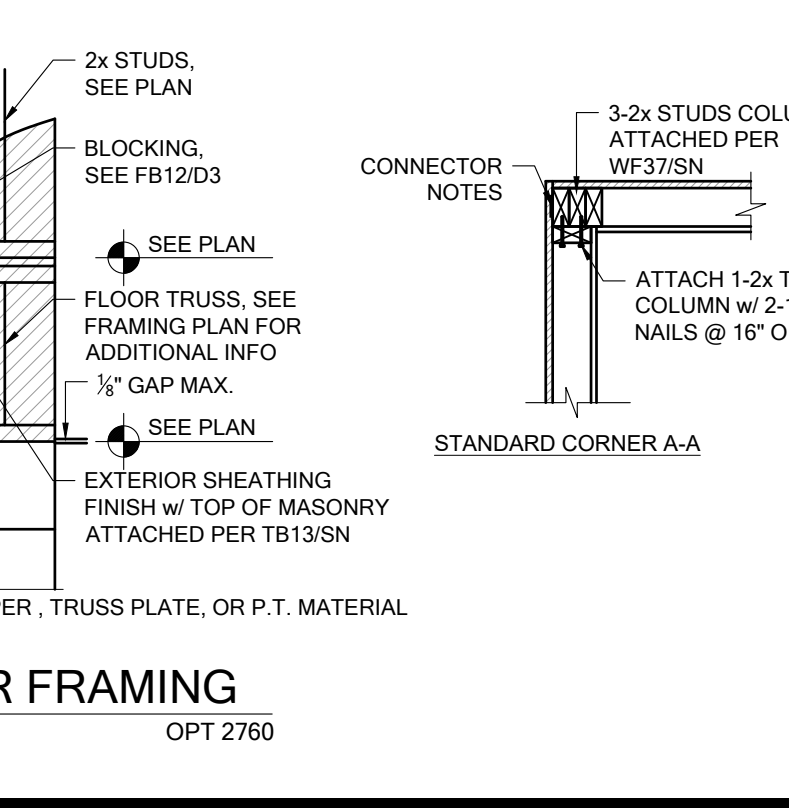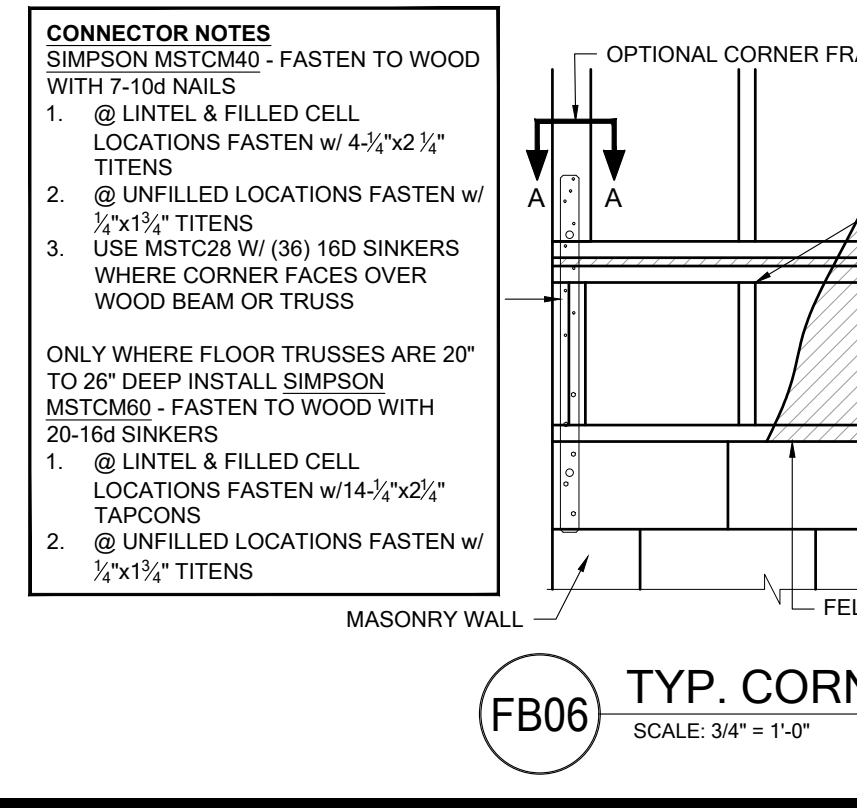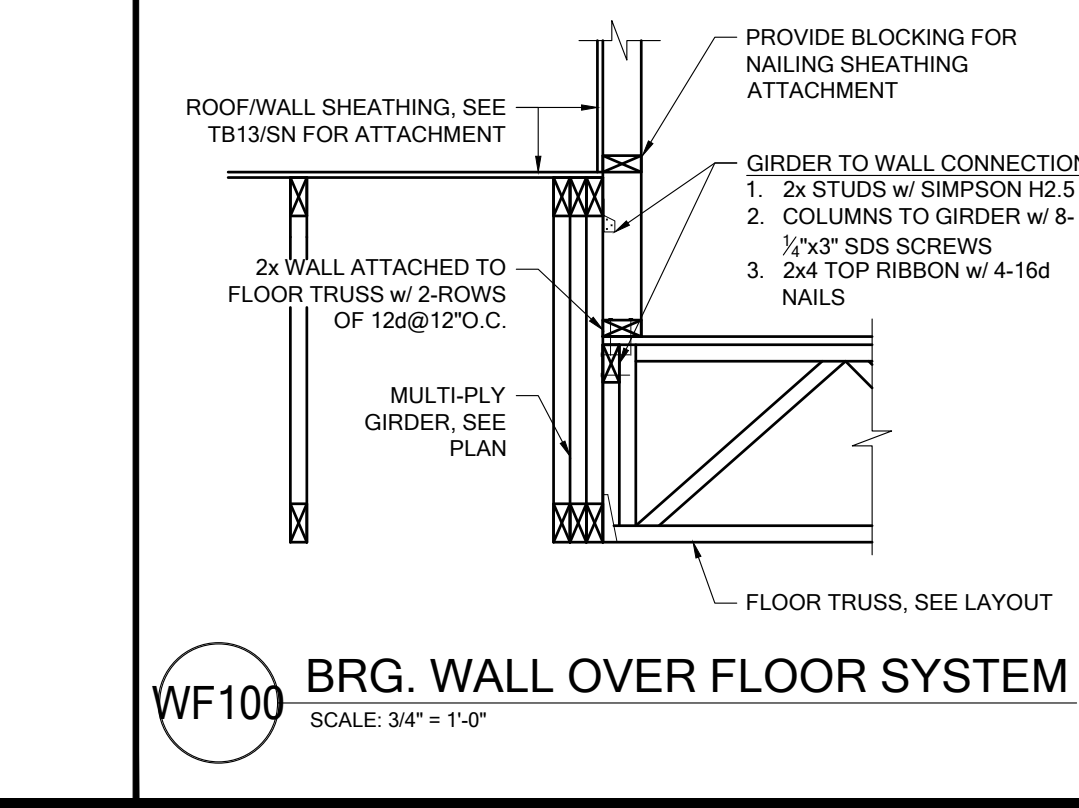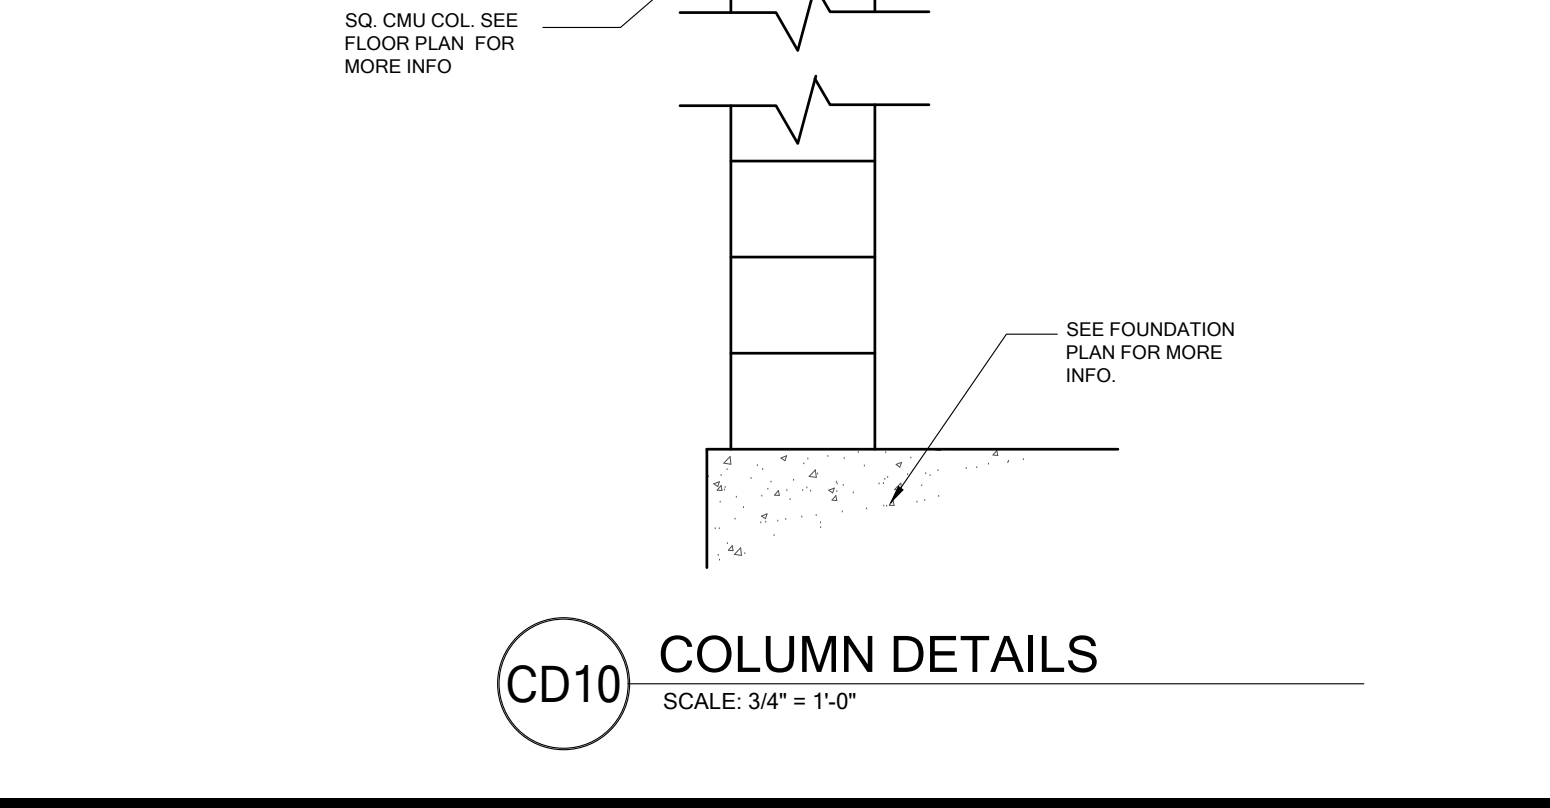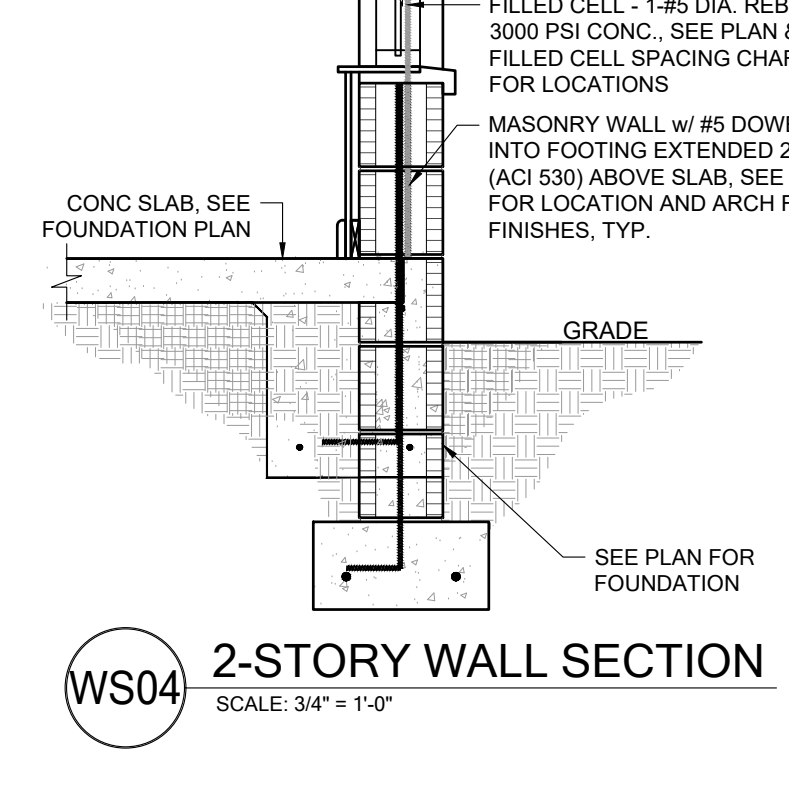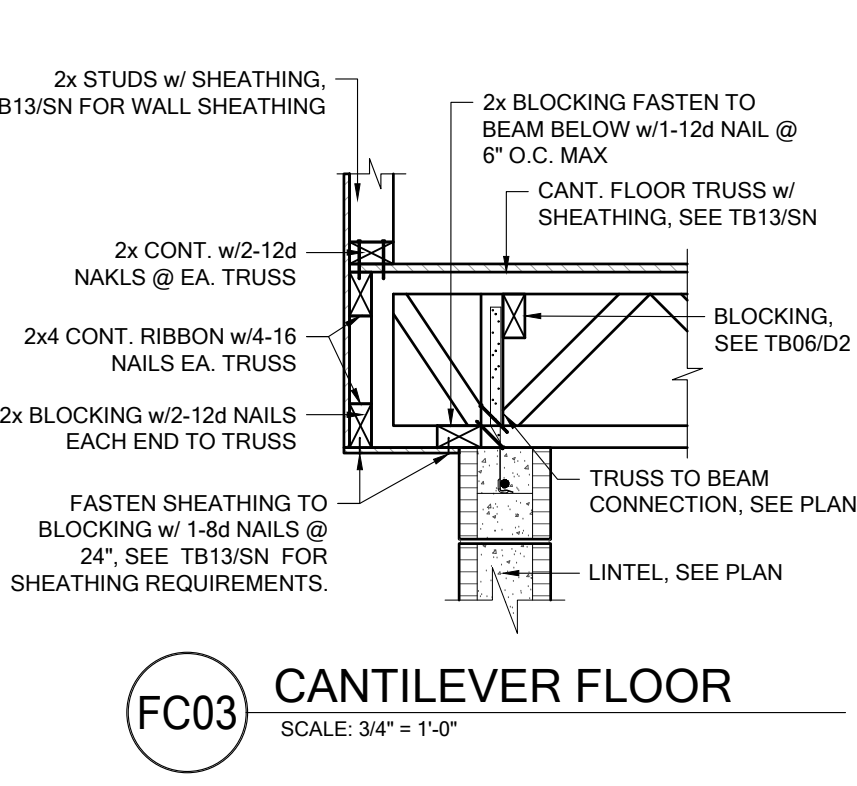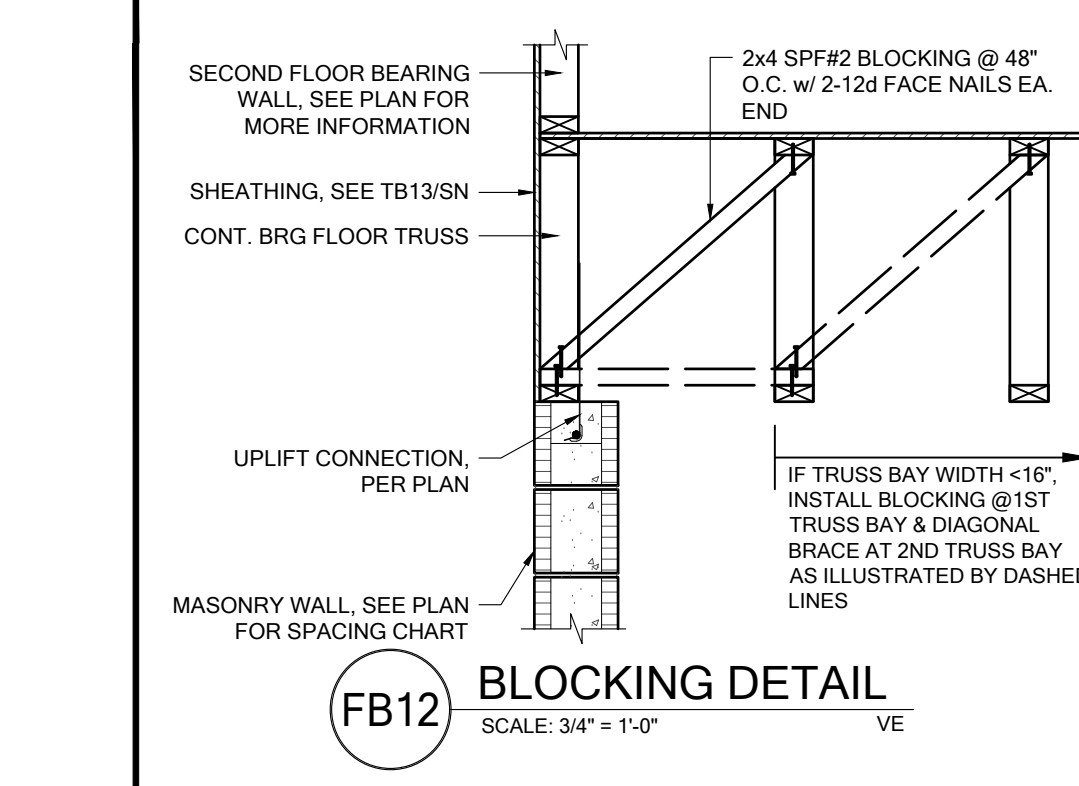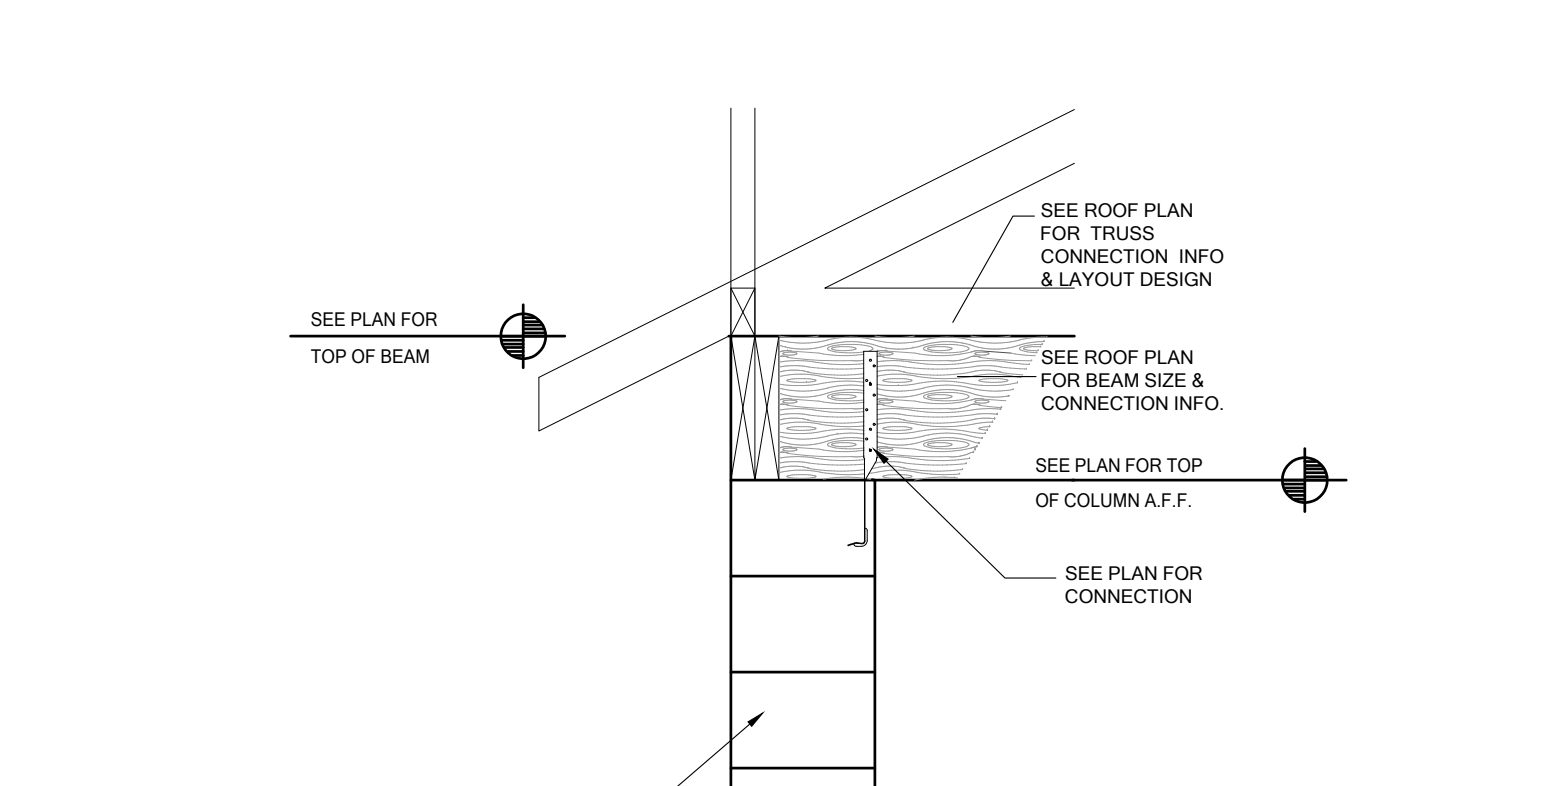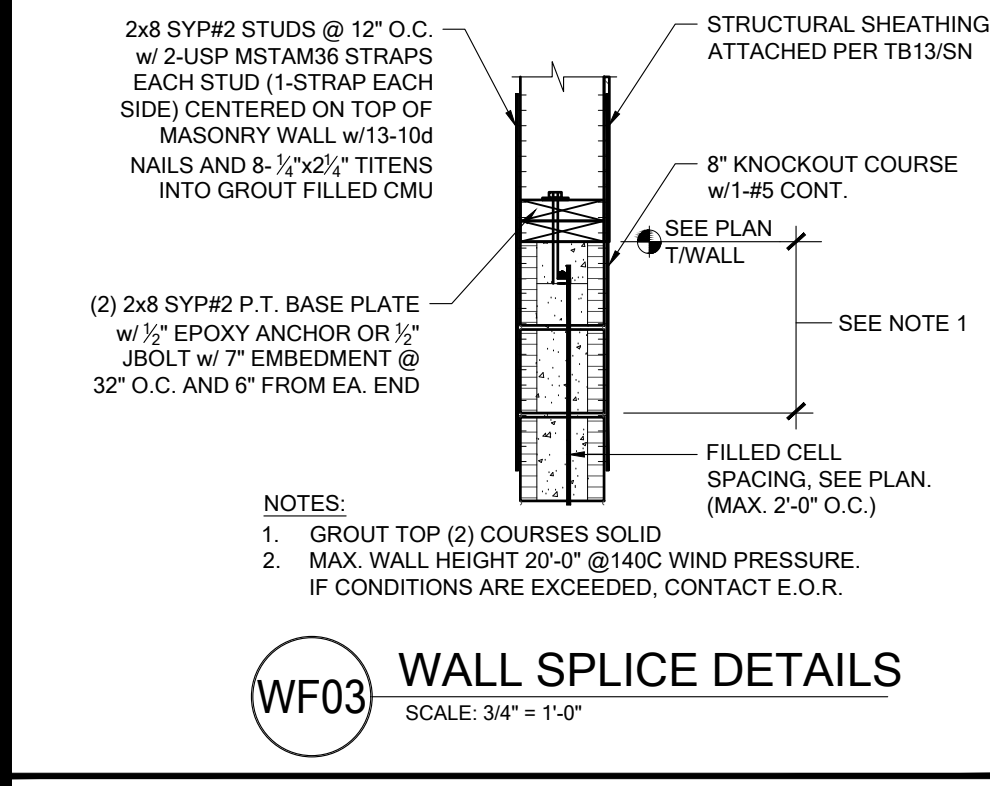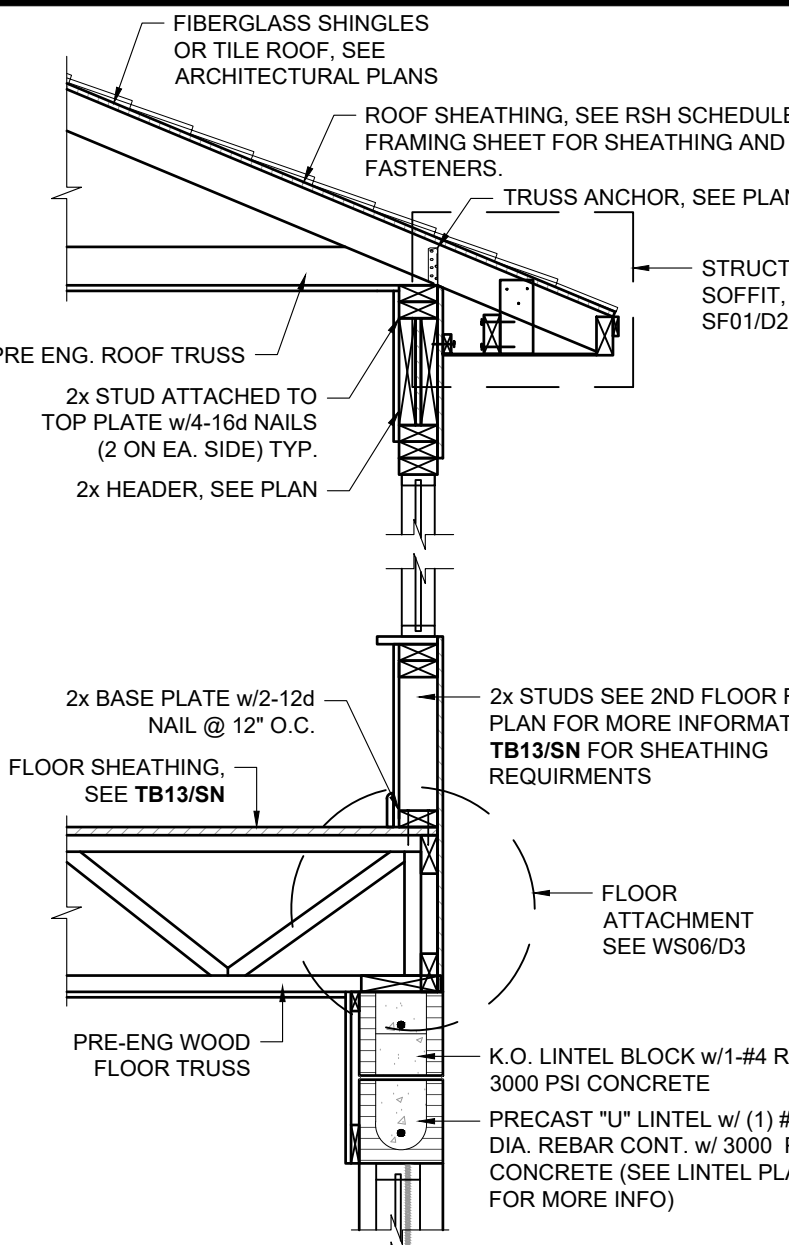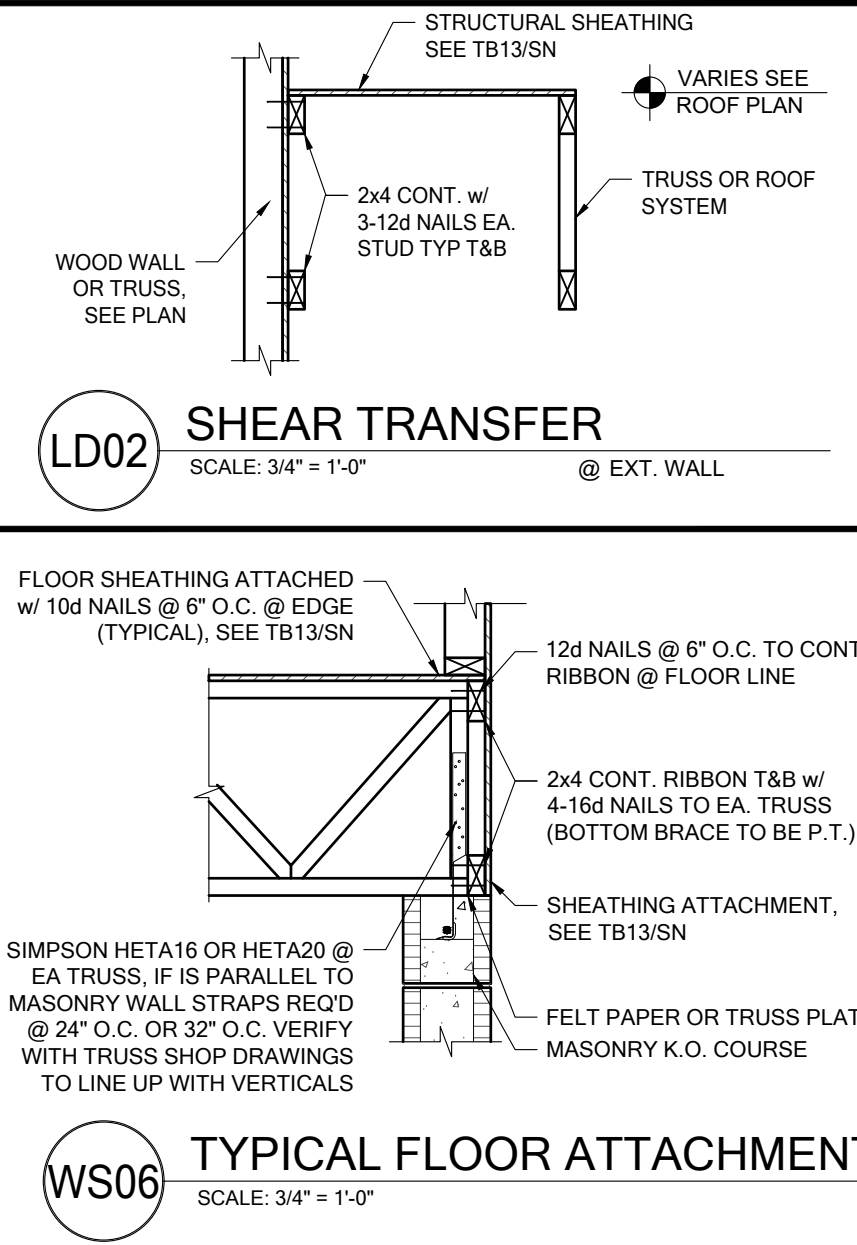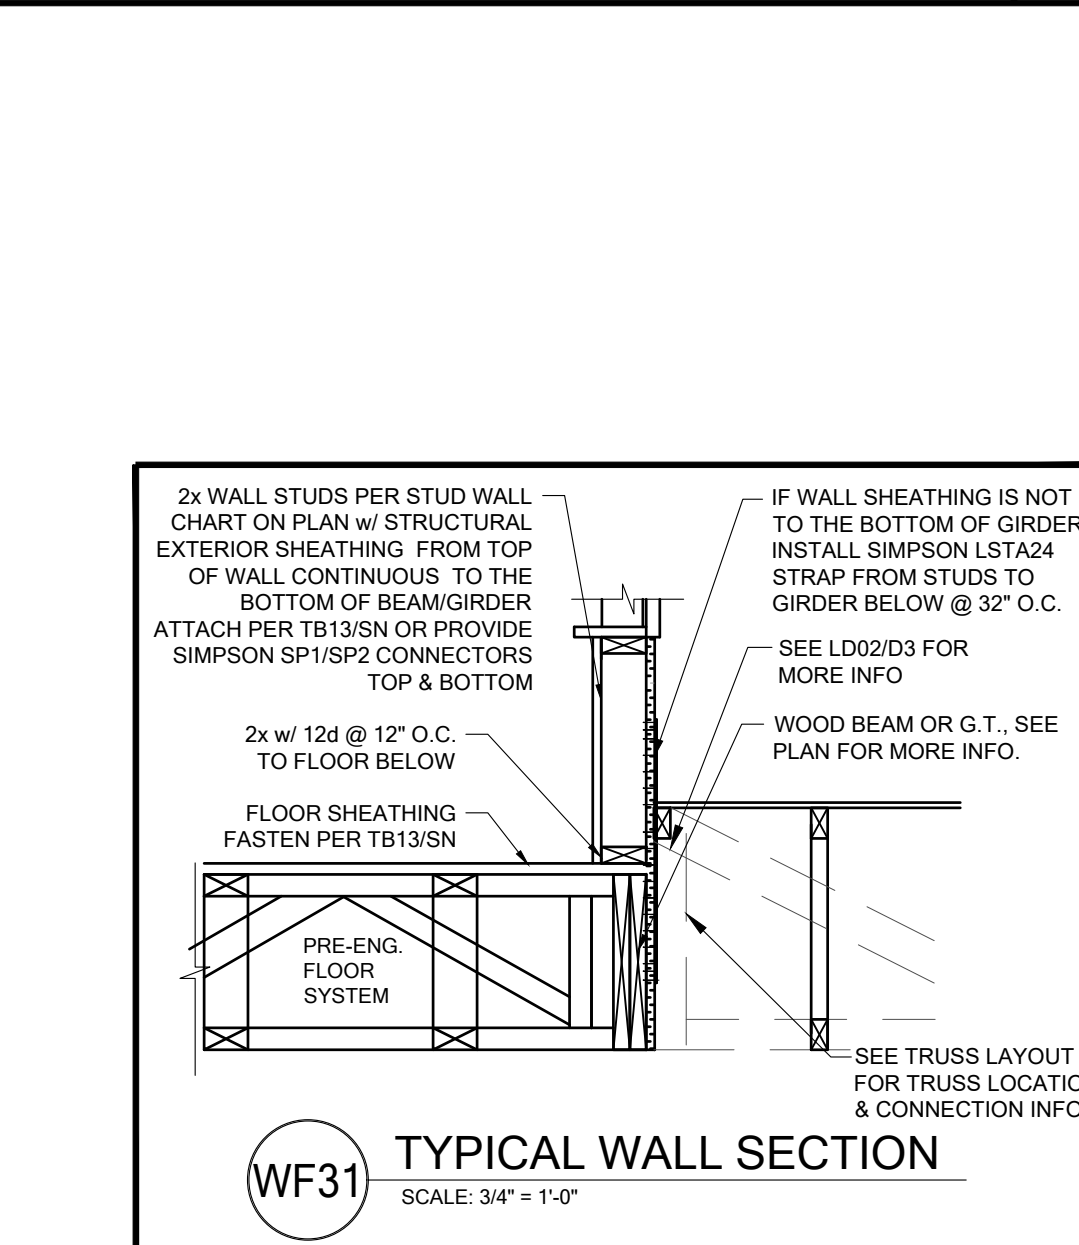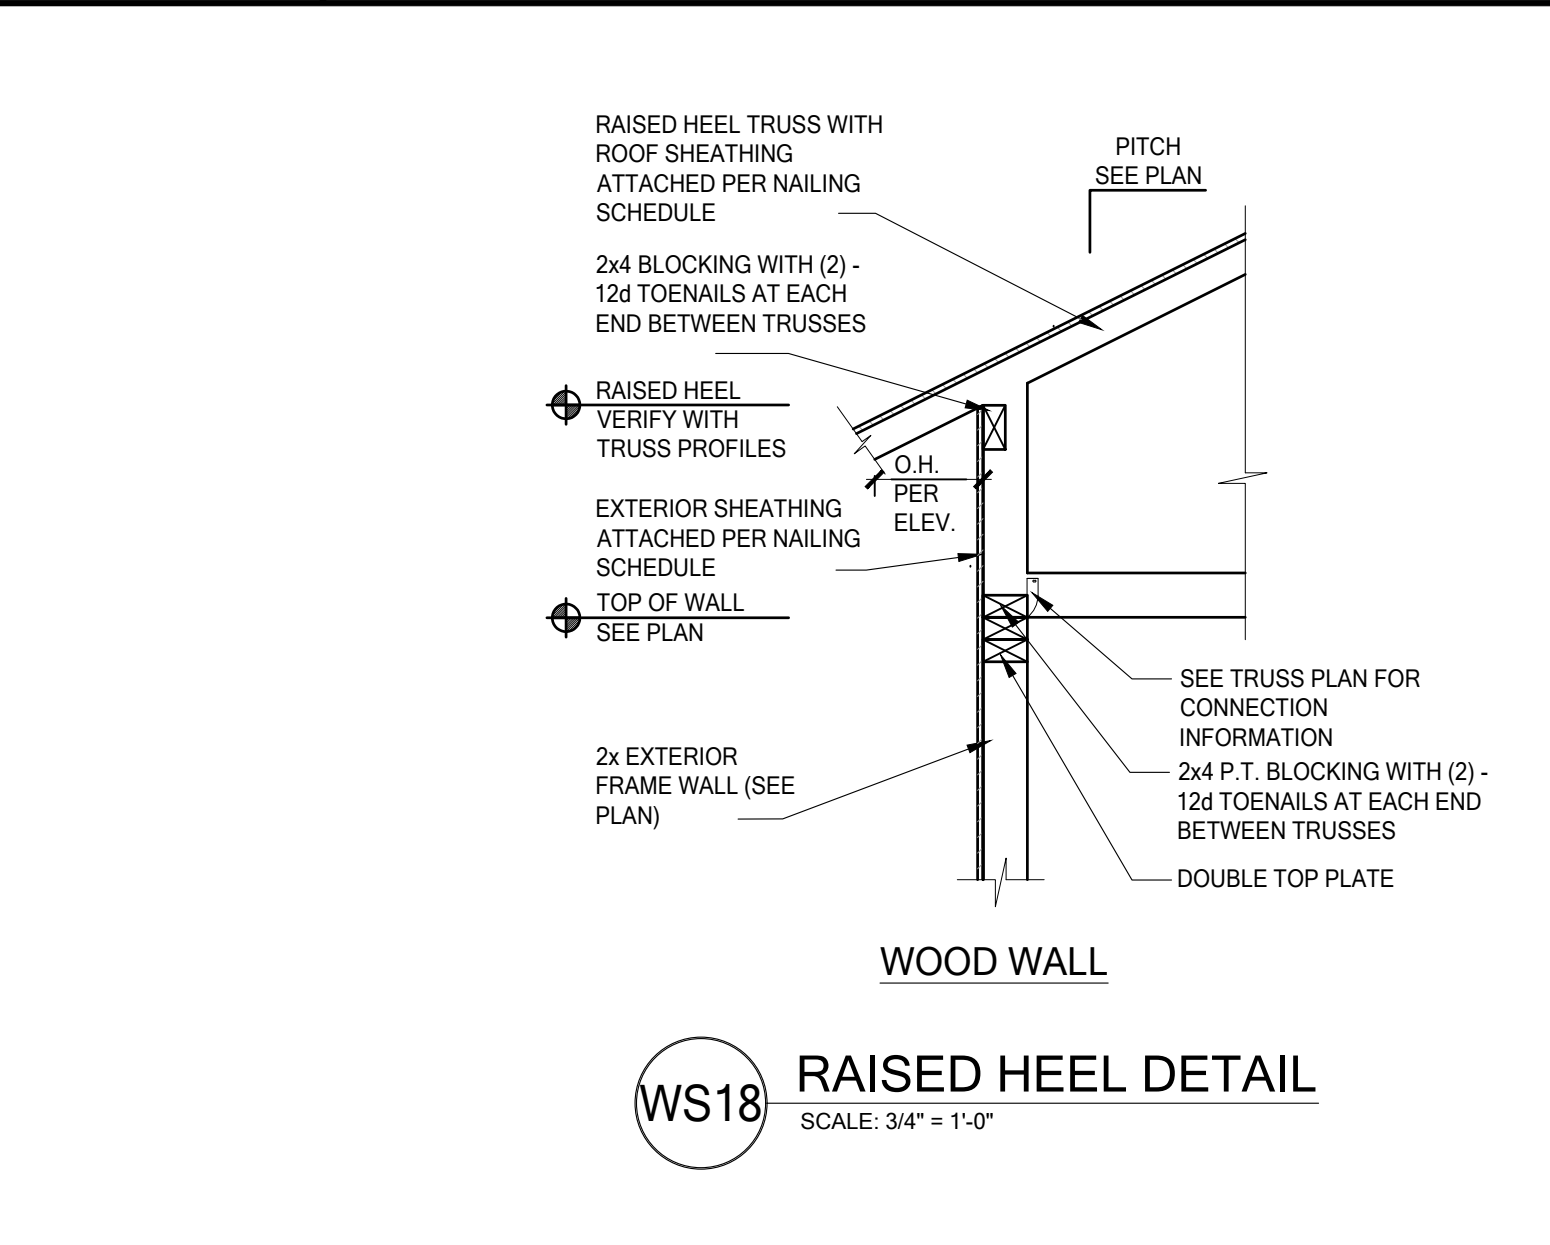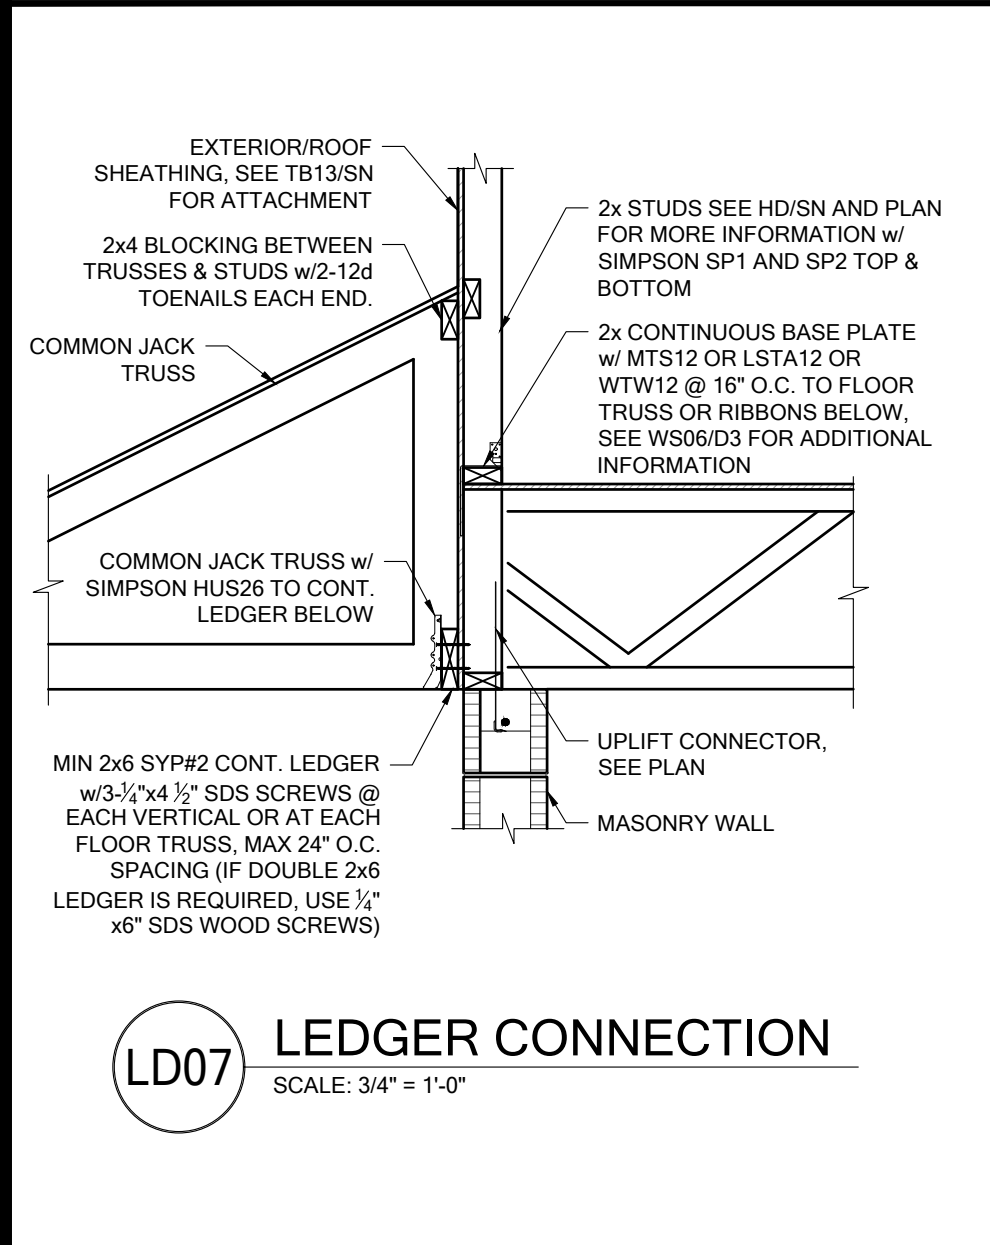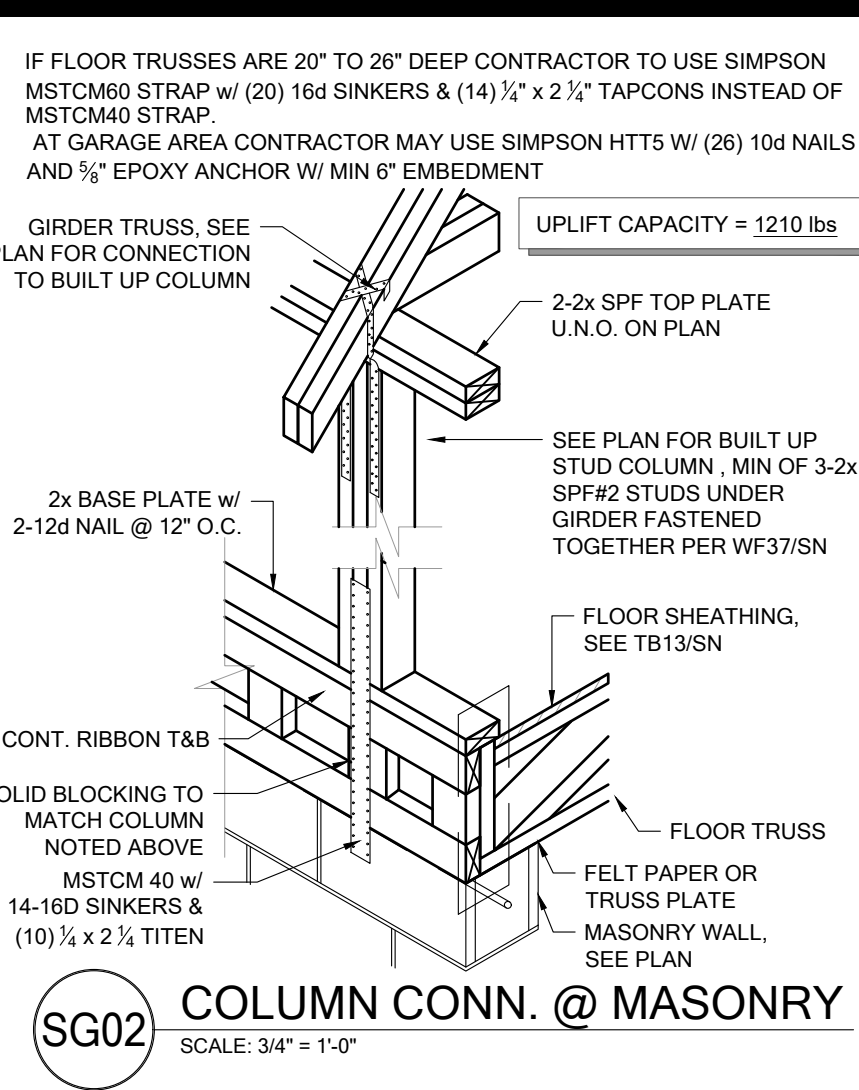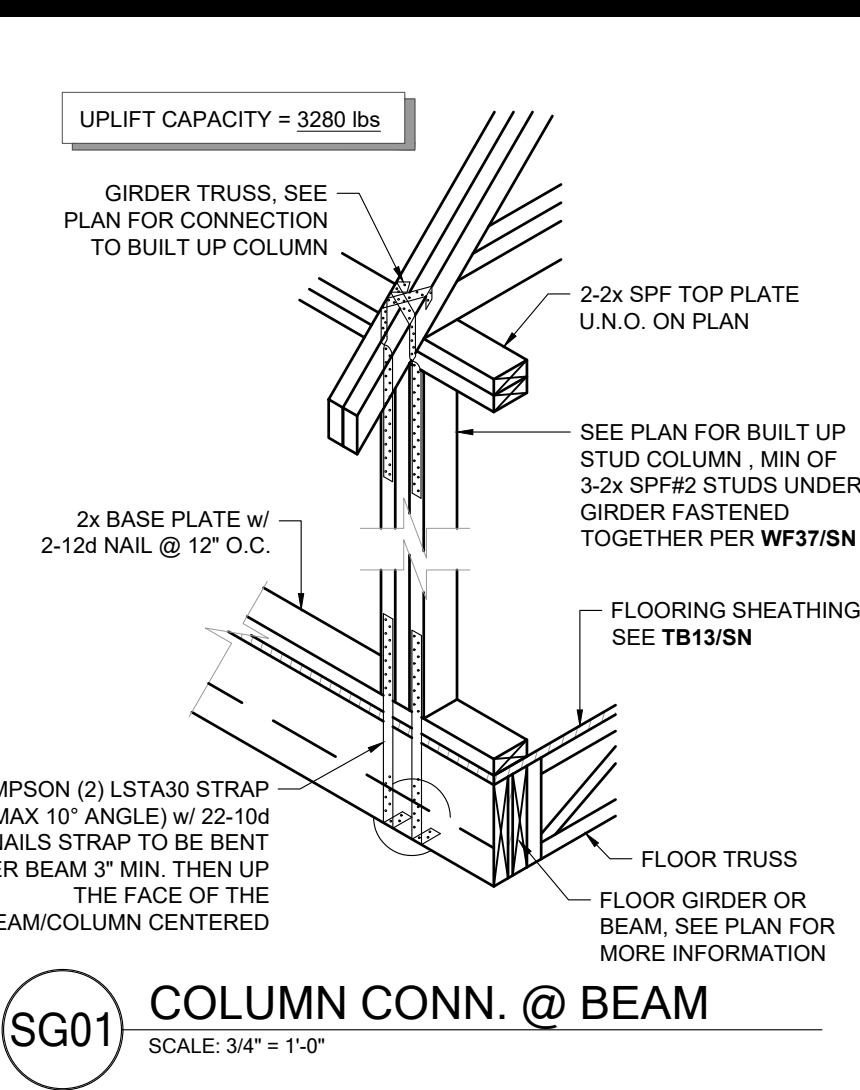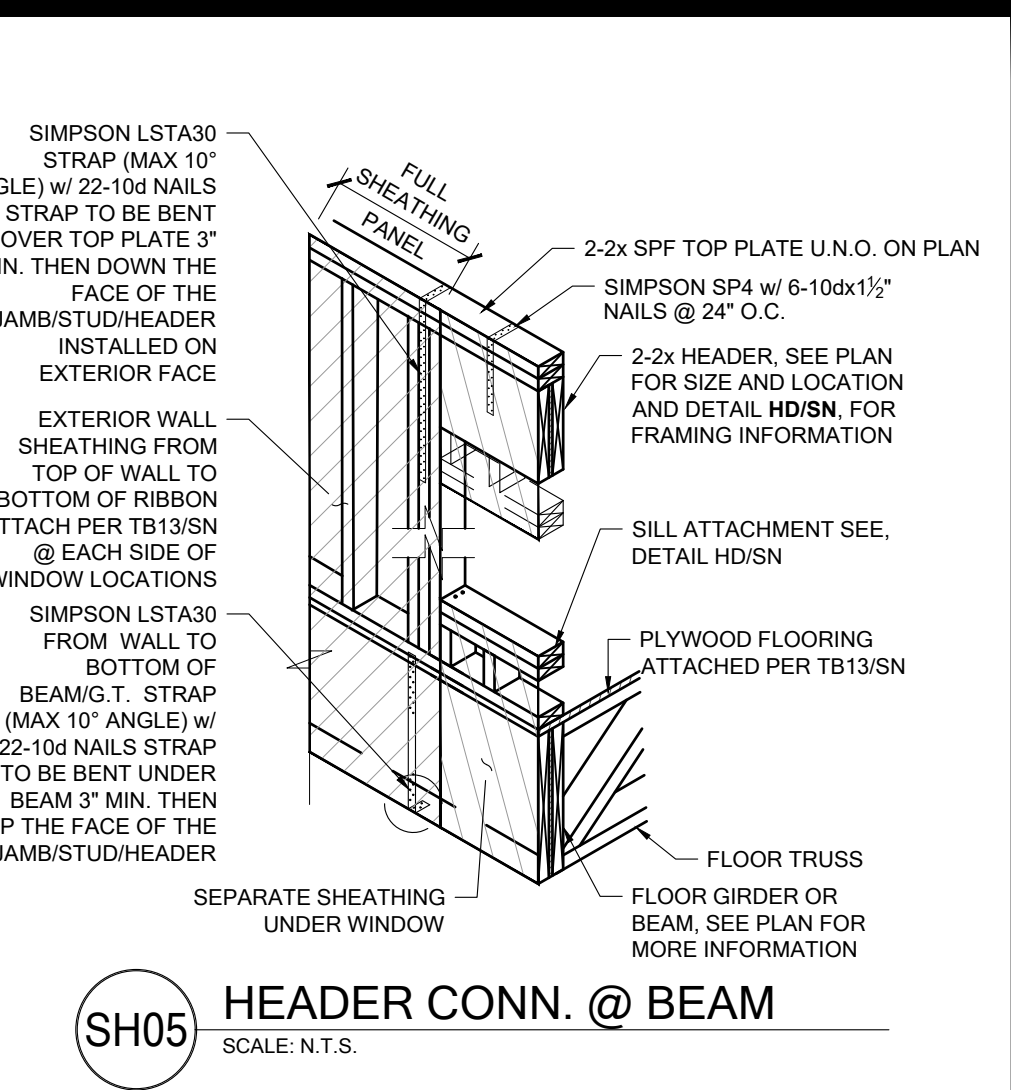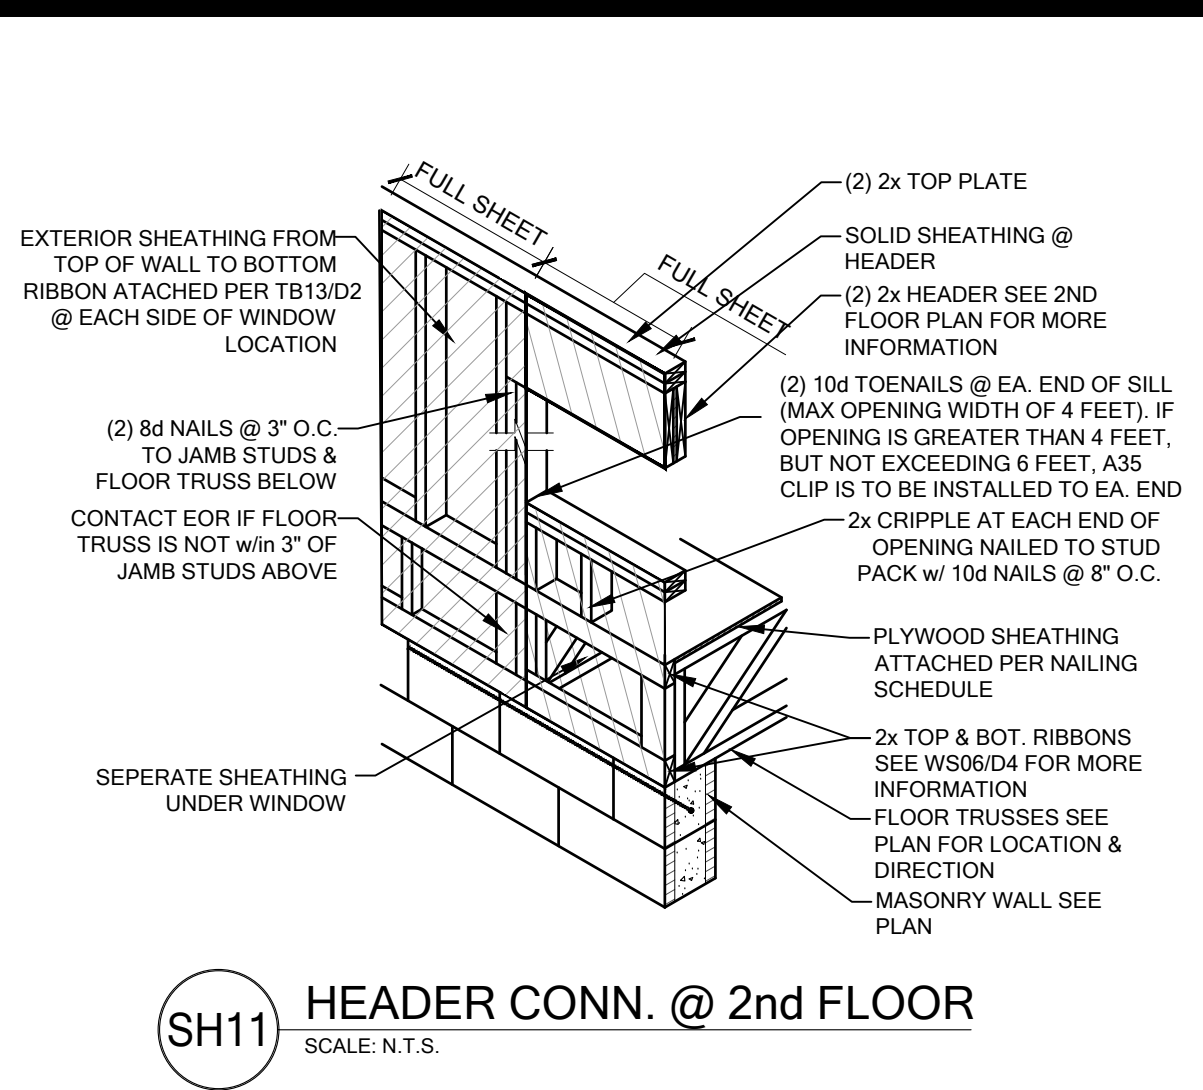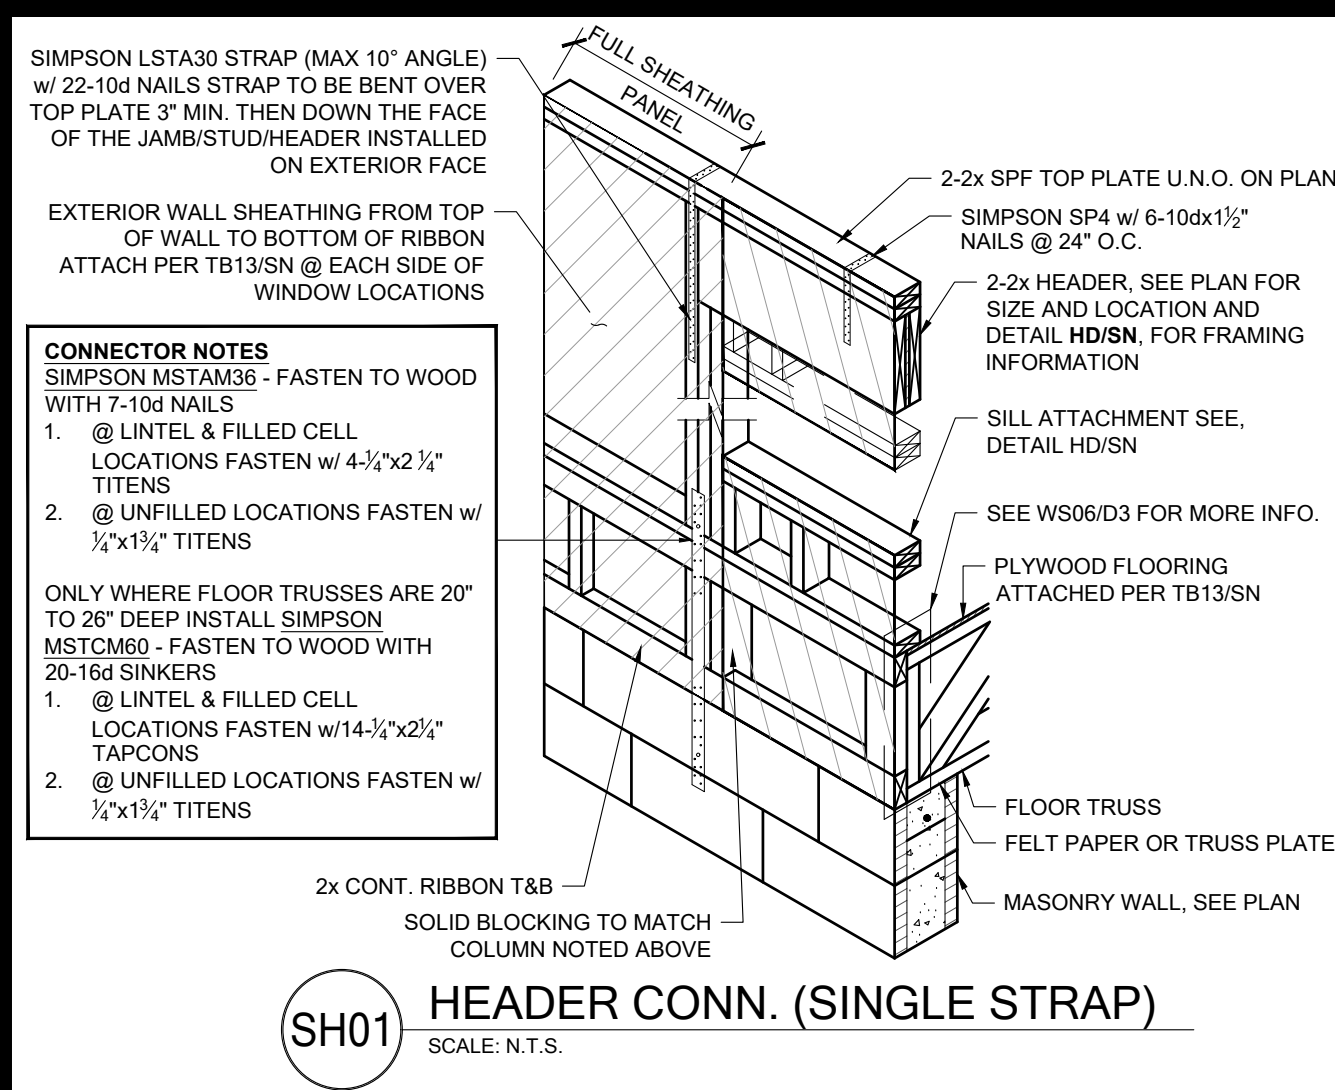project no. 2023083  
checked:  
drawn: BA  
date: 04-12-23  
scale:

# D4

NOTE: DRAWINGS ON 11"x17" SHEET WILL BE ONE HALF THE SCALE NOTED

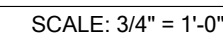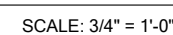


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☐ SCOTT LEWONSKI, PE #79759

**DATE: April 28, 2023**

PARK SQUARE  
HORIZONS WEST  
BARBECOCK RANCH BLDG 6 (LOTS 6092-6089) 4 UNIT

title:

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project no. 2023083  
checked:  
drawn: BA  
date: 04-12-23  
scale:

FP  
STRUCTURA

NOTE: DRAWINGS ON 11"x17" SHEET WILL BE ONE HALF THE SCALE NOTED