

THRIVE SERIES "SPIRIT"

30-1700 MODEL PAD SIZE 30'-0" x 75'-0"



SHEET INDEX:

| 00 | COVER SHEET |
|------------|--|
| A1 | SLAB PLAN - ELEV. "A,B,C" |
| A2 | FLOOR PLAN - ELEV. "A,B,C" |
| A3.A | FRONT & REAR ELEVATIONS - ELEV. "A" |
| A3.B | FRONT & REAR ELEVATIONS - ELEV. "B" |
| A3.C | FRONT & REAR ELEVATIONS - ELEV. "C" |
| A4.A | LEFT & RIGHT ELEVATIONS - ELEV. "A" |
| A4.B | LEFT & RIGHT ELEVATIONS - ELEV. "B" |
| A4.C | LEFT & RIGHT ELEVATIONS - ELEV. "C" |
| A5 | ELECTRICAL PLAN - ELEV. "A,B,C" |
| A6 | ARCHITECTURAL DETAILS |
| S 1 | FOUNDATION PLAN - ELEV. "A,B,C" (MONO) |
| S2 | LINTEL PLAN - ELEV. "A,B,C" |
| S3 | ROOF FRAMING PLAN - ELEV. "A,C" |
| S3.1 | ROOF FRAMING PLAN - ELEV. "B" |
| D1 | STRUCTURAL NOTES & DETAILS |
| D2 | STRUCTURAL DETAILS |
| D3 | STRUCTURAL DETAILS |
| D4 | STRUCTURAL DETAILS |
| | |

DISTRIBUTED LIVE LOAD

(IN POUNDS PER SQ. FT.)

UNINHABITABLE ATTICS WITHOUT STORAGE
UNINHABITABLE ATTICS WITH LIMITED STORAGE
HABITABLE ATTICS & ATTICS SERVED WITH FIXED STAIRS
BALCONIES (EXTERIOR) AND DECKS

FIRE ESCAPÈS **GUARDS AND HANDRAILS** GUARD IN-FILL COMPONENTS PASSENGER VEHICLE GARAGES ROOMS OTHER THAN SLEEPING ROOMS SLEEPING ROOMS

ANSI STANDARD FOR **MEASURING HOUSES**

THE ANSI STANDARD FOR MEASURING HOUSES: NATIONAL STANDARD 2765-1996 NEW CONSTRUCTION THE ANSI STANDARDS BASE FLOOR AREA CALCULATIONS ON THE EXTERIOR DIMENSIONS OF THE BUILDING AT EACH FLOOR LEVEL AND INCLUDE ALL INTERIOR WALLS AND VOIDS. FOR ATTACHED UNITS, THE OUTSIDE DIMENSION IS THE CENTER LINE OF THE COMMON WALLS. INTERNAL ROOM DIMENSIONS AREN'T USED IN THIS SYSTEM OF MEASURING. THI ANSI STANDARDS BASE FLOOR AREA CALCULATIONS ON THE EXTERIOR DIMENSIONS OF THE BUILDING AT EACH FLOOR LEVEL AND INCLUDE AL INTERIOR WALLS AND VOIDS. FOR ATTACHED UNITS, THE OUTSIDE DIMENSION IS THE CENTER LINE OF THE COMMON WALLS. INTERNAL ROOM DIMENSIONS AREN'T USED IN THIS SYSTEM OF MEASURING.

THE ANSI STANDARDS BASE FLOOR AREA CALCULATIONS ON THE EXTERIOR DIMENSIONS OF THE BUILDING AT EACH FLOOR LEVEL AND INCLUDE ALL INTERIOR WALLS AND VOIDS SEPARATED INTO TWO

AIR-CONDITIONED SPACE NON-AIR-CONDITIONED SPACE (GARAGES, PATIOS, PORCHES,

THE ANSI STANDARDS DEFINE "FINISHED AREA" AS "AN ENCLOSED AREA IN A HOUSE SUITABLE FOR YEAR-ROUND USE, EMBODYING WALLS, FLOORS. AND CEILINGS THAT ARE LIKE THE REST OF THE MEASUREMENTS MUST BE TAKEN TO THE NEAREST INCH OR TENTH OF A FOOT, AND FLOOR AREA MUST BE REPORTED TO THE NEAREST SQUARE FOOT. THESE WOULD INCLUDE BONUS/ATTIC SPACES AND AR

GENERAL CONTRACTOR:

IT IS THE RESPONSIBILITY OF THE GENERAL CONTRACTOR TO INSTALL ALL MATERIALS MEETING FLORIDA APPROVAL COMPLIANCE TO AVOID WATER INTRUSION AND MOISTURE INTRUSION ON WINDOWS, DOORS, ROOF, AND ANY OTHER AREA AROUND EACH SINGLE FAMILY HOUSE/ APARTMENT/ CONDOMINIUM TOWNHOUSE.

REVISION SCHEDULE:

| NO: | DATE: | DESCRIPTION: | BY: |
|-----|----------|--|------|
| 1 | 08/12/22 | MASTER CREATED | M.C. |
| 2 | 08/12/22 | ADDED EERO NOTE ALL EGRESS WINDOWS | A.M. |
| 3 | 08/12/22 | ADDED OFF RIDGE VENT ROOF NOTE | A.M. |
| 4 | 08/17/22 | ADDED WATER PROOFING NOTE TO COVER SHEET | A.M. |
| 5 | 02/14/23 | MASTER PLAN UPDATES | J.T. |
| 6 | 05/02/23 | REMOVED DBL. OVER OPTION, CORBELS FROM ELEV. B, STONE FROM SIDE ON ELEV. C | C.C |
| 7 | 06/07/23 | REVISED GLASS INSERTS ON GARAGE DOORS FOR ELEV. B & C TO MATCH ELEV. A | C.C |
| 8 | 09/15/23 | REVISED LIVING SQUARE FOOTAGE TO 1713 FROM 1700. | C.C |
| 9 | 11/28/23 | ELECTRICAL CHANGES | G.P |
| 10 | | | |
| 11 | | | |
| 12 | | | |
| 13 | | | |
| 14 | | | |
| 15 | | | |
| 16 | | | |










30-1700 Lot # - Subdivision

Enterprises Inc. 5200 Vineland Rd. Suite #200



DRAWN BY: C.C.

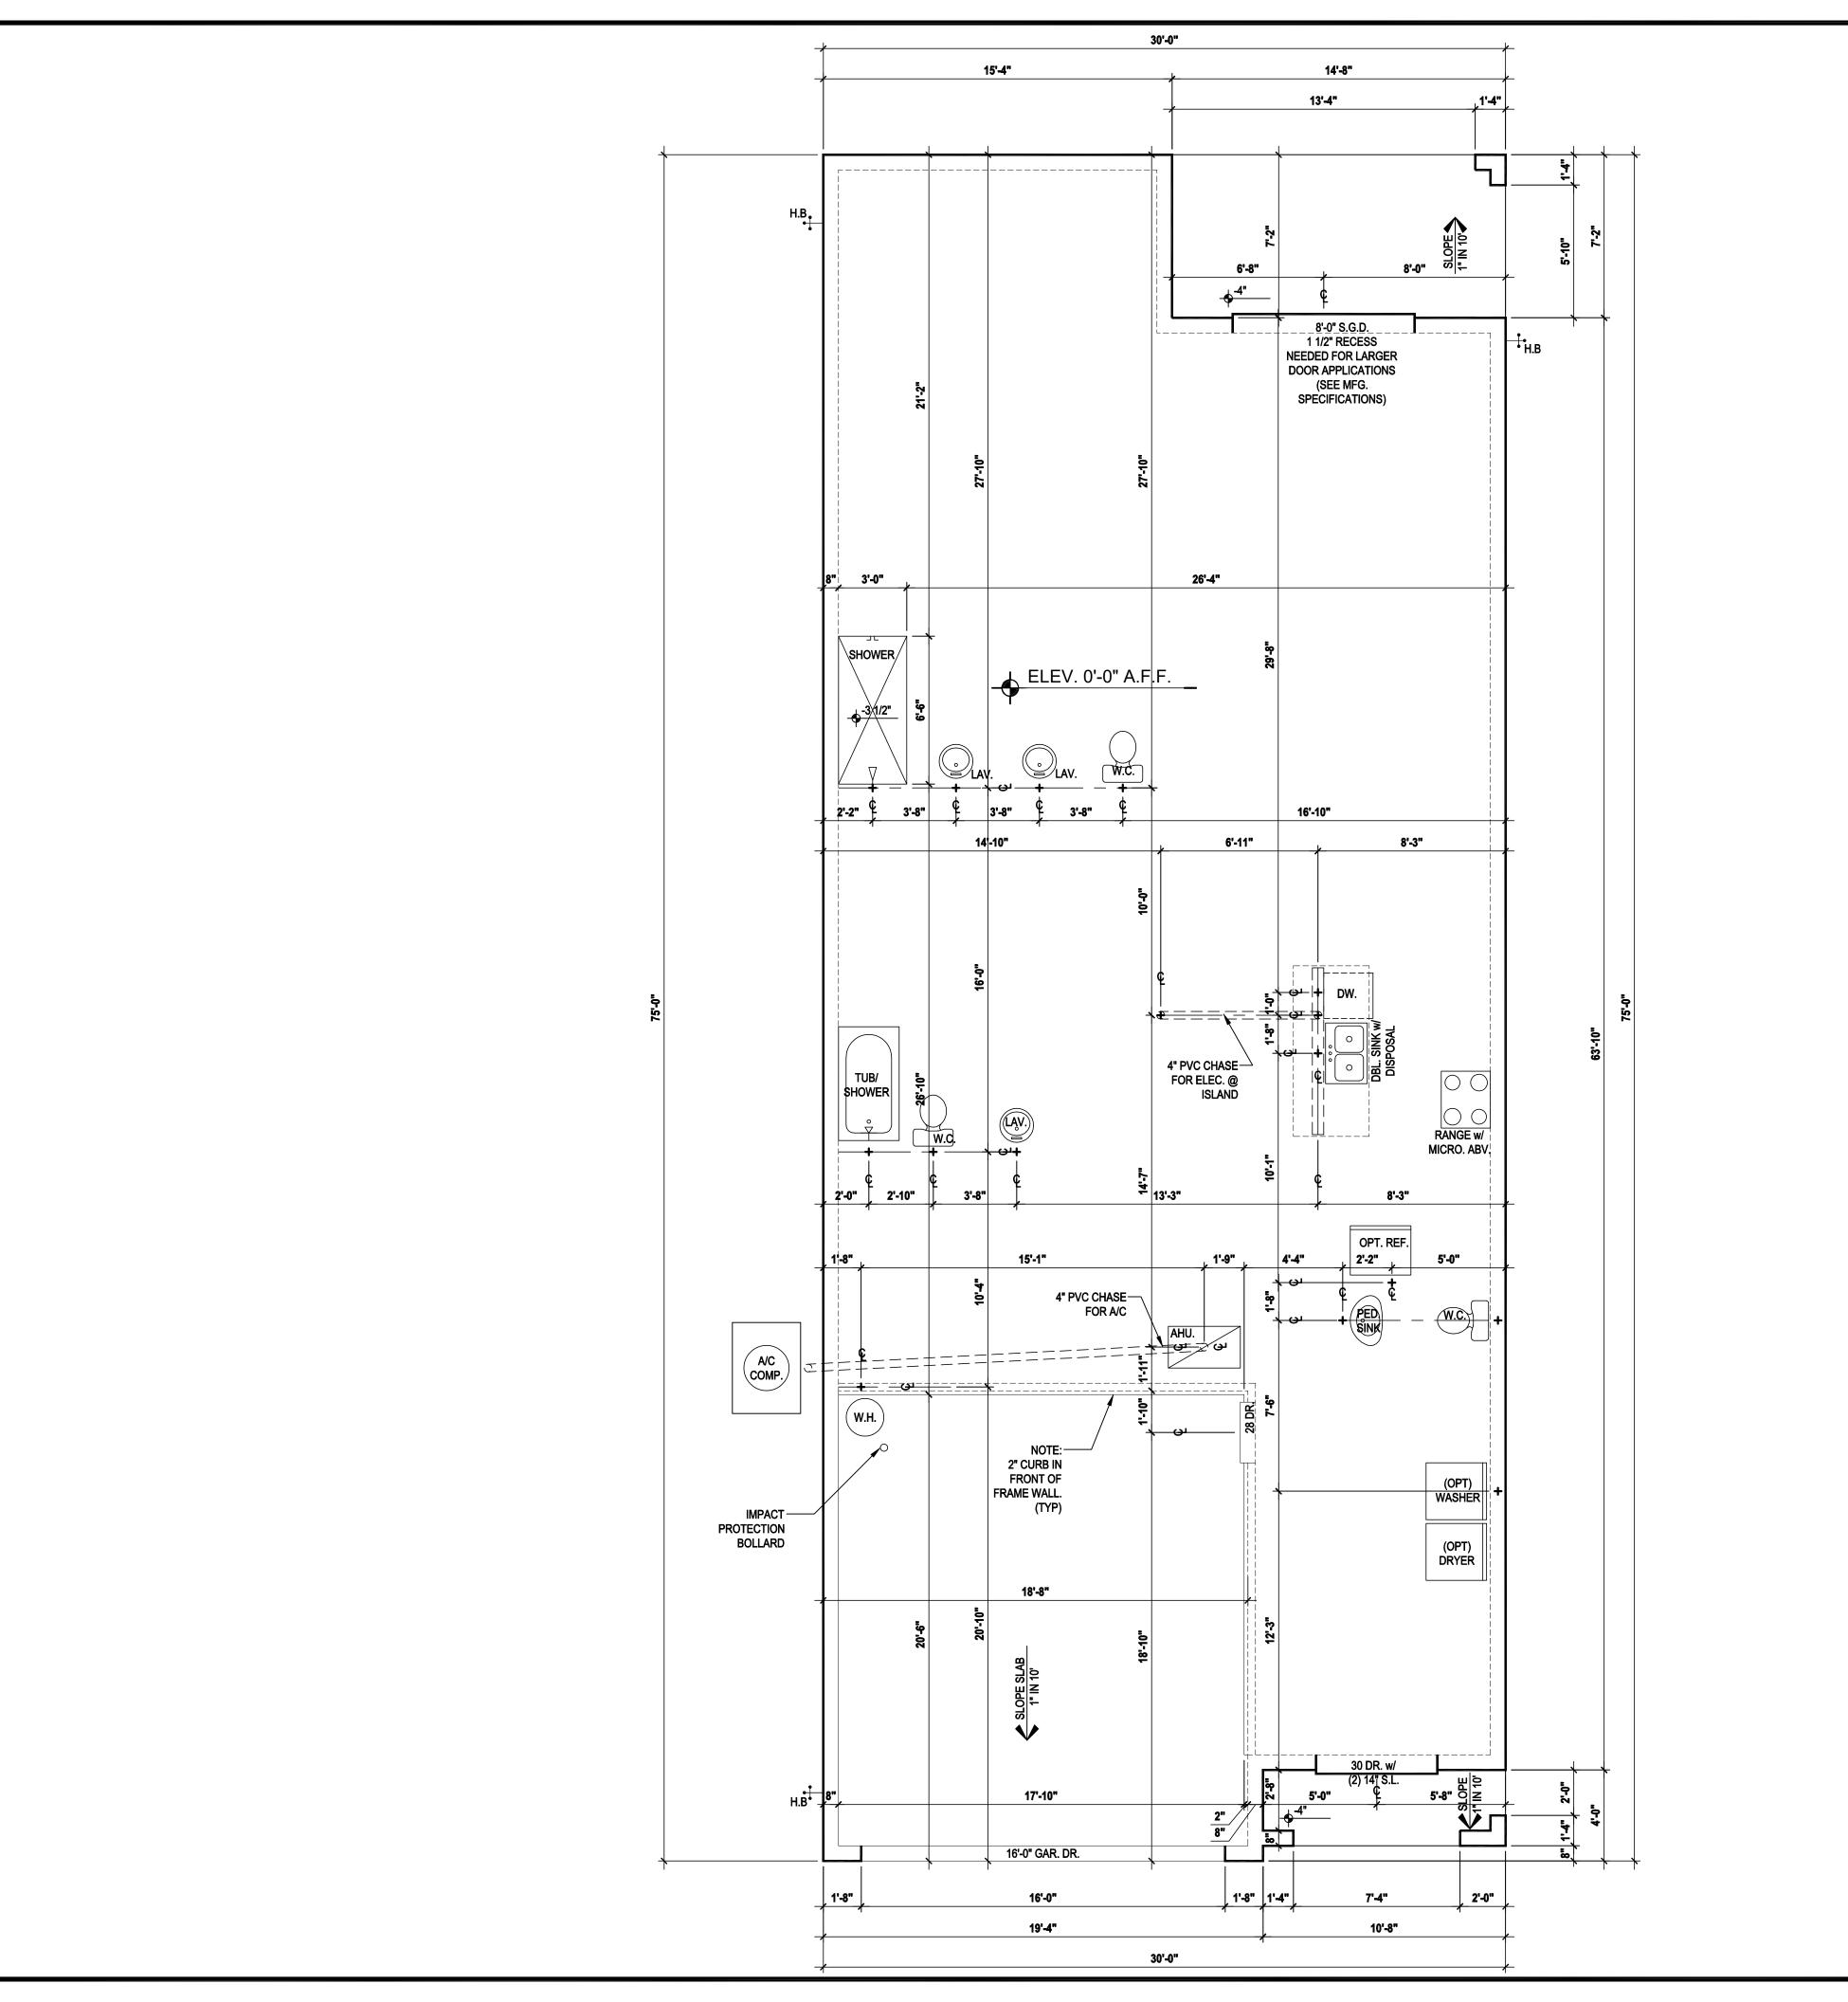

GENERAL NOTES KEY:

- CONTRACTOR TO VERIFY ALL DIMENSIONS ON JOB
- DO NOT SCALE PRINTS. CONSTRUCTION TO BE FROM CALCULATED DIMENSIONS ONLY. ANY DISCREPANCIES OR ERRORS TO BE REPORTED PROMPTLY TO SUPERVISOR FOR CLARIFICATION.
- WATER HEATER T & P RELIEF VALVE SHALL BE FULL SIZE TO EXTERIOR WATER HEATED AT OR ABOVE FLOOR LEVEL SHALL BE IN A PAN WITH DRAIN TO EXTERIOR. WATER HEATER SHALL HAVE AN APPROVED THERMAL EXPANSION DEVICE.
- PAVERS MAY BE USED ILO CONCRETE SLAB AT PATIO, PORCH, DRIVE AND WALKWAY.
- IN LEIU OF TREATING THE SOIL AN ALTERNATIVE TO TERMITE TREATED SOIL CAN BE TERMICIDE.
- BORA-CARE TO BE APPLIED ON INTERIOR WALLS IAW MANUFACTURERS INSTRUCTIONS AND SPECIFICATIONS. PURSUANT TO CH.482 OF THE FLORIDA BUILDING CODE.

DOOR NOTE KEY:

- 30 = 3'-0"
- * ALL INT. DOORS TO BE 6'-8" TALL U.N.O. OR PER BUILDER/CLIENT





30-1700
Lot # - Subdivision
Street Address
City, State. Zip

A division of Park Square

Enterprises Inc.
5200 Vineland Rd. Suite #200
Orlando, Fl. 32811
Phone: (407) 529-3000


REVISIONS

PROJECT: 22-1184 AS NOTED DRAWN BY: C.C.

DESIGNED BY: MJS SLAB PLAN

SCALE: 1/4" = 1'-0" (22x34)

Slab Plan "A,B,C"

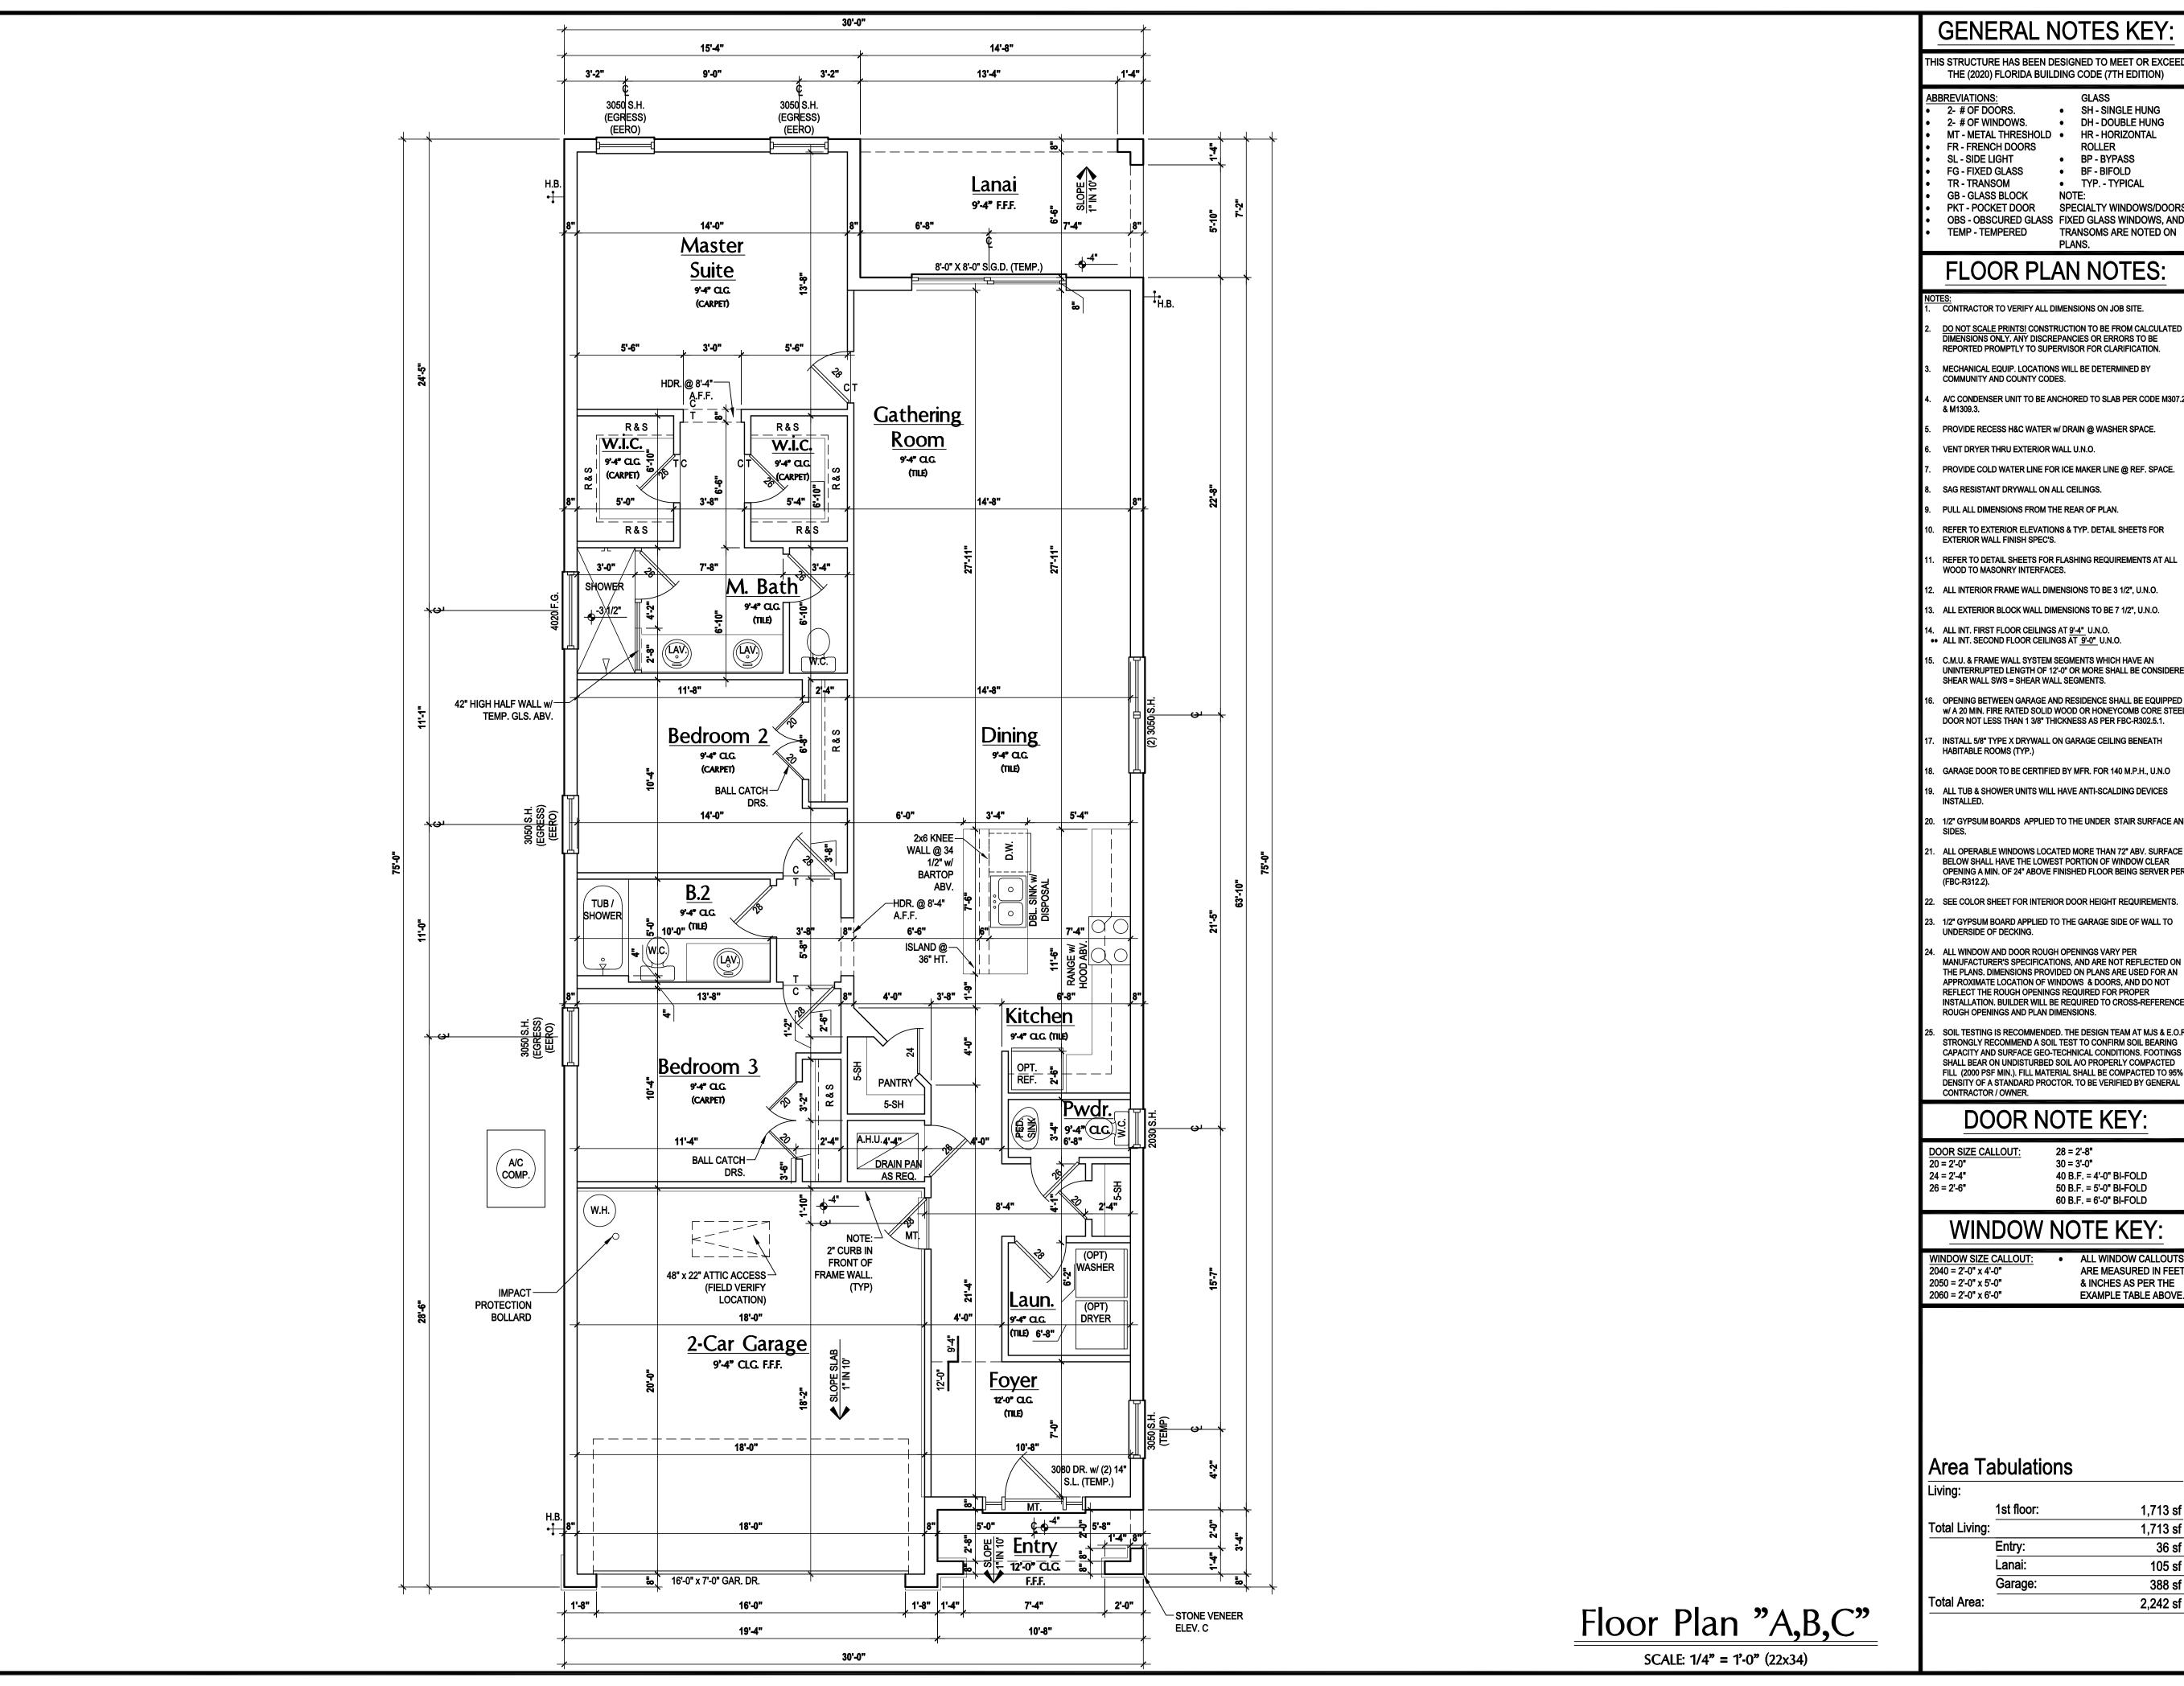

GENERAL NOTES KEY

THIS STRUCTURE HAS BEEN DESIGNED TO MEET OR EXCEED THE (2020) FLORIDA BUILDING CODE (7TH EDITION)

 SH - SINGLE HUNG DH - DOUBLE HUNG MT - METAL THRESHOLD • HR - HORIZONTAL ROLLER BP - BYPASS BF - BIFOLD TYP. - TYPICAL

TRANSOMS ARE NOTED ON

FG - FIXED GLASS TR - TRANSOM GB - GLASS BLOCK NOTE: PKT - POCKET DOOR SPECIALTY WINDOWS/DOORS OBS - OBSCURED GLASS FIXED GLASS WINDOWS, AND

FLOOR PLAN NOTES:

CONTRACTOR TO VERIFY ALL DIMENSIONS ON JOB SITE.

DO NOT SCALE PRINTS! CONSTRUCTION TO BE FROM CALCULATED DIMENSIONS ONLY. ANY DISCREPANCIES OR ERRORS TO BE REPORTED PROMPTLY TO SUPERVISOR FOR CLARIFICATION.

MECHANICAL EQUIP. LOCATIONS WILL BE DETERMINED BY COMMUNITY AND COUNTY CODES.

A/C CONDENSER UNIT TO BE ANCHORED TO SLAB PER CODE M307

PROVIDE RECESS H&C WATER w/ DRAIN @ WASHER SPACE.

VENT DRYER THRU EXTERIOR WALL U.N.O.

PROVIDE COLD WATER LINE FOR ICE MAKER LINE @ REF. SPACE.

PULL ALL DIMENSIONS FROM THE REAR OF PLAN.

REFER TO EXTERIOR ELEVATIONS & TYP. DETAIL SHEETS FOR

REFER TO DETAIL SHEETS FOR FLASHING REQUIREMENTS AT AL WOOD TO MASONRY INTERFACES.

ALL INTERIOR FRAME WALL DIMENSIONS TO BE 3 1/2", U.N.O.

ALL EXTERIOR BLOCK WALL DIMENSIONS TO BE 7 1/2", U.N.O.

ALL INT. FIRST FLOOR CEILINGS AT 9'-4" U.N.O. •• ALL INT. SECOND FLOOR CEILINGS AT 9'-0" U.N.O.

. C.M.U. & FRAME WALL SYSTEM SEGMENTS WHICH HAVE AN UNINTERRUPTED LENGTH OF 12'-0" OR MORE SHALL BE CONSIDERE SHEAR WALL SWS = SHEAR WALL SEGMENTS.

OPENING BETWEEN GARAGE AND RESIDENCE SHALL BE EQUIPPED w/ A 20 MIN. FIRE RATED SOLID WOOD OR HONEYCOMB CORE STEE DOOR NOT LESS THAN 1 3/8" THICKNESS AS PER FBC-R302.5.1.

INSTALL 5/8" TYPE X DRYWALL ON GARAGE CEILING BENEATH

GARAGE DOOR TO BE CERTIFIED BY MFR. FOR 140 M.P.H., U.N.O

. ALL TUB & SHOWER UNITS WILL HAVE ANTI-SCALDING DEVICES

. 1/2" GYPSUM BOARDS APPLIED TO THE UNDER STAIR SURFACE AND

ALL OPERABLE WINDOWS LOCATED MORE THAN 72" ABV. SURFACE BELOW SHALL HAVE THE LOWEST PORTION OF WINDOW CLEAR OPENING A MIN. OF 24" ABOVE FINISHED FLOOR BEING SERVER PER

SEE COLOR SHEET FOR INTERIOR DOOR HEIGHT REQUIREMENTS

1/2" GYPSUM BOARD APPLIED TO THE GARAGE SIDE OF WALL TO UNDERSIDE OF DECKING.

24. ALL WINDOW AND DOOR ROUGH OPENINGS VARY PER MANUFACTURER'S SPECIFICATIONS, AND ARE NOT REFLECTED ON THE PLANS. DIMENSIONS PROVIDED ON PLANS ARE USED FOR AN APPROXIMATE LOCATION OF WINDOWS & DOORS, AND DO NOT REFLECT THE ROUGH OPENINGS REQUIRED FOR PROPER

SOIL TESTING IS RECOMMENDED. THE DESIGN TEAM AT MJS & E.O.I STRONGLY RECOMMEND A SOIL TEST TO CONFIRM SOIL BEARING CAPACITY AND SURFACE GEO-TECHNICAL CONDITIONS. FOOTINGS SHALL BEAR ON UNDISTURBED SOIL A/O PROPERLY COMPACTED FILL (2000 PSF MIN.). FILL MATERIAL SHALL BE COMPACTED TO 95% DENSITY OF A STANDARD PROCTOR. TO BE VERIFIED BY GENERAL

DOOR NOTE KEY:

28 = 2'-8" 30 = 3'-0" 40 B.F. = 4'-0" BI-FOLD 50 B.F. = 5'-0" BI-FOLD 60 B.F. = 6'-0" BI-FOLD

WINDOW NOTE KEY:

WINDOW SIZE CALLOUT: 2040 = 2'-0" x 4'-0" ALL WINDOW CALLOUTS ARE MEASURED IN FEET & INCHES AS PER THE EXAMPLE TABLE ABOVE.

Area Tabulations

| Al Ca I | il Ca Tabalations | | |
|--------------|-------------------|------|--|
| Living: | | | |
| | 1st floor: | 1,71 | |
| Total Living | g: | 1,71 | |
| | Entry: | 3 | |
| | Lanai: | 10 | |
| | Garage: | 38 | |
| Total Area: | | 2,24 | |









30-1700 Lot # - Subdivision Street Address City, State. Zip


A division of Park Square Enterprises Inc. 00 Vineland Rd. Suite #200 Orlando, Fl. 32811



ISSUE DATE | 11/28/2023 REVISIONS

PROJECT: 22-1184 SCALE: AS NOTED DRAWN BY: C.C. DESIGNED BY: MJS


FLOOR PLAN **A2**

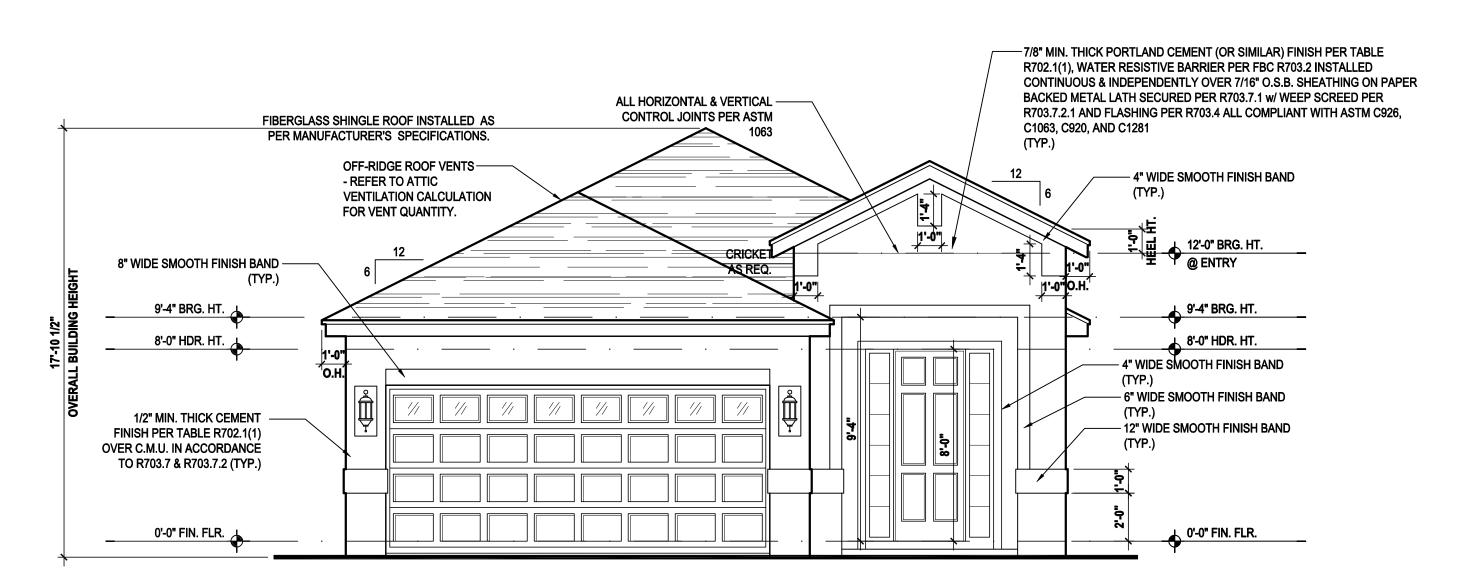

Front Elevation "A"

(Standard)

SCALE: 1/8" = 1'-0" (11x17) 1/4" = 1'-0" (22x34)

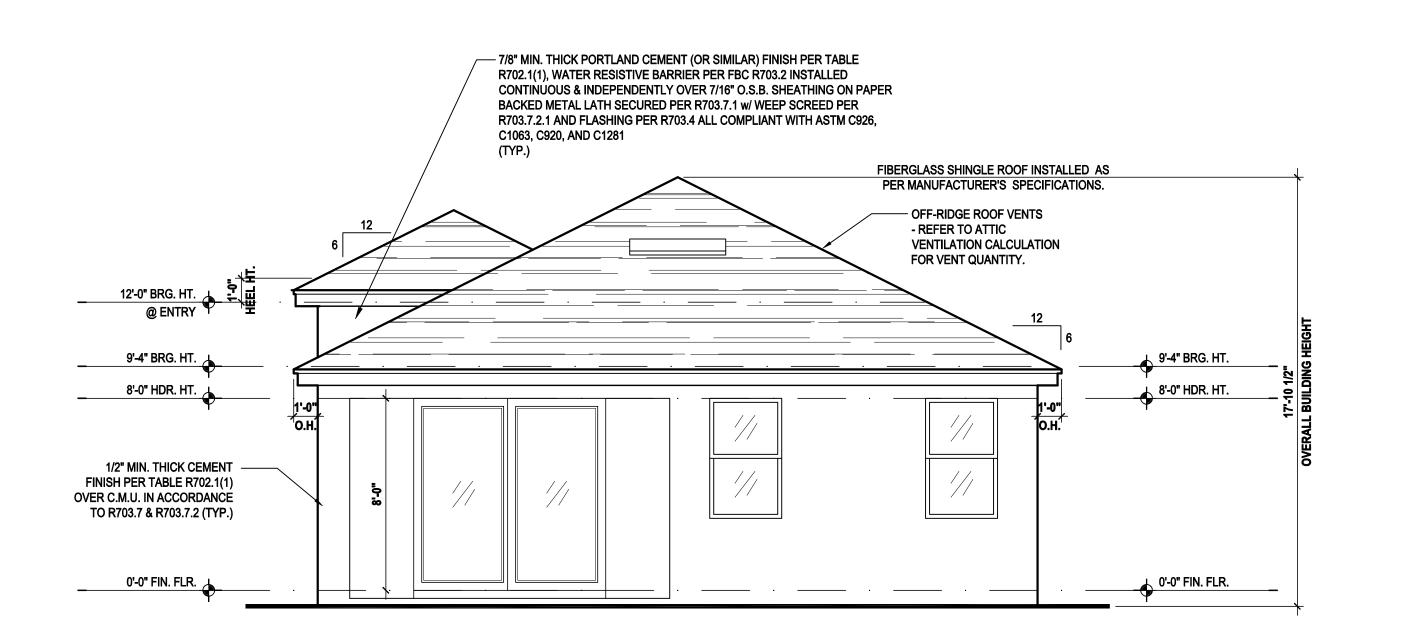

Rear Elevation "A"

(Standard)

SCALE: 1/8" = 1'-0" (11x17) 1/4" = 1'-0" (22x34)

ATTIC VENT CALC'S:

PER FBC2014 5TH EDITION R806. MIN. 40% - MAX 50% OF REQUIRED VENTILATION TO BE IN UPPER PORTION OF ATTIC SPACE AND THE BALANCE TO BE IN LOWER PORTION (EAVES).

MINIMUM NET VENTILATION AREA SHALL BE $\frac{1}{150}$ OF VENTED SPACE.


TOTAL VENTED SPACE: $\frac{2,530}{300} = \frac{8.43 \text{ SF.}}{\text{REQUIRED}}$

UPPER PORTION VENTILATION TOTAL: 3.373 SF.
TO BE PROVIDED w/ OFF RIDGE VENTS:
5 VENTS @ .652 /PER VENT

TILE: O'HAGIN MODEL "S", SHINGLE: LOMANCO 770-D).

LOWER PORTION VENTILATION TOTAL: 5.058 SF.
TO BE PROVIDED w/ SOFFITS @ EAVE:
80.00 LF. @ 0.063 SF. VENTING/LF

UPPER ROOF PERCENTAGE: 40% LOWER ROOF PERCENTAGE: 60%

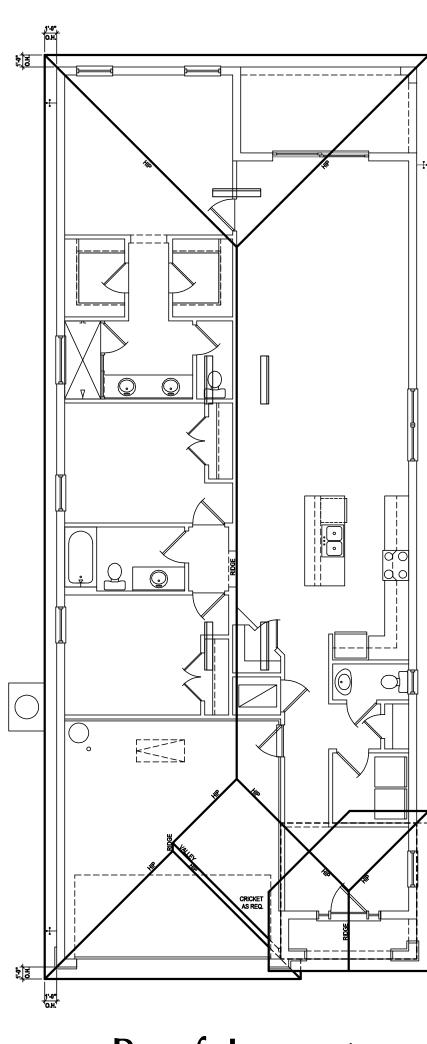

Roof Layout

SCALE: 1/16" = 1'-0" (11x17) 1/8" = 1'-0" (22x34)



THOMPSON ENGIN 4401 Vineland Road Sui Ph: (407) 734-1450 Fax: (407) 734-1790 www.tegfl.com

h: (407) 629-6711
ax: (407) 629-6711
x: (407) 629-6776
xww.mjshomedesigns.com
popyright notice: these Plans, designs







30-1700
Lot # - Subdivision
Street Address
City, State. Zip

A division of Park Square Enterprises Inc. 5200 Vineland Rd. Suite #200 Orlando, Fl. 32811




ISSUE DATE 11/28/2023
REVISIONS

PROJECT: 22-1184
SCALE: AS NOTED
DRAWN BY: C.C.

DESIGNED BY: MJS


ELEVATIONS "A"

A3.A

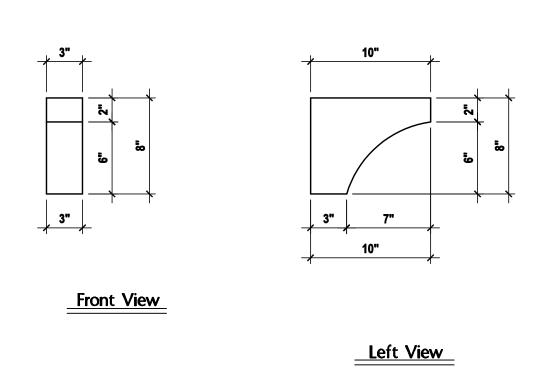

Detail #1


SCALE: 1 1/2" = 1'-0" (22x34)

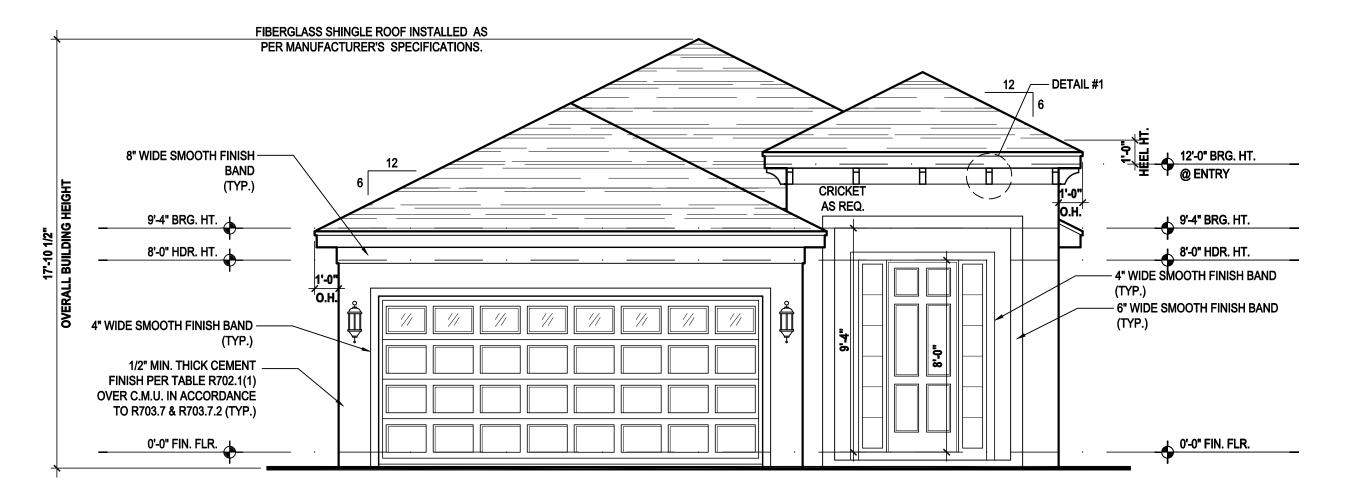

Front Elevation "B"

(Standard)

SCALE: 1/8" = 1'-0" (11x17) 1/4" = 1'-0" (22x34)

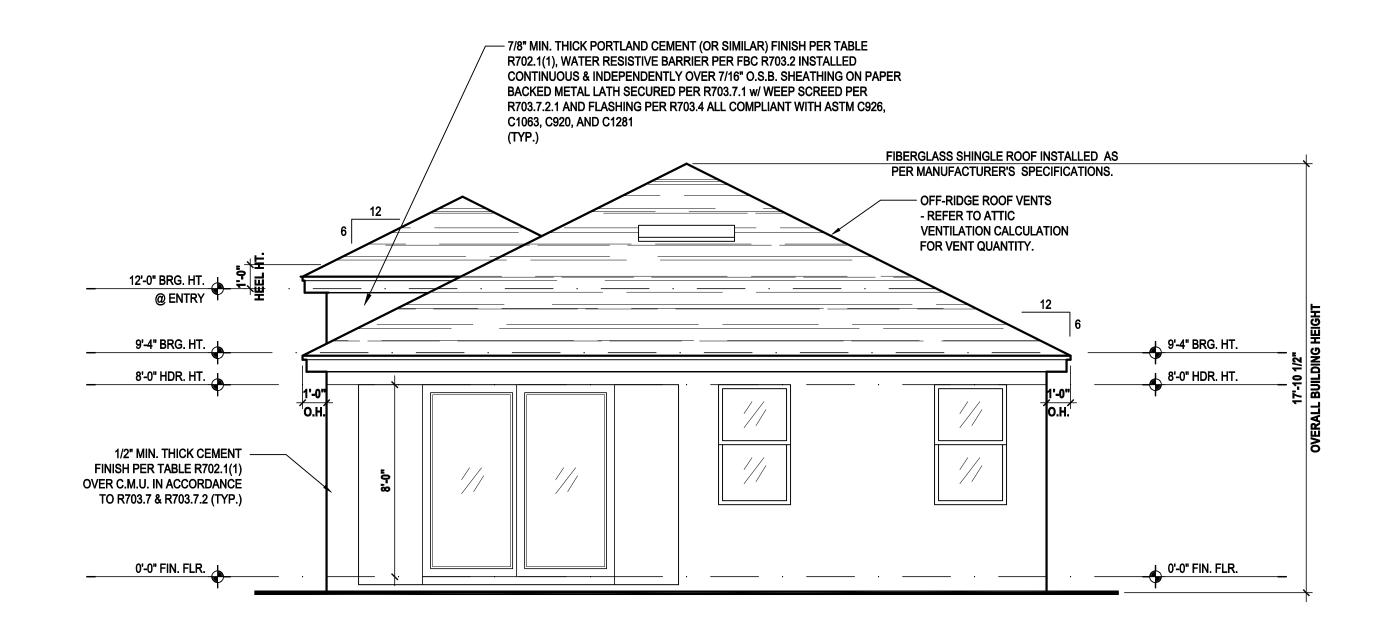

Rear Elevation "B"

(Standard)

SCALE: 1/8" = 1'-0" (11x17) 1/4" = 1'-0" (22x34)

ATTIC VENT CALC'S:

PER FBC2014 5TH EDITION R806. MIN. 40% - MAX 50% OF REQUIRED VENTILATION TO BE IN UPPER PORTION OF ATTIC SPACE AND THE BALANCE TO BE IN LOWER PORTION (EAVES).

MINIMUM NET VENTILATION AREA SHALL BE $\frac{1}{150}$ OF VENTED SPACE.


TOTAL VENTED SPACE: $\frac{2,530}{300} = \frac{8.43 \text{ SF.}}{8.43 \text{ NET FREE}}$ REQUIRED


UPPER PORTION VENTILATION TOTAL: 3.373 SF.
TO BE PROVIDED w/ OFF RIDGE VENTS:


5 <u>VENTS @ .652 /PER VEN'</u> TILE: O'HAGIN MODEL "S", SHINGLE: LOMANCO 770-D).

LOWER PORTION VENTILATION TOTAL: 5.058 SF.
TO BE PROVIDED w/ SOFFITS @ EAVE:
80.00 LF. @ 0.063 SF. VENTING/LF.

UPPER ROOF PERCENTAGE: 40% LOWER ROOF PERCENTAGE: 60%

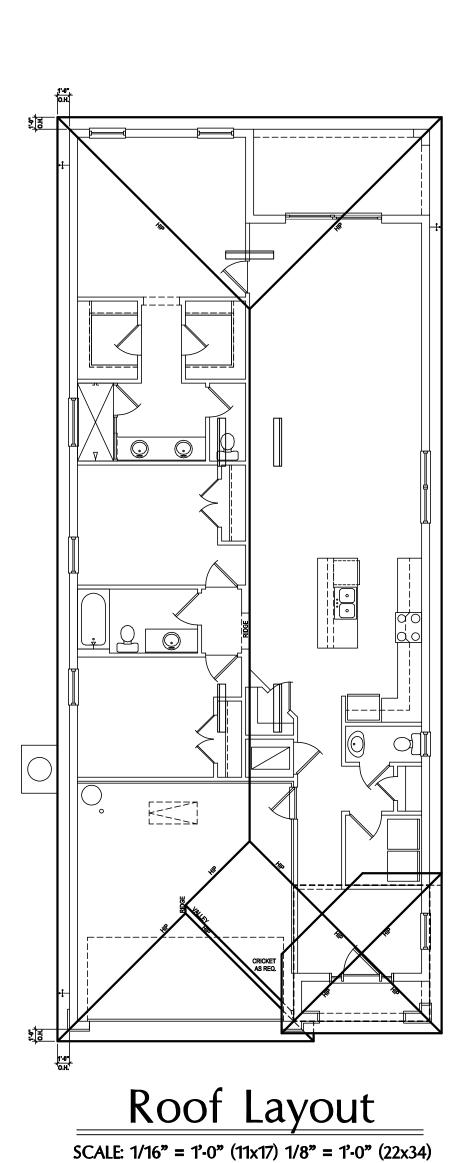

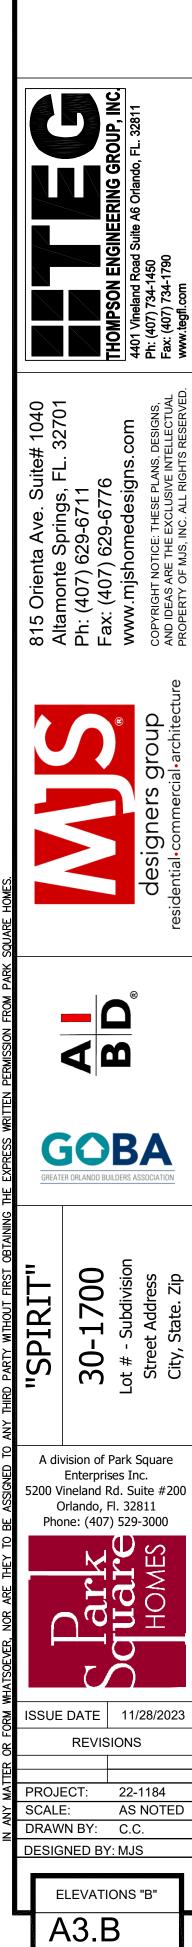


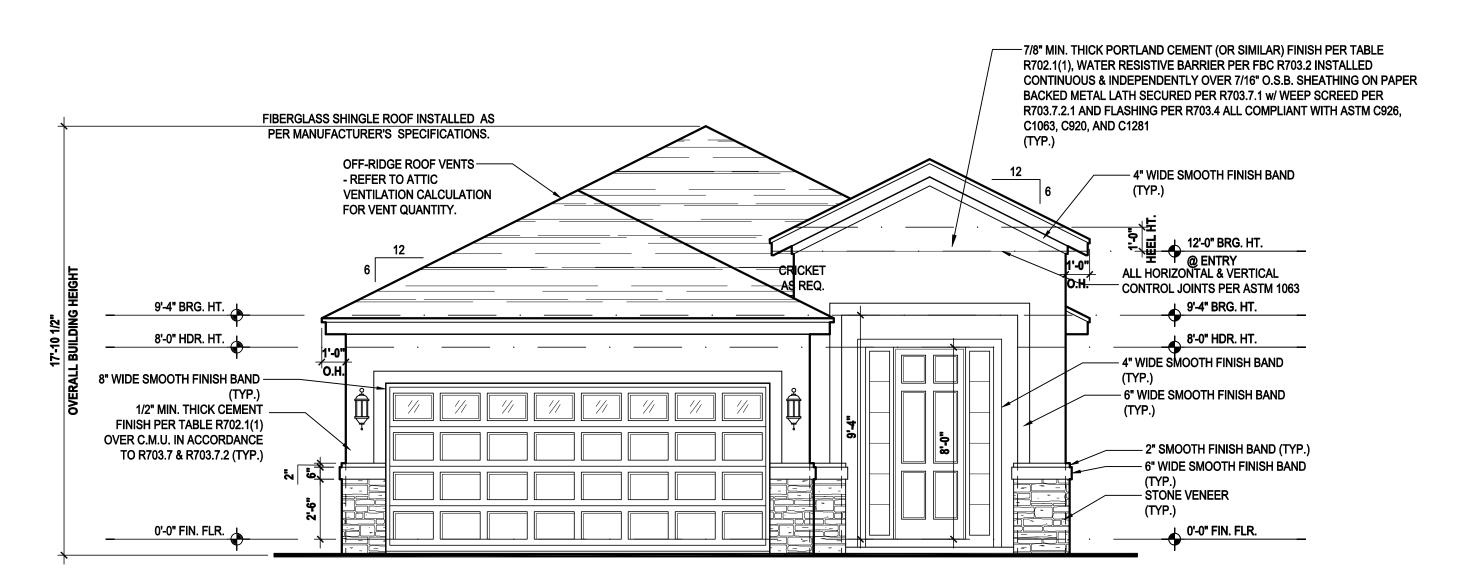

Front Elevation "C"

(Standard)

SCALE: 1/8" = 1'-0" (11x17) 1/4" = 1'-0" (22x34)

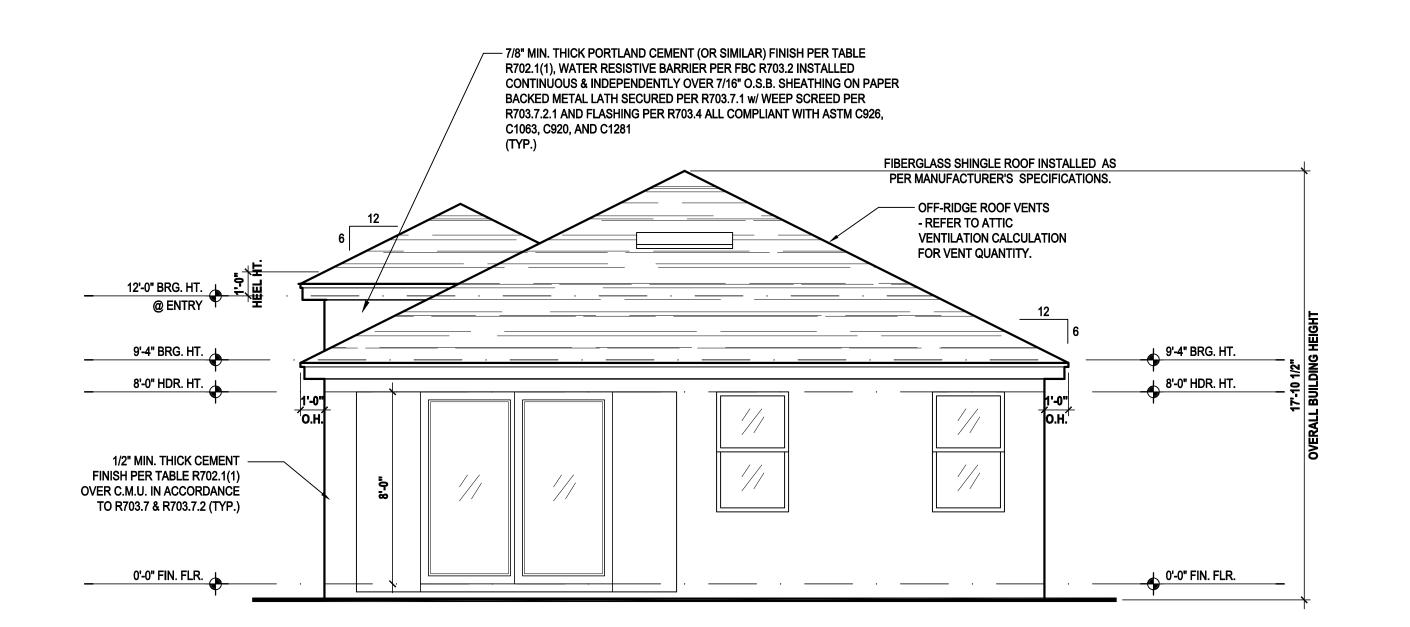

Rear Elevation "C"

(Standard)

SCALE: 1/8" = 1'-0" (11x17) 1/4" = 1'-0" (22x34)

ATTIC VENT CALC'S:

PER FBC2014 5TH EDITION R806. MIN. 40% - MAX 50% OF REQUIRED VENTILATION TO BE IN UPPER PORTION OF ATTIC SPACE AND THE BALANCE TO BE IN LOWER PORTION (EAVES).

MINIMUM NET VENTILATION AREA SHALL BE $\frac{1}{150}$ OF VENTED


TOTAL VENTED SPACE: $\frac{2,530}{300} = \frac{8.43 \text{ SF.}}{\text{REQUIRED}}$


UPPER PORTION VENTILATION TOTAL: 3.373 SF. TO BE PROVIDED w/ OFF RIDGE VENTS: 5 VENTS @ .652 /PER VENT

TILE: O'HAGIN MODEL "S", SHINGLE: LOMANCO 770-D).

LOWER PORTION VENTILATION TOTAL: 5.058 SF. TO BE PROVIDED w/ SOFFITS @ EAVE: 80.00 LF. @ 0.063 SF. VENTING/LF.

UPPER ROOF PERCENTAGE: 40% LOWER ROOF PERCENTAGE: 60%

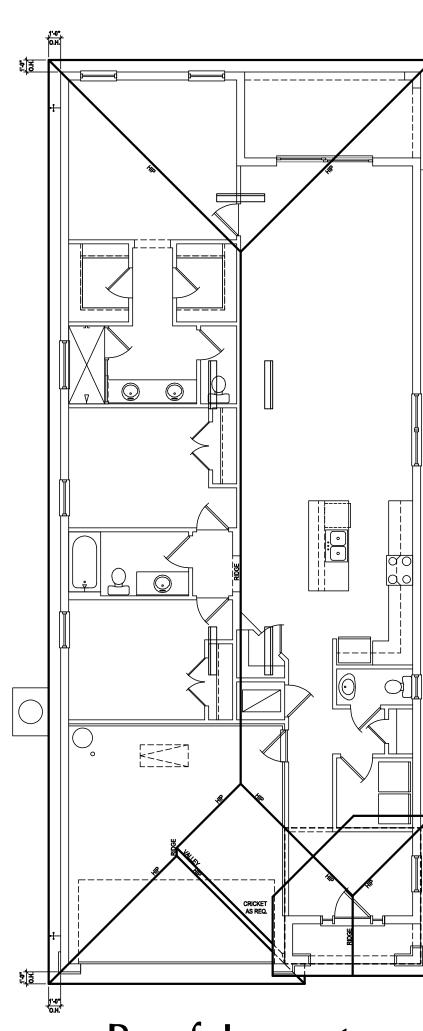

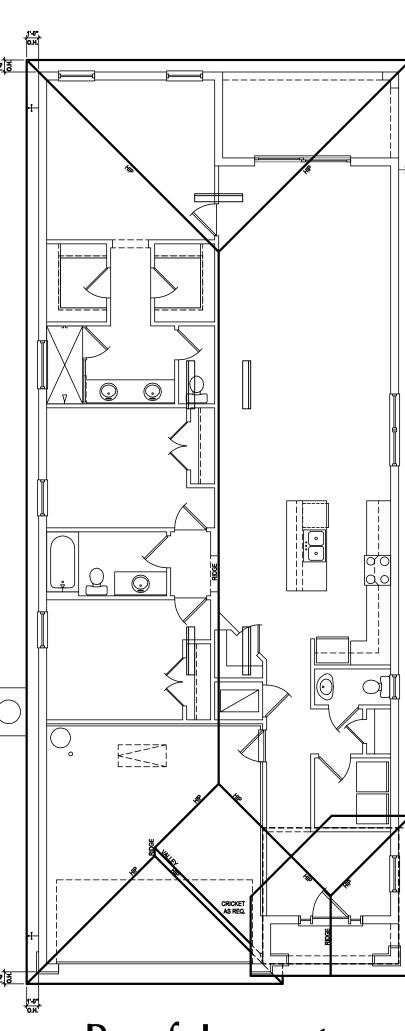

Roof Layout

SCALE: 1/16" = 1'-0" (11x17) 1/8" = 1'-0" (22x34)





30-1700
Lot # - Subdivision
Street Address
City, State. Zip

A division of Park Square Enterprises Inc.


5200 Vineland Rd. Suite #200 Orlando, Fl. 32811 Phone: (407) 529-3000

ISSUE DATE | 11/28/2023 **REVISIONS**

PROJECT: 22-1184 SCALE: AS NOTED DRAWN BY: C.C.

DESIGNED BY: MJS


ELEVATIONS "C" A3.C

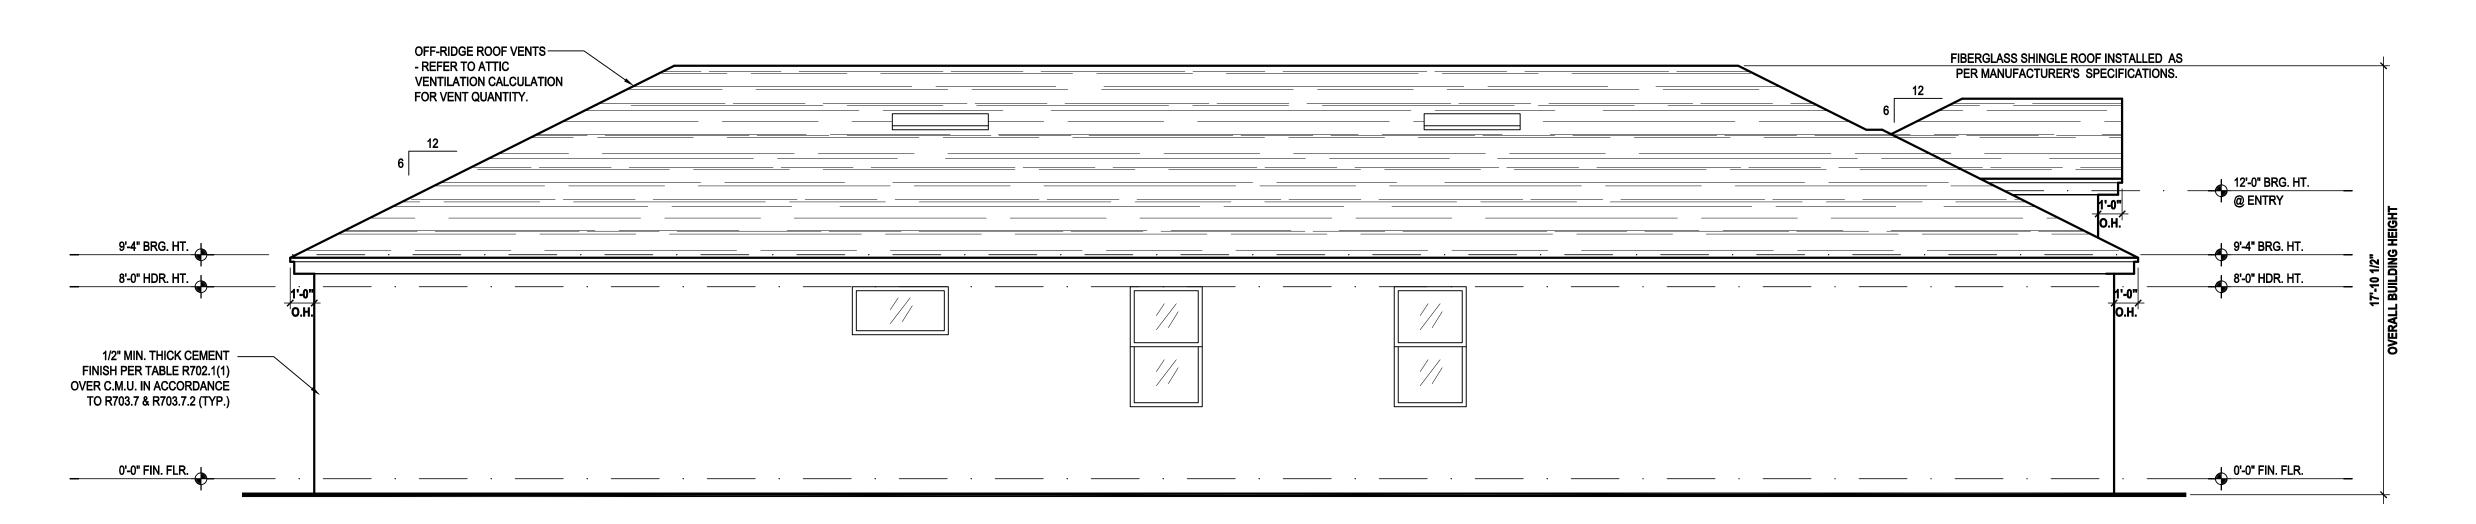

Left Elevation "A"

(Standard)

SCALE: 1/8" = 1'-0" (11x17) 1/4" = 1'-0" (22x34)

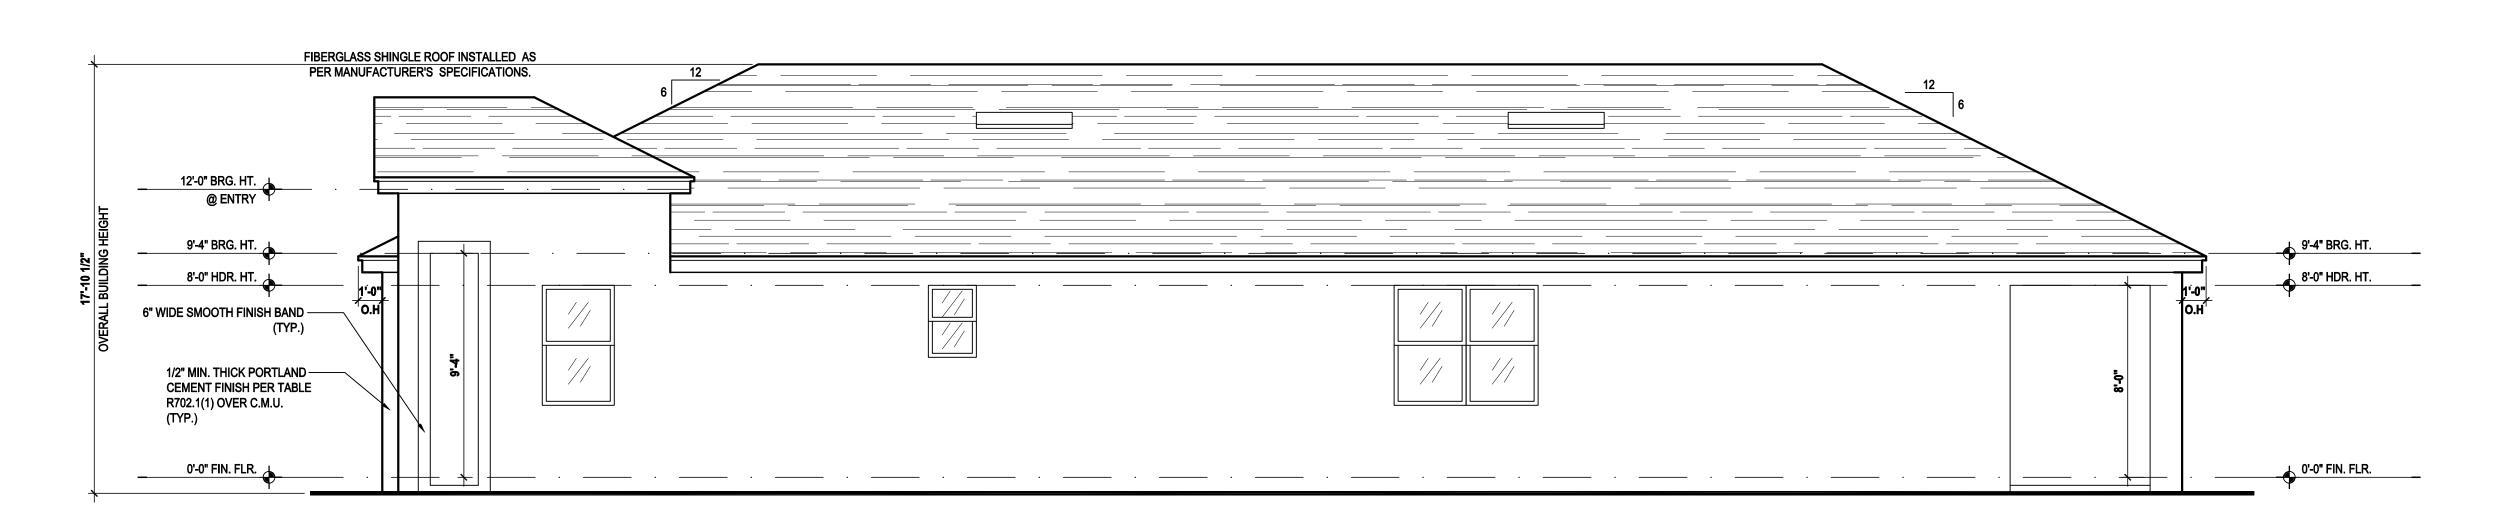

Right Elevation "A"

(Standard)

SCALE: 1/8" = 1'-0" (11x17) 1/4" = 1'-0" (22x34)



6776

HOMPSOI

designs.com

ESE PLANS, DESIGNS, Fay: (407) 734-

Altamonte Springs, FL. 32 Ph: (407) 629-6711 Fax: (407) 629-6776 www.mjshomedesigns.cor







0-1700
- Subdivision

A division of Park Square
Enterprises Inc.
5200 Vineland Rd. Suite #20

Enterprises Inc.
5200 Vineland Rd. Suite #200
Orlando, Fl. 32811
Phone: (407) 529-3000

ISSUE DATE 11/28/2


PROJECT: 22-1184
SCALE: AS NOTED
DRAWN BY: C.C.

SCALE: AS NOT DRAWN BY: C.C.

DESIGNED BY: MJS

ELEVATIONS "A"


A4.A

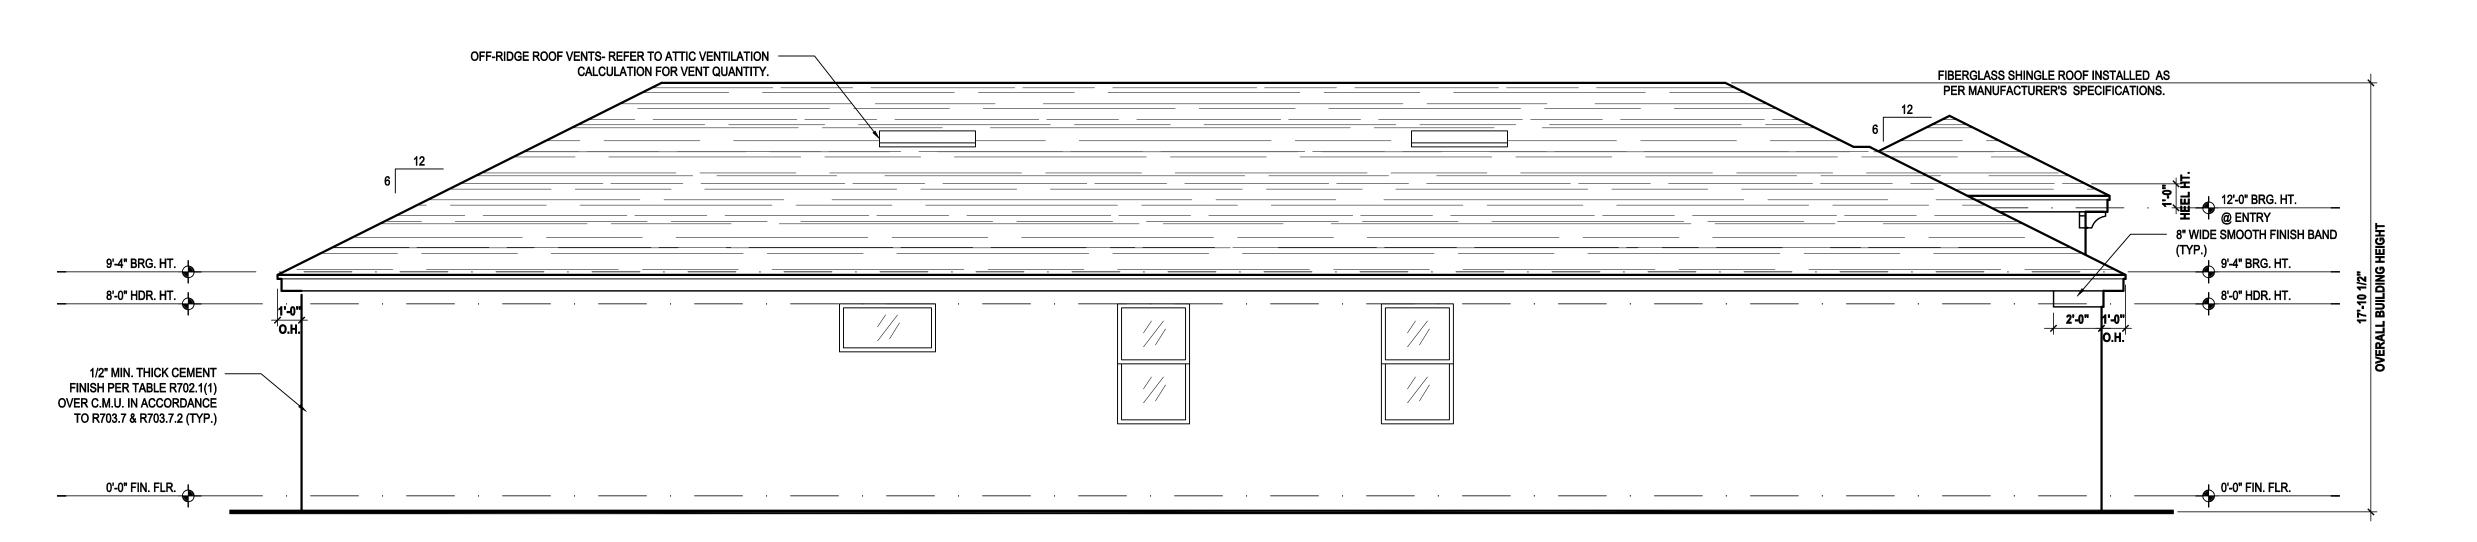

Left Elevation "B"

(Standard)

SCALE: 1/8" = 1'-0" (11x17) 1/4" = 1'-0" (22x34)

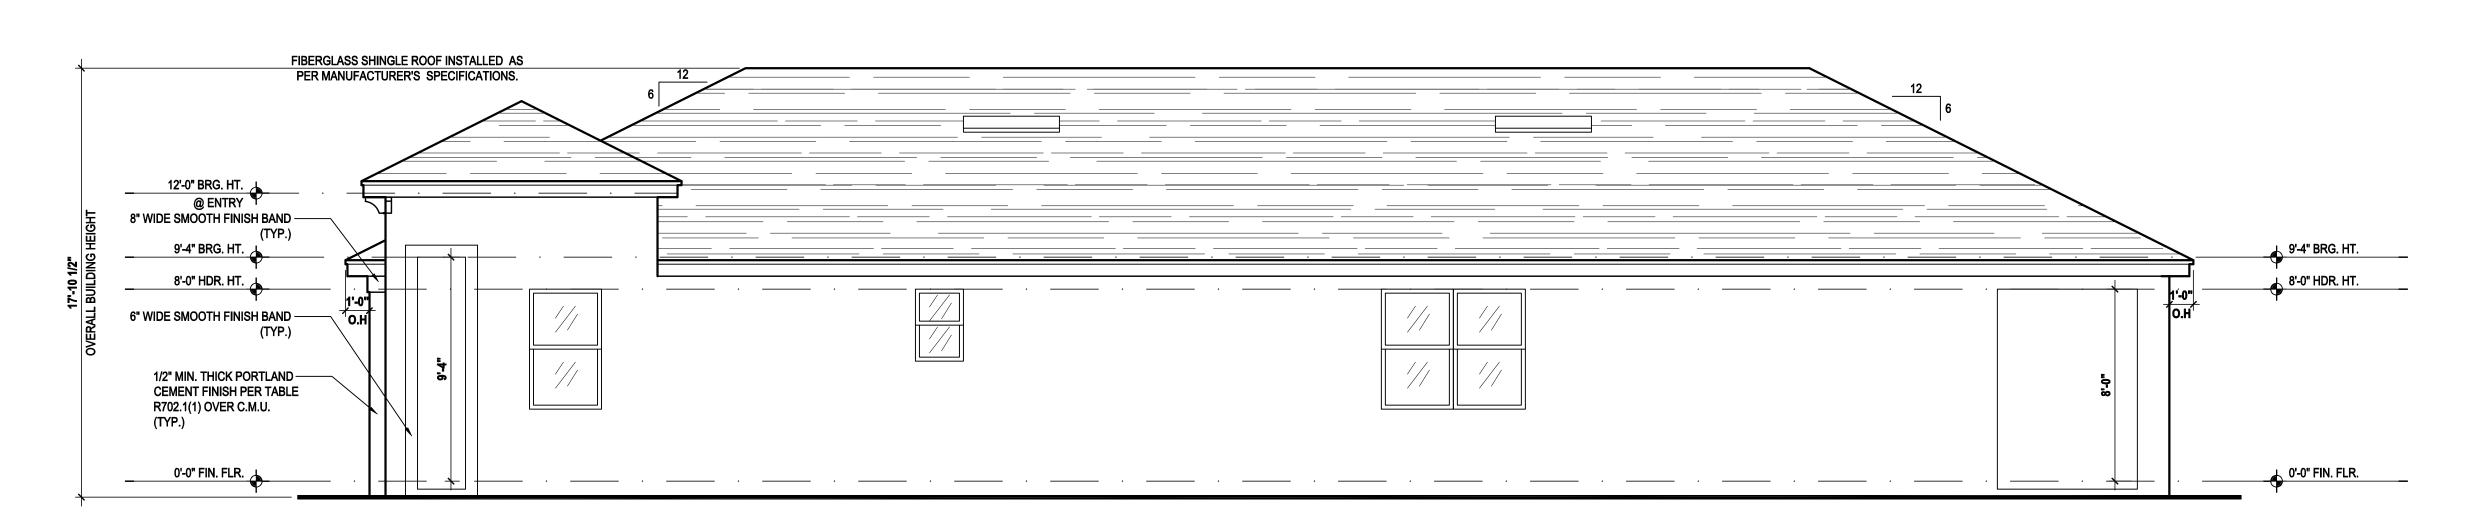

Right Elevation "B"

(Standard)

SCALE: 1/8" = 1'-0" (11x17) 1/4" = 1'-0" (22x34)



THOMPSON E
SIGNS. COM
E PLANS, DESIGNS, SIVE INTELLECTUAL
Fax: (407) 734-14

Altamonte Springs, FL. 32 Ph: (407) 629-6711
Fax: (407) 629-6776
www.mjshomedesigns.cor







30-1700 t # - Subdivision

A division of Park Square Enterprises Inc. 5200 Vineland Rd. Suite #20

Enterprises Inc.
5200 Vineland Rd. Suite #200
Orlando, Fl. 32811
Phone: (407) 529-3000

ISSUE DATE 11/28/2023
REVISIONS

PROJECT: 22-1184

SCALE: AS NOTED


DRAWN BY: C.C.

ELEVATIONS "B"

Left Elevation "C"

(Standard)

SCALE: 1/8" = 1'-0" (11x17) 1/4" = 1'-0" (22x34)

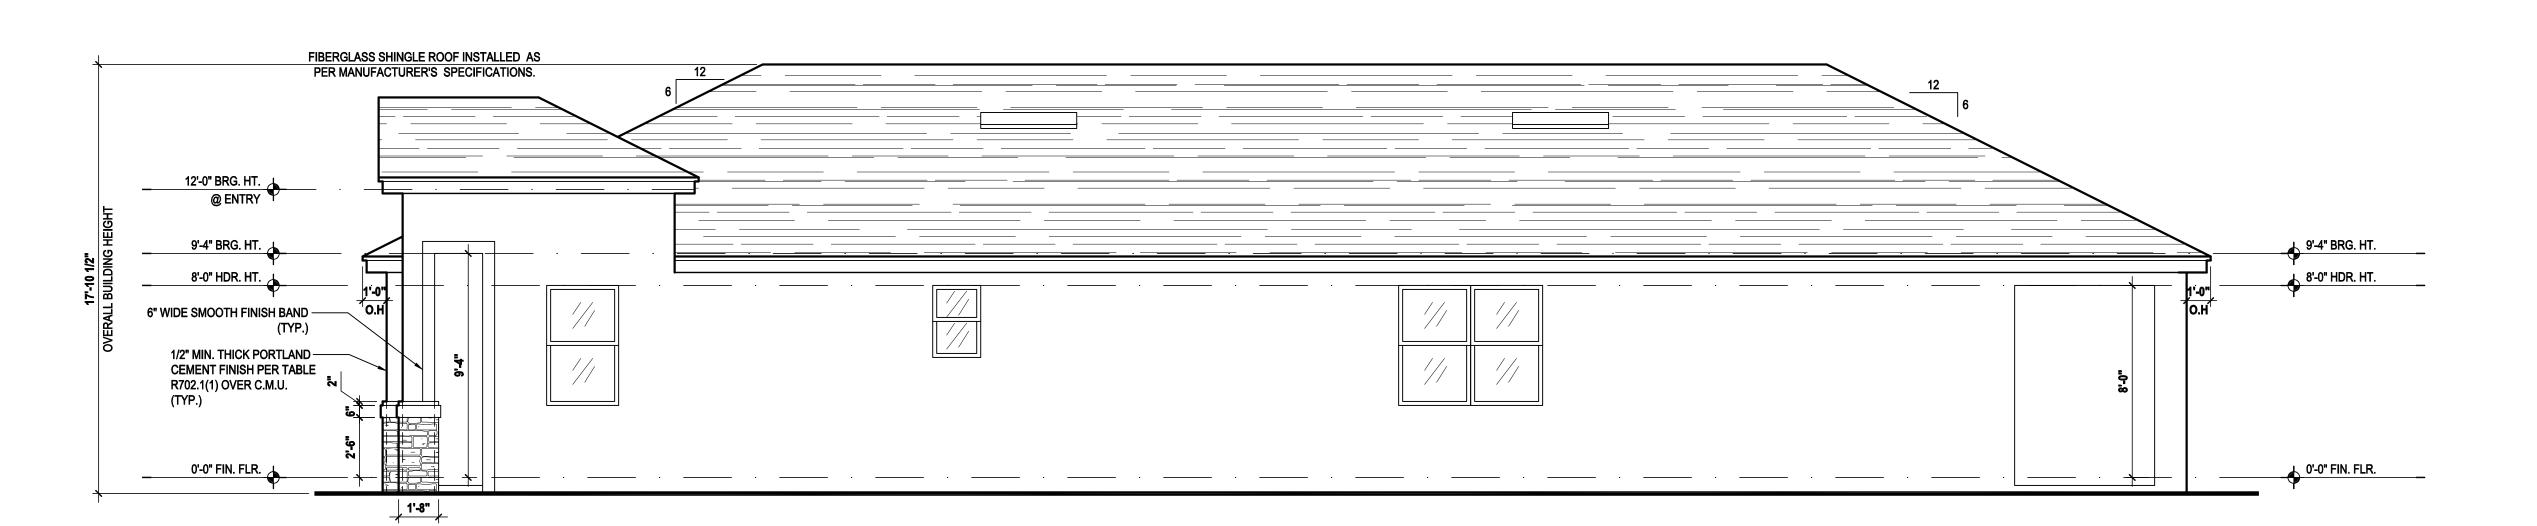

Right Elevation "C"

(Standard)

SCALE: 1/8" = 1'-0" (11x17) 1/4" = 1'-0" (22x34)



529-6776
529-6776
medesigns.com
4401 V

Altamonte Springs,
Ph: (407) 629-6711
Fax: (407) 629-677
www.mjshomedesi







30-1700
Lot # - Subdivision
Street Address
City, State. Zip

A division of Park Square Enterprises Inc. 5200 Vineland Rd. Suite #200 Orlando, Fl. 32811 Phone: (407) 529-3000

Phone: (407) 529-3000

ISSUE DATE 11/28/2023
REVISIONS

PROJECT: 22-1184


SCALE: AS NOTED


DRAWN BY: C.C.

DESIGNED BY: MJS

ELEVATIONS "C"

A4.C

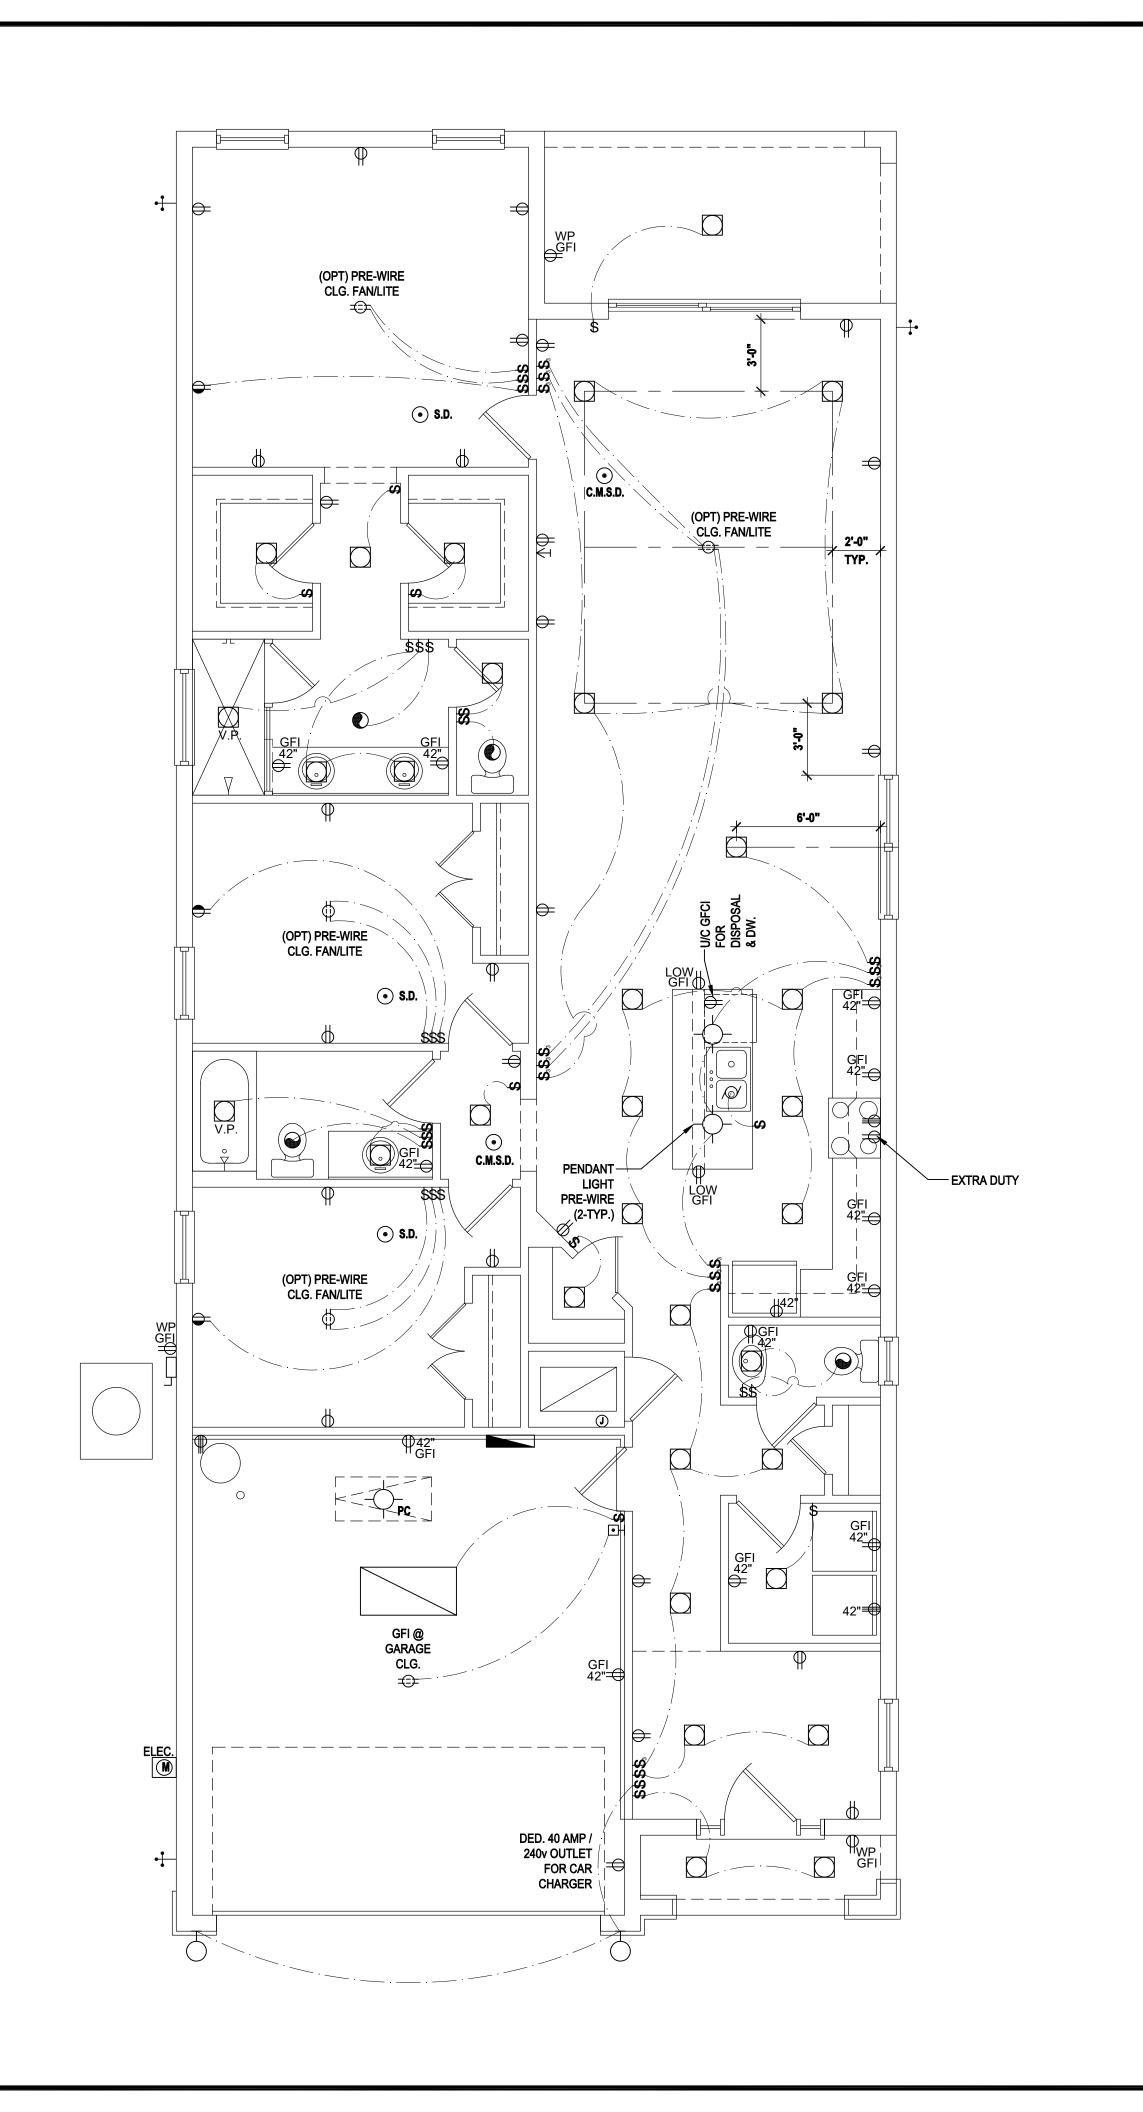

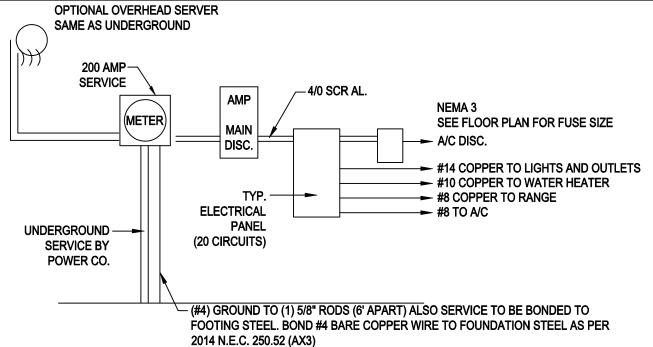

- ALL ELECTRICAL WORK AND MATERIAL PROVIDED SHALL COMPLY WITH THE FLORIDA BUILDING CODE (2020)
- THE ABOVE ELECTRICAL LAYOUT IS FOR BID PURPOSE ONLY.
- ELECTRICAL MATERIALS AND INSTALLATIONS SHALL COMPLY w/ APPLICABLE PROVISIONS OF THE NATIONAL ELECTRICAL CODE 250.52 (AX1) TO (6). LOCAL CODES AND THE LOCAL POWER COMPANY

200 AMP ELECTRICAL RISER

GENERAL NOTES KEY

- BUILDER TO VERIFY EXACT LOCATION OF FLOOR OUTLETS
- ALL OUTLETS ARE TO BE AFCI PROTECTED.
- ALL 15A AND 20A 120V BRANCH CIRCUITS WILL BE AFCI PROTECTED.
- ALL 15A AND 20A 120V BRANCH CIRCUITS LOCATED IN THE
- GARAGE AND LAUNDRY WILL BE GFCI PROTECTED.
- ALL GARAGE BAYS WILL HAVE DEDICATED GFCI OUTLET. ALL OUTLETS LOCATED IN THE KITCHEN AND BATHROOMS
- ARE TO BE GFCI PROTECTED.
- DW. AND GARBAGE DISPOSAL ARE TO BE GFCI PROTECTED.
- EXCEPTIONS TO THE GFCI STIPULATION WILL BE ALLOWED ONLY IF ALLOWED PER CURRENT NFPA / NEC.
- OUTLETS LOCATED IN THE LAUNDRY ARE TO BE GFCI AND AFCI PROTECTED.
- 0. OUTLETS LOCATED WITHIN 6'-0" OF A WET AREA ARE TO BE
- ALL OUTLETS OVER COUNTERTOPS TO BE 42" A.F.F. (U.N.O.)
- ALL SMOKE/CARBON MONOXIDE DETECTORS ARE TO BE
- HARD WIRED, INTERCONNECTED AND AFCI PROTECTED. 13. 8'-0" HEIGHT VANITY LIGHTS IN MASTER BATHROOM AND 7'-0"
- IN ALL OTHER BATHROOMS.
- 14. IN AREAS SPECIFIED IN SECTION E3901.1, 125-VOLT, 15- AND 20-AMPERE RECEPTACLES SHALL BE LISTED TAMPER-RESISTANT RECEPTACLES.

THIS DIAGRAMMATIC PLAN IS INTENDED TO SHOW LIGHTING AND CONVENIENCE OUTLETS ONLY. IT IS THE ELECTRICAL CONTRACTORS RESPONSIBILITY TO VERIFY THE REQUIREMENT AND LOCATIONS OF ALL ELECTRICAL EQUIPMENT, (INCLUDING KITCHEN EQUIPMENT) AND PROVIDE AND INSTALL COMPLETE ELECTRICAL SERVICE AS REQUIRED PER NFPA, NEC, FBC CODES AND ALL REIGNING MUNICIPALITY CODES, STANDARDS AND ORDINANCES.

- LOCATION OF FIXTURES AND / OR OUTLETS ARE SUGGESTED LOCATIONS AND MEET MOST LOCAL CODE REQUIREMENTS. ADDITIONS OR ADJUSTMENTS MAY BE MADE BETWEEN THE OWNER AND BUILDER IN THE FIELD.
- ALL ELECTRICAL WORK AND APPLIANCES ARE IN FULL COMPLIANCE WITH N.F.P.A., N.E.C., F.B.C. 7TH EDITION (2020) RESIDENTIAL, AND ALL APPLICABLE LOCAL STANDARDS, CODES, AND ORDINANCES.
- VARIOUS SYMBOLS ON ELECTRICAL LEGEND MAY OR MAY NOT BE USED ON THIS PLAN.



GOBA
GREATER ORLANDO BUILDERS ASSOCIATION

A division of Park Square Enterprises Inc. 5200 Vineland Rd. Suite #200

Orlando, Fl. 32811 Phone: (407) 529-3000

ISSUE DATE | 11/28/2023

REVISIONS

PROJECT: 22-1184

ELECTRICAL LAYOUT

DRAWN BY: C.C.

A5


AS NOTED

ELECTRICAL KEY:

| - | CEILING MOUNTED LIGHT |
|--|----------------------------------|
| | PULL CHAIN LIGHT |
| | FLUSH-MOUNT LED |
| | WALL MOUNTED LIGHT |
| | WALL WASH RECESSED |
| | DUPLEX RECEPTACLE |
| \(\begin{array}{c}\end{array}\) | 220 V RECEPTACLE |
| | 1/2 HOT, 1/2 SWITCHED |
| ₩P | WATER PROOF RECEPTACLE |
| | FLOOR RECEPTACLE |
| + | PRE-WIRE FOR CLG. FAN |
| ⇒ _{GFI} | GROUND FAULT INTERRUPT |
| \$ | WALL SWITCH |
| \$ ₃ | 3-WAY SWITCH |
| \$□ | DIMMER SWITCH |
| | TELEPHONE JACK |
| \forall | CABLE JACK |
| \bigoplus | PRE-WIRE GARAGE DOOR OPENER |
| | FLUORESCENT LIGHT |
| | ELECTRICAL PANEL |
| 00 | CHIME |
| ΗĐ | DOOR BELL / GARAGE DOOR SWITCH |
| | DISCONNECT SWITCH |
| M | ELECTRICAL METER |
| ⊙ S.D. | SMOKE DETECTOR |
| • C.M.S.D. | CARBON MONOXIDE / SMOKE DETECTOR |
| | CEILING FAN |
| • | WALL SCONCE |
| တို့ဝ | CHANDELIER |
| 44 | SPOT LIGHT |
| | FLUSH MOUNT FLUORESCENT LIGHT |
| | FAN / LIGHT COMBINATION |
| Ø | GARBAGE DISPOSAL MOTOR |
| (S) | SPEAKER |
| | |


• L.V.


A.F.

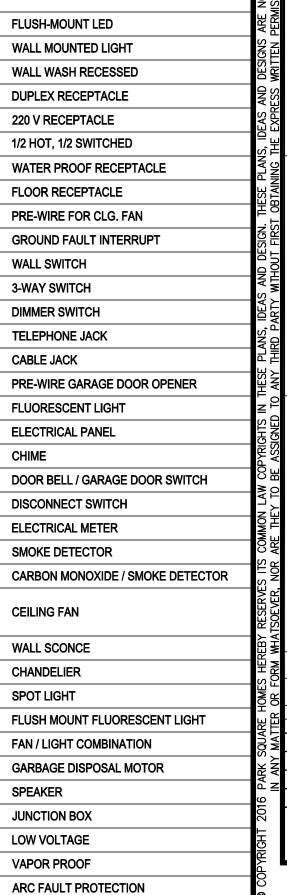


Electrical Plan "A,B,C"


SCALE: 1/4" = 1'-0" (22x34)

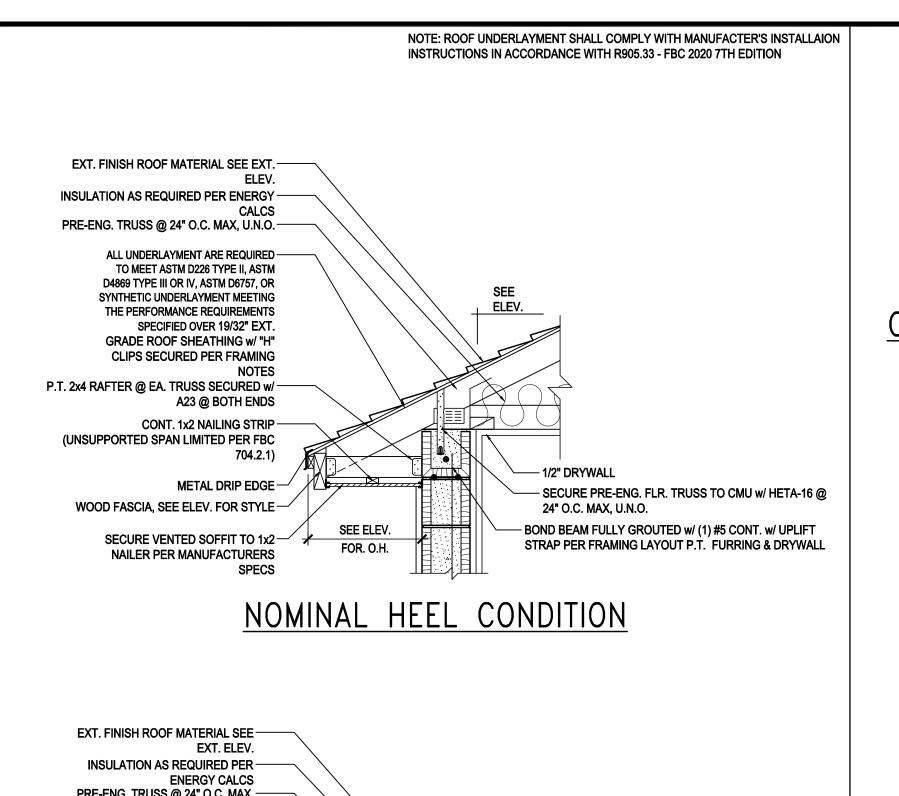

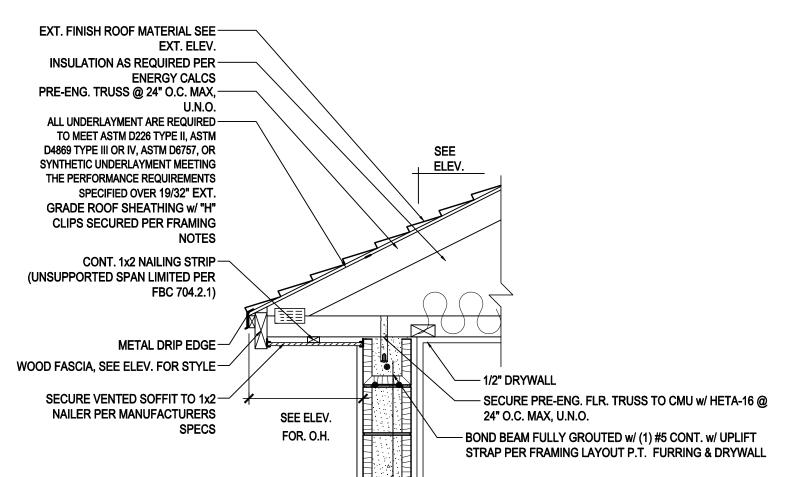



CANTILEVERED BTM. CHORD CONDITION

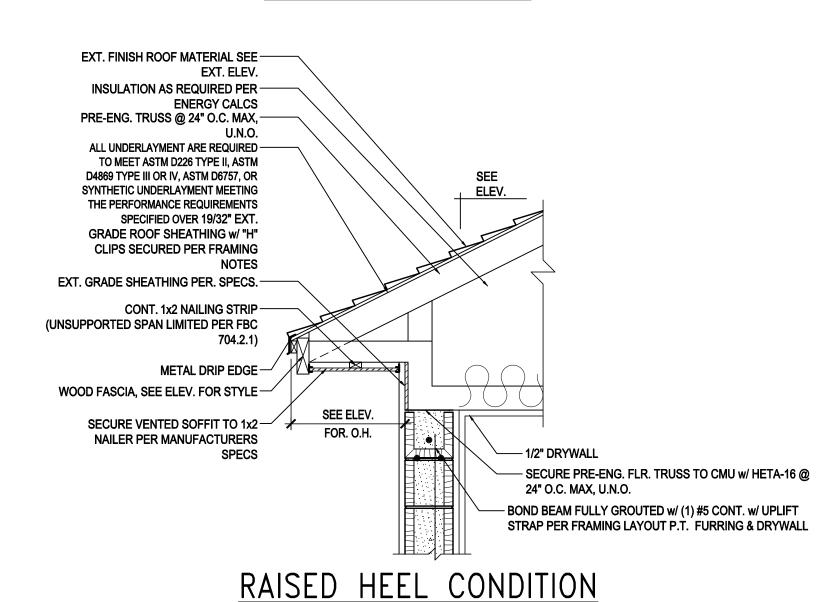

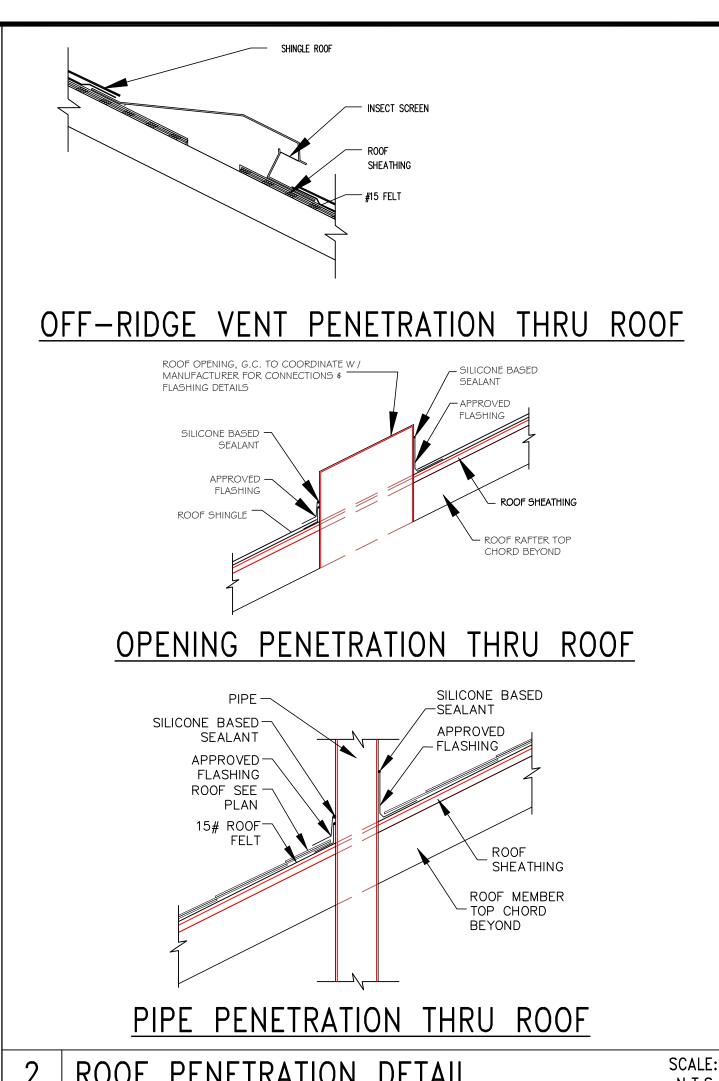

ROOF PENETRATION DETAIL

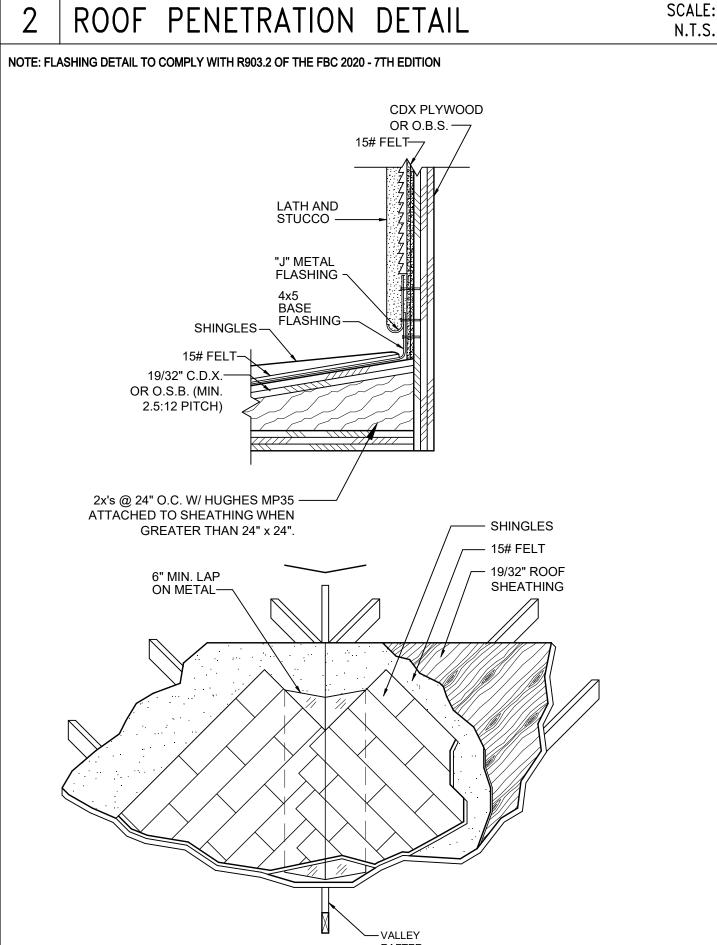


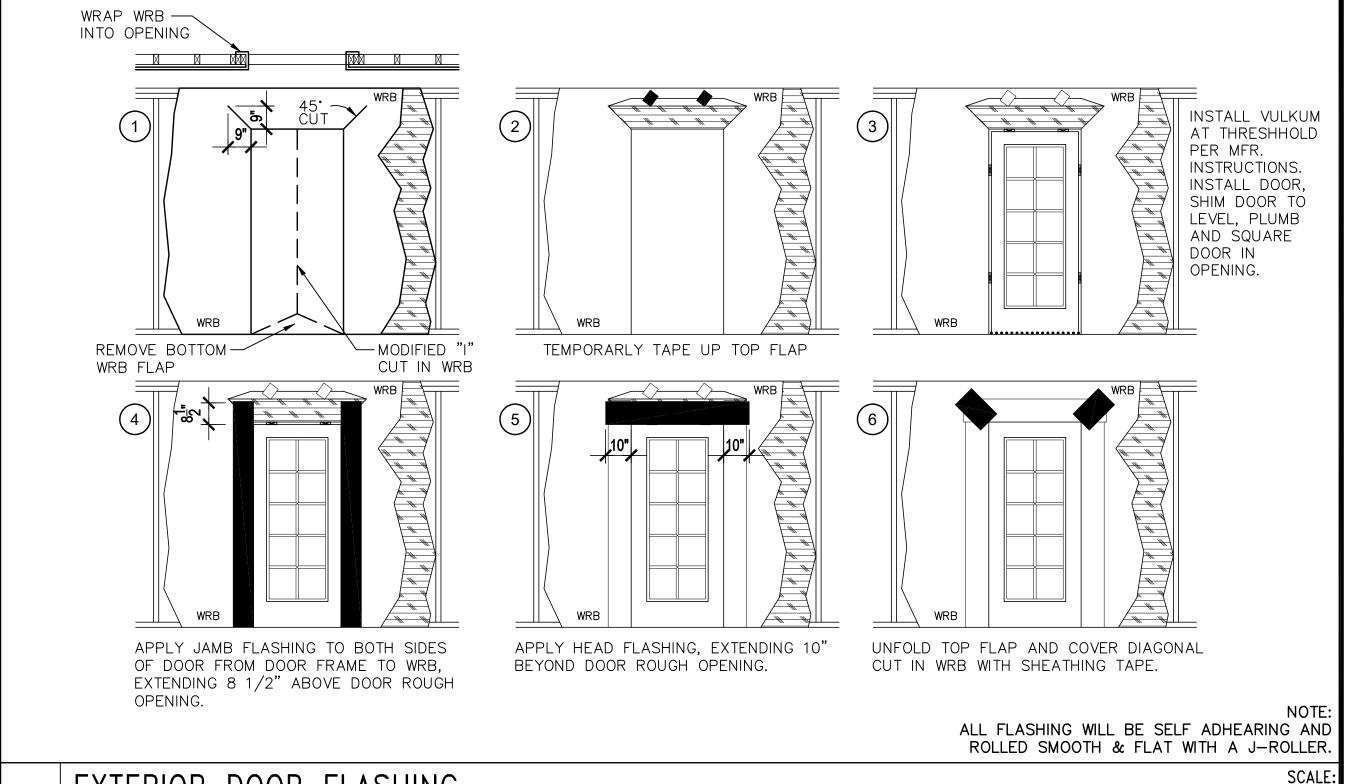

EXTERIOR DOOR FLASHING

WINDOW INSTALLATION (METHOD A-1) (ASTM E 2112-01)

WEATHER RESITIVE BARRIER (WRB) APPLIED PRIOR TO THE WINDOW INSTALLATION. FLASHING APPLIED OVER THE FACE OF THE MOUNTING FLANGE.

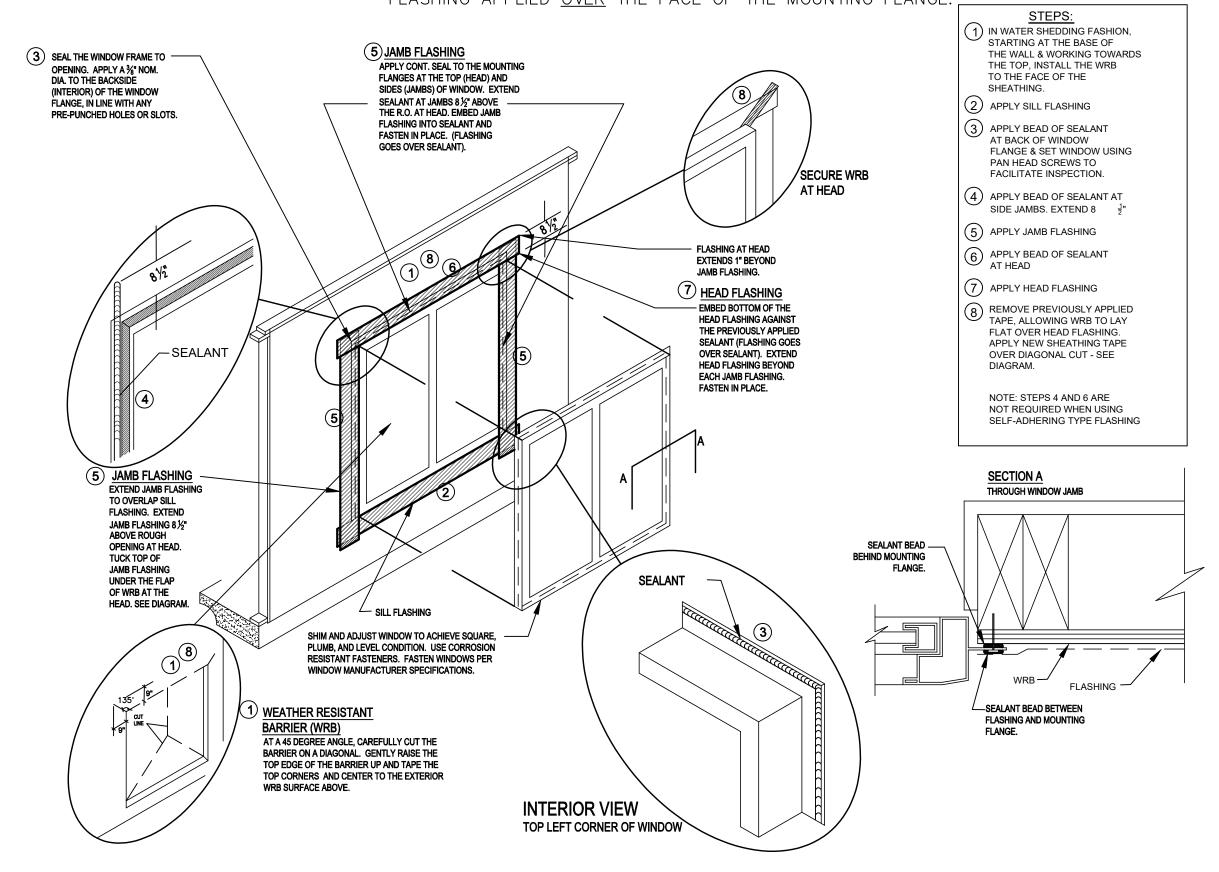

ALL FLASHING WILL BE SELF ADHEARING AND ROLLED SMOOTH & FLAT WITH A J-ROLLER.

DETAILS A6

GOBA

30-1700 Lot # - Subdivision Street Address

A division of Park Square Enterprises Inc. 200 Vineland Rd. Suite #200 Orlando, Fl. 32811 Phone: (407) 529-3000

SSUE DATE 11/28/2023 REVISIONS

PROJECT: 22-1184 SCALE: AS NOTED DRAWN BY: C.C.

DESIGNED BY: MJS

SOFFIT OVERHANG DETAIL

CRICKET/FLASHING DETAIL

WINDOW FLASHING "METHOD A-1"